

DEVELOPMENT APPLICATION

APPLICATION NUMBER:	PLN-24-063
PROPOSED DEVELOPMENT:	Proposed outbuilding and Relocation of carpark
LOCATION:	1/239 Tolosa Street Glenorchy
APPLICANT:	Richmond Projects
ADVERTISING START DATE:	08/04/2025
ADVERTISING EXPIRY DATE:	28/04/2025

Plans and documentation are available for inspection at Council's Offices, located at 374 Main Road, Glenorchy between 8.30 am and 5.00 pm, Monday to Friday (excluding public holidays) and the plans are available on Glenorchy City Council's website (<u>www.gcc.tas.gov.au</u>) until **28/04/25**.

During this time, any person may make representations relating to the applications by letter addressed to the Chief Executive Officer, Glenorchy City Council, PO Box 103, Glenorchy 7010 or by email to gccmail@gcc.tas.gov.au.

Representations must be received by no later than 11.59 pm on **28/04/25**, or for postal and hand delivered representations, by 5.00 pm on **28/04/25**.

SUBSTANTIAL COMPLIANCE & **PROPOSED NEW DECK** 239 TOLOSA ST, GLENORCHY

STAGE | DA/BA APPROVAL | REVISION 2

CLIENTS | NICHOLAS THOMAS

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GLENORCHY CITY COUNCIL PLANNING SERVICES	
APPLICATION No PLN-24-063	
DATE RECEIVED .26/03/2025	



SITE DETAILS	
PLANNING ZONE:	GLENORCHY CITY COUNCIL 10.0 GENERAL RESIDENTIAL
EXISTING SITE AREA:	749.4M ²
EX. DWELLING AREA: EX. DWELLING COVERAGE:	265M ² 35.3%
PROPOSED DECK:	18.5M ²

PROJECT INFORMATION
CLIENT: NICHOLAS THOMAS
TITLE REFERENCE: 57945/9
DESIGN WIND SPEED: N3
SOIL CLASS: CLASS M
CLIMATE ZONE: ZONE 7
BAL: N/A
CORROSION ENVIRONMENT: N/A
Document Set ID: 3474229
Version: 2, Version Date: 03/04/2025

2	LOCATION PLAN
A0.0	1:2000



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02	ADDITIONAL INFORATION	ER	13.03.25
REV	AMENDMENT DETAILS	BY	DATE
PROJECT	STAGE	-	



PROPOSED NEW DECK

239 TOLOSSA STREET,

GLENORCHY TAS 7010

CLIENT DETAILS


NICHOLAS THOMAS

DRAWING TITLE

T.F DESIGNE E.R CHECKED E.R

RP20_045

COVER PAGE

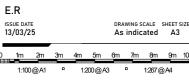

DRAWING NUMBER

REVISION

STANDARD SPECIFICATIONS

SOME ITEMS MAY NOT BE APPLICABLE TO THIS PROJECT

Some mems man nor be an eleable to mist hose of			
GENERAL NOTES:	CONSTRUCTION NOTES_CONTINUED	INSTALLATIONS, MATERIALS AND WORKMANSHIP	
1. CONTRACTOR TO CHECK AND CONFIRM ALL DIMENSIONS PRIOR TO CONSTRUCTION. REPORT ANY DISCREPANCIES IMMEDIATELY TO THE PROJECT	<u>EXITS (</u> REFER ELECTRICAL DRAWINGS) PROVIDE ILLUMINATED EXIT SIGNS AT ALL REQUIRED PATHS OF TRAVEL TO	TO BE IN ACCORDANCE WITH:	
MANAGER.	COMPLY WITH CLAUSES E4.5 AND	a. NCC 2019 (NATIONAL CONSTRUCTION CODE)	
2. DO NOT SCALE OFF DRAWINGS.	E4.8 OF THE BCA.	d. RELEVANT AUSTRALIAN STANDARD & BUILDING CODE REQU	REMEN
3. REFER WRITTEN DIMENSIONS ONLY. 4. ALL DIMENSIONS ARE IN MILLIMETRES.	FIRE HOSE REELS (REFER HYDRAULIC DRAWINGS)	FORMWORK FOR CONCRETE & CONCRETE FINISHES	AS
5. ALL DIMENSIONS TO BE CHECKED ON SITE.	PROVIDE FIRE HOSE REEL LENGTH IN ACCORDANCE WITH CLAUSE E4.1 OF THE	METAL ROOF SHEETING	AS
6. ARCHITECTURAL DRAWINGS ARE TO BE READ IN CONJUNCTION WITH	BCA & AS 2441.	PREPAINTED STEEL	AS
RELEVANT LANDSCAPE, CIVIL, STRUCTURAL, ELECTRICAL, MECHANICAL,			AS
HYDRAULIC, FIRE & ENERGY EFFICIENCY DOCUMENTATION. 7. PROVIDE ADEQUATE NOGGING & SUBSTRATE FOR ALL RELEVANT JOINERY.	FIRE EXTINGUISHERS (REFER HYDRAULIC DRAWINGS) PROVIDE FIRE EXTINGUISHERS TO COMPLY WITH CLAUSE E1.6 OF THE BCA. TO BE	AAMA COATING PERFORMACE SPEC FLASHINGS & CAPPINGS	AA AS
FIXTURES & FITTINGS.	PROVIDED AND INSTALLED TO	METAL RAINWATER GOODS	AS
8. INSTALLATION OF ALL PROPRIETARY MATERIALS, FIXTURES & FITTINGS	COMPLY WITH AS1841.5 & AS.2444 ORDINARY HAZARD CLASS A.	ROOF/STORMWATER DRAINAGE	AS
SHOULD BE REFERRED TO MANUFACTURER'S INSTRUCTIONS, SPECIFICATIONS		SARKING	AS
AND DETAIL. DRAWINGS AND SUPPLEMENTARY SITE DATA PROVIDED.	FIRE HAZARD PROPERTIES (REFER BA CONDITIONS)	SAFETY MESH	AS
9. ALL SECONDARY/SUB-CONTRACTORS TO CONFIRM ALL LEVELS AND DIMENSIONS ON SITE BEFORE COMMENCING WORK.	ALL BUILDING MATERIALS AND ASSEMBLIES TO COMPLY WITH CLAUSE C1.10 OF THE BCA.	ROOF INSULATION (WITHOUT SAFETY MESH) SAFETY SIGNS	ASAS
DIMENSIONS ON SITE DEFORE COMMENCING WORK.	FLAMMABILITY INDEX NOT MORE THAN 5 (SARKING TYPE MATERIAL) SPREAD OF	FIXED PLATFORMS, WALKWAYS, STAIRWAYS AND LADDERS	AS
CONSTRUCTION NOTES	FLAME INDEX NOT MORE THAN 9,	GLAZED ASSEMBLIES	AS
	SMOKE DEVELOPMENT INDEX NOT MORE THAN 8 (IF SPREAD OF FLAME INDEX IS	ALUMINIUM WINDOW & DOOR FRAMES	AS
QUERIES REFER ALL QUERIES TO THE PROJECT MANAGER VIA MANAGING	MORE THAN 5)	GLASS	AS
CONTRACTOR/SITE FOREMAN	EXIT DOOR HARDWARE (REFER BA CONDITIONS)	WINDOWS & EXTERNAL GLAZING BUILDING FACADE	ASAS
EXTERNAL WORKS	TO COMPLY WITH CLAUSE D2.21 OF THE BCA AND CLAUSE 11, AS 1428.1. EXIT	SAFETY GLASS	AS
CONSTRUCTION OF ALL CIVIL WORKS SHOULD BE CARRIED OUT TO COMPLY	DOORS OR DOORS IN A PATH OF	DAMP & WEATHERPROOFING - GENERAL	N
WITH RELEVANT STANDARDS,	TRAVEL MUST BE READILY OPENABLE WITHOUT A KEY FROM THE SIDE THAT	WATERPROOFING OF WET AREAS	AS
CODES AND REQUIREMENTS OF THE LOCAL AUTHORITY.	FACES A PERSON SEEKING EGRESS.	DAMP PROOF COURSE	AS
PLEASE CHECK AND CONFIRM EXISTING AND PROPOSED RL'S MATCH THOSE ON	DOOR HARDWARE TO BE LOCATED BETWEEN 900mm AND 1100mm ABOVE FFL.	TERMITE BARRIER PLASTERBOARD	ASAS
SITE. IF THERE ARE ANY	ALL EXIT DOOR LATCHES AND HANDLES TO COMPLY WITH CLAUSE D2.21 OF THE	FIBRE CEMENT	A3
DISCREPANCIES PLEASE ADVISE SITE FOREMAN IMMEDIATELY. DO NOT POUR	BCA.	PAINTING	AS
PAVEMENT FINISH IF THERE ARE		BALUSTRADES	N
ANY DOUBTS.	TOILET DOORS	ENERGY EFFICIENCY	N
PROVIDE TEMPORARY SAFETY FENCING, HOARDING AND GATES AS REQUIRED.	TO HAVE KNOCK OFF HINGES TO COMPLY WITH CLAUSE F2.5 OF THE BCA. IDENTIFICATION OF ACCESSIBLE	ACCESS & EGRESS ACCESS FOR PEOPLE WITH A DISABILITY	NC
CO-ORDINATE FENCING AND	DISABLED FACILITIES. PROVIDE SIGNAGE INCORPORATING THE INTERNATIONAL	DISABILITY (ACCESS TO PREMISES – BUILDINGS)	NU
ACCESS POINTS WITH THE OWNER BEFORE INSTALLATION.	SYMBOL OF ACCESS TO COMPLY	SIGNS & GRAPHICS FOR DISABLED ACCESS	AS
	WITH AS.1428.1 TO IDENTIFY THE PATH OF TRAVEL TO EACH UNISEX DISABLED	TACTILE GROUND SURFACE INDICATORS	AS
ONLY REMOVE VEGETATION AS INDICATED ON LANDSCAPE DRAWINGS.	FACILITY.	ROOF ACCESS SAFETY SYSTEM	W
PROTECT ALL OTHER VEGETATION DURING CONSTRUCTION. MAKE GOOD AND RE-INSTATE ALL DISTURBED AREAS.		(FOR MAINTENANCE OF NEW ROOF & GUTTER)	
BORING CONSTRUCTION. MARE COOD AND RE INSTATE ALL DISTORDED AREAS.	FLOOR SURFACES ARE TO COMPLY WITH CLAUSE P1 OF QDC PART 1.0. ALL	FALL ARREST SYSTEMSLIP RESISTANCE	ASAS
MAKE GOOD ALL DISTURBED WORK.	FLOORS TO HAVE EVEN SLIP-	POWERED DOOR FOR PEDESTRIAN ACCESS & EGRESS	AS
	RESISTANT SURFACE, WITHOUT OBSTRUCTIONS WHICH CREATE TRIPPING OR	THE STORAGE OF GASSES IN CYLINDERS	AS
UNLESS NOTED OTHERWISE, EXTERNAL CONCRETE PAVEMENT TO BE AS PER CIVIL ENGINEERS DOCUMENTS	STUMBLING HAZARDS.	INSTALLATION & USE OF INERT GASES FOR	
CIVIL ENGINEERS DOCOMENTS	FLOOR SURFACES TO BE WASHED DOWN MUST HAVE SURFACE FINISH	BEVERAGE DISPENSING CONSTRUCTION AND FIT OUT OF FOOD PREMISES	ASASAS
HYDRAULIC	IMPERVIOUS TO LIQUIDS USED FOR CLEANING.	SLIP RESISTANCE OF PEDESTRIAN SURFACES	AS
REFER HYDRAULIC DOCUMENTS FOR ALL NEW HYDRAULIC WORKS INCLUDING		STEEL STRUCTURES	AS
ANY RELEVANT CODE COMPLIANCE REQUIREMENTS.	FLOOR COVERINGS ARE TO BE PROVIDED THAT PREVENT SLIPS, TRIPS AND	BLOCKWORK/BRICKWORK:	
ELECTRICAL	FALLS TO COMPLY WITH CLAUSE P1 OF QDC PART MP5.1	DESIGN	AS
REFER ELECTRICAL DOCUMENTS FOR ALL NEW ELECTRICAL WORKS INCLUDING	FLOOR DRAINAGE(REFER HYDRAULIC DRAWINGS)	CONSTRUCTION MASONRY STRUCTURE	ASAS
ANY RELEVANT CODE COMPLIANCE REQUIREMENTS.	FLOOR DRAINAGE TO COMPLY WITH CLAUSE P2 OF QDC PART MP5.1 FLOOR	STRUCTURAL DESIGN	AS
	AREAS TO BE HOSED DOWN TO HAVE	UNITS	AS
STRUCTURAL	MIN. GRADES 1:25.	TESTING	AS
REFER TO STRUCTURAL DOCUMENTS FOR ALL STRUCTURAL WORKS INCLUDING ANY RELEVANT CODE COMPLIANCE REQUIREMENTS		THE STORAGE & HANDLING OF LP GAS	AS
	GLENORCHY CITY COUNCIL	THE STORAGE & HANDLING OF FLAMMABLE & COMBUSTIBLE LIQUIDS	AS
EMERGENCY LIGHTING (REFER ELECTRICAL DRAWINGS)		THE DESIGN, INSTALLATION & OPERATION OF	A3
EMERGENCY LIGHTING TO COMPLY WITH CLAUSE E4.2 AND E4.4 OF THE BCA	PLANNING SERVICES	UNDERGROUND PETROLEUM STORAGE SYSTEMS	AS
PROVIDE ILLUMINATED EXIT SIGNS AT ALL REQUIRED PATHS OF TRAVEL TO		EXPLOSIVE ATMOSPHERES - CLASSIFICATION OF AREAS	AS
COMPLY WITH CLAUSES E4.5 AND 4.8 OF THE BCA.	APPLICATION No. PLN-24-063	PARKING FACILITIES	AS
		SMOKE ALARMS	AS
	DATE RECEIVED .26/03/2025		

Document Set ID: 3474229 Version: 2, Version Date: 03/04/2025



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IENTS:

_AS3610.1-2010 AS 1562.1 _AS 2728 AS3715 _AAMA 2604 AS/NZS 2904 _AS/NZS 2179 _AS/NZS 3500.3 AS/NZS 4200 PARTS 1&2 _AS/NZS 4389 AS 4040.4 AS 1319 AS 1657 AS 2047 (BLDG CLASS 9b) AS 1231 AS 1288 AS 2047 AS4284 AS 2208 NCC 2019 BCA PART F1 _AS 3740 / NCC 2019 BCA PART F1 AS/NZS 2904 AS 3660 AS/NZS 2588 / AS 2589.1 AS 2908.2 _AS/NZS 2311 NCC 2014 BCA PART D2.16 NCC 2019 BCA PART J NCC 2019 BCA PART D NCC 2019 BCA PART D3 _STANDARDS 2010 / AS 1428.1 AS 1428.1 AS 1428.4 WORK HEALTH & SAFETY REGULATIONS 2011 AS/NZS 1891 AS/NZS 4586 / CSIRO HB 197/AS3661/AS4663 AS 5007 AS 4332 AS 5034 ____ AS 4674 02 REV ER 13.03.25 ADDITIONAL INFORATION _AS/NZS 3661.2 BY DATE AMENDMENT DETAILS AS 4100 DA/BA STAGE AS4773 PART 1 AS4772 PART 2 PROPOSED NEW DECK AS3700 239 TOLOSSA STREET, AS1170 AS4455 **GLENORCHY TAS 7010** AS4456 CLIENT DETAILS AS 1596 NICHOLAS THOMAS DRAWING TITLE AS 1940 **GENERAL NOTES** AS 4897 AS 60079.10.1 AS/NZS 2890 T.F AS3786 DESIGNED E.R CHECKED E.R ISSUE DATE 13/03/25 DRAWING SCALE SHEET SIZE 1:50 A3 4m 5m 6m 7m 9m 10m 0 1m 2m 3m 8m • 1:200@A3 • 1:100@A1 1:267@A4 drawing number REVISION RP20_045

SITE GENERAL NOTES

CONFIRM ALL DIMENSIONS ON SITE TO EXISTING DWELLINGS PRIOR TO COMMENCEMENT OF ANY WORK

EXISTING PLUMBING AND ELECTRICAL WORKS TO BE REMOVED AND MADE GOOD AS NECESSARY THE EXACT LOCATION OF UNDERGROUND AND ABOVEGROUND SERVICES SHALL BE PROVEN ON SITE.

NO GUARANTEE IS GIVEN THAT ALL EXISTING SERVICES ARE SHOWN. THIS DRAWING SET TO BE READ IN CONJUNCTION WITH THE SPECIFICATION PROVIDED. BEWARE OF EXISTING SERVICES. CONFIRM

LOCATIONS PRIOR TO EXCAVATION REFER ALL MAJOR WORKS TO RAMPS, WALKWAYS, DRIVEWAYS ETC (INCLUDING CARPARK WORKS, LEVELS & DATUMS) REFER CIVIL ENGINEERS DOCUMENTATION

ALL SITE WORKS SHALL BE IN ACCORDANCE WITH N.C.C., CSIRO BTF 18,19,22 AND AS2870 MINIMAL SITE DISTURBANCE IS TO BE CARRIED OUT. SEDIMENT CONTROL; 'GEOLAB' SILT FENCE 1000 OR SIMILAR. TOPSOIL STOCKPILES REMAINING ON THE SITE TO BE COVERED WITH PLASTIC, DEQUATELY RETAINED ALONG ALL EDGES. UNUSED STOCKPILES TO BE REMOVED FROM SITE OR USED FOR FUTURE LANDSCAPING.

SITE PREPARATION AND EXCAVATION IN ACCORDANCE WITH PART 3.1 OF CURRENT N.C.C., AND TO LOCAL COUNCIL REQUIREMENTS INTERNAL FINISHED FLOOR LEVEL (FFL) TO BE MIN. 150MM ABOVE

FINISHED EXTERNAL GROUND AREAS (FLOWER BEDS OR GRASSED AREAS) AND MIN. 50 MM ABOVE FINISHED EXTERNAL SEALED SURFACES (PAVED AREAS). PROVIDE 50 MM MIN. FALL FOR THE FIRST METRE AWAY FROM BUILDING TOWARDS LOWER GROUND OR ALTERNATIVELY SUFFICIENT DRAINAGE PROVISIONS (AG DRAINS, SUMPS OR SIMILAR).

FOOTINGS

CONCRETE FOOTINGS AND SLABS IN ACCORDANCE WITH PART 3.2 OF CURRENT N.C.C. AND AS 2870.1 AND ENGINEERS SPECS. UNLESS OTHERWISE SPECIFIED, FOOTINGS 25MPA / SLAB 25MPA. STRIP FOOTINGS TO BE PLACED WITH A MECHANICAL VIBRATOR. CONCRETE SLABS TO BE MOISTURE CURED FOR MIN. OF 7 DAYS OR APPLY APPROVED CURING COMPOUND. PROVIDE WALL CAVITY DRAINAGE WITH WEEPHOLES AT 960 MAX CENTRES ALONG LINE ABOVE FINISHED GROUND LEVEL. (SLAB AREA).

WORKPLACE HEALTH AND SAFETY

BUILDER SHALL COMPLY WITH ALL WORKPLACE HEALTH AND SAFETY REQUIREMENTS REQUIRED BY LEGISLATION FOR THE CONSTRUCTION OF THE STRUCTURE AND SHALL ASSES ALL WORKPLACE HEALTH AND SAFETY ISSUES BEFORE COMMENCEMENT OF CONSTRUCTION AND LIASE WITH THE DESIGNER IF NECESSARY TO AVOID/MINIMISE RISKS DURING CONSTRUCTIOIN.

SERVICES

BUILDER TO LOCATE ALL SERVICES BEFORE COMMENCEMENTOF CONSTRUCTION. SEWERAGE TO COMPLY WITH LOCAL AUTHORITY **REGULATIONS AND WATER SUPPLY ACT 1949. ROOF** WATER DISCHARGE TO DOWNPIPES TO RAINWATER STORAGE TANKS IN ACCORDANCE WITH LOCAL AUTHORITY REQUIREMENTS. TANK OVERFLOW TO BE DIRECTED OR DISCHARGE AS PER LOCAL AUTHORITY REQUIREMENTS. RAINWATER TANK AND WASTE SERVICES TO BE CONNECTED TO LOCAL AUTHORITY SEWERAGE SYSTEM OR AS PER HYDRAULIC ENGINEERS DEISGN.


NOTE: RICHMOND PROJECTS GIVES NO WARRANTY REGARDING THE PRECENSE OF LOCATION OF BURIED SERVICES, INCLUDING NEW-INSTALLED SERVICES. "AS CONSTRUCTED" LOCATIONS MAY DIFFER FROM WHAT IS DRAWN ON THIS PLAN.

INITIAL IDENTIFICATION AS PER DBYD (DIAL BEFORE YOU DIG - TELEPHONE: 1100 HTTP://WWW.1100.COM.AU)



SITE INFORMATION

	SITE AREA	749.4M²
	TOTAL BUILDING AREA	265M²
	ORONTALE ISIT SECTOR RADIE 229	35.3%
V	ersion: 2. Version Date: 03/0	4/2025

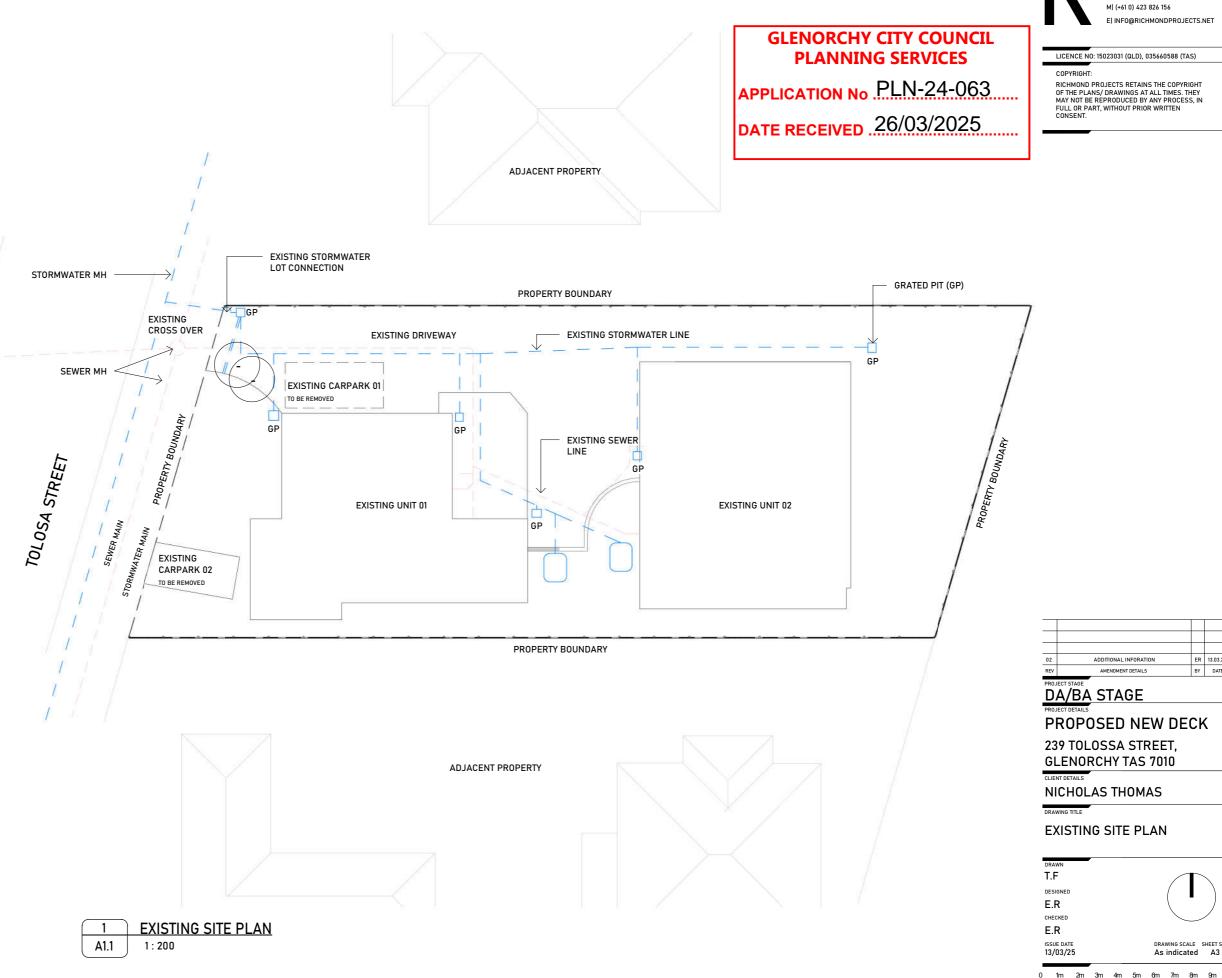



RICHMOND PROJECTS

ER 13.03.25

BY DATE

1200@A3

A1.1

1:267@,A4

02

NUMBER

1:100@A1

RP20_045

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SITE GENERAL NOTES

CONFIRM ALL DIMENSIONS ON SITE TO EXISTING DWELLINGS PRIOR TO COMMENCEMENT OF ANY WORK

EXISTING PLUMBING AND ELECTRICAL WORKS TO BE REMOVED AND MADE GOOD AS NECESSARY THE EXACT LOCATION OF UNDERGROUND AND ABOVEGROUND

SERVICES SHALL BE PROVEN ON SITE. NO GUARANTEE IS GIVEN THAT ALL EXISTING SERVICES ARE SHOWN. THIS DRAWING SET TO BE READ IN CONJUNCTION WITH THE

SPECIFICATION PROVIDED. BEWARE OF EXISTING SERVICES. CONFIRM LOCATIONS PRIOR TO EXCAVATION REFER ALL MAJOR WORKS TO RAMPS, WALKWAYS, DRIVEWAYS ETC

(INCLUDING CARPARK WORKS, LEVELS & DATUMS) REFER CIVIL ENGINEERS DOCUMENTATION

ALL SITE WORKS SHALL BE IN ACCORDANCE WITH N.C.C., CSIRO BTF 18,19,22 AND AS2870 MINIMAL SITE DISTURBANCE IS TO BE CARRIED OUT. SEDIMENT CONTROL; 'GEOLAB' SILT FENCE 1000 OR SIMILAR. TOPSOIL STOCKPILES REMAINING ON THE SITE TO BE COVERED WITH PLASTIC, DEQUATELY RETAINED ALONG ALL EDGES. UNUSED STOCKPILES TO BE REMOVED FROM SITE OR USED FOR FUTURE LANDSCAPING.

SITE PREPARATION AND EXCAVATION IN ACCORDANCE WITH PART 3.1 OF CURRENT N.C.C., AND TO LOCAL COUNCIL REQUIREMENTS

INTERNAL FINISHED FLOOR LEVEL (FFL) TO BE MIN. 150MM ABOVE FINISHED EXTERNAL GROUND AREAS (FLOWER BEDS OR GRASSED AREAS) AND MIN. 50 MM ABOVE FINISHED EXTERNAL SEALED SURFACES (PAVED AREAS). PROVIDE 50 MM MIN. FALL FOR THE FIRST METRE AWAY FROM BUILDING TOWARDS LOWER GROUND OR ALTERNATIVELY SUFFICIENT DRAINAGE PROVISIONS (AG DRAINS, SUMPS OR SIMILAR).

FOOTINGS

CONCRETE FOOTINGS AND SLABS IN ACCORDANCE WITH PART 3.2 OF CURRENT N.C.C. AND AS 2870.1 AND ENGINEERS SPECS. UNLESS OTHERWISE SPECIFIED, FOOTINGS 25MPA / SLAB 25MPA. STRIP FOOTINGS TO BE PLACED WITH A MECHANICAL VIBRATOR. CONCRETE SLABS TO BE MOISTURE CURED FOR MIN. OF 7 DAYS OR APPLY APPROVED CURING COMPOUND. PROVIDE WALL CAVITY DRAINAGE WITH WEEPHOLES AT 960 MAX CENTRES ALONG LINE ABOVE FINISHED GROUND LEVEL. (SLAB AREA).

WORKPLACE HEALTH AND SAFETY

BUILDER SHALL COMPLY WITH ALL WORKPLACE HEALTH AND SAFETY REQUIREMENTS REQUIRED BY LEGISLATION FOR THE CONSTRUCTION OF THE STRUCTURE AND SHALL ASSES ALL WORKPLACE HEALTH AND SAFETY ISSUES BEFORE COMMENCEMENT OF CONSTRUCTION AND LIASE WITH THE DESIGNER IF NECESSARY TO AVOID/MINIMISE RISKS DURING CONSTRUCTIOIN.

SERVICES

BUILDER TO LOCATE ALL SERVICES BEFORE COMMENCEMENTOF CONSTRUCTION. SEWERAGE TO COMPLY WITH LOCAL AUTHORITY **REGULATIONS AND WATER SUPPLY ACT 1949. ROOF** WATER DISCHARGE TO DOWNPIPES TO RAINWATER STORAGE TANKS IN ACCORDANCE WITH LOCAL AUTHORITY REQUIREMENTS. TANK OVERFLOW TO BE DIRECTED OR DISCHARGE AS PER LOCAL AUTHORITY REQUIREMENTS. RAINWATER TANK AND WASTE SERVICES TO BE CONNECTED TO LOCAL AUTHORITY SEWERAGE SYSTEM OR AS PER HYDRAULIC ENGINEERS DEISGN.

NOTE: RICHMOND PROJECTS GIVES NO WARRANTY REGARDING THE PRECENSE OF LOCATION OF BURIED SERVICES, INCLUDING NEW-INSTALLED SERVICES. "AS CONSTRUCTED" LOCATIONS MAY DIFFER FROM WHAT IS DRAWN ON THIS PLAN.

INITIAL IDENTIFICATION AS PER DBYD (DIAL BEFORE YOU DIG - TELEPHONE: 1100 HTTP://WWW.1100.COM.AU)





	SITE AREA	749.4M
	TOTAL BUILDING AREA	283.5M
	orounale istraet di De 1840724229	37.85
V	ersion: 2, Version Date: 03/04	1/2025

ADJACENT PROPERTY EXISTING STORMWATER LOT CONNECTION CP2 - CARPARK BELOW DECK PROPERTY BOUNDARY FXISTING PROPOSED CARPARK CROSS OVER SPACE (CP1) EXISTING DRIVEWAY SEWER MH PROPERTY BOUNDARY TOL OSA STREET PROPOSED NEW DECK EXISTING UNIT 01 **EXISTING UNIT 02** SEWER MAIN MWATER MAIN PROPERTY BOUNDARY ADJACENT PROPERTY PROPOSED SITE PLAN A1.2 1:200




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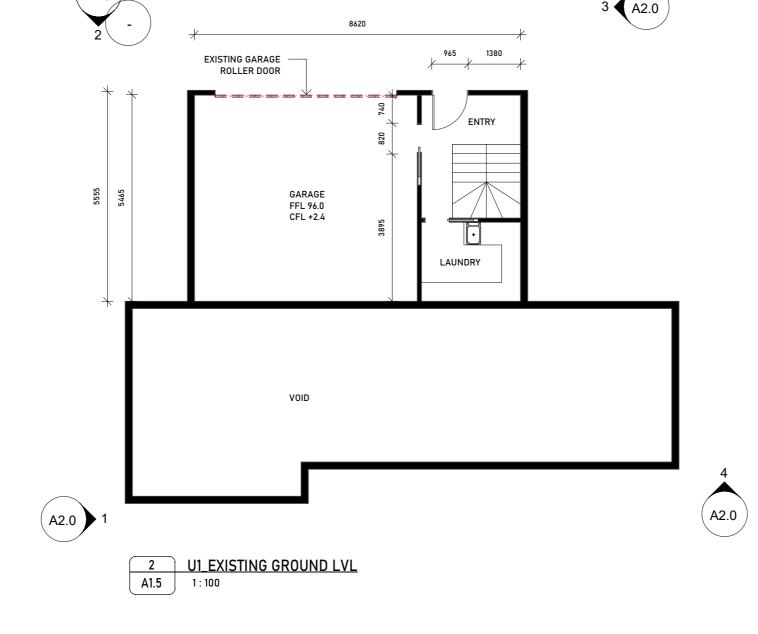
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FLOOR INFORMATION	-
FLOOR AREA	119.6M²
DECK AREA	0M²
Dorourae IARSet ID: 3474229	119.6M²
Version: 2, Version Date: 03/04	4/2025



A2-0

CONSTRUCTION AND MATERIALS IN ACCORDANCE WITH AS 1684.2 AND AS 3959 FOR BUSHFIRE ATTACK LEVEL - BAL N/A GLAZING TO BE IN ACCORDANCE WITH AS1288 AND AS2047 WIND SPEED 41M/S N3

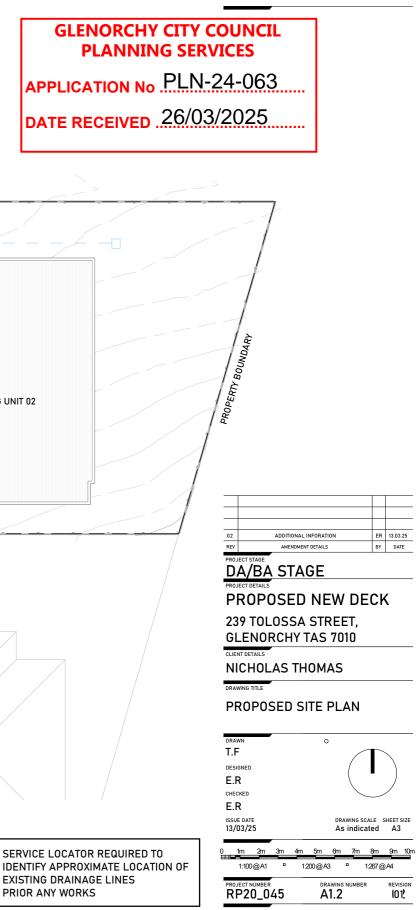GLENORCHY CITY COUNCIL PLANNING SERVICES APPLICATION No. PLN-24-063 DATE RECEIVED .26/03/2025





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02	ADDITIONAL INFORATION	ER	13.03.25
REV	AMENDMENT DETAILS	BY	DATE
PROJ	ECT STAGE A/BA STAGE ECT DETAILS ROPOSED NEW DE	-Ch	
23 GL	9 TOLOSSA STREET, ENORCHY TAS 7010		`
	CHOLAS THOMAS		
DRAV		.VL	
T.F DESI E.F CHEC	sned		
	R DATE DRAWING SU 13/25 As indice		HEET SIZE
0 1	<u>m 2m 3m 4m 5m 6m 7m</u>	8m	9m 10m
	1:100@A1 º 1:200@A3 º	1:267@	A4
	ect number drawing number P20_045 A1.5	1	REVISION 02

GLENORCHY CITY COUNCIL PLANNING SERVICES APPLICATION No. PLN-24-063 DATE RECEIVED .26/03/2025

3 🖌 A2.0







FLOOR AREA	119.6M²
DECK AREA	0M²
Dorounaeiar Set ID: 3474229	119.6M²
Version: 2, Version Date: 03/0	4/2025






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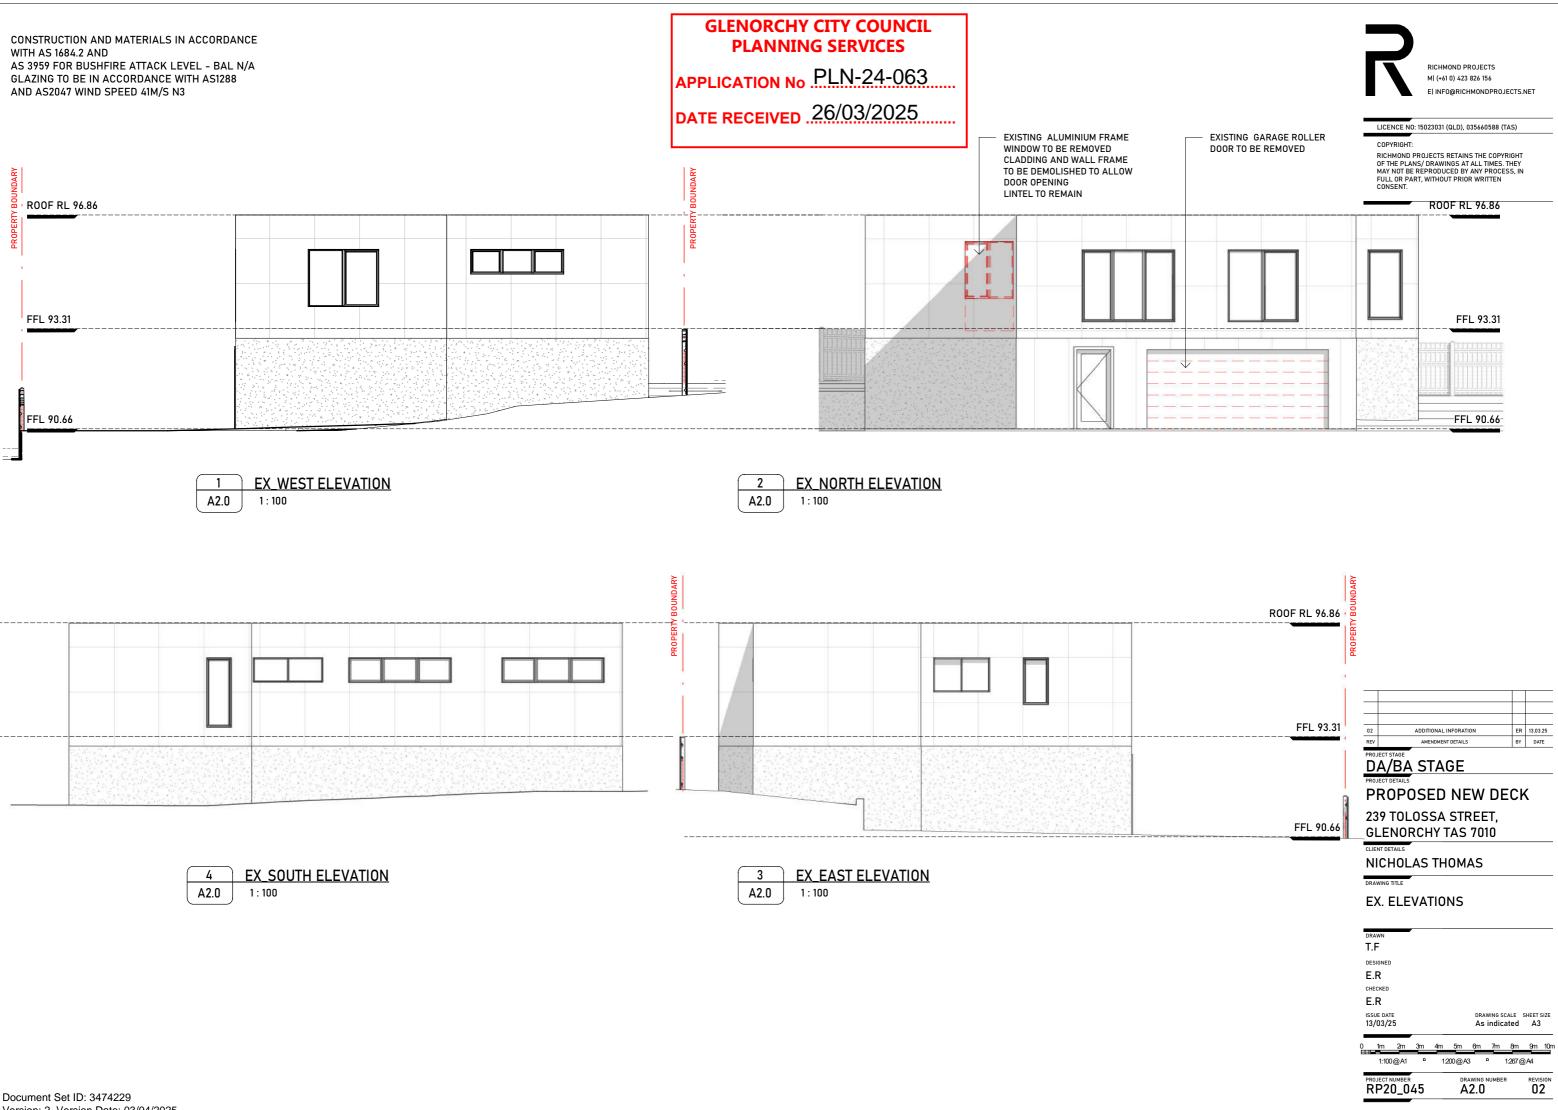
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DRAWING	TITLE								
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U1_E	XIS	TIN	IG l	JPP	ER	LV	L		
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DRAWN T.F DESIGNET E.R CHECKED E.R ISSUE DA' 13/03/2	о ГЕ 25		4m		DRA As ôm	WING SC indica	CALE S	A3 9m	51Z



1m	2m	3m	4m	5m
FLOOR INF	ORMATIO	N		
FLOOR ARE	ΕA		119.	.6M²


		-
	DECK AREA	18.5M²
	Droumaenarset ID: 3474229	138.1M²
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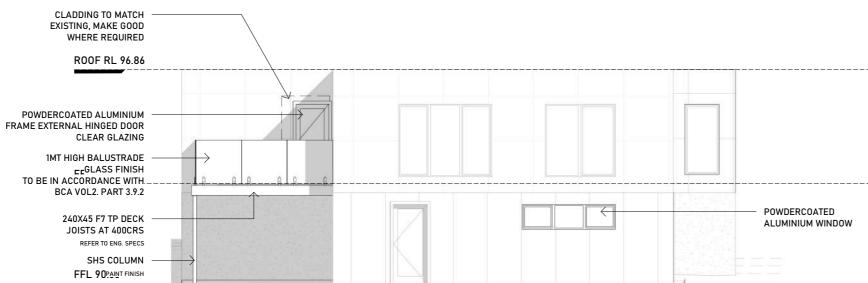
3	EX_EAST ELEVATION
A2.0	1:100



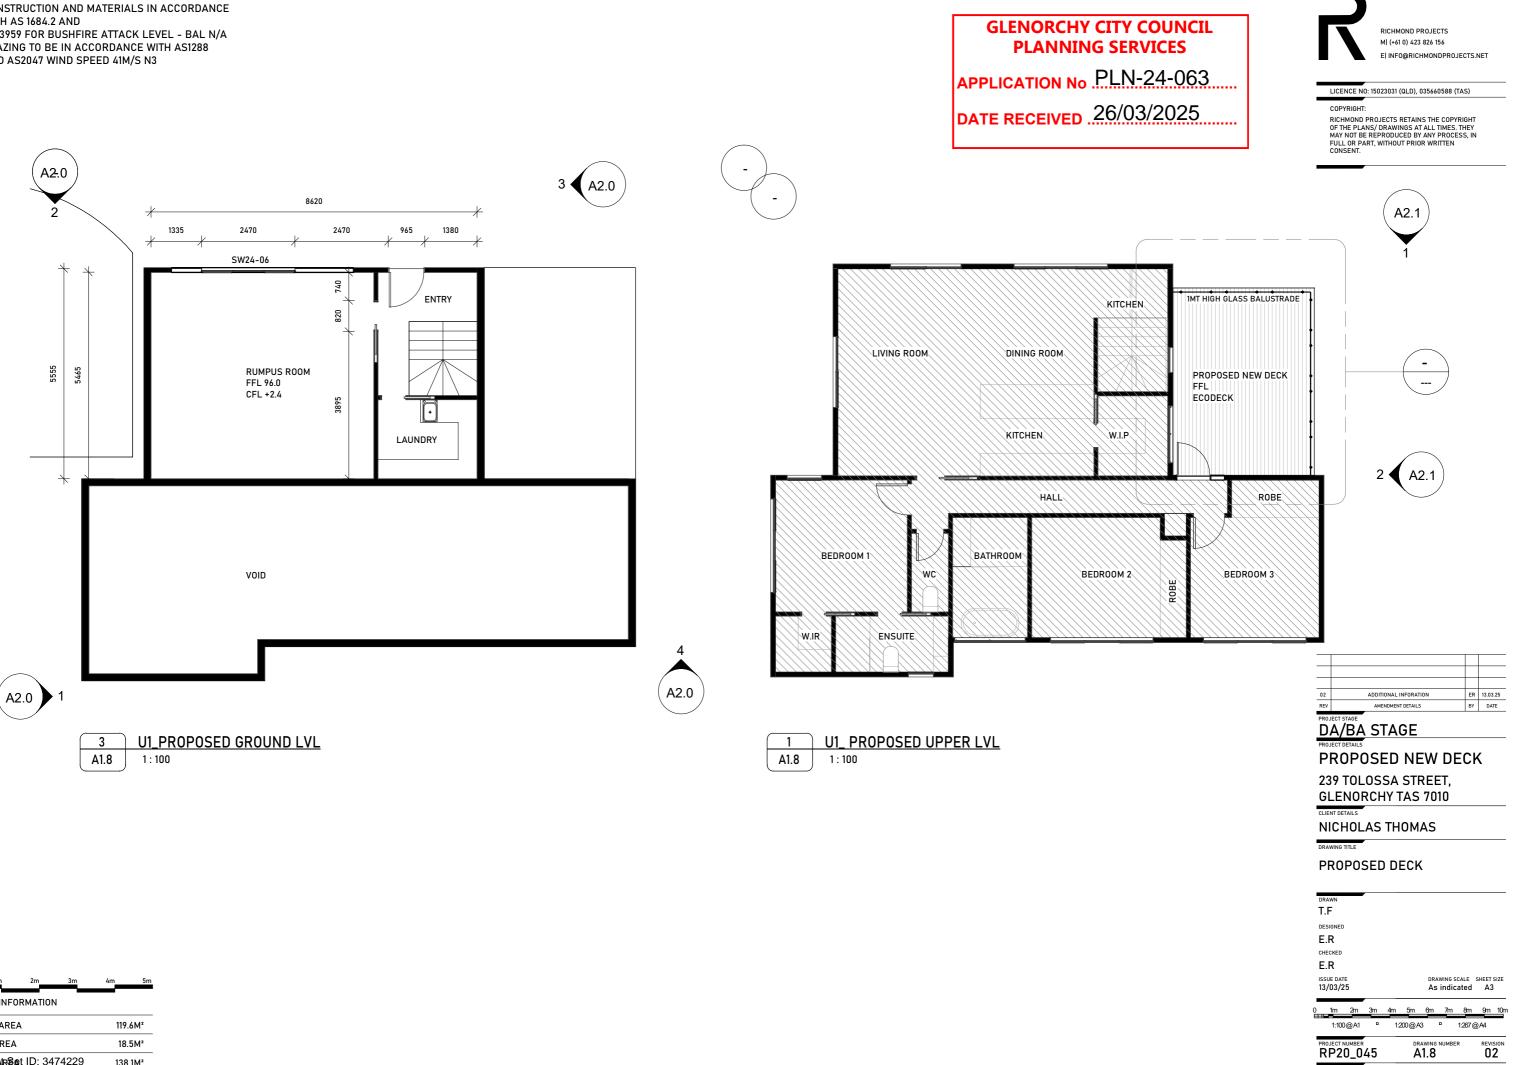


A2.1

1 : 100

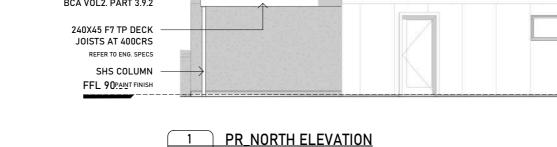

2	PR_EAST ELEVATION
A2.1	1 : 100

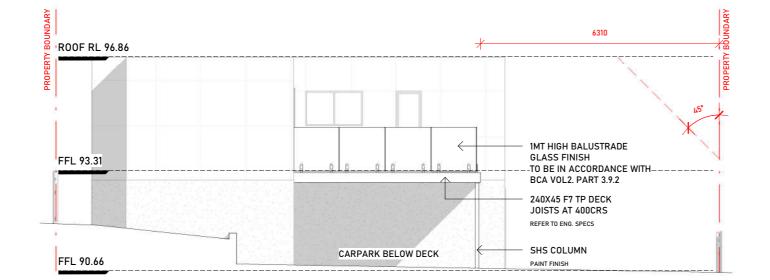

GLENORCHY CITY COUNCIL PLANNING SERVICES APPLICATION No. PLN-24-063 DATE RECEIVED 26/03/2025

CONSTRUCTION AND MATERIALS IN ACCORDANCE WITH AS 1684.2 AND AS 3959 FOR BUSHFIRE ATTACK LEVEL - BAL N/A GLAZING TO BE IN ACCORDANCE WITH AS1288 AND AS2047 WIND SPEED 41M/S N3





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ADDITIONAL INFORATION

AMENDMENT DETAILS

DA/BA STAGE

02 REV

ER 13.03.25

BY DATE

PART 3.8.7 CONDENSATION MANAGEMENT.

3.8.7.2 PLIABLE BUILDING MEMBRANE

(A) WHERE A PLIABLE BUILDING MEMBRANE IS INSTALLED IN AN EXTERNAL WALL, IT MUST--

(I) COMPLY WITH AS/NZS 4200.1; AND

(II) BE INSTALLED IN ACCORDANCE WITH AS 4200.2; AND (III) BE A VAPOUR PERMEABLE MEMBRANE FOR CLIMATE ZONES 6, 7 AND 8; AND

(IV) BE LOCATED ON THE EXTERIOR SIDE OF THE PRIMARY INSULATION LAYER OF WALL ASSEMBLIES THAT FORM THE

EXTERNAL ENVELOPE OF A BUILDING.

(B) EXCEPT FOR SINGLE SKIN MASONRY OR SINGLE SKIN CONCRETE, WHERE A PLIABLE BUILDING MEMBRANE IS NOT

INSTALLED IN AN

EXTERNAL WALL, THE PRIMARY WATER CONTROL LAYER MUST BE

SEPARATED FROM WATER SENSITIVE MATERIALS BY A DRAINED CAVITY.

3.8.7.3 FLOW RATE AND DISCHARGE OF EXHAUST SYSTEMS

(A) AN EXHAUST SYSTEM INSTALLED IN A KITCHEN, BATHROOM, SANITARY COMPARTMENT OR LAUNDRY MUST HAVE A MINIMUM

FLOW RATE OF ---(I) 25 L/S FOR A BATHROOM OR SANITARY COMPARTMENT; AND

(II) 40 L/S FOR A KITCHEN OR LAUNDRY. (B) EXHAUST FROM A BATHROOM, SANITARY COMPARTMENT, OR

LAUNDRY MUST BE DISCHARGED--(I) DIRECTLY OR VIA A SHAFT OR DUCT TO OUTDOOR AIR; OR

(II) TO A ROOF SPACE THAT IS VENTILATED IN ACCORDANCE WITH 3.8.7.4

3.8.7.4 VENTILATION OF ROOF SPACES

(A) WHERE AN EXHAUST SYSTEM COVERED BY 3.8.7.3 DISCHARGES INTO A ROOF SPACE, THE ROOF SPACE MUST BE VENTILATED TO

OUTDOOR AIR THROUGH EVENLY DISTRIBUTED OPENINGS. (B) OPENINGS REQUIRED BY (A) MUST HAVE A TOTAL

UNOBSTRUCTED AREA OF 1/300 OF THE RESPECTIVE CEILING AREA IF THE ROOF PITCH

IS MORE THAN 22°, OR 1/150 OF THE RESPECTIVE CEILING AREA IF THE ROOF PITCH IS NOT MORE THAN 22°.

(C) 30% OF THE TOTAL UNOBSTRUCTED AREA REQUIRED BY (B) MUST BE LOCATED NOT MORE THAN 900 MM BELOW THE RIDGE OR

HIGHEST POINT OF THE ROOF SPACE, MEASURED VERTICALLY, WITH THE REMAINING REQUIRED AREA PROVIDED BY EAVE VENTS.

SUB-FLOOR VENTILATION

IN ACCORDANCE WITH PART 3.4.1 OF CURRENT N.C.C., MINIMUM RATE OF SUB-FLOOR VENTILATION TO BE 6000mm2 PER METRE OF EXTERNAL PERIMETER WALL.

DAMP PROOFING IN ACCORDANCE WITH PART PART 3.3.4 OF CURRENT N.C.C. AND TO AS/NZS 2904.

TIMBER FRAMING DESIGN WIND SPEED N3. TIMBER FRAMING, TIE DOWN AND WIND BRACING DETAILS TO AS 1684.2.


WALL CLADDING IN ACCORDANCE WITH PART 3.5 OF CURRENT N.C.C. AND MANUFACTURER'S SPECIFICATIONS.

ROOF CLADDING, GUTTERING AND DOWNPIPES IN ACCORDANCE WITH 3.5.1 AND PARTS 3.5.2 OF CURRENT N.C.C. AND AS/NZS 3500.5. INSTALLATION TO BE IN ACCORDANCE WITH MANUFACTURER'S SPECIFICATIONS AND RECOMMENDATIONS.

WINDOWS & GLAZING ALL WINDOWS AND GLAZING TO AS 2047 AND AS 1288 AND PART 3.6 OF CURRENT N.C.C. MANUFACTURER TO PROVIDE CERTIFICATION OF COMPLIANCE. ALL WINDOW MEASUREMENT SHOWN ARE NOMINAL ONLY AND ARE TO BE VERIFIED ON SITE, PRIOR TO ORDERING.

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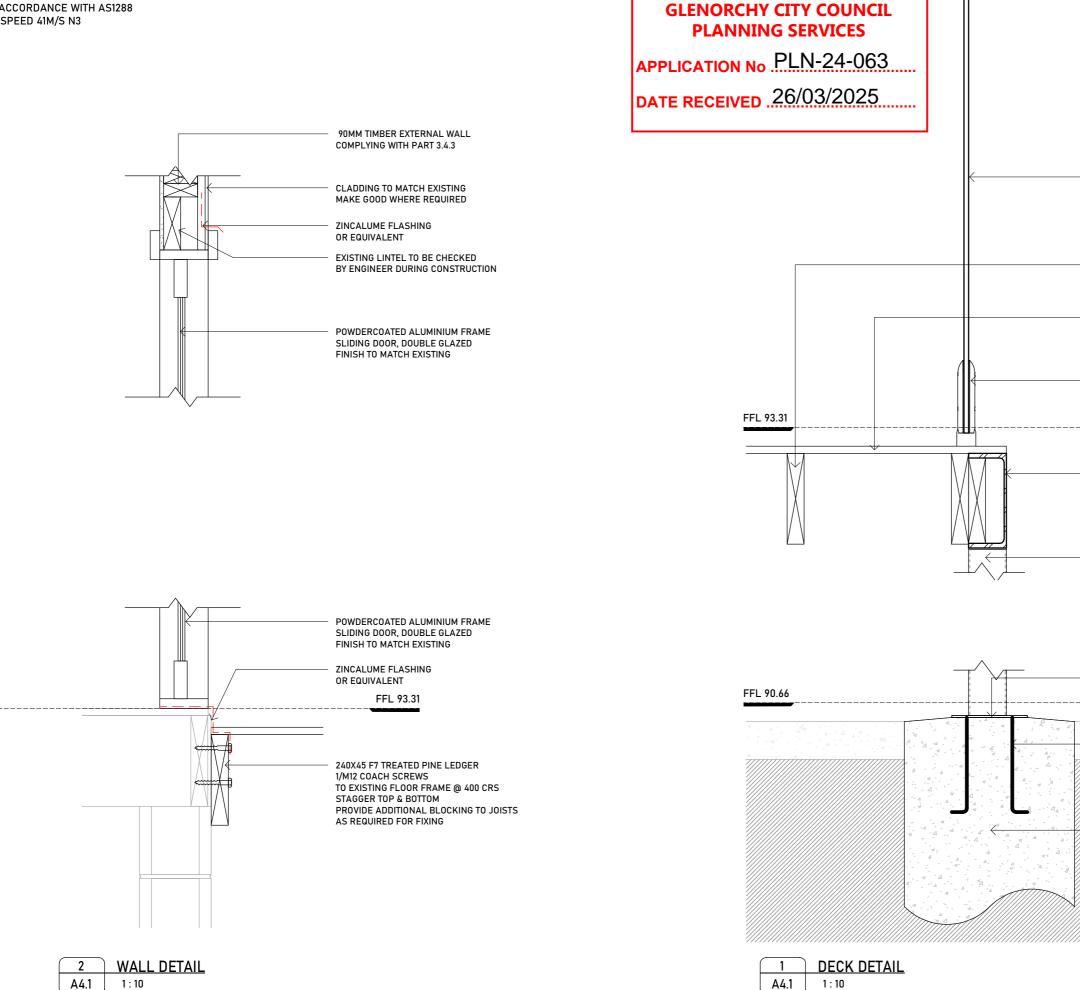
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02		ADDIT	IONAL II	NFORAT	ION		ER	13.03	.25
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TOUGHENED GLASS PANEL BALUSTRADE TO BE INSTALL TO MAN. SPECS


240X45 F7 TREATED PINE DECK JOIST AT 400 CRS REFER TO FLOOR FRAME

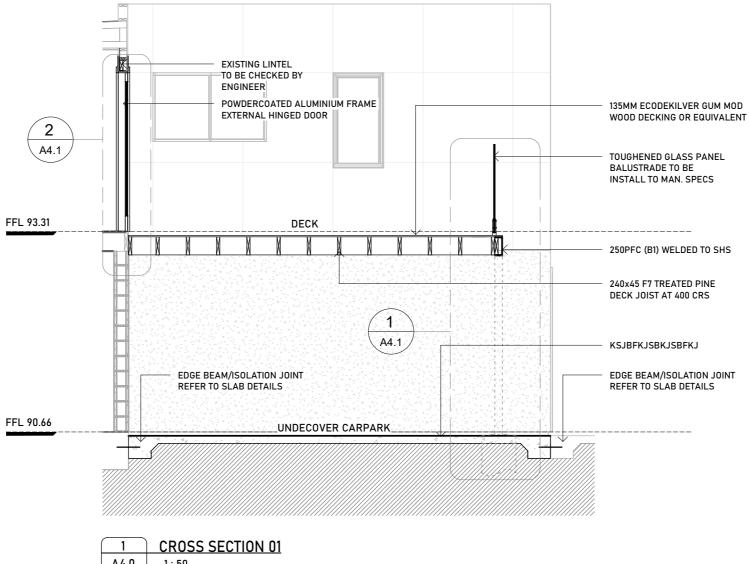135MM ECODEKILVER GUM MOD WOOD DECKING OR EQUIVALENT

GLASS CLAMP FIXED TO STEEL BEARER AS PER MAN. SPECS.

250PFC (B1) WELDED TO SHS

(C1) 100x100x3.5 SHS COLUMN

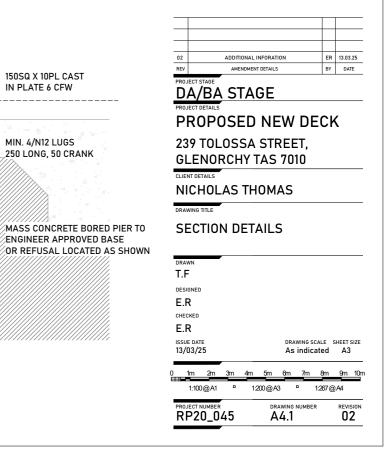


SCH	EDULE LEGEND
LI	240X45 F7 TREATED PINE LEDGER 1/M12 COACH BOLTS TO FLOOR FRAME @ 400 CRS STAGGER TOP & BOTTOM
B1	250 PFC BEARER WELDED TO SHS COLUMN
C1	100x100x3.5 SHS COLUMN
FB	30X0.8mm GALVANISED METAL STRAPS (GMS) FIXED TO JOIST
J1	240X45 F7 TREATED PINE DECK JOIST @ 400 CRS


GLENORCHY CITY COUNCIL PLANNING SERVICES APPLICATION No. PLN-24-063 DATE RECEIVED 26/03/2025

ENGINEERING NOTES

- 1. MASONRY CHEMICAL ANCHORING 10mm THICK LEDGERS TO 110 BRICKWORK CHEMICAL - HILTI HIT HY270 ROD - HAS-U (GRADED 5.8 GALVANISED) M12 90mm LONG SLEEVE - HIT-SC 18x50mm LONG
- 2. CONSULT WITH ENGINEER FOLLOWING DEMOLITION WORKS TO CONFIRM FLOOR CONDITION AND DESIGN.

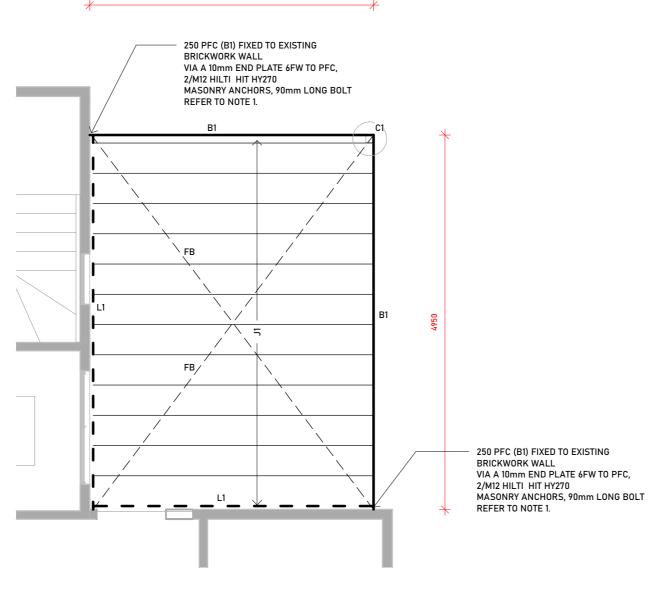

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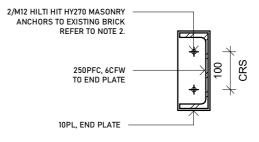


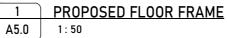
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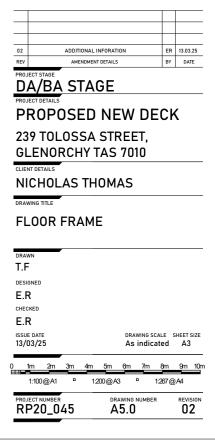
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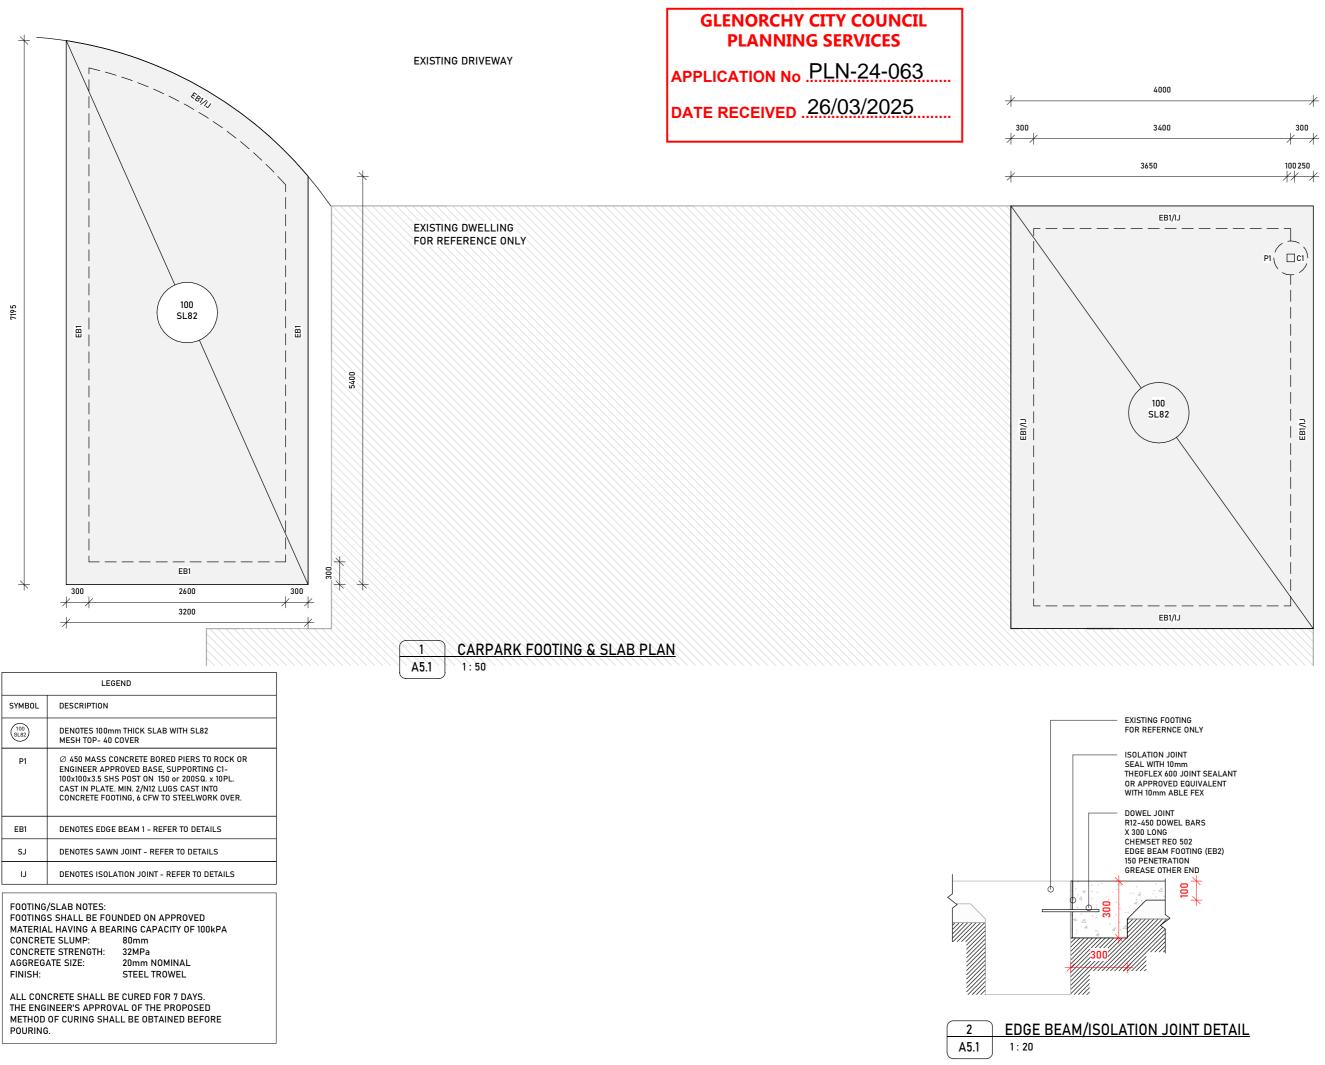
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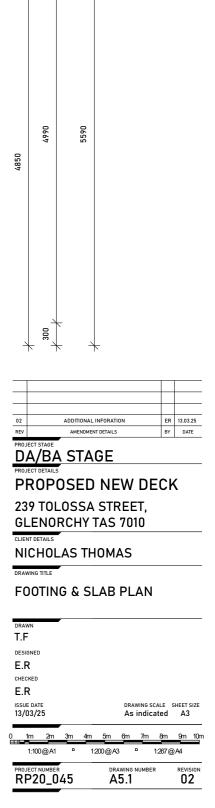
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CIVIL DRAWINGS **PROPOSED DRIVEWAYALTERATIONS** NICHOLAS THOMAS 239 TOLOSA STREET, GLENORCHY

DRAWING SCHEDULE

SHEET C01	DRAWING TITLE TITLE & OVERALL PLAN	REV O	D4 16
C07	VEHICLE TURNPATH 1	0	16
C08	VEHICLE TURNPATH 2	0	16

<u>WARNING</u> BEWARE OF UNDERGROUND SERVICES THE LOCATION OF UNDERGROUND SERVICES ARE APPROXIMATE ONLY AND THE EXACT POSITION SHOULD BE PROVEN ON SITE. NO GUARANTEE IS GIVEN THAT ALL SERVICES ARE SHOWN.

NOT FOR CONSTRUCTION

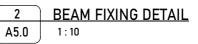DESCRIPTION

0 FOR APPROVAL

CF 16/09/2024

DATE


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DESCRIPTION

REV

GLENORCHY CITY COUNCIL PLANNING SERVICES APPLICATION No. PLN-24-063 DATE RECEIVED . 26/03/2025

DATE 16/09/2024 16/09/2024 16/09/2024

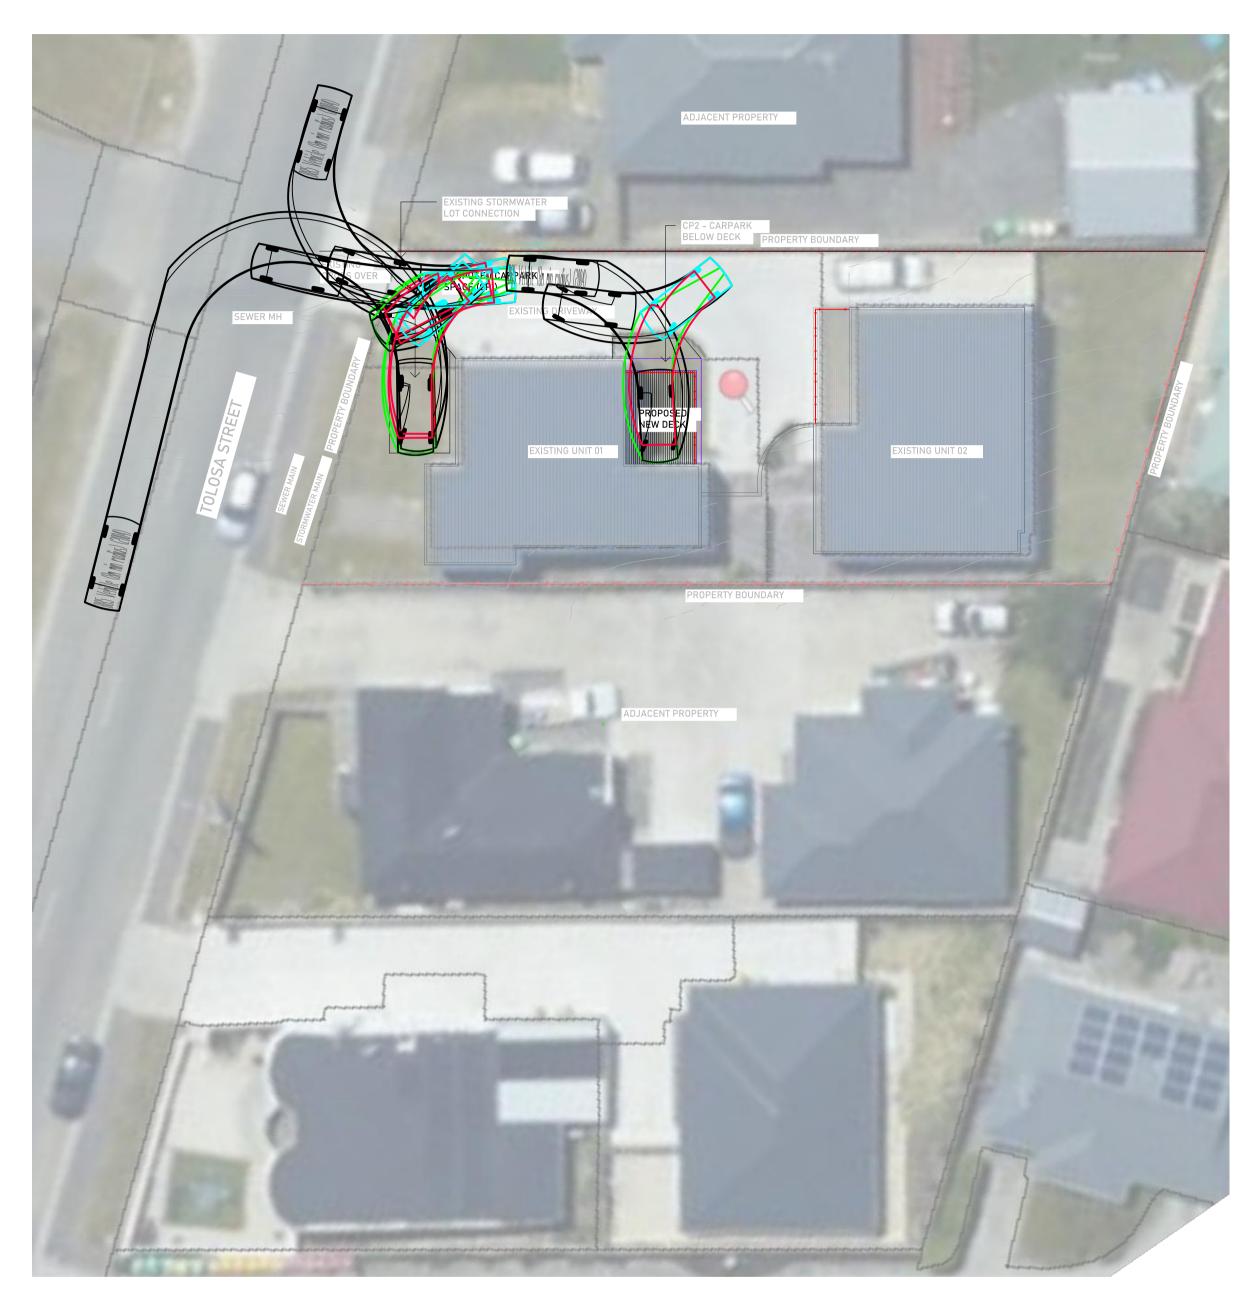

OVERALL PLAN SCALE 1:200 (mm) (A1)

BASE SURVEY SUPPLIED BY LEARY AND COX SURVEYED ON: 13/05/2022 HORIZONTAL DATUM: MGA2020 AHD 83 GRID: GDA2020, ZONE 55 LEVEL DATUM: AHD



UNIT 4, 160 BUNGANA WAY CAMBRIDGE TAS

ACCREDITATION: BSD LICENCE NO. 479819732

FYSH DESIGN

PH: 0414 149 394

NORTH \bigwedge K č



TURNPATHS

CLIENT: NICHOLAS THOMAS 239 TOLOSA STREET, GLENORCHY DRAWING TITLE TITLE AND OVERALL PLAN


SCALE 1:100 DESIGNED CF PROJECT CKD-CIV-139

DRAWN CF SHEET NO. C01

SCALE


1:100 @ A1

REVISION 0

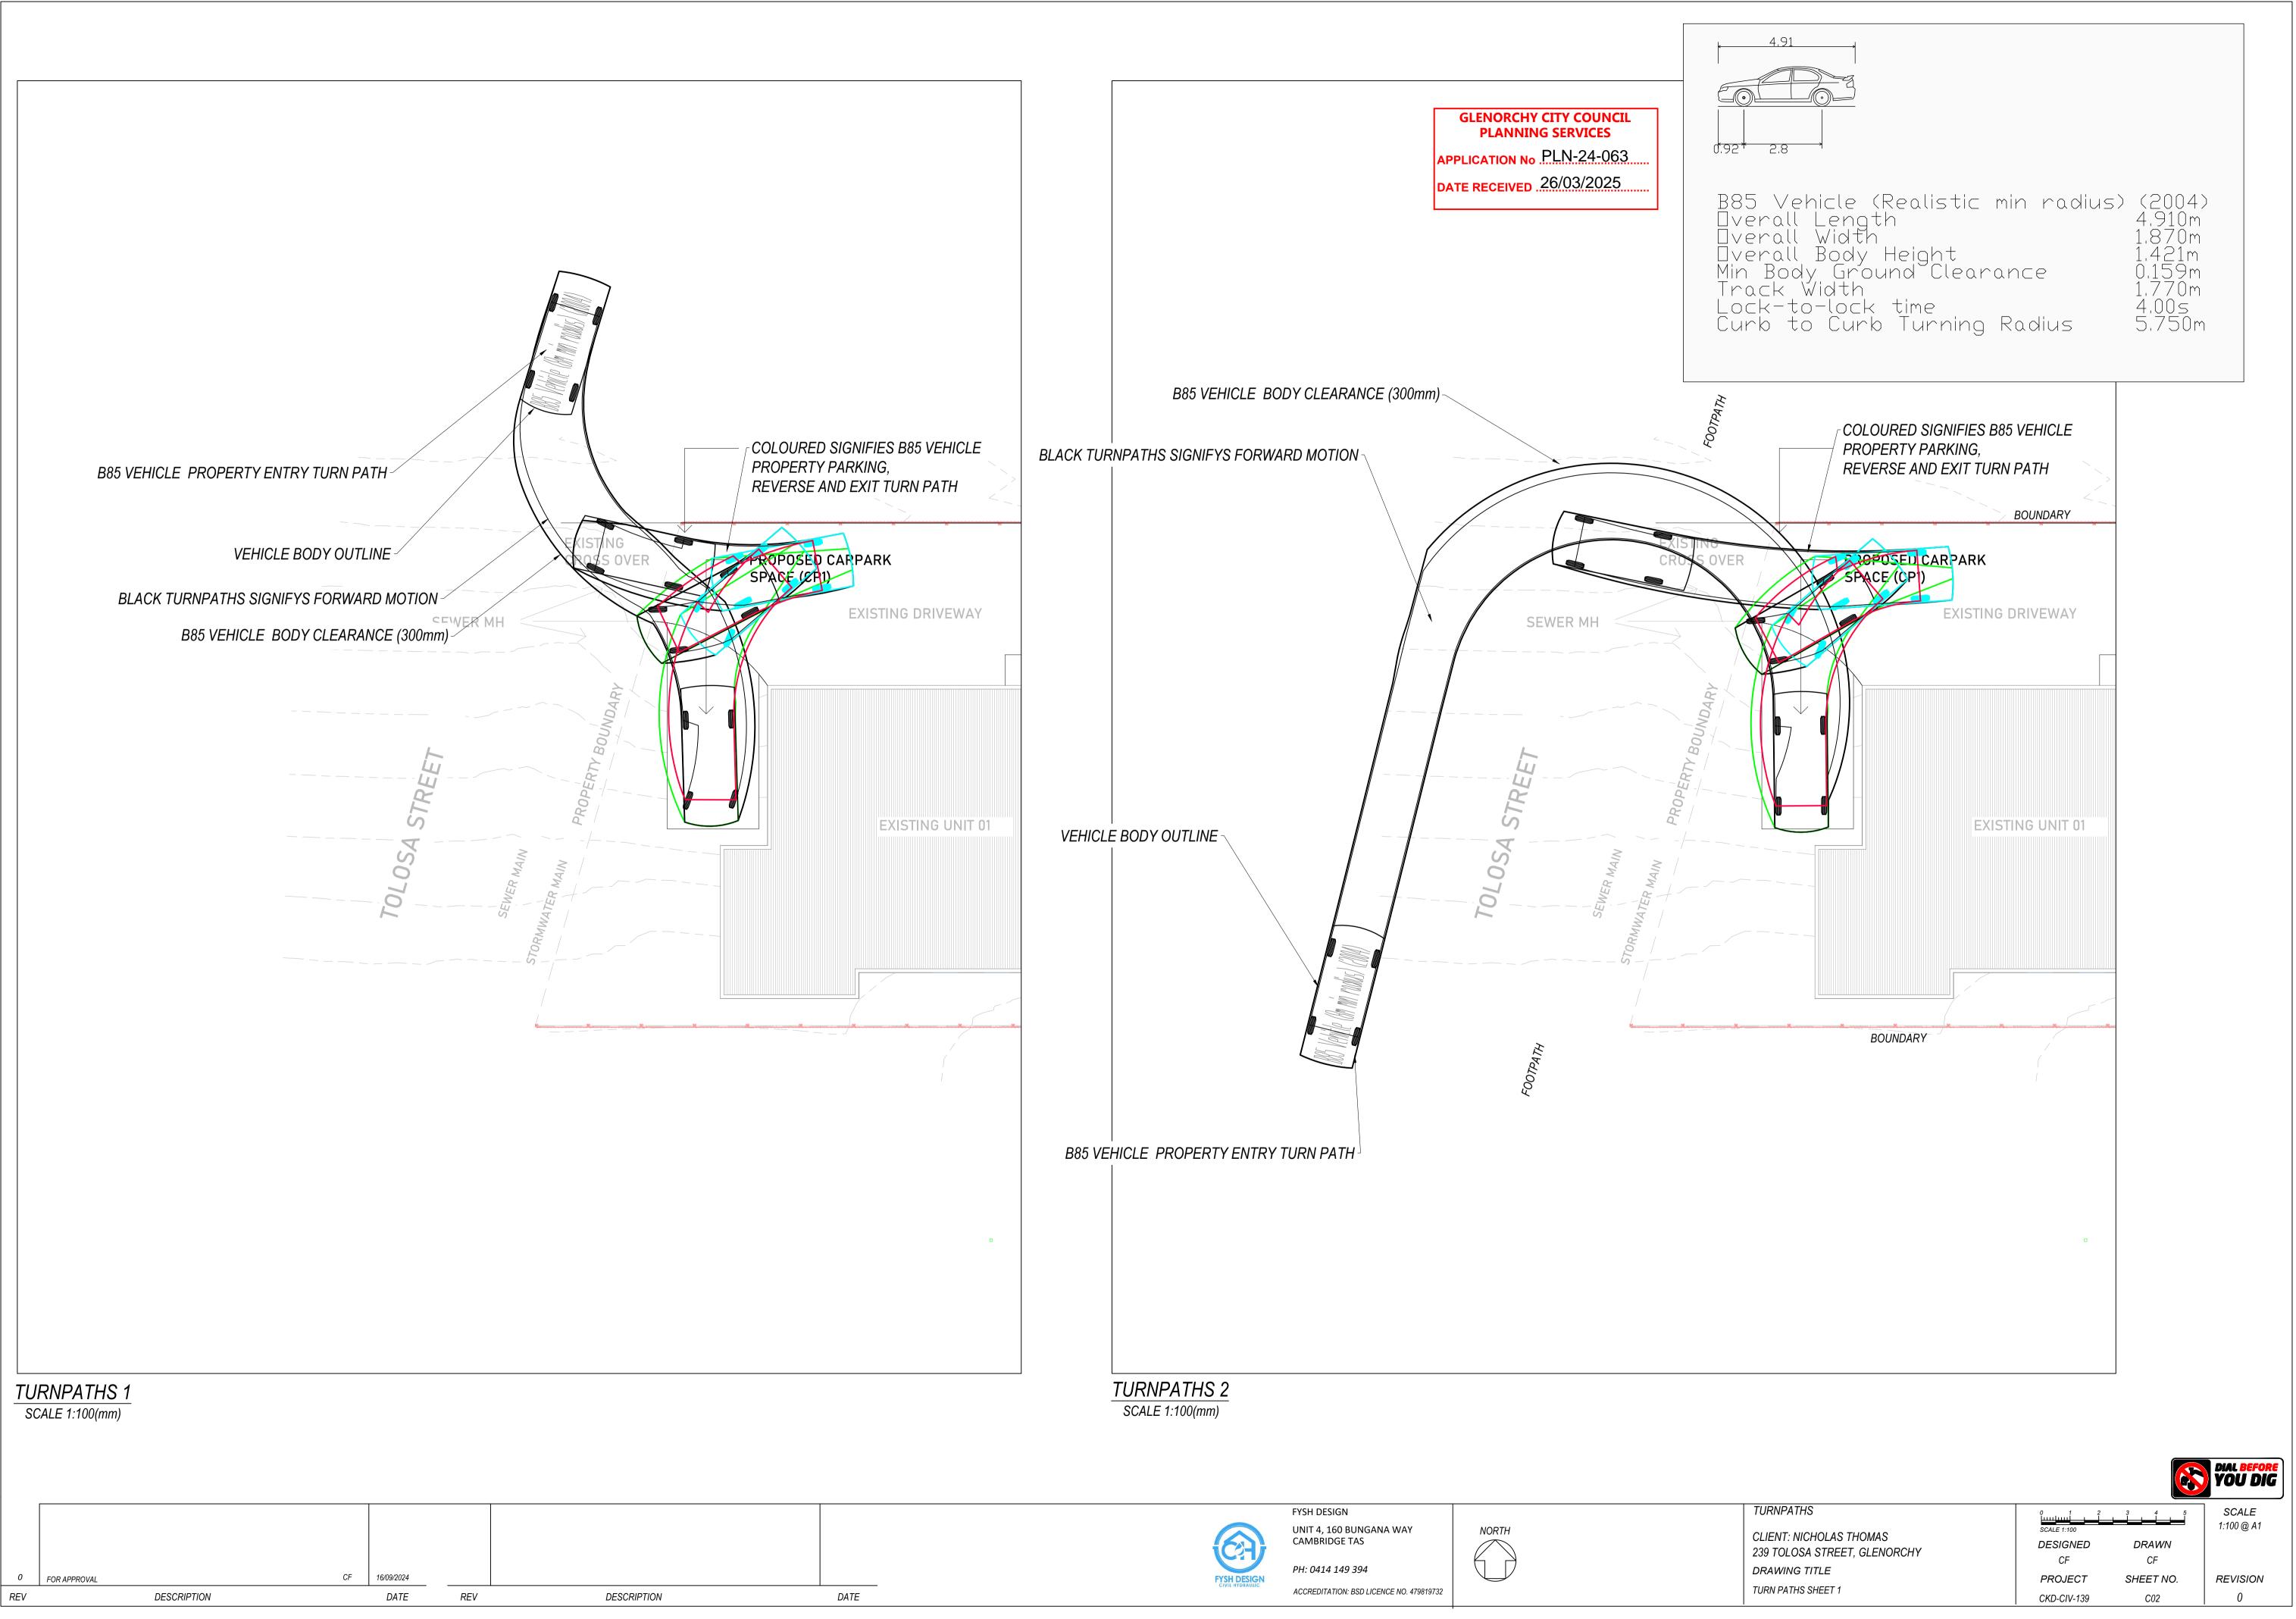

TURNPATHS	
CLIENT: NICHOLAS THOMAS	SCALE 1:100
239 TOLOSA STREET, GLENORCHY	DESIGNED
239 TOLOGA STREET, GELNOROTT	CF
DRAWING TITLE	PROJECT
TURN PATHS SHEET 1	PROJECT
TORM ATTIS SHEET	CKD-CIV-139

B85 Vehicle (Realistic min radius) (2004) Overall Length 4.910m Overall Width 1.870m Overall Body Height 1.421m Min Body Ground Clearance 0.159m Track Width 1.770m Lock-to-lock time 4.00s Curb to Curb Turning Radius 5.750m

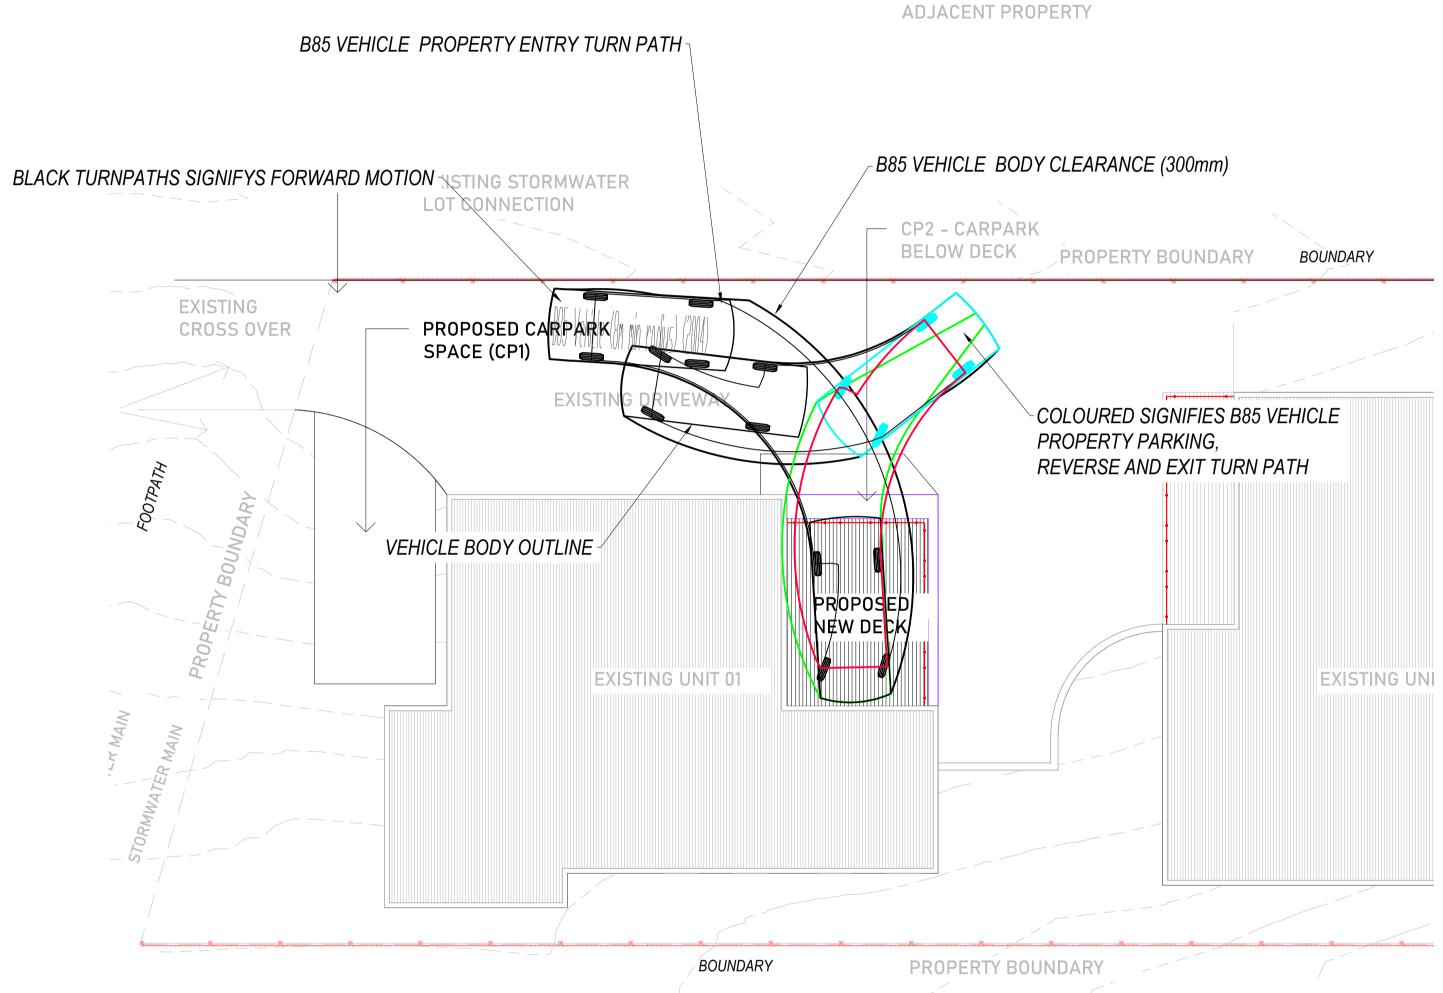

TURNPATHS 3 SCALE 1:100 (mm)

NOT FOR CONSTRUCTION

0 FOR APPROV	DESCRIPTION	CF	16/09/2024 DATE	REV	DESCRIPTION	
0 FOR APPROV	/AL	CF	16/09/2024			

ADJACENT PROPERTY



FYSH DESIGN UNIT 4, 160 BUNGANA WAY CAMBRIDGE TAS

ACCREDITATION: BSD LICENCE NO. 479819732

PH: 0414 149 394



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APPLICATION No PLN-24-063 DATE RECEIVED .26/03/2025

TURNPATHS CLIENT: NICHOLAS THOMAS 239 TOLOSA STREET, GLENORCHY DRAWING TITLE TURN PATHS SHEET 2



SCALE

DIAL BEFORE YOU DIG

REVISION 0