

DEVELOPMENT APPLICATION

APPLICATION NUMBER:	PLN-25-037
PROPOSED DEVELOPMENT:	Alterations, Addition, Change of Use to Residential (Single Dwelling), Associated Outbuildings, Vegetation Clearing, and Fill
LOCATION:	101 Suhrs Road Collinsvale
APPLICANT:	Spacewise Design Pty Ltd
ADVERTISING START DATE:	29/04/2025
ADVERTISING EXPIRY DATE:	13/05/2025

Plans and documentation are available for inspection at Council's Offices, located at 374 Main Road, Glenorchy between 8.30 am and 5.00 pm, Monday to Friday (excluding public holidays) and the plans are available on Glenorchy City Council's website (<u>www.gcc.tas.gov.au</u>) until **13/05/2025.**

During this time, any person may make representations relating to the applications by letter addressed to the Chief Executive Officer, Glenorchy City Council, PO Box 103, Glenorchy 7010 or by email to gccmail@gcc.tas.gov.au.

Representations must be received by no later than 11.59 pm on **13/05/2025**, or for postal and hand delivered representations, by 5.00 pm on **13/05/2025**.

DRAWIN

A00 A01

A02 A03 A04 A05 A06

A07 A08

A09 A10

A10 A11

GLENORCHY CITY COUNCIL PLANNING SERVICES APPLICATION No.: PLN-25-037 **DATE RECEIVED:** 16/04/2025

DWELLING AND OUTBUILDINGS (RETROSPECTIVE APPROVAL) 101 SUHRS ROAD | COLLINSVALE

LOCATION PLAN

Raymond Green DRAWING TITLE: Cover Page CLIENT: Retrospective Approval Spacewise Design Pty Ltd 101 Suhrs Road COLLINSVALE TAS ADDRESS: acewise ABN 72 604 335 408 mariska@spacewisedesign.com.au 0412 040 035 License number: 665044574 STAGE: DA design.com.au ZONING: Rural COUNCIL: City of Glenorchy

Certificate of Title Reference (Volume/Folio)

Low landslip hazard band, Medium landslip hazard band, Waterway and coastal protection area, Bushfire-prone areas,

Priority vegetation area, Scenic protection area

170917/1

Municipality

Planning Codes Overlay

Tasmanian Planning Scheme

Planning Scheme

Glenorchy

Document Set ID: 3480891 Version: 1, Version Date: 16/04/2025

SOIL CLASSIFICATION: CLAY LOAM (category 4)

BAL 19

Property Identification Number 3460096 Locality

COLLINSVALE

Planning Zones Rural

Total Area


207600 sqm



NG No.	DESCRIPTION
	Cover Page
	Unsealed Road R01
	Site Plan with Access Road
	Site Plan with Storm Water Plan 1:300
	Site Plan 1:500
	Cleared Areas
	Floor Plan Dwelling (As-Built)
	Upper Floor Plan As-Built
	Roof Plans
	Elevations
	Shed 03 and Cubby 06 As-Built
	Shed 01
	Sections Driveway
	Shed 02
	Sections Driveway




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		PRINT DATE:
		14/4/2025

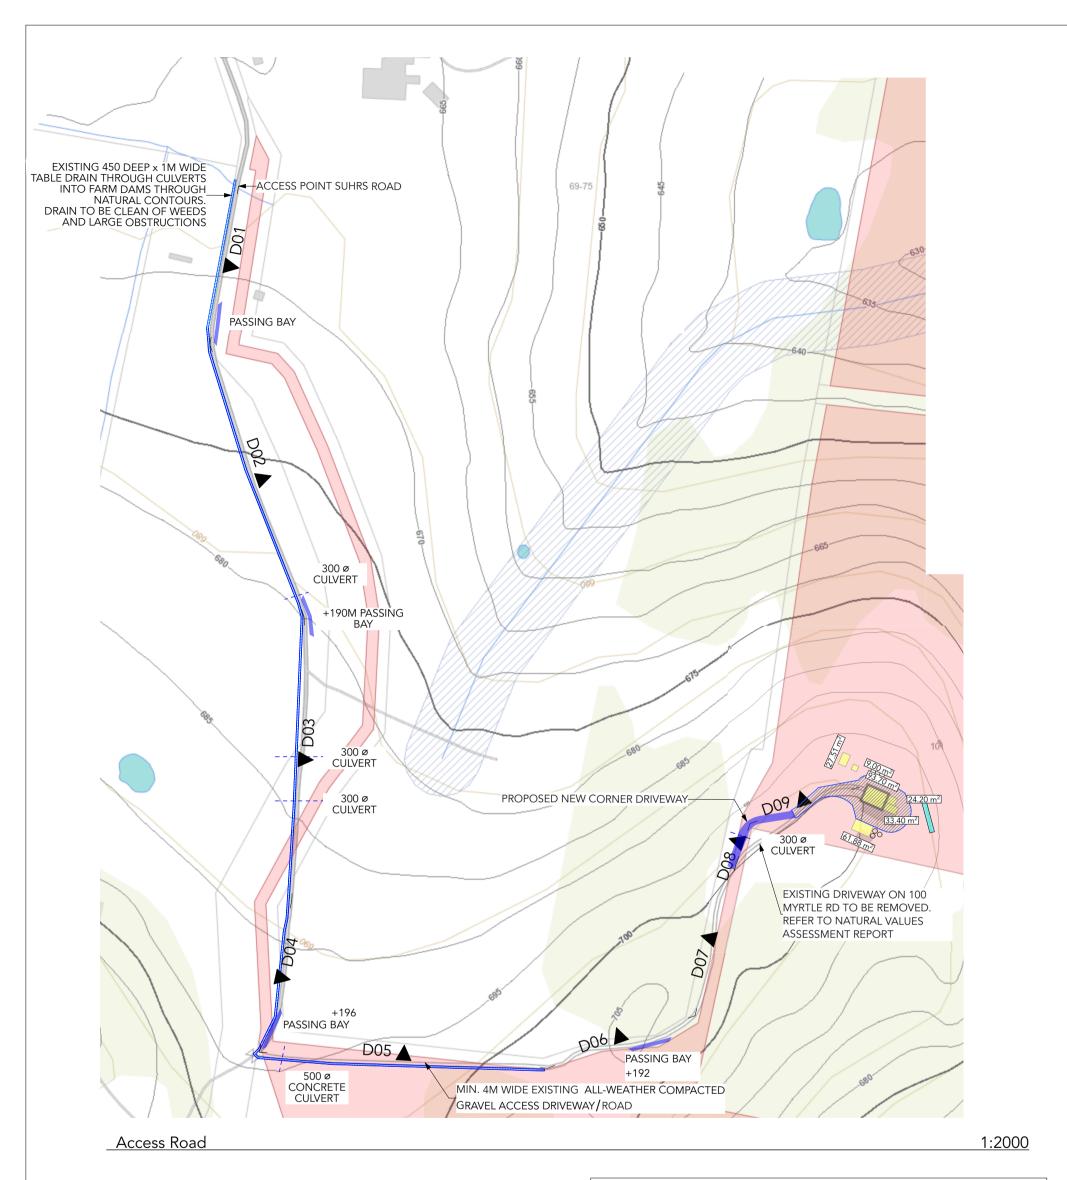

				RELEVANT DR	AWINGS INCLUDE: 1	AND IPWEA TASMANIAN SUBDIV ISD-R01-V3 RURAL ROADS UNSEA	
			CITY COUNCIL	ALL ROAD AND ROADWORKS S	STORMWATER WOR SPECIFICATIONS DSC	ACCESS TSD-R04-V3 RKS ARE TO BE IN ACCORDANCE G (FORMERLY DIER) SPECIFICATIO S R23 SUBGRADE ZONE R24 GE0	DNS: R21 CLEARING
	AP	PLICATION No	• : PLN-25-037			3 SUBSURFACE DRAINAGE AN 300MM IS TO BE APPROVED E	Y COUNCIL. FILLING
	DA	ATE RECEIVED	16/04/2025	DEVELOPMEN		WORKS FOR COMMERCIAL AND O BE UNDERTAKEN IN MAX 3001	
				<u>STORMWATER</u> STANDARD DR TO ACHIEVE IN EXPOSED BATT	ALL STORMWATER T AWINGS AND SPEC IPERMEABLE SURFAC TERS AND DRAINS AI ALL SURFACES AND	TO BE IN ACCORDANCE WITH IP IFICATIONS. GRAVEL TO BE FINE CE. 5, PLACE 150mm NON DISPE ND GRASS. AND KEEP STOCK OI DRAINS TO BE GRADED SO THEF	AND COMPACTED RSIVE TOPSOIL OVER FF UNTIL GRASS
mariska@spacewisedesign.com.au	CLIENT:	Raymond Green		DRAWING TIT	LE:	APPROVED BY	© COPYRIGHT PRINT DATE:
0412 040 035	ADDRESS:	101 Suhrs Road CO	LLINSVALE TAS	Site Plan with		CLIENT:	14/4/2025
design.com.au	ZONING:	Rural (COUNCIL: City of Glenorchy	STAGE:	DA	Retrospective Approval	SHEET NR: A00

Document Set ID: 3480891 Version: 1, Version Date: 16/04/2025

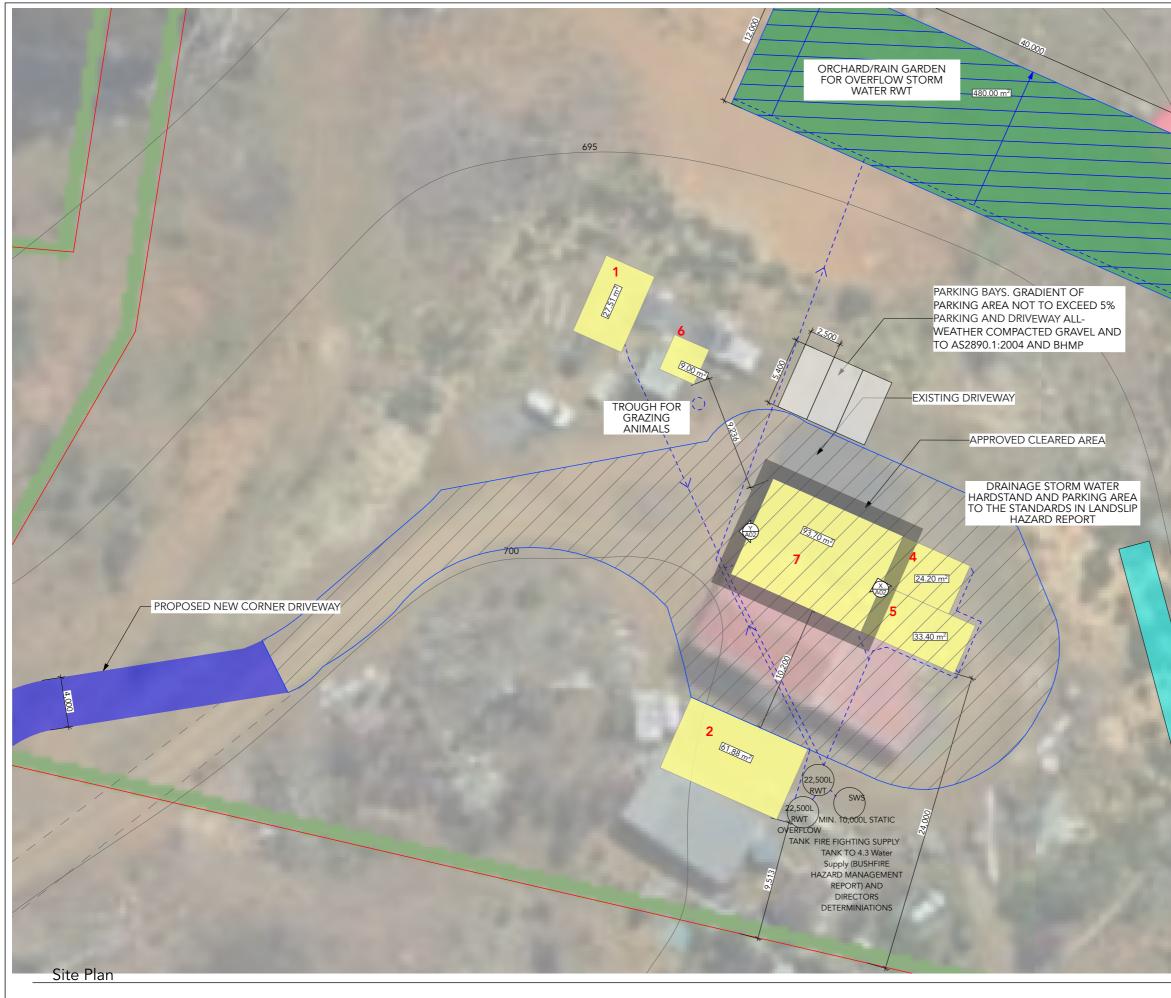

spacewse	Spacewise Design Pty Ltd ABN 72 604 335 408 maricka@spacewisedesign.com au	CLIENT: ADDRESS:	Raymond Green 101 Suhrs Road COLLINSVALE TAS	DRAWING TITLE: Site Plan with Storm Water Plan 1:300	Retrospective Approval
design.com.au	0412 040 035 License number: 665044574 ZONING: Rural	COUNCIL: City of Glenorchy		STAGE: DA	



MINIMUM DRIVEWAY, HARD STAND AND TURNING CIRCLE FIRE TRUCK

PROPOSED DRIVEWAY


GLENORCHY CITY COUNCIL PLANNING SERVICES

APPLICATION No.: PLN-25-037


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1:300



Spacewise Design Pty Ltd ABN 72 604 335 408 mariska@spacewisedesign.com.au		Raymond Green 101 Suhrs Road COLLINSVALE TAS	DRAWING TITLE: Site Plan 1:500	Retrospective Approval
SIGILcom au	ZONING: Rural	COUNCIL: City of Glenorchy		STAGE: DA

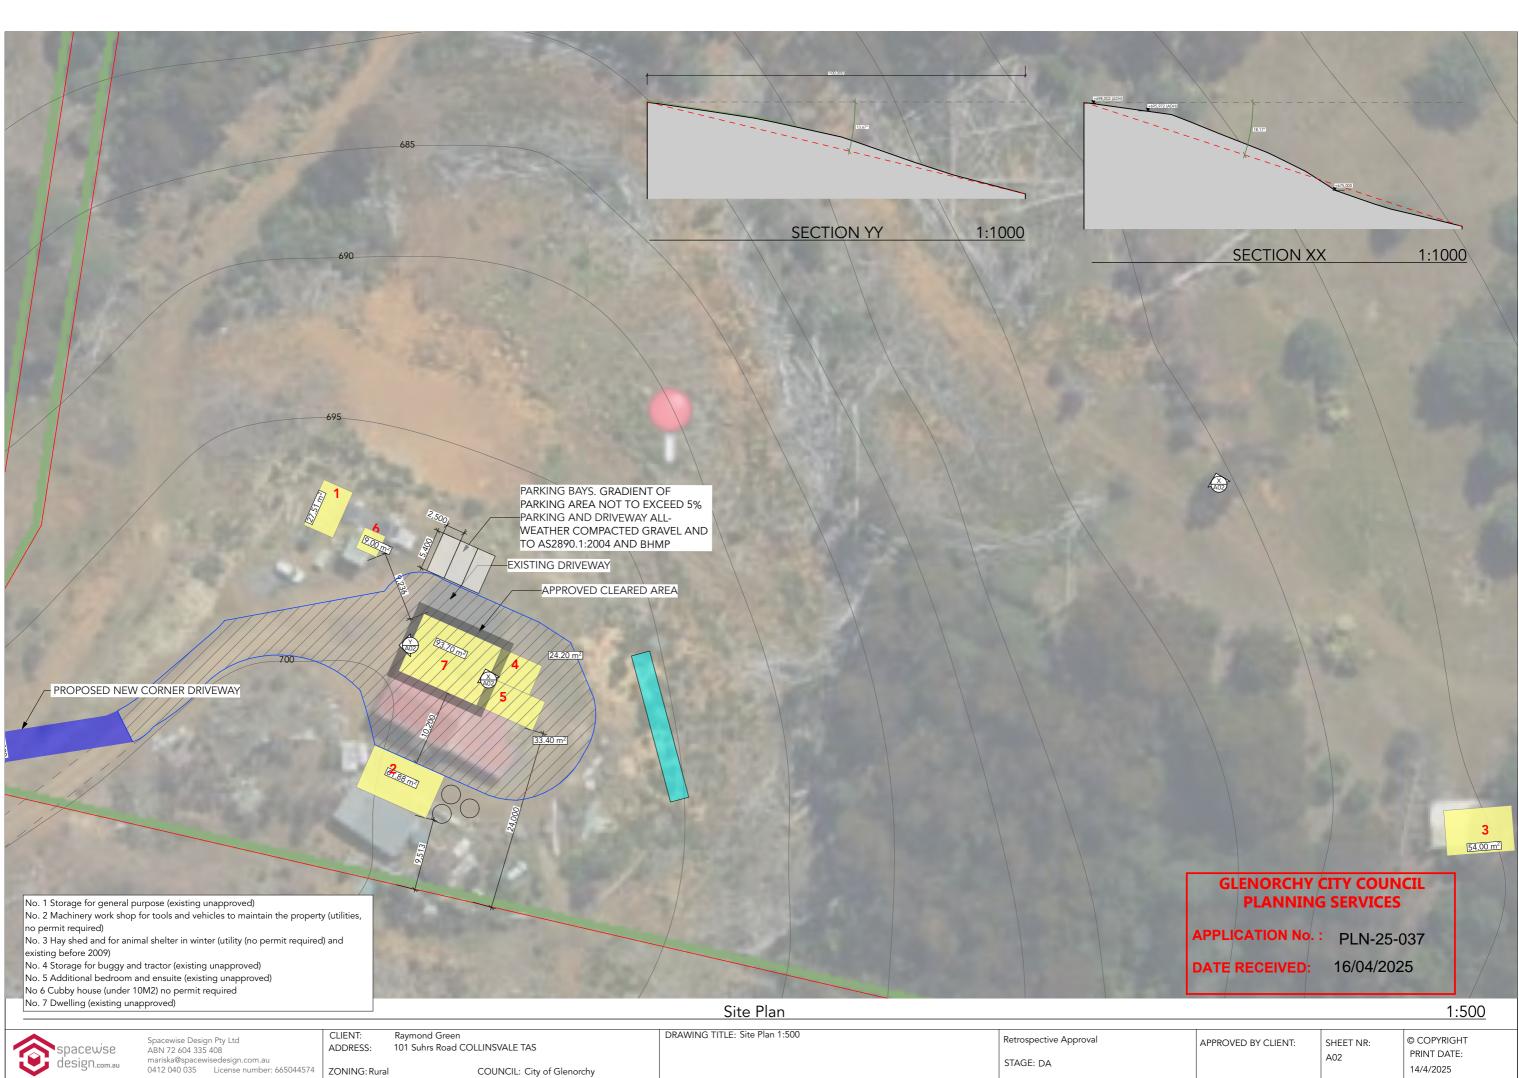


	Spacewise Design Pty Ltd ABN 72 604 335 408 mariska@snacewisedesign.com.au	CLIENT: ADDRESS:	Raymond Green 101 Suhrs Road COLLINSVALE TAS	DRAWING TITLE: Cleared Areas	Retrospective Approval
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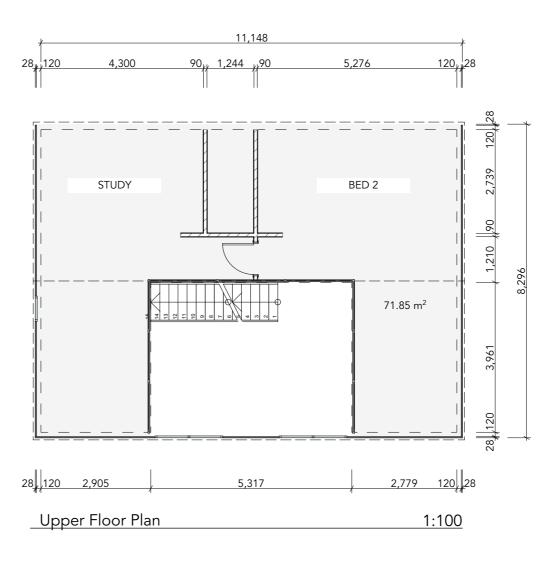
	Spacewise Design Pty Ltd ABN 72 604 335 408 mariska@snacewisedesign.com.au	CLIENT: ADDRESS:	Raymond Green 101 Suhrs Road COLLINSVALE TAS	DRAWING TITLE: Floor Plan Dwelling (As-Built)	Retrospective Approval
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GLENORCHY CITY COUNCIL PLANNING SERVICES

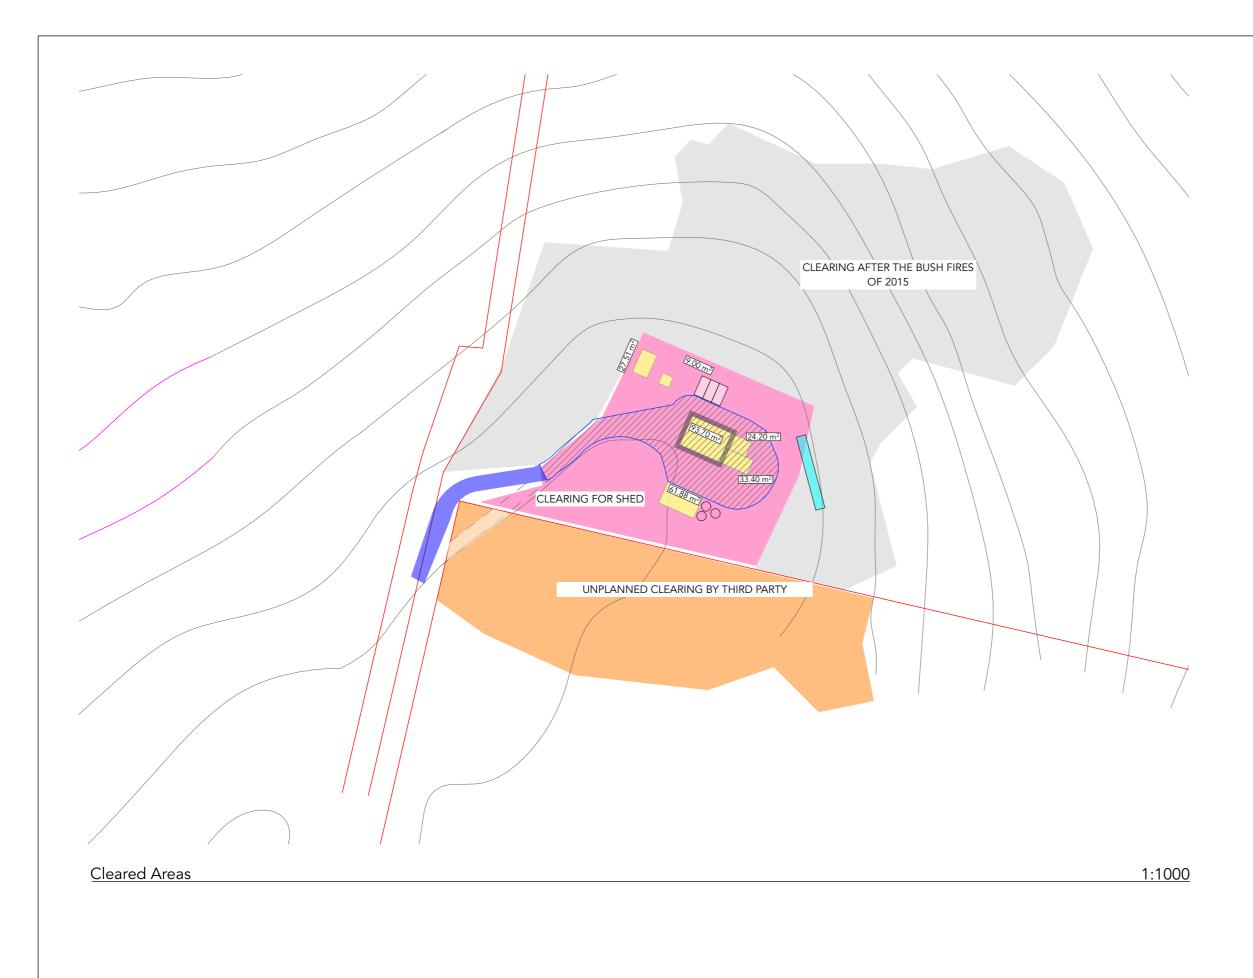 APPLICATION No. :
 PLN-25-037

 DATE RECEIVED:
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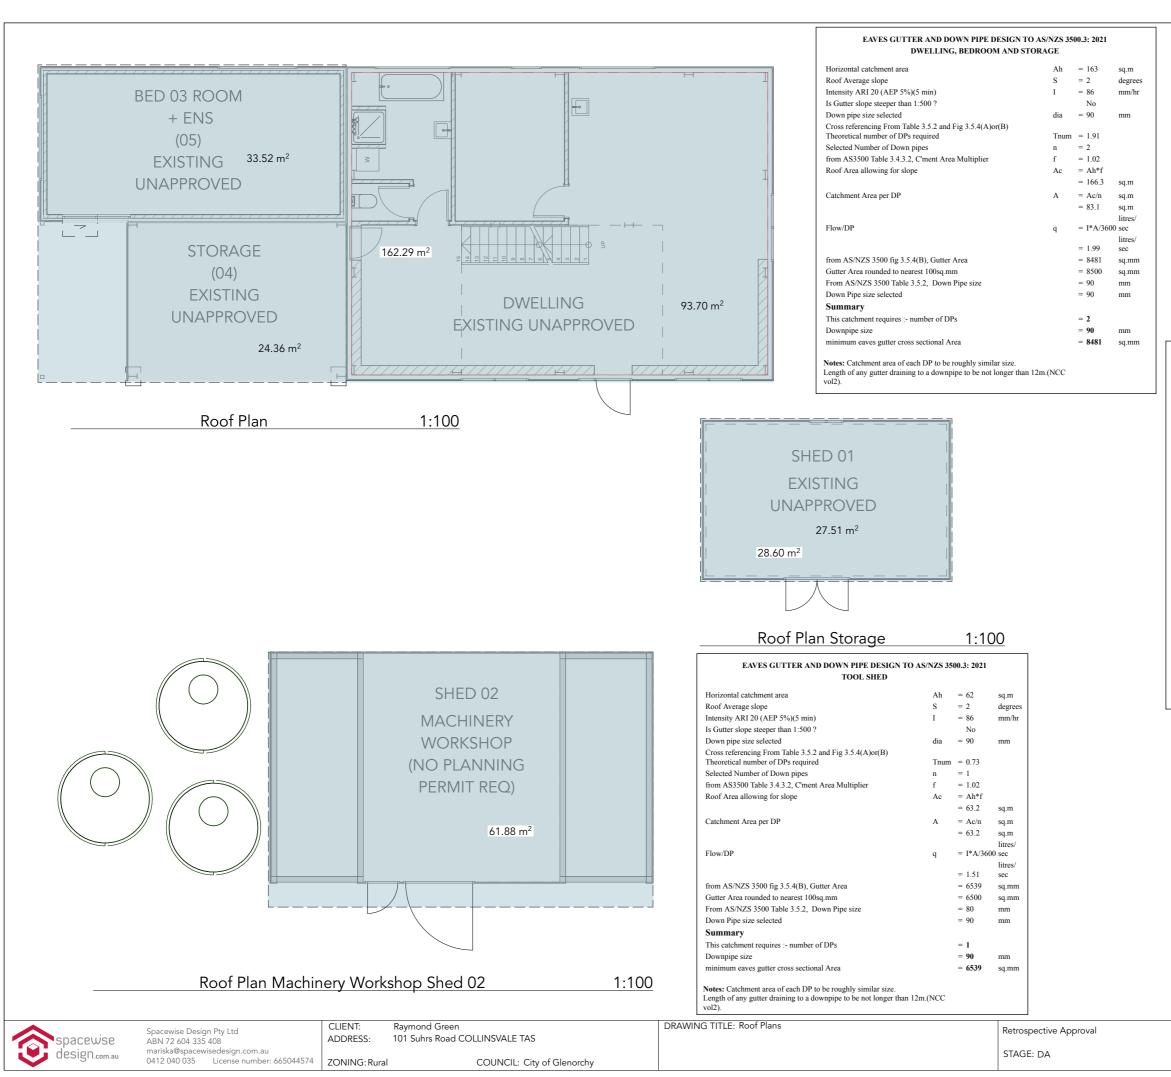
spacewise	Spacewise Design Pty Ltd ABN 72 604 335 408	CLIENT: ADDRESS:	Raymond Green 101 Suhrs Road COLLINSVALE TAS	DRAWING TITLE: Upper Floor Plan As-Built	Retrospective Approval
design.com.au	1.com.au mariska@spacewisedesign.com.au 0412 040 035 License number: 665044574 ZONING:Rural	COUNCIL: City of Glenorchy		STAGE: DA	

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APPLICATION No. : PLN-25-037
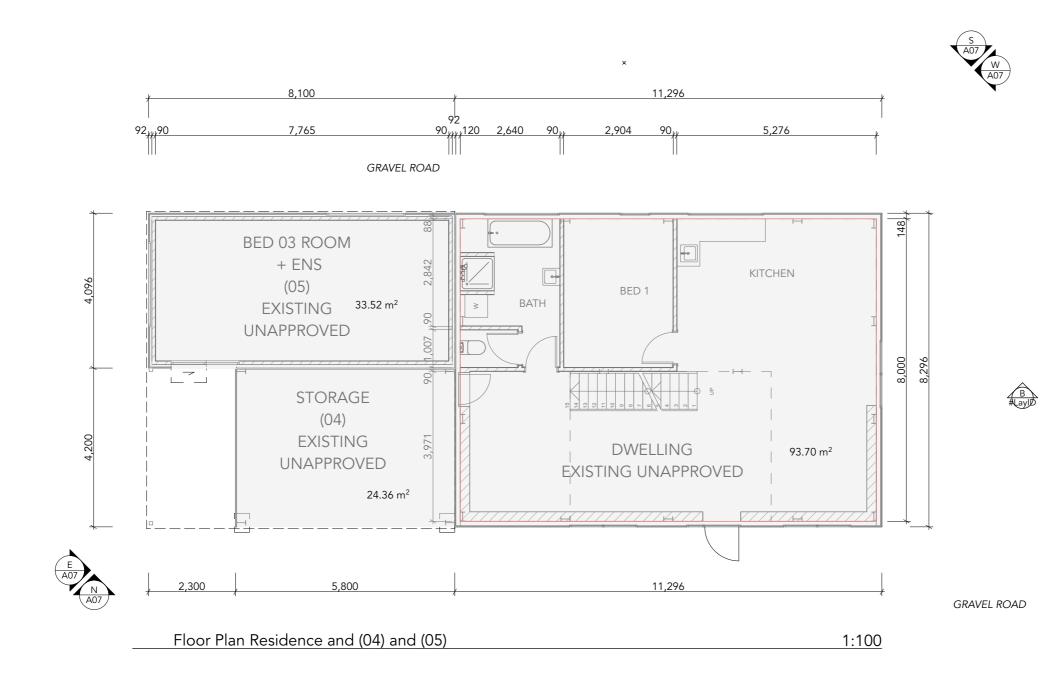
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GLENORCHY CITY COUNCIL PLANNING SERVICES

APPLICATION No. : PLN-25-037 DATE RECEIVED: 16/04/2025

EAVES GUTTER AND DOWN PIPE DESIGN TO AS/NZS 3500.3: 2021 STORAGE					
Horizontal catchment area	Ah	= 29	sq.m		
Roof Average slope	S	= 2	degrees		
Intensity ARI 20 (AEP 5%)(5 min)	Ι	= 86	mm/hr		
Is Gutter slope steeper than 1:500 ?		No			
Down pipe size selected	dia	= 90	mm		
Cross referencing From Table 3.5.2 and Fig 3.5.4(A)or(B) Theoretical number of DPs required	Tnum	= 0.34			
Selected Number of Down pipes	n	= 1			
from AS3500 Table 3.4.3.2, C'ment Area Multiplier	f	= 1.02			
Roof Area allowing for slope	Ac	= Ah*f			
		= 29.6	sq.m		
Catchment Area per DP	Α	= Ac/n	sq.m		
		= 29.6	sq.m		
			litres/		
Flow/DP	q	= I*A/360	00 sec		
			litres/		
		= 0.71	sec		
from AS/NZS 3500 fig 3.5.4(B), Gutter Area		= 3252	sq.mm		
Gutter Area rounded to nearest 100sq.mm		= 3300	sq.mm		
From AS/NZS 3500 Table 3.5.2, Down Pipe size		= 65	mm		
Down Pipe size selected		= 90	mm		
Summary					
This catchment requires :- number of DPs		= 1			
Downpipe size		= 90	mm		
minimum eaves gutter cross sectional Area		= 3252	sq.mm		
Notes: Catchment area of each DP to be roughly similar size. Length of any gutter draining to a downpipe to be not longer than vol2).	12m.(NCC				


STORM WATER HARVEST: 254M² x 626mm p/y = 159,004L p/y

TOTAL RWT (EXCLUDING FIRE FIGHT TANK) 2 x 22,500L = 45,000L

AVERAGE USAGE (2x 200L p/d x 365) = 146,000


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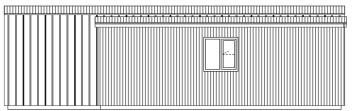


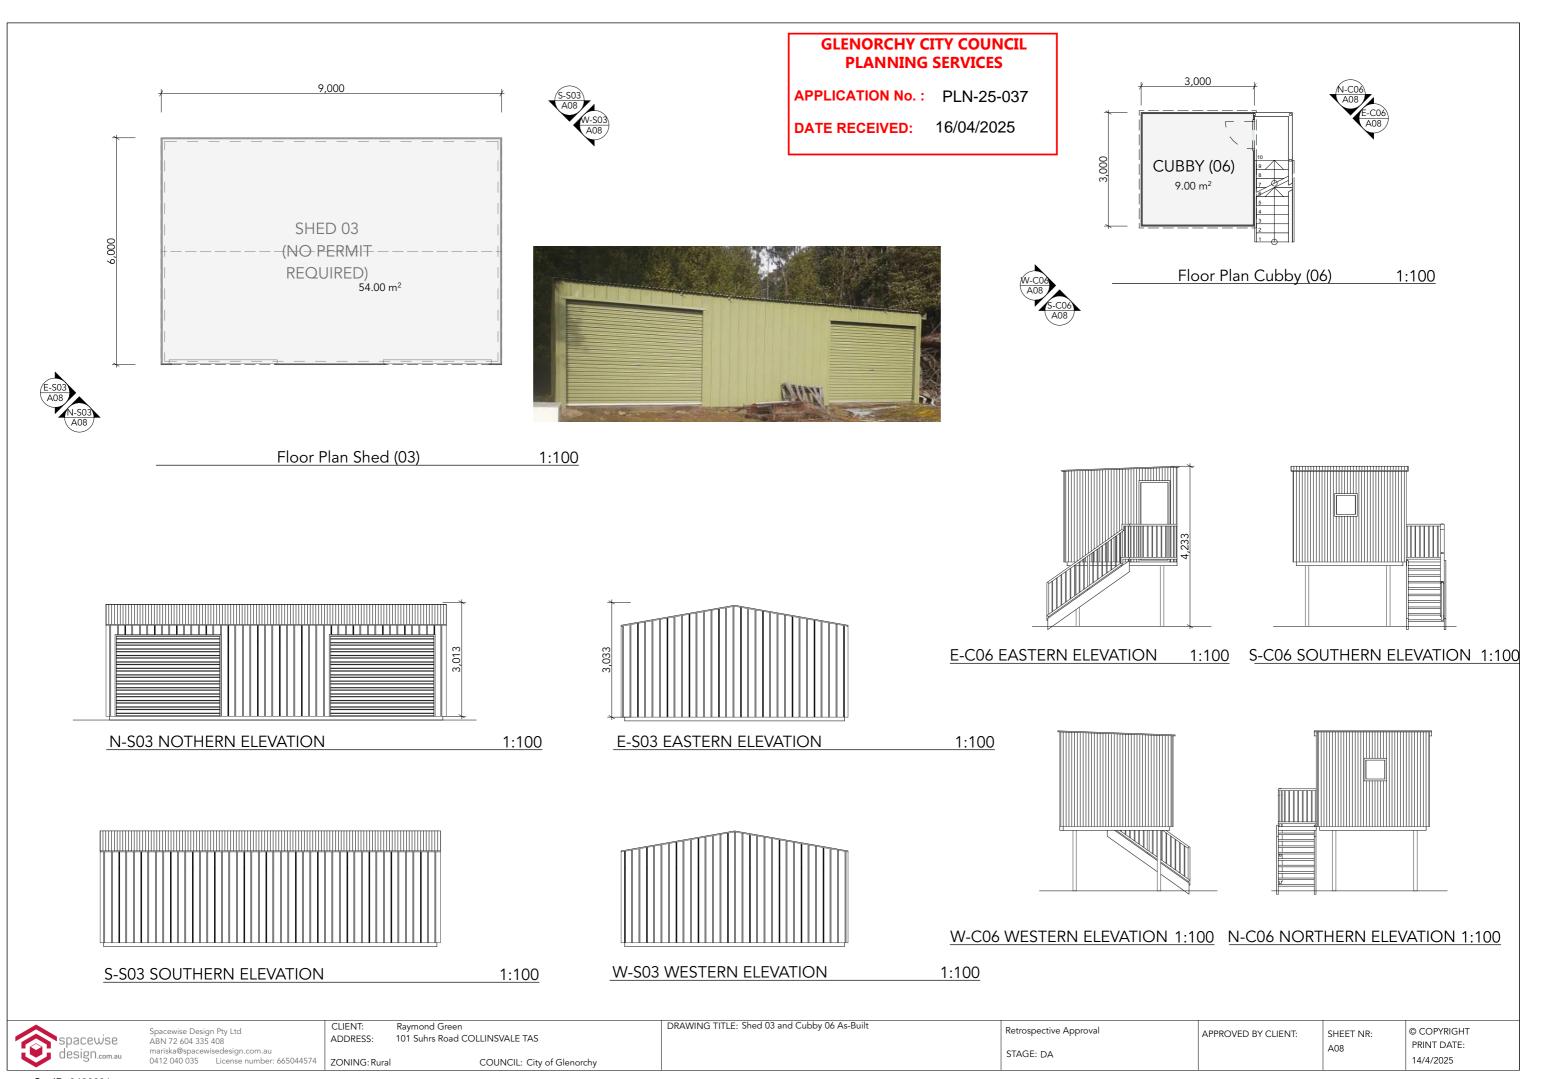


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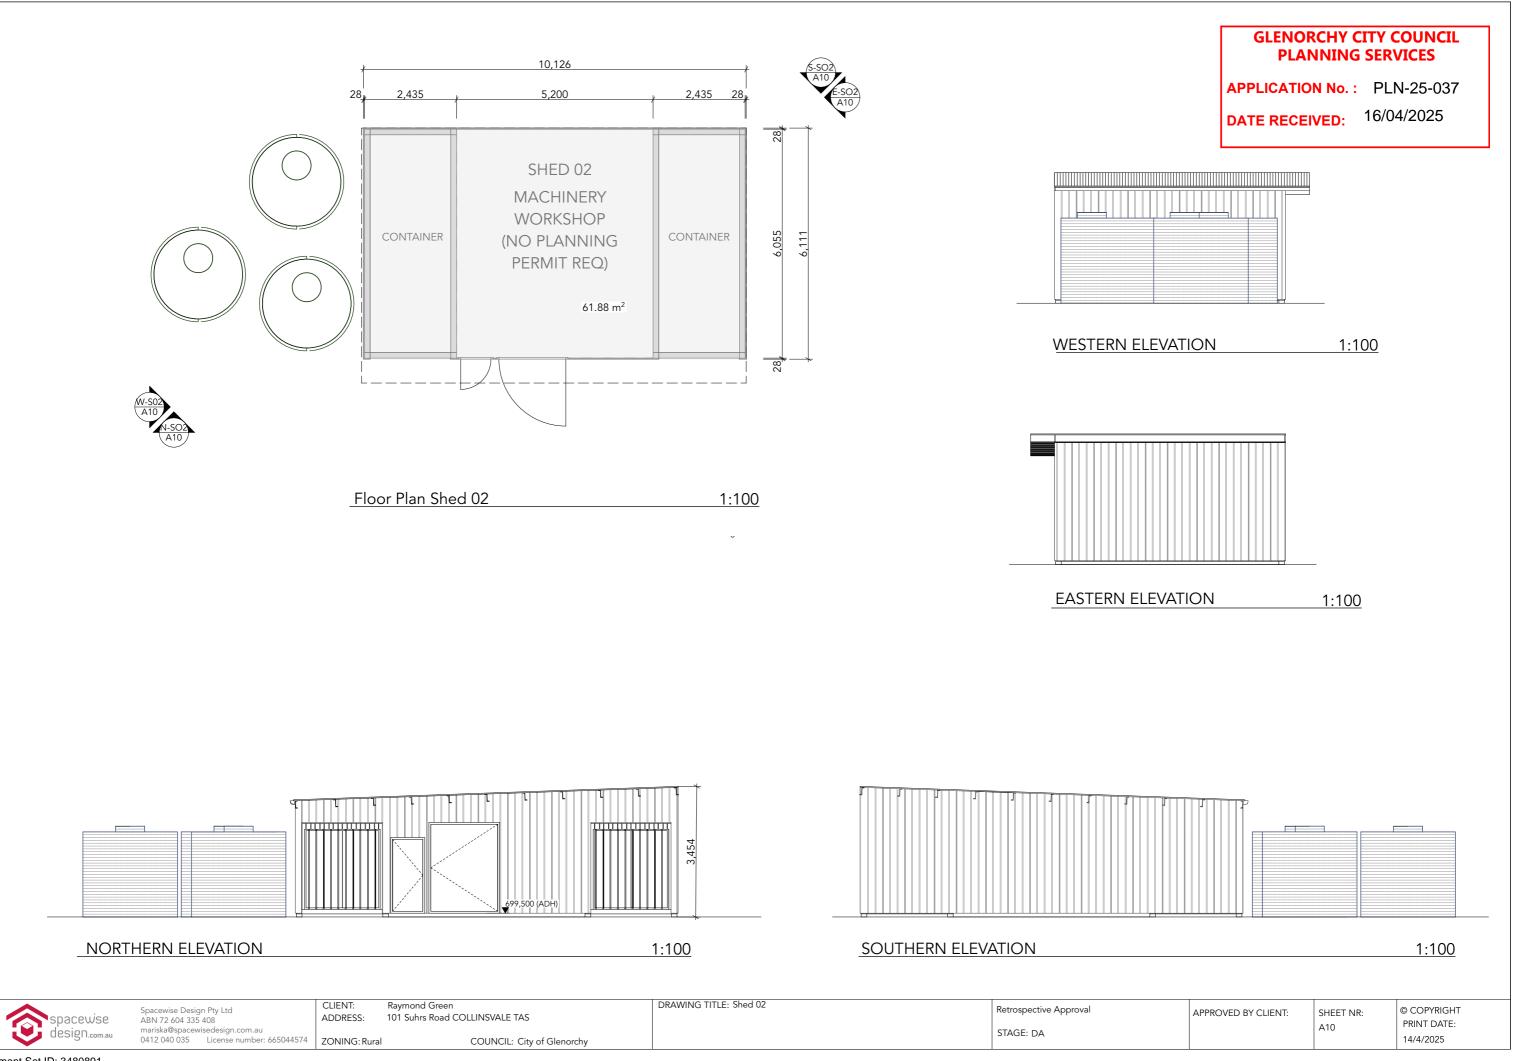
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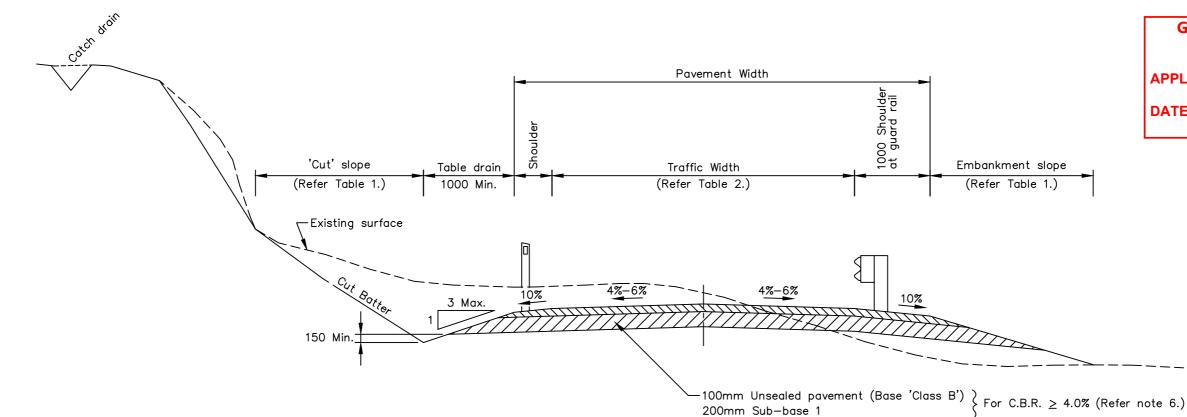




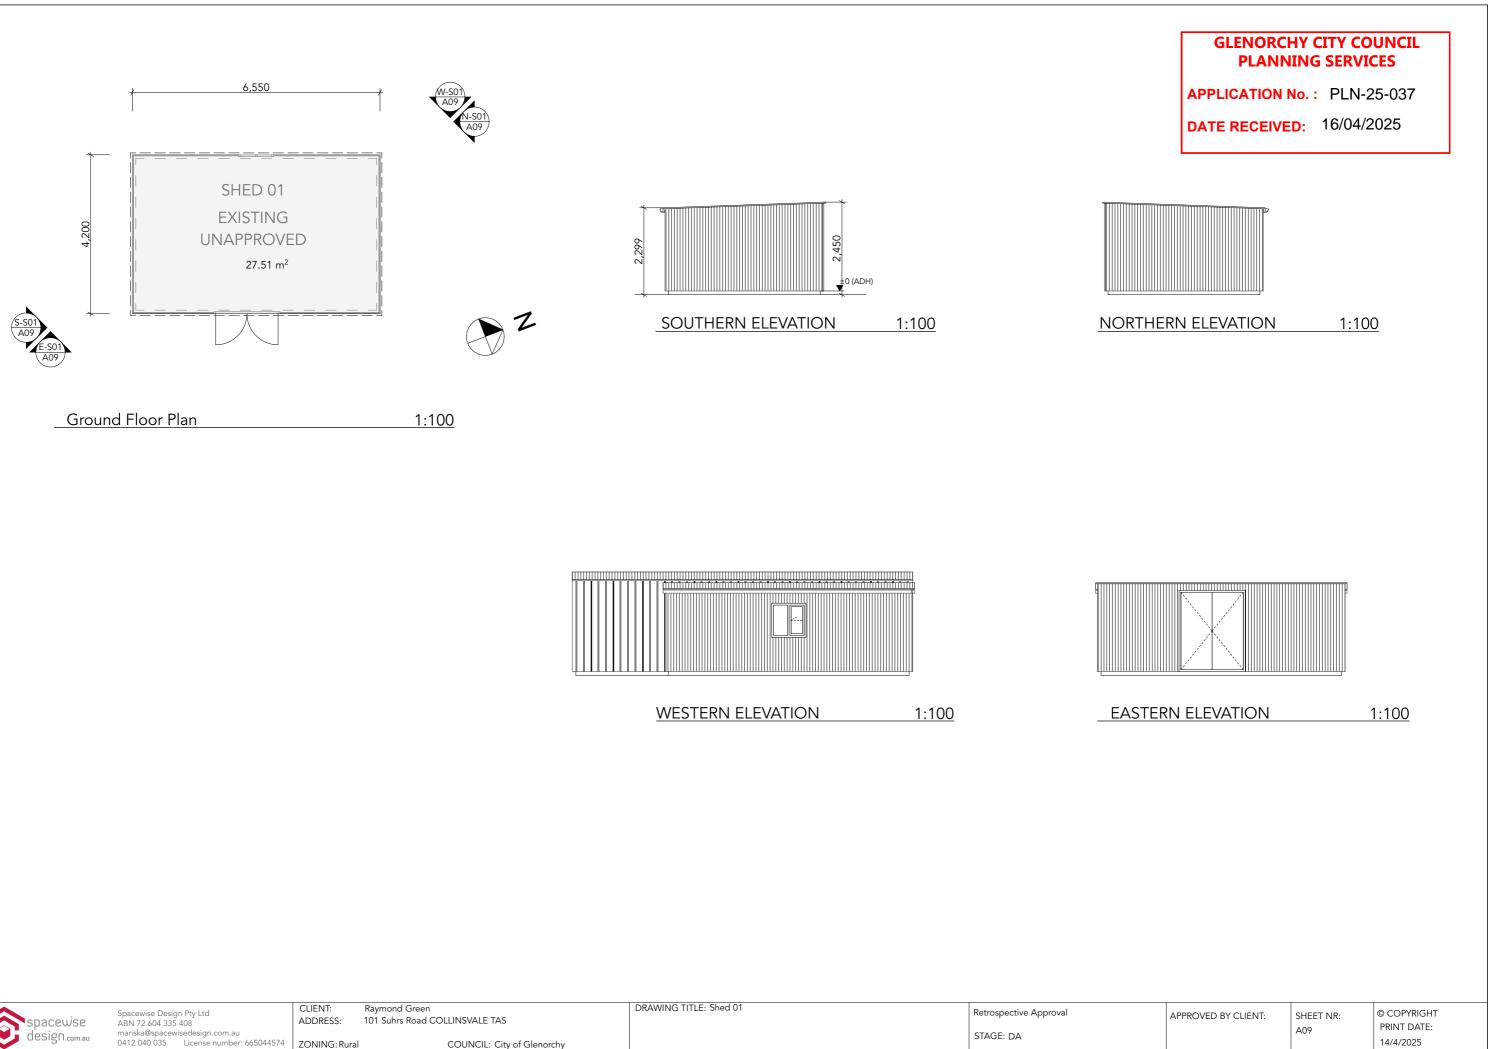

spacewise	Spacewise Design Pty Ltd ABN 72 604 335 408	CLIENT: ADDRESS:	Raymond Green 101 Suhrs Road COLLINSVALE TAS	DRAWING TITLE: Shed 01	Retrospective Approval
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TYPICAL CROSS SECTION SCALE 1 : 50

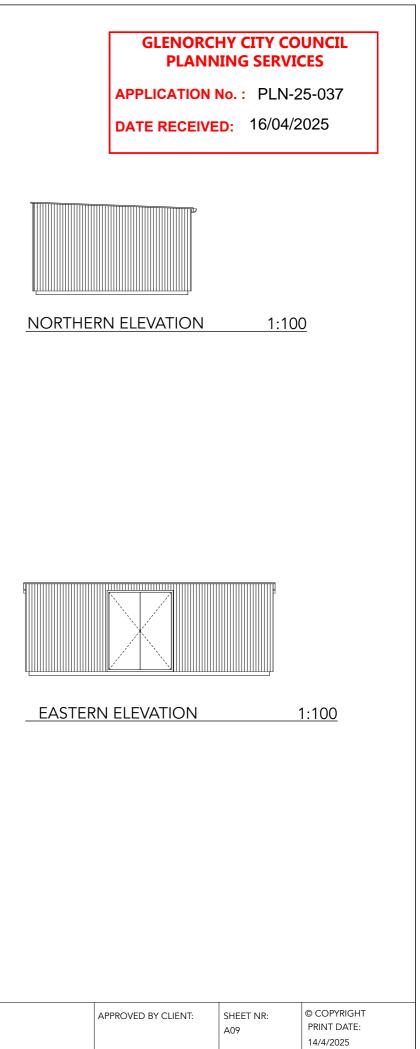TABLE 1

SOIL / ROCK TYPE	EMBAN	KMENT	CUTTING		
SUL / RUCK TIFE	Vertical	Horizontal	Vertical	Horizontal	
Solid Rock	-	-	1.00	0.25	
Loose Rock	1.00	2.00	1.00	1.33	
Sand	1.00	3.00	1.00	3.00	
Stiff Clay	1.00	1.00	1.00	1.00	
Soft Clay	1.00	3.00	1.00	1.50	


TABLE 2

CODE*	A.A.D.T.	(w) TRAFFIC WIDTH	GRAVEL SHOULDER	VERGE	PAVEMENT WIDTH	LOGGING ROUTE	HEAVY VEHICLES	BUS ROUTE	Bends with < 60m sight line
US1	<30	4000 (S)	500	NO	5	NO	< 5%	NO	w + 1000
US2	30 - 100	4000 (S)	1000	NO	6	YES < 5%	< 5 %	YES	w + 1000
US3	100 - 300	5500 (D)	1000	NO	7.5	YES	< 10%	YES	w + 500
US4	> 300	6000 (D)	1000	NO	8	YES	> 10%	YES	w + 500

*To satisfy a Road Class (eq. US3) the capability to comply with A.A.D.T, LOGGING ROUTE, HEAVY VEHICLE and BUS ROUTE

is necessary.

(S) - SINGLE LANE (D) - DUAL LANE

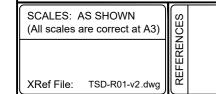

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NOTES

1. Alignment to satisfy min. Design speed.

with the procedures in either:

• Austroads - Pavement Design (2004)



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2. Roadside table drains, cut off drains and culverts to be installed to suit topography. 3. Provision for widening or passing bays may be required where sight distance requirements cannot be met or there are limited options for vehicles to pull off the road. 4. Refer Sheets TSD-R25, TSD-R28, TSD-R29 and TSD-R30 for Guide Post / Guard Rail installation. 5. Refer to Austroads AGRD-10 Part 6: Roadside Design, Safety and Barriers 6. Design of pavements to consider project traffic loading, sub-grade strength and comply • A.R.R.B. A.P.R.G. Report no. 21, A Guide to the Design of New Pavements for Light Traffic. 'A Guide To The Structural Design Of Road Pavements'

STANDARD DRAWING RURAL ROADS UNSEALED

arie Street, Hobart Tasmania 7000	ISSUE DATE:	DWG No.	
il: admin@lgat.tas.gov.au	28-04-2020		TSD-R01-v2
	(20-04-2020		