

DEVELOPMENT APPLICATION

APPLICATION NUMBER: PLN-24-272

PROPOSED DEVELOPMENT: Three Multiple Dwellings (one existing and two

new)

LOCATION: 3 Morriss Avenue Montrose

APPLICANT: Pinnacle Drafting & Design

ADVERTISING START DATE: 25/07/2025

ADVERTISING EXPIRY DATE: 08/08/2025

Plans and documentation are available for inspection at Council's Offices, located at 374 Main Road, Glenorchy between 8.30 am and 5.00 pm, Monday to Friday (excluding public holidays) and the plans are available on Glenorchy City Council's website (www.gcc.tas.gov.au) until 08/08/25.

During this time, any person may make representations relating to the applications by letter addressed to the Chief Executive Officer, Glenorchy City Council, PO Box 103, Glenorchy 7010 or by email to gccmail@gcc.tas.gov.au.

Representations must be received by no later than 11.59 pm on **08/08/25** or for postal and hand delivered representations, by 5.00 pm on **08/08/25**.

ABN 19 753 252 493

PINNACLE







3 Morriss Ave, Montrose 7010

Owner(s) or Clients
Building Classification
Designer
Total Floor Area (Combined)
Alpine Area

Other Hazards
(e.g., High wind, earthquake, flooding, landslip, dispersive soils, sand dunes, mine subsidence, landfill, snow & ice, or other relevant factors)

Amandeep Singh

1a

Jason Nickerson CC6073Y

Refer to Floor Plans

N/A

N/A

Title Reference 60985/13

Zoning General Residential

Land Size 1241m²

Design Wind Speed TBA

Soil Classification TBA

Climate Zone 7

Corrosion Environment Low

Bushfire Attack Level (BAL) TBA

ID Sheet Name Issue A0.01 DA - 04 Location Plan DA - 04 A0.02 Site Plan - Existing A0.03 Site Plan - Demolition DA - 04 A0.04 Site Plan - Proposed DA - 04 A0.05 Site Elevations DA - 04 DA - 04 A1.01 U1 - Floor Plan A1.02 U1 - Elevations DA - 04 A1.03 U1 - Elevations DA - 04 A1.04 U1 - Roof Plan DA - 04 A1.05 U1 - Electrical Plan DA - 04 DA - 04 A2.01 U2 - Floor Plan A2.02 U2 - Elevations DA - 04 A2.03 U2 - Elevations DA - 04 A3.01 U3 - Floor Plan DA - 04 U3 - Elevations DA - 04 A3.02 U3 - Elevations DA - 04 A3.03 A3.04 U3 - Roof Plan DA - 04 A3.05 U3 - Electrical Plan DA - 04 DA - 04 C.01 Parking


GLENORCHY CITY COUNCIL PLANNING SERVICES

APPLICATION No ... PLN-24-272


DATE RECEIVED .

22/07/25


Document Set ID: 3513815 Version: 2, Version Date: 22/07/2025

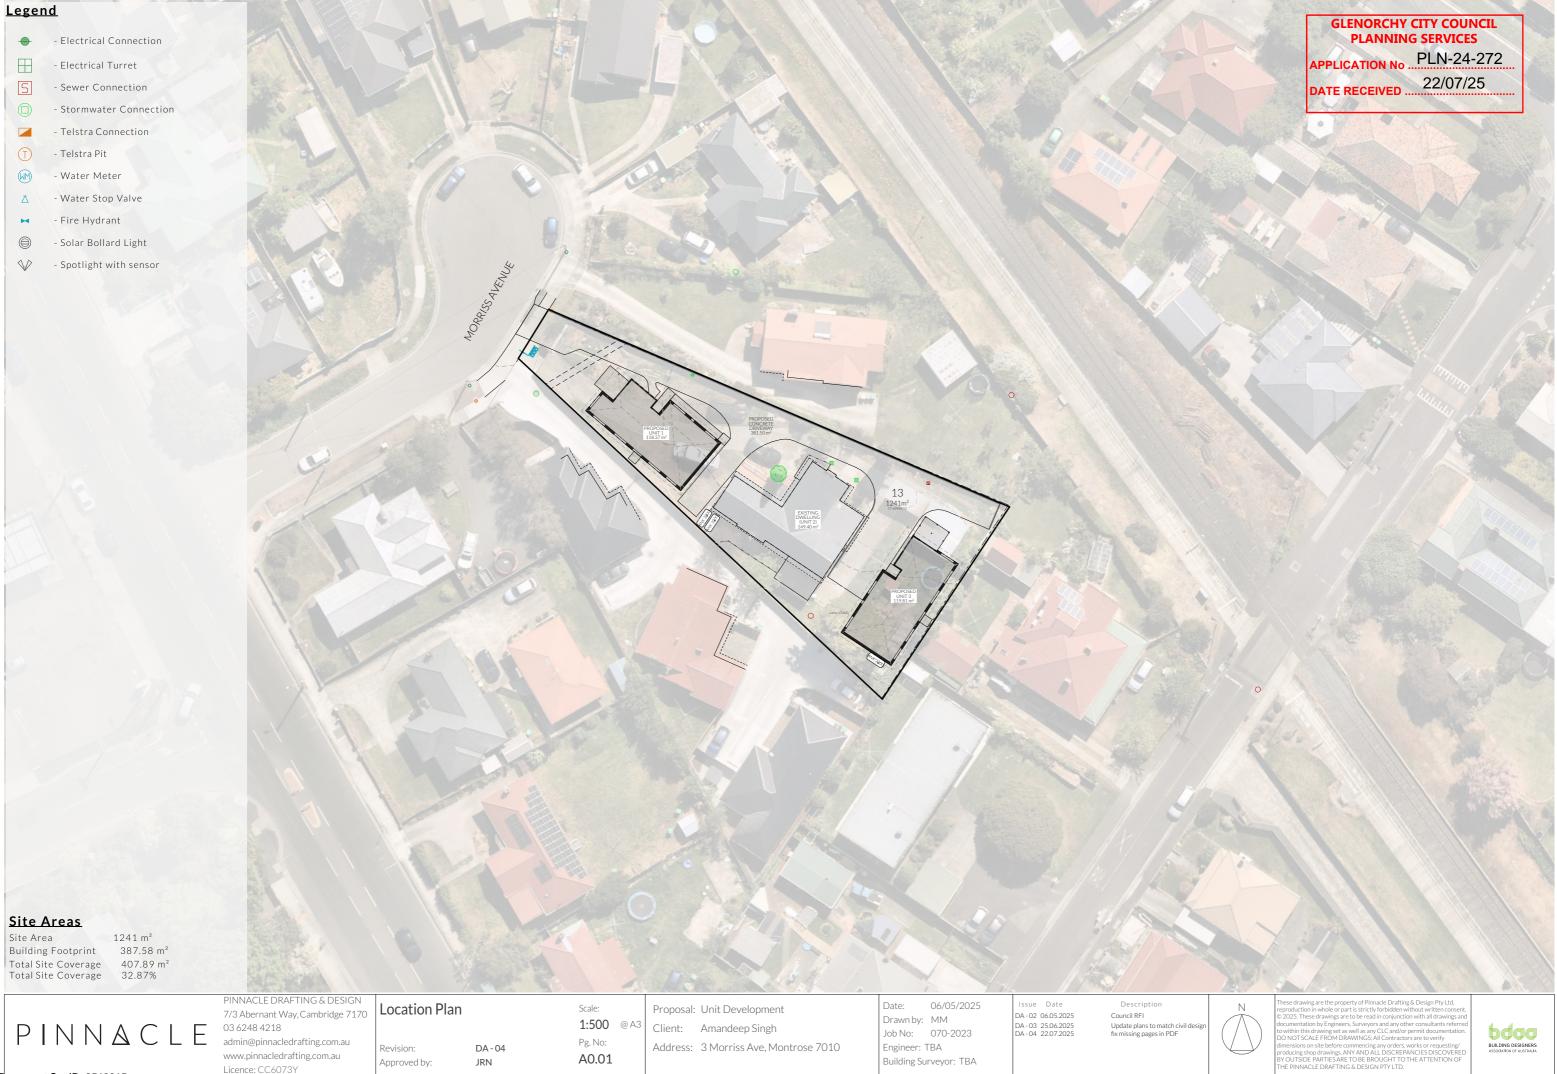

Document Set ID: 3513815 Version: 2, Version Date: 22/07/2025

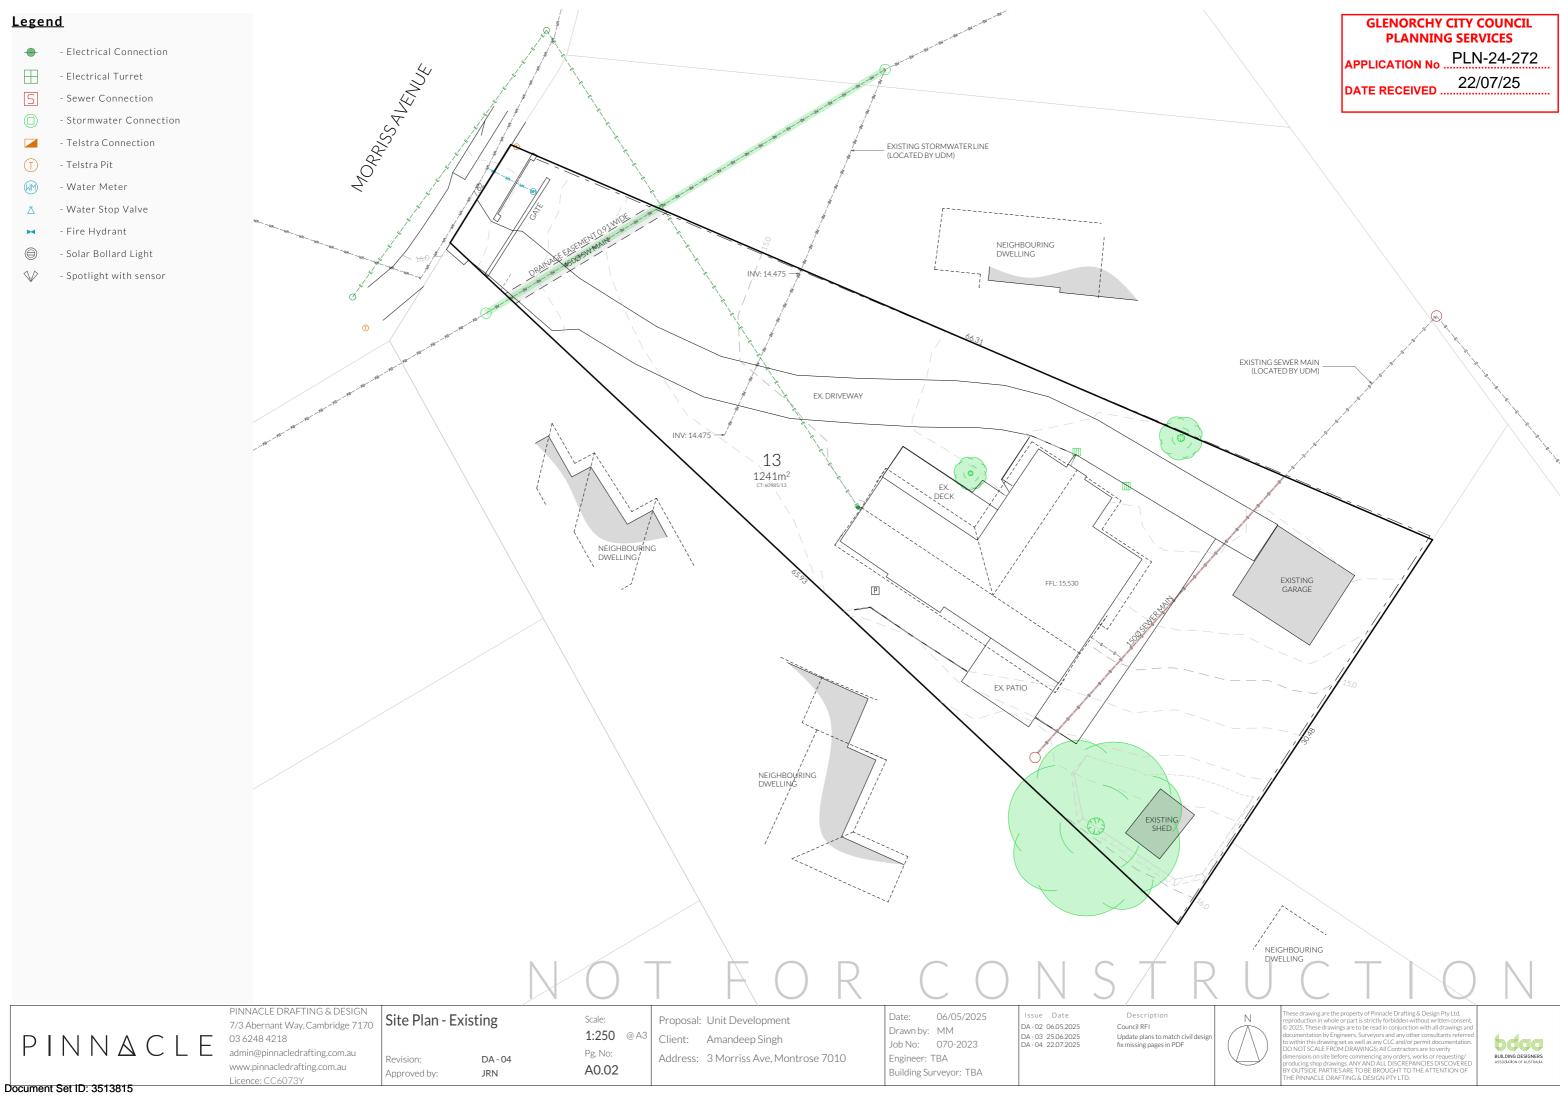

Document Set ID: 3513815 Version: 2, Version Date: 22/07/2025

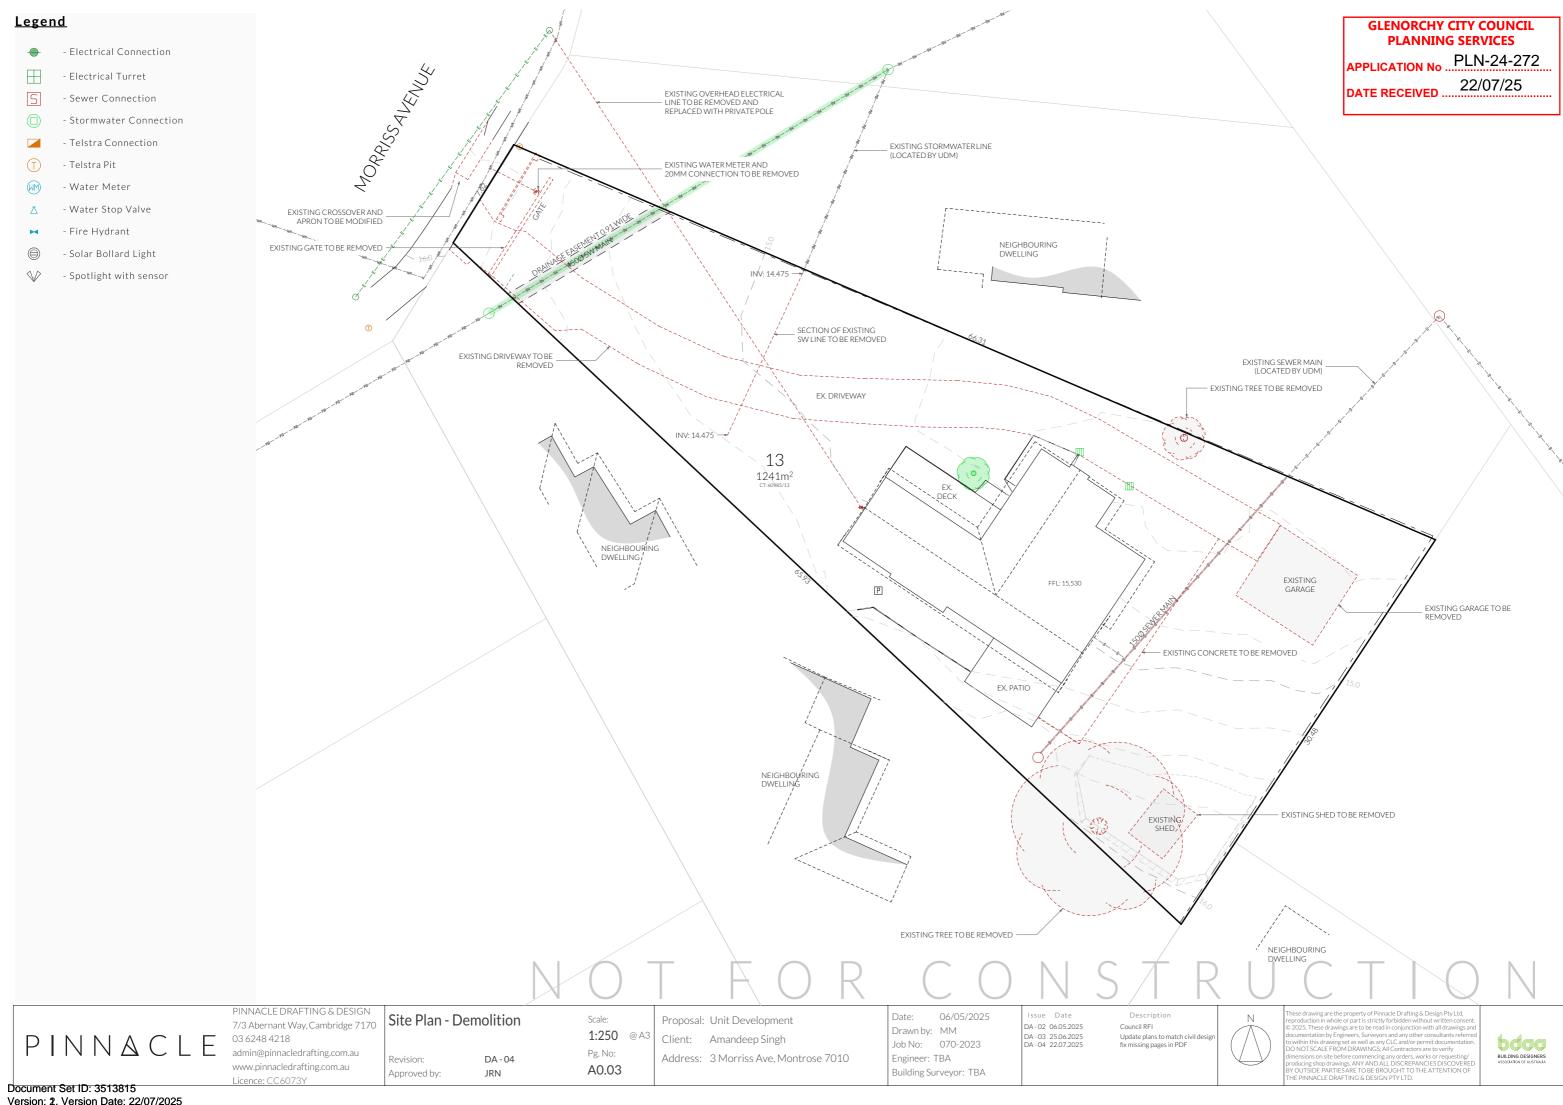

GLENORCHY CITY COUNCIL <u>Legend</u> **PLANNING SERVICES** - Electrical Connection PLN-24-272 MORRISSALEMLE APPLICATION No 22/07/25 Electrical Turret DATE RECEIVED - Sewer Connection WIDEN APRON AND - Stormwater Connection - CROSSOVER TO LGAT STANDARD DRAWINGS TSD-R09 - Telstra Connection EXISTING STORMWATERLINE (LOCATED BY UDM) - Telstra Pit Water Meter CORRECT FENCE ALIGNMENT Water Stop Valve IN THIS AREA - Fire Hydrant NEIGHBOURING - Solar Bollard Light DWELLING - Spotlight with sensor OMPLIANT P.O.S 24.00 m² 10 MAX GRADIENT Surface Water Drainage Ground to fall away from building in all directions in compliance with AS2870 & N.C.C 2022 3.3.3. 13 1241m² Surface water must be diverted away from a Class EXISTING SEWER MAIN 1 building as follows: (LOCATED BY UDM) (a)Slab-on-ground - finished ground level adjacent to a building: the external finished surface surrounding the slab must be drained to move surface water away from the building and graded to give a slope of not less than COMPLIANT P.O.S 24.60 m² 1:10 MAX GRADIENT (i)25mm over the first 1m from the building (A)in low rainfall intensity areas for surfaces that are reasonably impermeable (such as concrete or claypaving); or (B) for any reasonably impermeable surface that forms part of an access path or ramp provided for the purposes of Clauses 1.1 (2) or (4)(c) of the ABCB Standard for Livable Housing Design; or (ii) 50 mm over the first 1 m from the building in any other case. **DWELLING** (b)Slab-on-ground - finished slab heights: the height of the slab-on-ground above external finished surfaces mustbe not less than Р COMPLIANT P.O.S 24.00 m² 1:10 MAX GRADIEN (i) 100 mm above the finished ground level in low rainfall intensity areas or sandy, welldrained areas: or (ii)50 mm above impermeable (paved or concrete) areas that slope away from the building in accordance with(a); or (iii) 150 mm in any other case. (c)The ground beneath suspended floors must be EX. PATIO graded so that the area beneath the building is above the adjacent external finished ground level and surface water is prevented from ponding under the building. Subsoil Drainage is to comply with AS2870, AS3500 & N.C.C 2022 NEIGHBOURING DWELLING Where a subsoil drainage system is installed to divert subsurface water away from the area beneath a building, the subsoil drain must-(a) be graded with a uniform fall of not less than 1:300: and (b) discharge into an external silt pit or sump with-BATTER TO COMPLY (i)the level of discharge from the silt pit or WITH NCC 2022 3.2.1 & TABLE 3.2.1 sump into an impervious drainage line not less than 50 mm below the invert level of the inlet; and provision for cleaning and maintenance. FALL GROUND AWAYFROM HOUSE A MINIMUM OF 50mm OVER FIRST 1000mm IN ACCORDANCE WITH AS2870, NCC 2022 PART 3.3.3 & FIGURE 3.3.3a <u>Note</u> All driveway pits and grate drains to be Class B. DWFILING Stormwater pits are indicative. Location may vary depending on site conditions. PINNACLE DRAFTING & DESIGN Date: Site Plan - Proposed Scale: Proposal: Unit Development 7/3 Abernant Way, Cambridge 7170 A - 02 06 05 2025 Council RFI

PINNACLE

7/3 Abernant Way, Cambridge 7170 03 6248 4218 admin@pinnacledrafting.com.au

www.pinnacledrafting.com.au

Licence: CC6073Y

Revision: DA

Approved by:

DA - 04

1:250 @ A3
Pg. No:

A0.04

Client: Amandeep Singh

Address: 3 Morriss Ave, Montrose 7010

Drawn by: MM
Job No: 070-2023
Engineer: TBA

Building Surveyor: TBA

DA-02 06.05.2025 DA-03 25.06.2025 DA-04 22.07.2025 Council RFI
Update plans to match civil design fix missing pages in PDF



hese drawing are the property of Pinnacle Drafting & Design Pty Ltd, sproduction in whole or part is strictly forbidden without written cons 2025. These drawings are to be read in conjunction with all drawings ocumentation by Engineers, Surveyors and any other consultants refer within this drawing set as well as any CLC and/or permit documentati O NOT SCALE FROM DRAWINGS; All Contractors are to verify mensions on site before commencing any orders, works or requesting oducing shop drawings. ANY AND ALL DISCREPANCIES DISCOVER! Y OUTSIDE PARTIES ARE TOB EROUGHT TO THE ATTENTION O 4E PINNACLE DRAFTING & DESIGN PTY LTD.



GLENORCHY CITY COUNCIL PLANNING SERVICES APPLICATION No ...PLN-24-272 22/07/25 DATE RECEIVED .



Site Elevation - North East Elevation

1:150

Clearances between cladding and ground shall comply with Clause 7.5.7 of the NCC 2022 and shall be a minimum clearance of:

100mm in low rainfall intensity areas or sandy, well-drained areas; or 50mm above impermeable areas that slope away from the building; or 150mm in any other case.

Wall cladding must extend a minimum of 50 mm below the bearer or lowest horizontal part of the suspended floor framing.

U.N.O in builders specifications or located in saline environments or if using a glazed finish brick, brickwork is to be installed in stretcher bond pattern with raked joints.

Openable windows greater than 4m above ground level are to be fitted with a device to limit the opening or a suitable screen so a 125mm sphere cannot pass through, and withstand a force of 250N. Except for bedrooms, where the requirement is for heights above 2m.

All stairs to be constructed in accordance with NCC 2022 Vol II Part 11.2.2

Riser: Min 115mm - Max 190mm Going: Min 240mm - Max 355mm PINNACLE DRAFTING & DESIGN

7/3 Abernant Way, Cambridge 7170

03 6248 4218 admin@pinnacledrafting.com.au www.pinnacledrafting.com.au Licence: CC6073Y

Site Elevations

Revision:

Pg. No: DA - 04 A0.05 Approved by:

Scale:

Slope (2R+G): Max 550 - Min 700

Proposal: Unit Development 1:150 @ A3

Client: Amandeep Singh Address: 3 Morriss Ave, Montrose 7010

Date: Drawn by: MM Job No: 070-2023 Engineer: TBA

Building Surveyor: TBA

DA - 02 06.05.2025 DA-03 25.06.2025 DA-04 22.07.2025 Council RFI Update plans to match civil desi fix missing pages in PDF



PINNACLE



Articulation Joint

Smoke Alarm

Construction of sanitary

compartments 10.4.2 of NCC 2022

The door to a fully enclosed sanitary compartment must -

- open outwards; or
- slide: or
- be readily removable from the outside of the compartment.

unless there is a clear space of at least 1.2 m, measured in accordance with Figure 10.4.2 of NCC 2022 Vol II, between the closet pan within the sanitary compartment and the doorway.

Note: Safe Movement & Egress

Openable windows greater than 4m above the surface below are to be fitted with a device to limit opening or a suitable screen so a 125mm sphere cannot pass through. Except for Bedrooms, where the requirement is for heights above 2m. Refer to clauses 11.3.7 and 11.3.8 of NCC 2022 for further information on suitable protective devices.

Note: Paved Areas

All paths and patios to fall away from dwelling.

Note: Stair Construction

All stairs to be constructed in accordance with NCC Vol II 2022 Part 11.2.2:

Riser: Min 115mm - Max 190mm Going: Min 240mm - Max 355mm

infrequently, refer to table 11.2.2(b).

Slope (2R+G): Max 550 - Min 700 For stairways serving non-habitable room used

Landings to comply with Clause 11.2.5 and be a minimum of 750mm deep measured 500mm from the inside edge of the landing.

Slip resistance of treads, nosings and ramps to comply with Clause 11.2.4.

Heights of rooms & other spaces 10.3.1 of NCC 2022

Heights of rooms and other spaces must not be less

(a)in a habitable room excluding a kitchen - 2.4 m; and (b)in a kitchen - 2.1 m; and

(c)in a corridor, passageway or the like - 2.1 m; and (d)in a bathroom, shower room, laundry, sanitary compartment, airlock, pantry, storeroom, garage, car parking area or the like - 2.1 m; and


(e)in a room or space with a sloping ceiling or projections below the ceiling line within- See NCC directly for these items

(f)in a stairway, ramp, landing, or the like - 2.0 m measured vertically above the nosing line of stairway treads or the floor surface of a ramp, landing or the like.

If required onsite, the builder may work within the tolerances of the above as specified within the NCC 2022 Vol II. Builder to contact Pinnacle before undertaking works.

Floor Areas

118.37m² Total Floor Area Patio $10.66 \, m^2$ Porch $4.25m^{2}$ Landing: 1.44m² Landing 2 1.44m^2 $8.59 \, \text{m}^2$

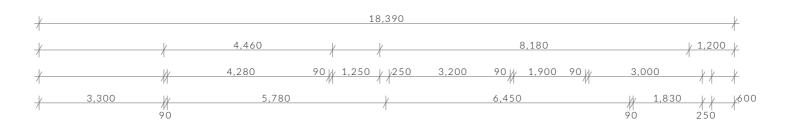



Important Note

Unit to be wheelchair accessible. Unit to comply with NDIS SDA Improved liveability



GLENORCHY CITY COUNCIL PLANNING SERVICES PLN-24-272 **APPLICATION No**

22/07/25 **DATE RECEIVED**

PINNACLE DRAFTING & DESIGN 7/3 Abernant Way, Cambridge 7170 PINNACLE 03 6248 4218

admin@pinnacledrafting.com.au www.pinnacledrafting.com.au Licence: CC6073Y

006

1,100 600%

006

4,190

3,400

500

80%

5,590

1,200

2007

U1 - Floor Plan

Revision:

Approved by:

DA - 04

Scale: 1:100 @ A3 Pg. No: A1.01

Proposal: Unit Development Client: Amandeep Singh

Address: 3 Morriss Ave, Montrose 7010

Date: Drawn by: MM Job No: 070-2023 Engineer: TBA

Building Surveyor: TBA


DA - 02 06 05 2025 DA - 03 25.06.2025 DA - 04 22.07.2025 Council RFI Update plans to match civil des fix missing pages in PDF




1,290

mensions on site before commencing any orders, works or requesting oducing shop drawings. ANY AND ALL DISCREPANCIES DISCOVER (*OUTSIDE PARTIESARE TO BE BROUGHT TO THE ATTENTION O IE PINNACLE DRAFTING & DESIGN PTY LTD.



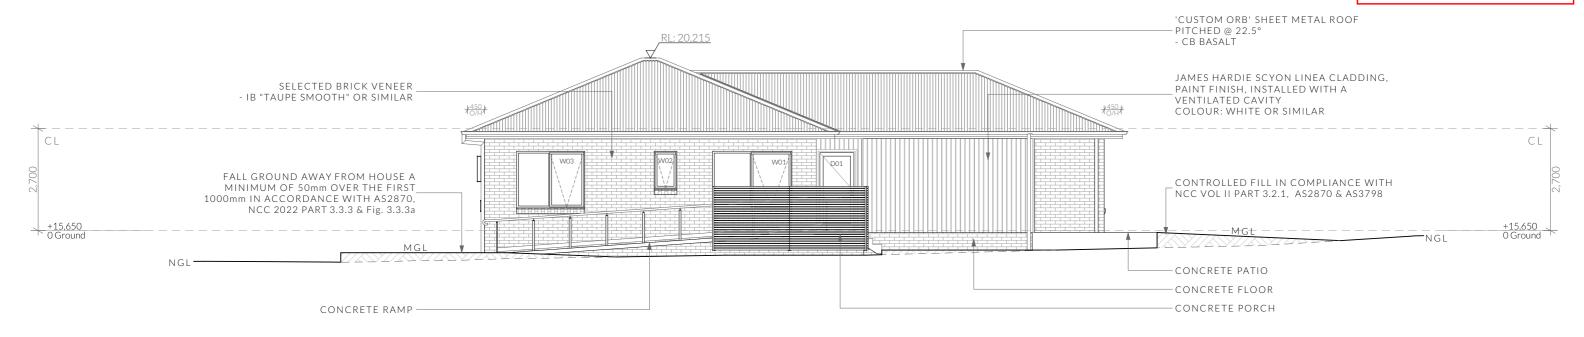

U1 - North East Elevation

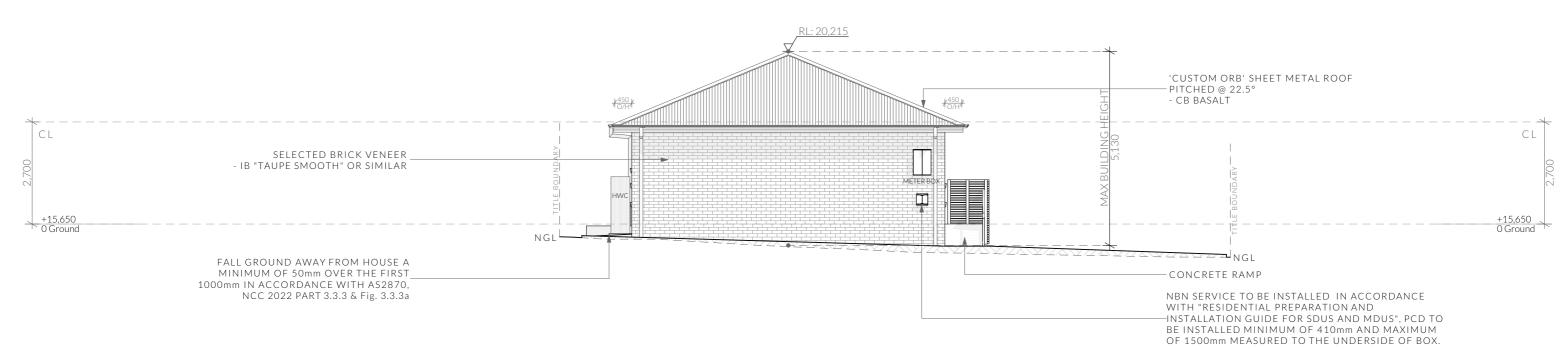

U1 - South East Elevation Clearances between cladding and ground shall comply with Clause 7.5.7 of the NCC 2022 and shall be a minimum clearance of:

100mm in low rainfall intensity areas or sandy, well-drained areas; or 50mm above impermeable areas that slope away from the building; or 150mm in any other case.

Wall cladding must extend a minimum of 50 mm below the bearer or lowest horizontal part of the suspended floor framing.

U.N.O in builders specifications or located in saline environments or if using a glazed finish brick, brickwork is to be installed in stretcher bond pattern with raked joints.

Openable windows greater than 4m above ground level are to be fitted with a device to limit the opening or a suitable screen so a 125mm sphere cannot pass through, and withstand a force of 250N. Except for bedrooms, where the requirement is for heights above 2m.

All stairs to be constructed in accordance with NCC 2022 Vol II Part 11.2.2 Riser: Min 115mm - Max 190mm Going: Min 240mm - Max 355mm Slope (2R+G): Max 550 - Min 700 PINNACLE DRAFTING & DESIGN Date: U1 - Elevations Scale: Proposal: Unit Development

PINNACLE

7/3 Abernant Way, Cambridge 7170 03 6248 4218 admin@pinnacledrafting.com.au www.pinnacledrafting.com.au

Licence: CC6073Y

DA - 04 Revision: Approved by:

1:100 @ A3 Pg. No: A1.02

Client: Amandeep Singh Address: 3 Morriss Ave, Montrose 7010 Drawn by: MM Job No: 070-2023 Engineer: TBA

Building Surveyor: TBA

DA - 02 06 05 2025 DA - 03 25.06.2025 DA - 04 22.07.2025 Council RFI Update plans to match civil des fix missing pages in PDF

nensions on site before commencing any orders, works or requesting; oducing shop drawings. ANY AND ALL DISCREPANCIES DISCOVER! "OUTSIDE PARTIES ARE TO BE BROUGHT TO THE ATTENTION O HE PINNACLE DRAFTING & DESIGN PTY LTD.




1:100

1:100

GLENORCHY CITY COUNCIL PLANNING SERVICES APPLICATION No ...PLN-24-272 22/07/25 DATE RECEIVED



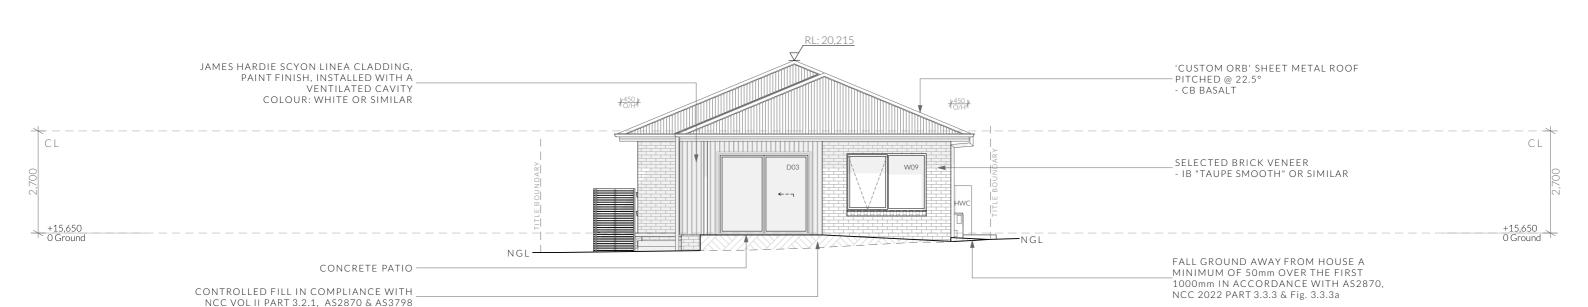

U1 - South West Elevation

U1 - North West Elevation Clearances between cladding and ground shall comply with Clause 7.5.7 of the NCC 2022 and shall be a minimum clearance of: 100mm in low rainfall intensity areas or sandy, well-drained areas; or 50mm above impermeable areas that slope away from the building; or 150mm in any other case.

1:100

1:100

Wall cladding must extend a minimum of 50 mm below the bearer or lowest horizontal part of the suspended floor framing.

Licence: CC6073Y

U.N.O in builders specifications or located in saline environments or if using a glazed finish brick, brickwork is to be installed in stretcher bond pattern with raked joints.

Riser: Min 115mm - Max 190mm

Openable windows greater than 4m above ground level are to be fitted with a device to limit the opening or a suitable screen so a 125mm sphere cannot pass through, and withstand a force of 250N. Except for bedrooms, where the requirement is for heights above 2m.

All stairs to be constructed in accordance with NCC 2022 Vol II Part 11.2.2

PINNACLE DRAFTING & DESIGN 7/3 Abernant Way, Cambridge 7170 PINNACLE 03 6248 4218 admin@pinnacledrafting.com.au

Going: Min 240mm - Max 355mm U1 - Elevations

Revision: www.pinnacledrafting.com.au

Approved by:

DA - 04 JRN

Slope (2R+G): Max 550 - Min 700

Scale: 1:100 @ A3 Pg. No: A1.03

Proposal: Unit Development Client: Amandeep Singh Address: 3 Morriss Ave, Montrose 7010

Date: Drawn by: MM Job No: 070-2023 Engineer: TBA

Building Surveyor: TBA

DA - 02 06 05 2025 DA - 03 25.06.2025 DA - 04 22.07.2025 Council RFI Update plans to match civil desi fix missing pages in PDF

mensions on site before commencing any orders, works or requesting/ oducing shop drawings. ANY AND ALL DISCREPANCIES DISCOVERE Y OUTSIDE PARTIES ARE TO DE BROUGHT TO THE ATTENTION OF HE PINNACLE DRAFTING & DESIGN PTY LTD.



Ventilation of roof spaces NCC 2022 Part 10.8.3

A roof must have a roof space that-

(a)is located-(i)immediately above the primary insulation layer;

(ii)immediately above sarking with a vapour permeance of not less than 1.14 µg/N.s, which is immediately above the primary insulation layer;

(iii)immediately above ceiling insulation; and (b) has a height of not less than 20 mm; and (c)is either-

(i)ventilated to outdoor air through evenly distributed openings in accordance with Table

(ii)located immediately underneath the roof tiles of an unsarked tiled roof.

Stormwater Notes

All gutters, downpipes and rain heads to be designed and installed in compliance with AS3500.3 & NCC 2022 Volume II Part 7.4.

Roofing Cladding

Roof cladding, flashings, cappings, roof sheeting and fixings are to be installed in accordance with NCC 2022 Volume II Part 7.2 for sheet roofing and Part 7.3 for tiled and shingle roofing.

Eaves & Soffit Linings

To comply with NCC 2022 Vol II Part 7.5.5 and where provided, external fibre-cement sheets and linings used as eaves and soffit linings must-


(a)comply with AS/NZS 2908.2 or ISO 8336; and (b) be fixed in accordance with Table 7.5.5 and Figure 7.5.5 using-

(i) 2.8×30 mm fibre-cement nails; or

(ii) No. 8 wafer head screws (for 4.5 mm and 6 mm sheets only); or

(iii) No. 8 self embedding head screws (for 6 mm

Refer to table 7.5.5 for trimmer and fastener spacings.

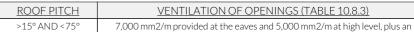

additional 18,000 mm2/m at the eaves if the roof has a cathedral ceiling (1) Ventilation openings are specified as a minimum free open area per metre length of the

longest horizontal dimension of the roof.

(2) For the purposes of this Table, high level openings are openings provided at the ridge or not more than 900 mm below the ridge or highest point of the roof space, measured vertically.

GLENORCHY CITY COUNCIL PLANNING SERVICES

PLN-24-272 APPLICATION No. 22/07/25 DATE RECEIVED.





PINNACLE DRAFTING & DESIGN 7/3 Abernant Way, Cambridge 7170 03 6248 4218 admin@pinnacledrafting.com.au

www.pinnacledrafting.com.au

Licence: CC6073Y

U1 - Roof Plan

Revision:

Approved by:

DA - 04

Scale: 1:100 @ A3 Pg. No: A1.04

Proposal: Unit Development Client: Amandeep Singh

Address: 3 Morriss Ave, Montrose 7010

Date: Drawn by: MM Job No: 070-2023 Engineer: TBA

Building Surveyor: TBA

DA - 02 06.05.2025 DA - 03 25.06.2025 DA - 04 22.07.2025 Council RFI Update plans to match civil des fix missing pages in PDF




mensions on site before commencing any orders, works or requesting, oducing shop drawings. ANY AND ALL DISCREPANCIES DISCOVER! Y OUTSIDE PARTIESARE TO BE BROUGHT TO THE ATTENTION O HE PINNACLE DRAFTING & DESIGN PTY LTD.



ELECTRICAL LEGEND - UNIT 1 - Lower Floor

Symbol	Description	Allowance	Quantity
300H ∇ □	DATA- CAT 6 (RJ45) - 1 GANG		3
300H Ļ ™	DATA-TV CONNECTION		2
	FAN - 3 IN 1 (4 LAMP)	10W (LIGHT)	2
0	FAN - CEILING - EXHAUST		2
300H	GPO - (1) SINGLE		4
300H 2	GPO - (2) DOUBLE		20
2 ISO 200	GPO - (2) DOUBLE (WITH COOKTOP ISOLATOR SWITCH)		1
300H W/PROOF	GPO - WEATHER PROOF DOUBLE		1
$\otimes_{_{R}}$	LIGHT - CEILING - DOWNLIGHT RECESSED	10W	23
\bigotimes_{P1}	LIGHT - CEILING - PENDANT - TYPE 1	10W	3
(SA)	SERVICE - SMOKE ALARM		4
Ь	SWITCH - LIGHT 1 GANG		8
2₫	SWITCH - LIGHT 2 GANG		2
6 - H	SWITCH - LIGHT 6 GANG		1

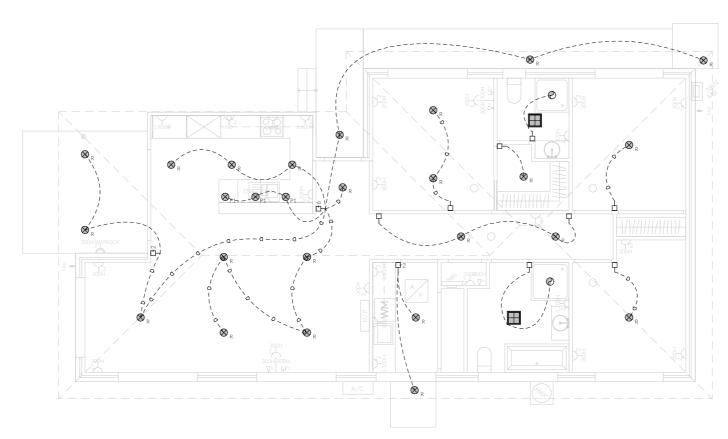

Electrical Plan - Lower - Light/Reflected Ceiling - U1

300H 200H A/C

Electrical Plan - Lower - Power - U1

Smoke Alarms Part 9.5 of NCC 2022

Smoke alarms must-

(a)be located in-(i)a Class 1a building in accordance with 9.5.2 and 9.5.4; and (ii) a Class 1b building in accordance with 9.5.3 and 9.5.4;

(b)comply with AS 3786, except that in a Class 10a private garage where the use of the area is likely to result in smoke alarms causing spurious signals, any other alarm deemed suitable in accordance with AS 1670.1 may be installed provided that smoke alarms complying with AS 3786 are installed elsewhere in the Class 1 building; and

(c)be powered from the consumer mains source where a consumer mains source is supplied to the building; and be interconnected where there is more than one alarm.

In a Class 1a building, smoke alarms must be located in-(a) any storey containing bedrooms, every corridor or hallway associated with a bedroom, or if there is no corridor or hallway, in an area between the bedrooms and the remainder of the building; and

(b) each other storey not containing bedrooms.

Smoke alarms required by 9.5.2 and 9.5.3 must be installed on or near the ceiling, in accordance with the following:

(a) Where a smoke alarm is located on the ceiling it must be-(i)a minimum of 300 mm away from the corner junction of the wall and ceiling; and

(ii) between 500 mm and 1500 mm away from the high point and apexes of the ceiling, if the room has a sloping ceiling.

(b) Where (a) is not possible, the smoke alarm may be installed on the wall, and located a minimum of 300 mm and a maximum of 500 mm off the ceiling at the junction with the

PINNACLE DRAFTING & DESIGN PINNACLE 03 6248 4218 admin@pinnacledrafting.com.au

7/3 Abernant Way, Cambridge 7170

Licence: CC6073Y

U1 - Electrical Plan www.pinnacledrafting.com.au

DA - 04 Approved by:

Revision:

Pg. No: A1.05

Scale:

Proposal: Unit Development Client: Amandeep Singh

Address: 3 Morriss Ave, Montrose 7010

Date: 06/05/2025 Drawn by: MM Job No: 070-2023 Engineer: TBA

Building Surveyor: TBA

A - 02 06 05 2025 DA - 03 25.06.2025 DA - 04 22.07.2025

Council RFI Update plans to match civil des fix missing pages in PDF

nierisin's drisite betiere confinencing any orders, work so i requesting oducing shop drawings. ANY AND ALL DISCREPANCIES DISCOVEI OUTSIDE PARTIES ARE TO BE BROUGHT TO THE ATTENTION O HE PINNACLE DRAFTING & DESIGN PTY LTD.



Notes

Note: Exhaust Fans

(b)40 L/s for a kitchen or laundry.

directly or via a shaft or duct to outdoor air.

via a shaft or duct to outdoor air.

accordance with 10.6.2(a) must-

switch is turned off.

5W/m² in class 1a dwellings

 $4W/m^2$ to veranda, balcony or the like

Note: Lighting

Exhaust fans to comply with NCC 2022 Vol 2 Part 10.8.2 and

-An exhaust system installed in a kitchen, bathroom, sanitary compartment or laundry must have a minimum flow rate of-(a) 25 L/s for a bathroom or sanitary compartment; and

-Where a venting clothes dryer is installed, it must discharge

-An exhaust system that is not run continuously and is serving a bathroom or sanitary compartment that is not ventilated in

(a) be interlocked with the room's light switch; and (b)include a run-on timer so that the exhaust system continues to operate for 10 minutes after the light

Lighting layout may change, owner to confirm with builder prior to purchase/installation of exact quantity and location of electrical services provided that installation is compliant with AS3000 and artificial lighting allowances do not exceed:

3W/m² in a class 10a dwelling associated with the class 1a

U.N.O - All downlights are to be Insulation Contact (IC) rated. Preparation for future Solar Installation:

> **GLENORCHY CITY COUNCIL PLANNING SERVICES**

> > PLN-24-272

22/07/25

Should the solar design be required for future installation, 2/25mm solarflex (or similar) conduits marked "solar" are to be installed from the meter box to the roof space - See electrical

APPLICATION No

DATE RECEIVED

-Exhaust from a kitchen, kitchen range hood, bathroom, sanitary compartment or laundry must discharge directly or

U.N.O ceilings are to be plasterboard.

--□---- Dimmable Circuit

-- T---- Timer Circuit(as fan note)

РΒ - Plasterboard

CS - Cement Sheet Eaves


Plywood Ceiling

Timber Batten Ceiling

Important Note

Existing plans have been derived from survey data and real estate information

GLENORCHY CITY COUNCIL PLANNING SERVICES APPLICATION NoPLN-24-272

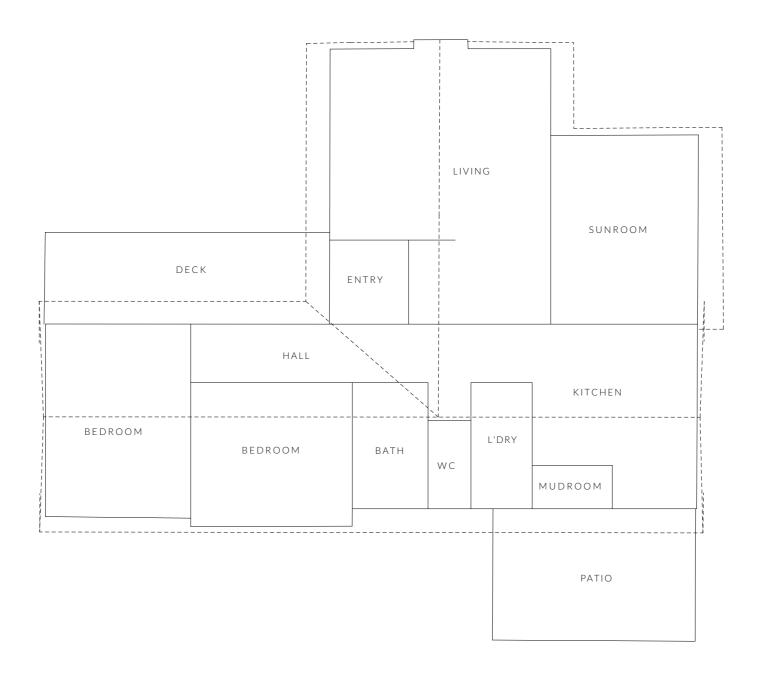

NOT FOR CONSTRUCTION

PINNACLE

PINNACLE DRAFTING & DESIGN 7/3 Abernant Way, Cambridge 7170 03 6248 4218 admin@pinnacledrafting.com.au

www.pinnacledrafting.com.au

Licence: CC6073Y

U2 - Floor Plan

Revision:

Approved by:

DA - 04

Scale: 1:100 @ A3 Pg. No: A2.01

Proposal: Unit Development

Client: Amandeep Singh

Address: 3 Morriss Ave, Montrose 7010

 Date:
 06/05/2025

 Drawn by:
 MM

 Job No:
 070-2023

 Engineer:
 TBA

Building Surveyor: TBA

DA-02 06.05.2025 DA-03 25.06.2025 DA-04 22.07.2025 Description
Council RFI
Update plans to match civil design fix missing pages in PDF



I hese drawing are the property of Prinnacie Dratting & Design Pty Ltd., reproduction in whole or part is strictly forbidden without written conso © 2025. These drawings are to be read in conjunction with all drawings documentation by Engineers, Surveyors and any other consultants refet to within this drawing set as well as any CLC and/or permit documental DO NOT SCALE FROM DRAWINGS: All CONTRACTOR STORY dimensions on site before commencing any orders, works or requesting producing shop drawings. ANY AND ALL DISCREPANCIES DISCOVER BY OUTSIDE PARTIES ARE TO BE BROUGHT TO THE ATTENTION O




Important Note

Existing plans have been derived from survey data and real estate information



1:100

1:100

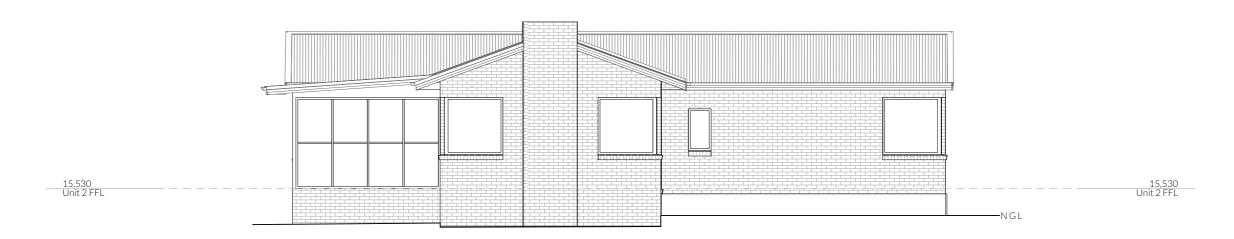

U2 -North East Elevation



U2 - South East Elevation

PINNACLE

PINNACLE DRAFTING & DESIGN 7/3 Abernant Way, Cambridge 7170 03 6248 4218 admin@pinnacledrafting.com.au www.pinnacledrafting.com.au

Licence: CC6073Y

U2 - Elevations

Revision:

Approved by:

DA - 04

Scale: 1:100 @ A3 Pg. No: A2.02

Proposal: Unit Development Client: Amandeep Singh

Drawn by: MM Job No: 070-2023 Address: 3 Morriss Ave, Montrose 7010 Engineer: TBA Building Surveyor: TBA

Date:

06/05/2025

DA - 02 06.05.2025 DA - 02 00.03.2025 DA - 03 25.06.2025 DA - 04 22.07.2025

Council RFI


Update plans to match civil design fix missing pages in PDF

bdoo BUILDING DESIGNERS ASSOCIATION OF AUSTRALIA

Important Note

Existing plans have been derived from survey data and real estate information



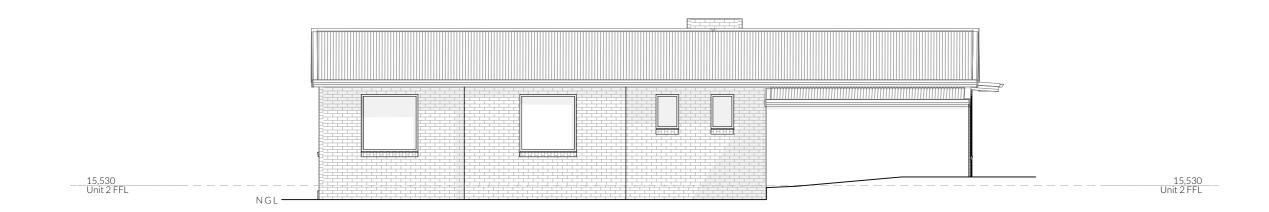

U2 -South West Elevation



U2 - North West Elevation

NOT FOR CONSTRUCTION

PINNACLE

PINNACLE DRAFTING & DESIGN 7/3 Abernant Way, Cambridge 7170 03 6248 4218 admin@pinnacledrafting.com.au www.pinnacledrafting.com.au

Licence: CC6073Y

U2 - Elevations

Revision:

Approved by:

1:100
DA-04
Pg. No:
A2.03

Scale: Propos
1:100 @ A3 Client:

Proposal: Unit Development

Client: Amandeep Singh

Address: 3 Morriss Ave, Montrose 7010

Drawn by: MM
Job No: 070-2023
Engineer: TBA
Building Surveyor: TBA

Date:

DA-02 06.05.2025 DA-03 25.06.2025 DA-04 22.07.2025 Council RFI
Update plans to match civil design fix missing pages in PDF

I hese drawing are the property of Prinnaice Dratting & Design Pty Lice
reproduction in whole or part is strictly forbidden without written cor

© 2025. These drawings are to be read in conjunction with all drawing
documentation by Engineers, Surveyors and any other consultants re
to within this drawing set as well as any CLC and/or permit document.
D O NOT SCALE FROM DRAWINGS: All Contractors are to verify
dimensions on site before commencing any orders, works or requesti
producing shop drawings. ANY AND ALL DISCREPANCIES DISCOSE
BY OUTSIDE PARTIES ARE TO BE BROUGHT TO THE ATTENTION



1:100

1:100



Articulation Joint



Construction of sanitary

compartments 10.4.2 of NCC 2022

The door to a fully enclosed sanitary compartment must -

- open outwards; or
- slide: or
- be readily removable from the outside of the compartment.

unless there is a clear space of at least 1.2 m, measured in accordance with Figure 10.4.2 of NCC 2022 Vol II, between the closet pan within the sanitary compartment and the doorway.

Note: Safe Movement & Egress

Openable windows greater than 4m above the surface below are to be fitted with a device to limit opening or a suitable screen so a 125mm sphere cannot pass through. Except for Bedrooms, where the requirement is for heights above 2m. Refer to clauses 11.3.7 and 11.3.8 of NCC 2022 for further information on suitable protective devices.

Note: Paved Areas

All paths and patios to fall away from dwelling.

Note: Stair Construction

All stairs to be constructed in accordance with NCC Vol II 2022 Part 11.2.2:

Riser: Min 115mm - Max 190mm

Going: Min 240mm - Max 355mm

Slope (2R+G): Max 550 - Min 700 For stairways serving non-habitable room used

infrequently, refer to table 11.2.2(b).

Landings to comply with Clause 11.2.5 and be a minimum of 750mm deep measured 500mm from the inside edge of the landing.

Slip resistance of treads, nosings and ramps to comply with Clause 11.2.4.

Heights of rooms & other spaces

10.3.1 of NCC 2022

Heights of rooms and other spaces must not be less

(a)in a habitable room excluding a kitchen - 2.4 m; and (b)in a kitchen - 2.1 m; and

(c)in a corridor, passageway or the like - 2.1 m; and (d)in a bathroom, shower room, laundry, sanitary compartment, airlock, pantry, storeroom, garage, car parking area or the like - 2.1 m; and


(e)in a room or space with a sloping ceiling or projections below the ceiling line within- See NCC


directly for these items (f)in a stairway, ramp, landing, or the like - 2.0 m measured vertically above the nosing line of stairway treads or the floor surface of a ramp, landing or the like.

If required onsite, the builder may work within the tolerances of the above as specified within the NCC 2022 Vol II. Builder to contact Pinnacle before undertaking works.

Floor Areas

119.81m² Total Floor Area Patio $11.96\,m^2$ Porch $2.06m^{2}$ Landing: 1.44m² Landing 2 1.44m^2 3.20m²

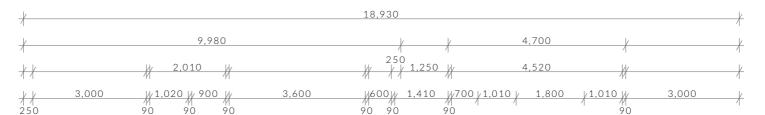

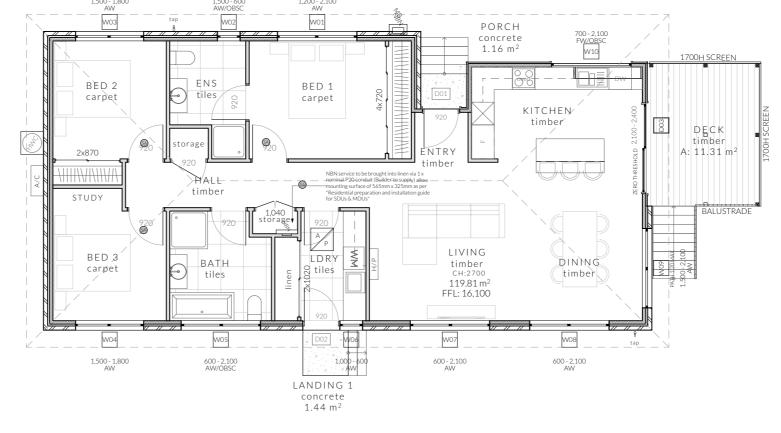



Important Note


Unit to be wheelchair accessible. Unit to comply with NDIS SDA Improved liveability



GLENORCHY CITY COUNCIL PLANNING SERVICES

PLN-24-272 **APPLICATION No.**

22/07/25 **DATE RECEIVED**

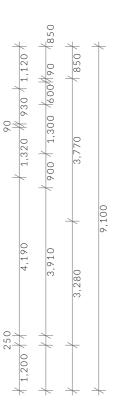

PINNACLE DRAFTING & DESIGN 7/3 Abernant Way, Cambridge 7170 PINNACLE 03 6248 4218

admin@pinnacledrafting.com.au

www.pinnacledrafting.com.au

Licence: CC6073Y

DA - 04

U3 - Floor Plan

Revision:

Approved by:

2,220

1,200

06 06

1,200 / / 250

100910091 06

Scale: 1:100 @ A3 Pg. No:

A3.01

Proposal: Unit Development Client: Amandeep Singh

Address: 3 Morriss Ave, Montrose 7010

Date: Drawn by: MM Job No: 070-2023 Engineer: TBA

Building Surveyor: TBA

DA - 02 06 05 2025 DA - 03 25.06.2025 DA - 04 22.07.2025 Council RFI Update plans to match civil des fix missing pages in PDF




mensions on site before commencing any orders, works or requesting, oducing shop drawings. ANY AND ALL DISCREPANCIES DISCOVER! OUTSIDE PARTIESARE TO DE BROUGHT TO THE ATTENTION O HE PINNACLE DRAFTING & DESIGN PTY LTD.



GLENORCHY CITY COUNCIL
PLANNING SERVICES

APPLICATION No PLN-24-272

DATE RECEIVED 22/07/25

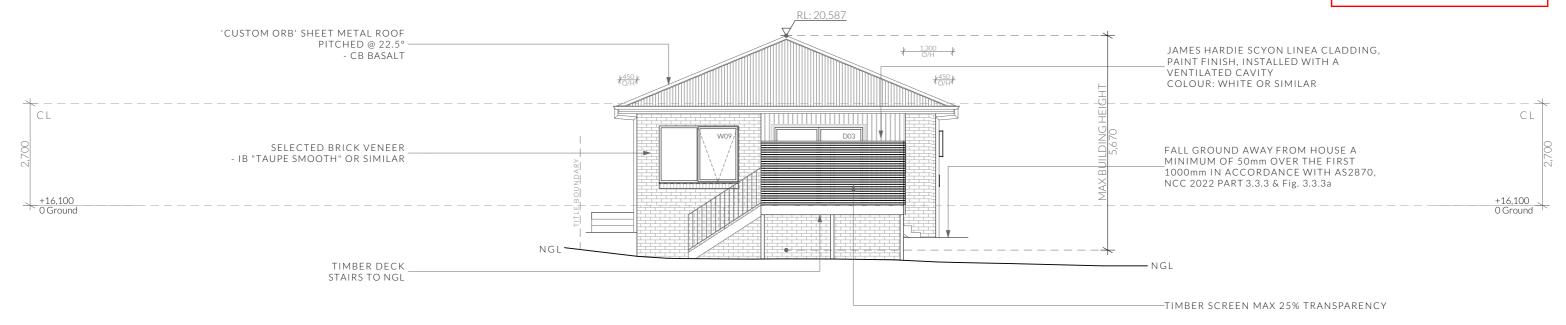



NOTE

U3 - South East Elevation

1:100

Clearances between cladding and ground shall comply with Clause 7.5.7 of the NCC 2022 and shall be a minimum clearance of:

100mm in low rainfall intensity areas or sandy, well-drained areas; or 50mm above impermeable areas that slope away from the building; or 150mm in any other case.

 $Wall \ cladding \ must \ extend \ a \ minimum \ of \ 50 \ mm \ below \ the \ bearer \ or \ lowest \ horizontal \ part \ of \ the \ suspended \ floor \ framing.$

U.N.O in builders specifications or located in saline environments or if using a glazed finish brick, brickwork is to be installed in stretcher bond pattern with raked joints.

As per NCC parts 11.3.7 and 11.3.8

Openable windows greater than 4m above ground level are to be fitted with a device to limit the opening or a suitable screen so a 125mm sphere cannot pass through, and withstand a force of 250N. Except for bedrooms, where the requirement is for heights above 2m.

Riser: Min 115mm - Max 190mm Going
PII
7/3
PINNACLE
ad
ad

All stairs to be constructed in accordance with NCC 2022 Vol II Part 11.2.2

Going: Min 240mm - Max 355mm
PINNACLE DRAFTING & DESIGN
7/3 Abernant Way, Cambridge 7170
03 6248 4218
admin@pinnacledrafting.com.au

www.pinnacledrafting.com.au

Licence: CC6073Y

U3 - Elevations

Revision:

Approved by:

Slope (2R+G): Max 550 - Min 700

DA - 04

JRN

Scale: 1:100 @ A3 Pg. No: A3.02 Proposal: Unit Development
Client: Amandeep Singh
Address: 3 Morriss Ave, Montrose 7010

Date: 06/05/2025

Drawn by: MM

Job No: 070-2023

Engineer: TBA


Building Surveyor: TBA


DA-02 06.05.2025 DA-03 25.06.2025 DA-04 22.07.2025 Description
Council RFI
Update plans to match civil desi
fix missing pages in PDF

These drawing are the property of Pinnacle Drafting & Design Pty Ltd. reproduction in whole or part is strictly forbidden without written conse © 2025. These drawings are to be read in conjunction with all drawings a documentation by Engineers, Surveyors and any other consultants refer to within this drawing set as well as any CLC and/or permit documentation DO NOTSCALE FROM DRAWINGS; All Contractors are to verify dimensions on site before commencing any orders, works or requesting, producing shop drawings. ANY AND ALL DISCREPANCIES DISCOVER BY OUTSIDE PARTIES ARE TO BE BROUGHT TO THE ATTENTION O THE PINNACLE DRAFTING & DESIGN PTYLTD.



GLENORCHY CITY COUNCIL PLANNING SERVICES PLN-24-272 **APPLICATION No.** 22/07/25 DATE RECEIVED

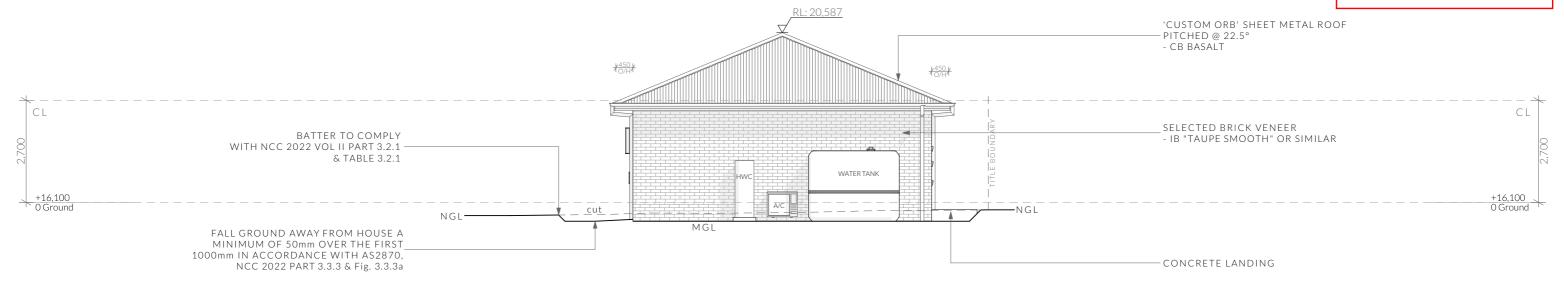

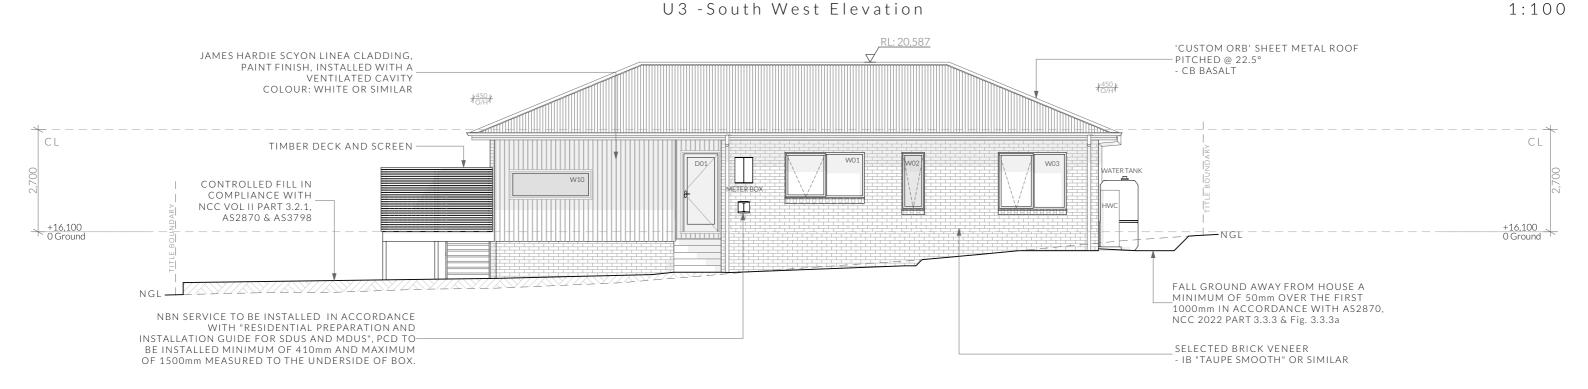

U3 - North West Elevation

Clearances between cladding and ground shall comply with Clause 7.5.7 of the NCC 2022 and shall be a minimum clearance of: 100mm in low rainfall intensity areas or sandy, well-drained areas; or 50mm above impermeable areas that slope away from the building; or 150mm in any other case.

Wall cladding must extend a minimum of 50 mm below the bearer or lowest horizontal part of the suspended floor framing.

U.N.O in builders specifications or located in saline environments or if using a glazed finish brick, brickwork is to be installed in stretcher bond pattern with raked joints.

Openable windows greater than 4m above ground level are to be fitted with a device to limit the opening or a suitable screen so a 125mm sphere cannot pass through, and withstand a force of 250N. Except for bedrooms, where the requirement is for heights above 2m.

Riser: Min 115mm - Max 190mm Going: Min 240mm - Max 355mm PINNACLE 03 6248 4218

All stairs to be constructed in accordance with NCC 2022 Vol II Part 11.2.2

PINNACLE DRAFTING & DESIGN 7/3 Abernant Way, Cambridge 7170 admin@pinnacledrafting.com.au

www.pinnacledrafting.com.au

Licence: CC6073Y

U3 - Elevations

Revision:

Approved by:

Slope (2R+G): Max 550 - Min 700

DA - 04

JRN

1:100 @ A3 Pg. No: A3.03

Scale:

Proposal: Unit Development Client: Amandeep Singh Address: 3 Morriss Ave, Montrose 7010

Date: Drawn by: MM Job No: 070-2023 Engineer: TBA

Building Surveyor: TBA

DA - 02 06 05 2025 DA - 03 25.06.2025 DA - 04 22.07.2025

Council RFI Update plans to match civil desi fix missing pages in PDF

mensions on site before commencing any orders, works or requesting, oducing shop drawings. ANY AND ALL DISCREPANCIES DISCOVER! Y OUTSIDE PARTIESARE TO BE BROUGHT TO THE ATTENTION O HE PINNACLE DRAFTING & DESIGN PTY LTD.



1:100

Ventilation of roof spaces NCC 2022 Part 10.8.3

A roof must have a roof space that-

(a)is located-

(i)immediately above the primary insulation layer;

(ii)immediately above sarking with a vapour permeance of not less than 1.14 µg/N.s, which is immediately above the primary insulation layer;

(iii)immediately above ceiling insulation; and (b) has a height of not less than 20 mm; and (c)is either-

(i)ventilated to outdoor air through evenly distributed openings in accordance with Table

(ii)located immediately underneath the roof tiles of an unsarked tiled roof.

Stormwater Notes

All gutters, downpipes and rain heads to be designed and installed in compliance with AS3500.3 & NCC 2022 Volume II Part 7.4.

Roofing Cladding

Roof cladding, flashings, cappings, roof sheeting and fixings are to be installed in accordance with NCC 2022 Volume II Part 7.2 for sheet roofing and Part 7.3 for tiled and shingle roofing.

Eaves & Soffit Linings

To comply with NCC 2022 Vol II Part 7.5.5 and where provided, external fibre-cement sheets and linings used as eaves and soffit linings must-

(a)comply with AS/NZS 2908.2 or ISO 8336; and (b) be fixed in accordance with Table 7.5.5 and Figure 7.5.5 using-

(i) 2.8×30 mm fibre-cement nails; or (ii) No. 8 wafer head screws (for 4.5 mm and 6 mm

sheets only); or (iii) No. 8 self embedding head screws (for 6 mm

Refer to table 7.5.5 for trimmer and fastener spacings.

ROOF PITCH VENTILATION OF OPENINGS (TABLE 10.8.3) >15° AND <75° 7,000 mm2/m provided at the eaves and 5,000 mm2/m at high level, plus an

additional 18,000 mm2/m at the eaves if the roof has a cathedral ceiling (1) Ventilation openings are specified as a minimum free open area per metre length of the


longest horizontal dimension of the roof.

(2) For the purposes of this Table, high level openings are openings provided at the ridge or not more than 900 mm below the ridge or highest point of the roof space, measured vertically.

GLENORCHY CITY COUNCIL PLANNING SERVICES

APPLICATION No

PLN-24-272 22/07/25 DATE RECEIVED

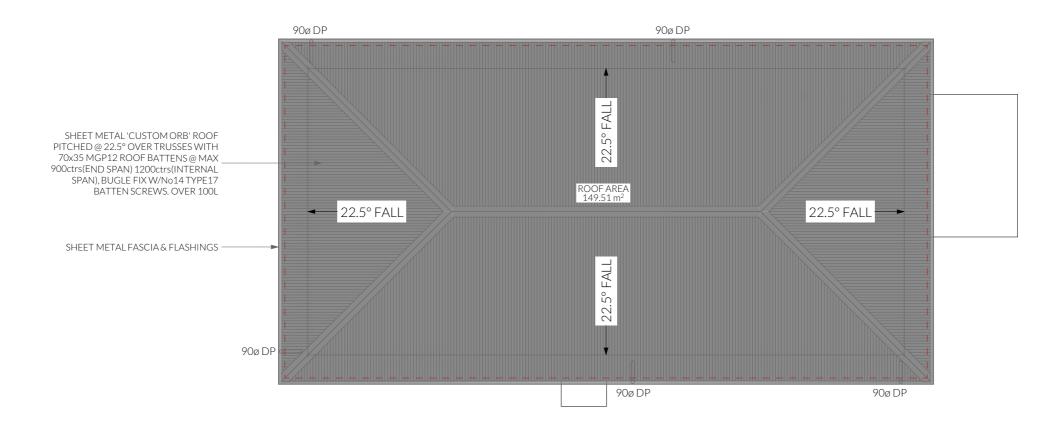



PINNACLE DRAFTING & DESIGN 7/3 Abernant Way, Cambridge 7170 03 6248 4218 admin@pinnacledrafting.com.au

www.pinnacledrafting.com.au

Licence: CC6073Y

U3 - Roof Plan

Revision:

Approved by:

DA - 04

Scale: 1:100 @ A3 Pg. No:

A3.04

Proposal: Unit Development Client: Amandeep Singh

Drawn by: MM Job No: 070-2023 Address: 3 Morriss Ave, Montrose 7010 Engineer: TBA Building Surveyor: TBA

Date:

DA - 02 06.05.2025 DA - 03 25.06.2025 DA - 04 22.07.2025

Council REI Update plans to match civil des fix missing pages in PDF




mensions on site before commencing any orders, works or requesting, oducing shop drawings. ANY AND ALL DISCREPANCIES DISCOVER! Y OUTSIDE PARTIESARE TO BE BROUGHT TO THE ATTENTION O HE PINNACLE DRAFTING & DESIGN PTY LTD.



ELECTRICAL LEGEND - UNIT 3 - Lower Floor

Symbol	Description	Allowance	Quantity
300H	DATA- CAT 6 (RJ45) - 1 GANG		3
300H 1 ™	DATA-TV CONNECTION		2
	FAN - 3 IN 1 (4 LAMP)	10W (LIGHT)	2
0	FAN - CEILING - EXHAUST		2
300H	GPO - (1) SINGLE		4
300H 2	GPO - (2) DOUBLE		17
250 200	GPO - (2) DOUBLE (WITH COOKTOP ISOLATOR SWITCH)		1
300H W/PROOF	GPO - WEATHER PROOF DOUBLE		1
$\otimes_{_{R}}$	LIGHT - CEILING - DOWNLIGHT RECESSED	10W	21
\bigotimes_{P1}	LIGHT - CEILING - PENDANT - TYPE 1	10W	3
(SA)	SERVICE - SMOKE ALARM		4
Ь	SWITCH - LIGHT 1 GANG		8
2 🕇	SWITCH - LIGHT 2 GANG		1
6₫	SWITCH - LIGHT 6 GANG		1

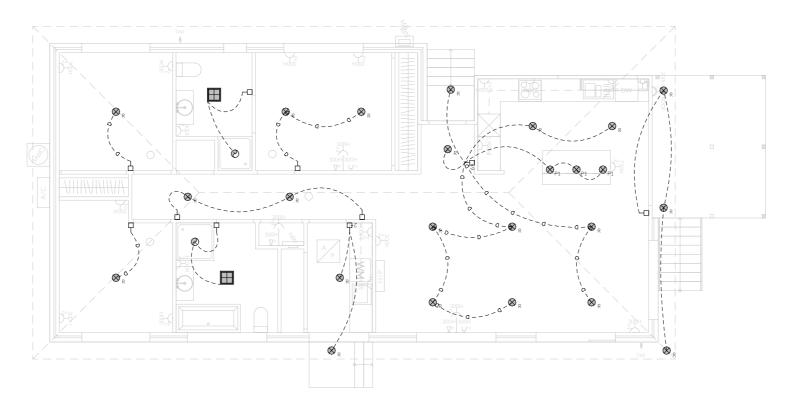

Electrical Plan - Lower - Light/Reflected Ceiling - U3

Smoke Alarms Part 9.5 of NCC 2022

Smoke alarms must-

(a)be located in-(i)a Class 1a building in accordance with 9.5.2 and 9.5.4; and (ii)a Class 1b building in accordance with 9.5.3 and 9.5.4;

(ii)a Class 1b building in accordance with 9.5.3 and 9.5.4; and (b)comply with AS 3786, except that in a Class 10a private

garage where the use of the area is likely to result in smoke alarms causing spurious signals, any other alarm deemed suitable in accordance with AS 1670.1 may be installed provided that smoke alarms complying with AS 3786 are installed elsewhere in the Class 1 building; and

(c)be powered from the consumer mains source where a consumer mains source is supplied to the building; and be interconnected where there is more than one alarm.

In a Class 1a building, smoke alarms must be located in-(a) any storey containing bedrooms, every corridor or hallway associated with a bedroom, or if there is no corridor or hallway, in an area between the bedrooms and the remainder of the building; and


(b) each other storey not containing bedrooms.

Smoke alarms required by 9.5.2 and 9.5.3 must be installed on or near the ceiling, in accordance with the following:

(a)Where a smoke alarm is located on the ceiling it must be-(i)a minimum of 300 mm away from the corner junction of the wall and ceiling; and

(ii) between 500 mm and 1500 mm away from the high point and apexes of the ceiling, if the room has a sloping ceiling.

(b)Where (a) is not possible, the smoke alarm may be installed on the wall, and located a minimum of 300 mm and a maximum of 500 mm off the ceiling at the junction with the wall.

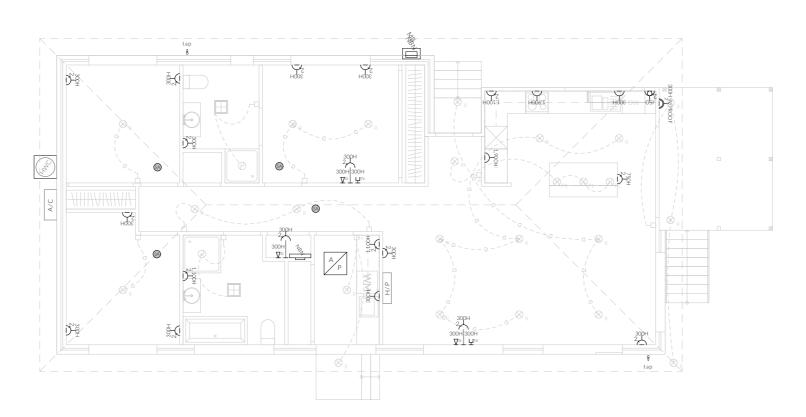

Electrical Plan - Lower - Power - U3

NOT FOR CONSTRUC

06/05/2025

Date:

Drawn by: MM

PINNACLE

PINNACLE DRAFTING & DESIGN 7/3 Abernant Way, Cambridge 7170 03 6248 4218 admin@pinnacledrafting.com.au

03 6248 4218 admin@pinnacledrafting.com.au www.pinnacledrafting.com.au Licence: CC6073Y U3 - Electrical Plan

Revision: DA - 04
Approved by: JRN

@ A Pg. No: **A3.05**

Scale:

Proposal: Unit Development
Client: Amandeep Singh

Address: 3 Morriss Ave, Montrose 7010

Job No: 070-2023

Engineer: TBA

Building Surveyor: TBA

DA-02 06.05.2025 DA-03 25.06.2025 DA-04 22.07.2025 Description
Council RFI
Update plans to match civil des
fix missing pages in PDF

sese drawing are the property of Pinnacle Drafting & Design Pty Ltd, production in whole or part is strictly forbidden without written cons 2025. These drawings are to be read in conjunction with all drawings cumentation by Engineers, Surveyors and any other consultants refe within this drawing set as well as any CLC and/or permit documentat D NOTS CALE FROM DRAWINGS; All Contractors are to verify mensions on site before commencing any orders, works or requesting oducing shop drawings. ANY AND ALL DISCREPANCIES DISCOVER (OUTSIDE PARTIES ARE TO BE BROUGHT TO THE ATTENTION C 4E PINNACLE DRAFTING & DESIGN PTY LTD.



Document Set ID: 3513815 Version: 2, Version Date: 22/07/2025 <u>Notes</u>

Note: Exhaust Fans

(b)40 L/s for a kitchen or laundry.

directly or via a shaft or duct to outdoor air.

via a shaft or duct to outdoor air.

accordance with 10.6.2(a) must-

switch is turned off.

5W/m² in class 1a dwellings

 $4W/m^2$ to veranda, balcony or the like

DATE RECEIVED

Note: Lighting

Exhaust fans to comply with NCC 2022 Vol 2 Part 10.8.2 and

 -An exhaust system installed in a kitchen, bathroom, sanitary compartment or laundry must have a minimum flow rate of-(a) 25 L/s for a bathroom or sanitary compartment; and

-Where a venting clothes dryer is installed, it must discharge

 -An exhaust system that is not run continuously and is serving a bathroom or sanitary compartment that is not ventilated in

(a)be interlocked with the room's light switch; and (b)include a run-on timer so that the exhaust system continues to operate for 10 minutes after the light

Lighting layout may change, owner to confirm with builder prior to purchase/installation of exact quantity and location of electrical services provided that installation is compliant with AS3000 and artificial lighting allowances do not exceed:

3W/m² in a class 10a dwelling associated with the class 1a

U.N.O - All downlights are to be Insulation Contact (IC) rated.

Preparation for future Solar Installation:

Should the solar design be required for future installation,

2/25mm solarflex (or similar) conduits marked "solar" are to be installed from the meter box to the roof space - See electrical

GLENORCHY CITY COUNCIL
PLANNING SERVICES

PLN-24-272 22/07/25

 -Exhaust from a kitchen, kitchen range hood, bathroom, sanitary compartment or laundry must discharge directly or

U.N.O ceilings are to be plasterboard.

--□---- Dimmable Circuit

-- Ţ --- Ţ Timer Circuit(as fan note)


PB - Plasterboard

CS - Cement Sheet Eaves

- Plywood Ceiling -Timber Batten Ceiling

Vehicle Movement Notes

- Movement templates demonstrate the ability of vehicles to enter intersection in a forwards direction and leave in a forwards direction.
- The base dimensions of the vehicle template represent the B85 (85th Percentile) Vehicle
- The swept path of the vehicle represent the outer extents of the vehicle.

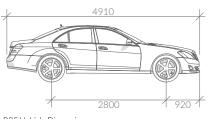

B85 Vehicle Dimensions

 Width:
 1870

 Track:
 1770

 L-L Time:
 6.0

 Turning Radius:
 5800

Parking Space requirements

As defined by the Parking and Sustainable Transport Code - Table C2.3

Parking Dimensions - 90°

 Width:
 2600
 2800
 3000
 3200

 Length:
 5400
 5400
 5400
 5400

 Aisle Width:
 6400
 5800
 5200
 4800

Parking Dimensions - 45°

Width: 2600 Length: 5400 Aisle Width: 3500

Parking Dimensions - Parallel

Width: 2300 Length: 6700 Aisle Width: 3600

<u>Legend</u>


- Solar Bollard Lighting
- ✓ Spotlight with Sensor

Turning Path Legend

— LINE OF BODY

— 300mm BODY CLEARANCE

— DIRECTION OF TRAVEL

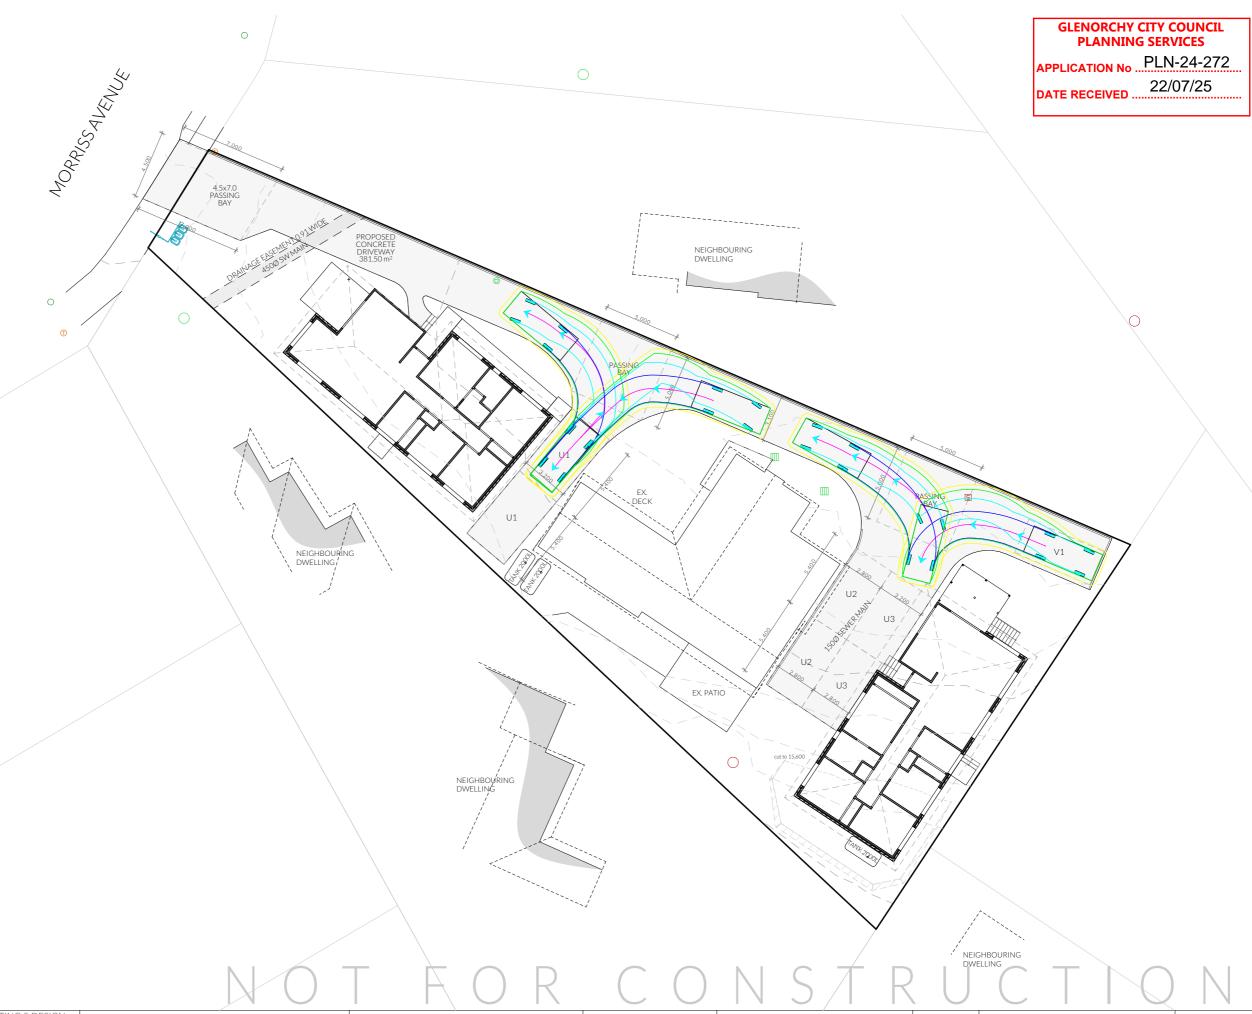

PINNACLE

PINNACLE DRAFTING & DESIGN 7/3 Abernant Way, Cambridge 7170 03 6248 4218

admin@pinnacledrafting.com.au www.pinnacledrafting.com.au Licence: CC6073Y Parking

Revision:

Approved by:

DA - 04

Scale: 1:250 @ A3 Pg. No:

C.01

Proposal: Unit Development Client: Amandeep Singh

Address: 3 Morriss Ave, Montrose 7010

Date: 06/05/2025

Drawn by: MM

Job No: 070-2023

Engineer: TBA

Building Surveyor: TBA

DA-02 06.05.2025 DA-03 25.06.2025 DA-04 22.07.2025 Council RFI
Update plans to match civil design fix missing pages in PDF

N

These drawing are the property of Pinnacle Drafting & Design Pty Ltd. perporduction in whole or part is strictly forbidden without written conse to 2025. These drawings are to be read in conjunction with all drawings a locumentation by Engineers. Surveyors and any other consultants refer to within this drawing set as well as any CLC and/or permit documentation DO NOT SCALE FROM DRAWINGS: All Contractors are to verify dimensions on site before commencing any orders, works or requesting, producing shop drawings. ANY AND ALL DISCREPANCISC DISCOVER! YO UTSIDE PARTIES SARE TO BE BROUGHT TO THE ATTENTION O

