

DEVELOPMENT APPLICATION

APPLICATION NUMBER:	PLN-24-181
PROPOSED DEVELOPMENT:	Sediment Basin and associated works (Utilities)
LOCATION:	15 Redlands Drive Rosetta 2 Redlands Drive Rosetta
APPLICANT:	Glenorchy City Council
ADVERTISING START DATE:	09/05/2025
ADVERTISING EXPIRY DATE:	23/05/2025

Plans and documentation are available for inspection at Council's Offices, located at 374 Main Road, Glenorchy between 8.30 am and 5.00 pm, Monday to Friday (excluding public holidays) and the plans are available on Glenorchy City Council's website (www.gcc.tas.gov.au) until **23/05/25**.

During this time, any person may make representations relating to the applications by letter addressed to the Chief Executive Officer, Glenorchy City Council, PO Box 103, Glenorchy 7010 or by email to gccmail@gcc.tas.gov.au.

Representations must be received by no later than 11.59 pm on **23/05/25**, or for postal and hand delivered representations, by 5.00 pm on **23/05/25**.

Project: Glenorchy City Council - Redlands Drive, Rosetta Debris Basin	Project No.: 230352CS
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Discipline	Day	25	20	04	08	22	19	16							
Civil / Structural Services	Mth	08	09	03	03	05	03	04							
	Year	23	23	24	24	24	25	25							

Document Register	Doc. No.	Revision													
Notes Sheet 1	C01	P1	P2	P3	P4	BA	BA1	BA1							
Notes Sheet 2	C02	P1	P2	P3	P4	BA	BA1	BA1							
General Arrangement	C03	P1	P2	P3	P4	BA	BA1	BA2							
Levels and Alignment Plan	C04	P1	P2	P3	P4	BA	BA1	BA2							
Debris Basin Typical Details and Sections	C05	P1	P2	P3	P4	BA	BA1	BA1							
Basin Profiles	C06	P1	P2	P3	P4	BA	BA1	BA1							
Debris Basin Cross Sections	C07	P1	P2	P3	P4	BA	BA1	BA1							
Retaining Wall Elevations Sheet 1	C08	P1	P2	P3	P4	BA	BA1	BA1							
Retaining Wall Elevations Sheet 2	C09			P1	P2	BA	BA1	BA1							
Structural Details Sheet 1	C10			P1	P2	BA	BA1	BA2							
Structural Details Sheet 2	C11			P1	P2	BA	BA1	BA1							
Jointing Plan	C12			P1	P2	BA	BA1	BA1							
Watermain Lowering Notes & Details	C100						BA1	BA2							
Watermain Lowering General Arrangement & Profiles	C101						BA1	BA2							

Distribution	Copies													
GCC (Patrick Marshall)		1	1	1	1	1	1	1						

Reason for Issue														
X - Information	P - Preliminary		P	P	P	P	A	A	A					
R - Review	T - Tender													
C - Construction	A - Approval													

Type														
E - E-mail	D - .dwg	P - PlanBuild	L - Link		E	E	E	E	E	E	E			
U - USB	Z - Paper	A - Aconex												

Comments

30 April 2025

Planning Officer
Glenorchy Planning Authority
Glenorchy City Council

Dear Planning Officer

PLN-24-290 RESPONSE TO ADDITIONAL INFORMATION REQUEST UNDER S54(1) LUPAA – REDLANDS DRIVE FLOOD EROSION MITIGATION WORKS

This letter is in response to the additional information requested under the planning provisions for the proposed Redlands Drive Flood Erosion and Mitigation Works.

We have had several constructive discussions with the Council's planning officer, development engineers, and TasWater to better understand the additional information needed. This response has been prepared based on those discussions and our understanding of the requirements.

This response also includes the following additional documents as supporting information:

- Revised Engineering Plans with a section of TasWater bulk water main replaced along with associated adjustment as approved by TasWater
- Erosion and Sediment Control Plan
- Driveway drainage discharge calculations worksheet
- Email correspondence with statements from Council's Senior Transport Engineer and Manager Asset, Engineering and Design assessment on the proposed gradients of the maintenance access driveway for sediment basin
- Email correspondence from Council's Manager Assets, Engineering and Design as the asset owner, confirming the level of acceptance of the proposed driveway design and associated drainage measures

I welcome the opportunity to discuss this application further with the Glenorchy City Council Planning Authority if there are further clarifications required. Please feel free to contact me at 03 6216 6457 or dan.egodawatte@gcc.tas.gov.au for any additional information.

Thank you for your time and consideration.

Senior Civil Engineer

Responses to the additional information requests:

6.0 Assessment of an Application for Use or Development

Clause 6.1.3, Application requirements	Response:
<p>The submitted site plan does not match the area to be used during construction for machinery access and temporary stock piling of fill. This request is to enable assessment of the application in accordance with the standards of the Scheme.</p> <p>Please provide a copy of scaled and dimensioned plans showing the following:</p> <ul style="list-style-type: none"> • A site plan showing the full extent of the area to be disturbed by the use and development during construction, including all pathways and areas to be used by machinery to access the site. • A site plan showing any areas to be disturbed for use and development in relation to the replacement of the section of the Lake Fenton pipeline, including any temporary stock piling of dirt during the replacement. 	<ul style="list-style-type: none"> • An Erosion and Sediment Control Plan has now been provided. The plan includes stockpiling area, access points and area of ground disturbance and proposed measures in place to control sediment and erosion during construction. Stockpiling is expected to be minimised due to most of the cut material being used as fill within the works area (marked on the map) and to minimise erosion impacts. • A revised engineering plan submitted for the works near the TasWater bulk main (not the Fenton pipeline). No stockpiling to occur within the proximity of the water main and in drainage easement unless approved by or prior consultation with Tas Water.

22.0 Landscape and Conservation Zone


Clause 22.3.3, Discretionary use	Response:
<p>The submitted plan indicates the proposal may impact the landscape values. Please demonstrate that the proposal satisfies performance criteria P1 of Clause 22.3.3 Discretionary use, Tasmanian Planning Scheme – Glenorchy. In particular, please demonstrate how the proposal will have regard to the landscape values of the site and surrounding area, and how the proposal will take measures to minimise or mitigate impacts</p>	<p>Proposed development works, including sediment retention basin and stormwater channel, falls under ‘minor utilities’ as defined in the LUPAA 1993 and is considered a permitted use class for 22.0 Landscape and Conservation Zone.</p>
Clause 22.4.4 Landscape protection	Response:

<p>The submitted plan indicates the proposal may impact the vegetation and landscape values. Please demonstrate that the proposal satisfies performance criteria P1 of Clause 22.4.4 Landscape protection, Tasmanian Planning Scheme – Glenorchy. In particular, please demonstrate how the proposal will have regard to the vegetation and landscape values of the site, and how the proposal will take measures to minimise or mitigate impacts.</p>	<p>Works are to be strictly limited to the extent shown in the Erosion and Sediment Control Plan and mostly contained within the watercourse. This ensures minimum impacts to the natural and landscape values.</p> <p>Landscape conservation was considered during the design process. The proposed design solution incorporating retaining walls was selected over constructing extensive batters in order to minimise the area of earthworks required outside the natural waterway and disturbance to the existing vegetation.</p> <p>Only the vegetation and trees that are directly within the works zone will be removed under the instruction of a qualified arborist and works are to be performed under the Erosion and Sediment Control Plan submitted herewith.</p> <p>Furthermore, we have consulted with Council's Property, Environment & Waste department to confirm there are no significant trees in the area or the works zone.</p>
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23.0 Environmental Management Zone



Clause 23.3.1 Discretionary use	Response:
<p>The submitted plan indicates the proposal may extend into the Environmental Management Zone (CT 50844/1) during construction, if this is the case then there may be an impact the land management values.</p> <p>Please demonstrate that the proposal satisfies performance criteria P1 of Clause 23.3.1 Discretionary use, Tasmanian Planning Scheme – Glenorchy. In particular, please demonstrate how the proposal will have regard to the protection, conservation and management of the site, and how the proposal will take measures to minimise or mitigate impacts.</p> <p>Note:</p> <p>If the construction area, including use of machinery, does not extend into CT 50844/1 please ignore this request.</p>	<p>Proposed works are to occur outside of the Environmental Management Zone. The Erosion and Sediment Control Plan provided indicates the separation of the proposed works to the shared boundary between 160921/1 and CT50844/1.</p>
Clause 23.4.1 Development area	Response:
<p>The submitted plan indicates the proposal may extend into the Environmental Management Zone (CT 50844/1) during construction, if this is the case then there may be an impact the land management values. Please demonstrate that the proposal satisfies performance criteria P1 of Clause 23.4.1 Discretionary use, Tasmanian Planning Scheme – Glenorchy. In particular, please demonstrate how the proposal will have regard to the protection, conservation, remediation or mitigation of the site.</p> <p>Note:</p> <p>If the construction area, including use of machinery, does not extend into CT 50844/1</p> <p>please ignore this request.</p>	<p>Proposed works are to occur outside of the Environmental Management Zone. The Erosion and Sediment Control Plan provided indicates the separation of the proposed works to the shared boundary between 160921/1 and CT50844/1.</p>

C2.0 Parking and Sustainable Transport Code

C2.6.1 Construction of Parking Areas	Response
<p>Please provide a stormwater concept plan showing the capture and disposal of all stormwater run-off from the proposed driveway, parking and any new hardstand areas to Council's approved outlet.</p> <p>All runoff must be drained via gravity to the proposed outlet. Driveway, parking and any new hardstand areas must be constructed and compacted to standards with paved/sealed surface, provide a driveway plan demonstrated the requirement:</p> <ul style="list-style-type: none"> • Please show drainage for the driveway • Driveway to be sealed; and • The legend missing.  <p>Green = Batter, Orange=??</p>	<ul style="list-style-type: none"> • Please refer to the '<i>Driveway Drainage Discharge Calculations Worksheet</i>' for detailed calculations that demonstrate the additional runoff generated from the driveway portion towards the kerb and gutter is insignificant (0.78 l/sec). Also, a capacity comparison of the stormwater side entry pit at the Cul-de-Sac has been provided and it demonstrates the net increase is an only 4% of the kerb inlet capacity. These calculations are justified by endorsement of the Manager Assets, Engineering and Design, from the asset owner's perspective, that the additional drainage received by the kerb and gutter infrastructure is acceptable. • The driveway is reinforced concrete and will be constructed in accordance with TSD-R14. • The legend for all plans is listed on the notes sheet C02 and for reinstatement details on C04. Green area is topsoil with grass seed and Orange area is the verge(gravel)
C2.6.2 Design and layout of parking areas	Response

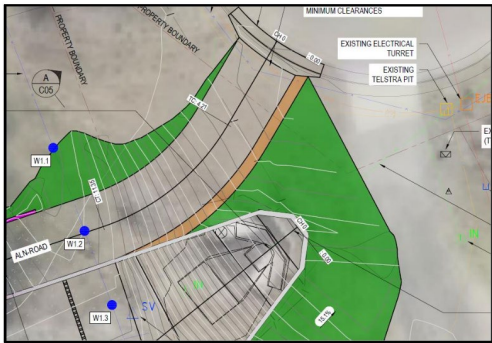Layout of driveway and parking areas must be in accordance with the AS2890.1:2004 (depends what kind of vehicle is going to use the driveway) and the Scheme requirements. Please clearly show on the parking plan details of the proposed driveway, access and parking areas including gradients, parking area, spot levels, manoeuvring area, materials, finishing surface and drainage details must be submitted to demonstrate compliance and shall comply with the followings:

- Please show driveway long section CH00-CH25 to demonstrate the design is in accordance with AS. It is noted that the grades exceed 25% maximum allowable grade.
- Show detailed driveway crossover including footpath width, wings and grade.

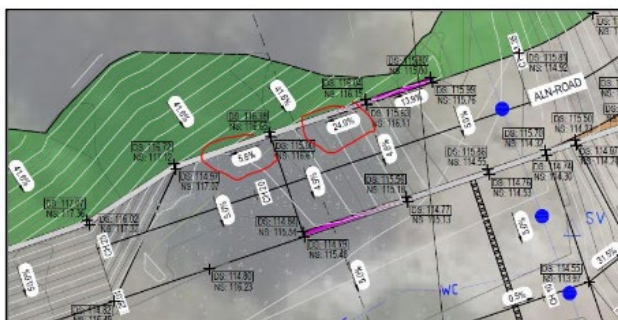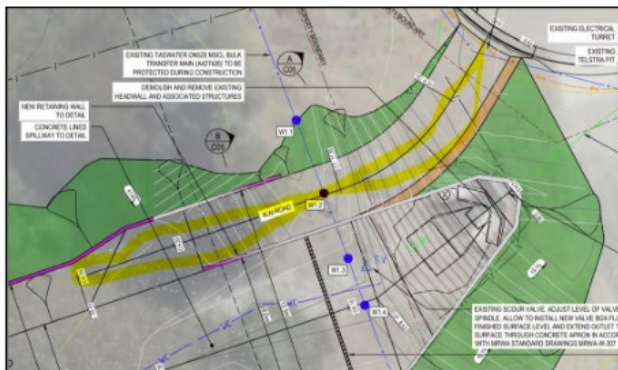

	<p>area, particularly around the mouth of the pipes. The ability to use a vac truck provides an alternative method of debris removal without requiring additional modifications to the driveway grade.</p> <ul style="list-style-type: none"> • A 30% longitudinal grade remains within acceptable parameters for maintenance vehicles and personnel access. Many utility and maintenance roads exceed standard residential driveway requirements and still function effectively for their intended purpose. Given that this driveway is not intended for frequent or daily passenger vehicle use, but rather periodic maintenance access, a steeper grade is reasonable and practical. • The presence of heavy equipment such as backhoes and excavators ensure that any required maintenance, including clearing debris, silt, and other obstructions, can be effectively conducted without the need for a lower-grade driveway. The use of specialised equipment mitigates the need for compliance with residential driveway slope standards. Additionally, the driveway has been designed to only need to be cleaned quarterly, meaning access will be required only once every three months.
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GENERAL

WORK HEALTH & SAFETY NOTICE:
JMG HAVE CONSIDERED THE HAZARDS AND RISKS ASSOCIATED WITH THE CONSTRUCTION, OPERATION, MAINTENANCE AND EVENTUAL DEMOLITION OF THIS PROJECT. THERE ARE A NUMBER OF HAZARDS AND HENCE RISKS WHICH ARE NOT UNIQUE TO THIS PROJECT WHICH NEED TO BE MANAGED DURING THESE PHASES. JMG REMIND CONSTRUCTORS, OPERATORS, MAINTAINERS AND DEMOLISHERS OF THEIR RESPONSIBILITIES UNDER WORK HEALTH & SAFETY ACTS AND REGULATIONS. THE FOLLOWING RISKS HAVE BEEN IDENTIFIED WHICH ARE UNUSUAL TO THIS PROJECT: LANDSLIP RISK AREA. FLOOD PRONE AREA

UNLESS SPECIFIED OTHERWISE BY DOCUMENTATION SPECIFIC TO THIS PROJECT ALL DIMENSIONS, MATERIALS, WORKMANSHIP ETC SHALL COMPLY WITH DSG STANDARD CONTRACT DOCUMENTS AND SPECIFICATIONS (R SERIES) AND IPWEA TASMANIAN DIVISION STANDARD DRAWINGS (INCLUDING THE AUTHORITIES LISTED DEPARTURES FROM THE IPWEA STANDARD DRAWINGS) VERSION 3 ISSUED DECEMBER 2020.

ONLY THOSE SERVICES CONSPICUOUS DURING FIELD SURVEYS HAVE BEEN PLOTTED. THE LOCATION OF THESE SERVICES IS APPROXIMATE ONLY AND NO GUARANTEE IS GIVEN THAT ALL SERVICES ARE SHOWN. THE CONTRACTOR SHALL CONFIRM ON SITE PRIOR TO THE START OF WORKS THE LOCATION OF ALL SERVICES WITH THE RELEVANT AUTHORITY. TASWATER BULK TRANSFER MAIN A428426 LOCATED VIA NON DESTRUCTIVE DIGGING METHODS (POTHOLING) ON 07/07/2023 AND 12/02/2025.

THE CONTRACTOR MUST POTHOLE ALL EXISTING SERVICES AT PROPOSED CROSSING POINTS WITH NEW SERVICES, STRUCTURES AND WHERE UNDER REDUCED FINISHED SURFACE LEVELS PRIOR TO THE COMMENCEMENT OF WORKS TO DETERMINE IF THE EXISTING OR PROPOSED SERVICE WILL BE ADVERSELY AFFECTED BY CLASH OR REDUCED MINIMUM COVER. THE CONTRACTOR MUST POTHOLE EXISTING SERVICES AT ALL PROPOSED CONNECTION POINTS FOR NEW SERVICES TO CONFIRM THAT MINIMUM COVER AND OR GRADIENT FOR THE NEW SERVICE WILL BE ACHIEVED. WHERE A CONFLICT WITH AN EXISTING OR PROPOSED SERVICE IS IDENTIFIED THE CONTRACTOR SHALL SEEK DIRECTION FROM THE SUPERINTENDENT. NO CLAIM FOR VARIATION OR EXTENSION OF TIME WILL BE CONSIDERED AS A RESULT OF THE CONTRACTORS FAILURE TO UNDERTAKE THIS INVESTIGATION, AT A SUFFICIENT TIME PRIOR TO THE INSTALLATION WORKS, TO ALLOW ANY REDESIGN TO OCCUR.

PRIOR TO THE COMMENCEMENT OF SITE WORKS THE CONTRACTOR SHALL PREPARE, SUBMIT AND GAIN APPROVAL FROM THE RELEVANT COUNCIL FOR A SOIL AND WATER MANAGEMENT PLAN FOR THE CONSTRUCTION WORKS. THE CONTRACTOR SHALL BE RESPONSIBLE FOR THE INSTALLATION AND MAINTENANCE OF ALL REQUIRED PROTECTION MEASURES FOR THE DURATION OF THE CONTRACT AND UNTIL NEW VEGETATION IS FULLY ESTABLISHED.

ALL SITE WORKS SHALL BE UNDERTAKEN IN ACCORDANCE WITH THE ENVIRONMENTAL CONDITIONS OF THE PLANNING PERMIT. ALL CONSTRUCTION EQUIPMENT ENTERING AND LEAVING THE SITE SHALL BE WASHED IN ACCORDANCE WITH THE REQUIREMENTS OF THE EPA.

PRIOR TO THE COMMENCEMENT OF ANY COUNCIL INFRASTRUCTURE WORKS, THE CONTRACTOR SHALL APPLY TO COUNCIL, AND RECEIVE A PERMIT TO CONSTRUCT PUBLIC INFRASTRUCTURE.

FOR WORKS WITHIN THE ROAD RESERVATION THE CONTRACTOR SHALL APPLY FOR AND RECEIVE A ROAD OPENING PERMIT FROM COUNCIL PRIOR TO THE COMMENCEMENT OF WORKS, THIS APPLICATION SHALL INCLUDE THE PREPARATION OF TRAFFIC AND PEDESTRIAN MANAGEMENT PLANS AS APPLICABLE.

PRIOR TO THE COMMENCEMENT OF ANY TASWATER INFRASTRUCTURE WORKS, THE CONTRACTOR SHALL APPLY TO TASWATER, AND RECEIVE A PERMIT TO CONSTRUCT TASWATER INFRASTRUCTURE.

THE CONTRACTOR SHALL BE RESPONSIBLE FOR THE INSTALLATION AND MAINTENANCE OF ALL PEDESTRIAN AND TRAFFIC MANAGEMENT DEVICES TO COMPLY WITH AS1742 FOR THE DURATION OF THE WORKS.

THE CONTRACTOR SHALL PREPARE IN ELECTRONIC (.DWG) FORMAT "AS CONSTRUCTED" DRAWINGS TO THE SATISFACTION OF JMG, COUNCIL MUNICIPAL ENGINEER AND/OR TASWATER SHOWING THE AS INSTALLED LOCATION OF ALL ABOVE AND BELOW GROUND WORKS. CONFIRMATION OF APPROVAL, FROM THE RELEVANT AUTHORITIES, OF THE COMPLETED DRAWINGS SHALL BE SUBMITTED TO THE SUPERINTENDENT PRIOR TO THE ISSUING OF THE CERTIFICATE OF PRACTICAL COMPLETION.

ALL PIPEWORK (WATER, SEWER AND STORMWATER) PROFILE LEVELS ARE TO THE PIPE INVERT LEVEL. ALLOW ADDITIONAL TRENCHING DEPTH FOR BEDDING AS INDICATED ON THE TYPICAL DETAILS.

THE CONTRACTOR IS RESPONSIBLE FOR COMPLYING WITH ALL CONDITIONS OF THE PLANNING PERMIT, A COPY OF WHICH MUST BE KEPT ON SITE.

PROPRIETARY PRODUCTS ARE TO BE INSTALLED IN ACCORDANCE WITH THE MANUFACTURER'S WRITTEN INSTRUCTIONS.

EARTHWORKS

DEMOLISH AND REMOVE ALL CONCRETE SLABS, KERBS, WALLS ETC. AS NOTED AND REQUIRED FOR THE CONSTRUCTION OF THE NOMINATED WORKS.

FOLLOWING DEMOLITION AND REMOVAL OF SLABS, KERBS ETC. AND STRIPPING OF THE SITE TO THE REQUIRED FORMATION LEVELS, GRADE SUB-GRADE TO A SMOOTH PROFILE AND CONSOLIDATE TO 98% MAXIMUM DRY DENSITY (AS 1289.5) PROOF ROLL IN THE PRESENCE OF THE CONSULTING ENGINEER USING A SINGLE AXLE RIGID TRUCK WITH A FULL LEGAL LIMIT LOAD. REMOVE ANY UNSUITABLE SOFT, WET OR HEAVING MATERIAL AS DIRECTED BY THE SUPERINTENDENT AND REPLACE WITH COMPACTED SELECT FILL IN LAYERS NOT EXCEEDING 200mm LOOSE TO ACHIEVE 98% STANDARD COMPACTION (AS1289.5).

ALL STRIPPED TOPSOIL SHALL BE STOCKPILED ON-SITE FOR RESPREADING ON BATTERS AND DISTURBED AREAS, ALL EXCESS EXCAVATED MATERIAL SHALL BECOME THE PROPERTY OF THE CONTRACTOR AND SHALL BE DISPOSED OF OFF SITE AT THE CONTRACTORS COST UNLESS APPROVED OTHERWISE BY THE SUPERINTENDENT.

ANY IMPORTED FILL MATERIAL FOR UNDER ROADWAYS AND BASIN SHALL BE WELL GRADED WITH A MAXIMUM PARTICLE SIZE OF 75mm, 80% LESS THAN 20mm, HAVE A MINIMUM CBR VALUE OF 15% AND A PLASTICITY INDEX LESS THAN 12%. COMPACT TO A MINIMUM OF 95% STANDARD COMPACTION TO DSG SPECIFICATION R22 IN LAYERS NOT EXCEEDING 200mm LOOSE THICKNESS.

ALL EARTHWORKS INCLUDING EMBANKMENTS SHALL BE PREPARED AND CONSTRUCTED TO DSG SPECIFICATION R22 & R23

WHERE EMBANKMENT FILLS EXCEED 400mm IN HEIGHT ABOVE STRIPPED SURFACE LEVEL THE CONTRACTOR SHALL PROVIDE COMPACTION TEST RESULTS FOR THE PLACED MATERIAL AT A RATE OF AT LEAST 1 PER 500M2 OR A MINIMUM OF 2 PER LAYER WHICHEVER IS THE GREATER UNLESS APPROVED OTHERWISE BY THE SUPERINTENDENT. EMBANKMENT COMPACTION SHALL BE IN ACCORDANCE WITH DSG SPECIFICATION R22 TABLE 22.3.

WHERE EMBANKMENTS ARE TO BE CONSTRUCTED ON NATURAL GROUND WITH SLOPES EXCEEDING 3 HORIZONTAL TO 1 VERTICAL (3:1) THE FOUNDATION SHALL BE CUT INTO HORIZONTAL BENCHES TO DSG SPECIFICATION R22.9.1 PRIOR TO THE COMMENCEMENT OF EMBANKMENT CONSTRUCTION.

DURING FORMATION WORKS THE CONTRACTOR SHALL ENSURE THAT ADEQUATE STEPS ARE TAKEN TO PROTECT THE SUBGRADE FROM WET WEATHER PRIOR TO THE PLACEMENT OF THE SUB-BASE. NO CLAIM WILL BE CONSIDERED AS A RESULT OF THE CONTRACTORS FAILURE TO PROTECT THE WORKS.

ROADWORKS

WHERE NEW WORKS ABUT EXISTING SAWCUT ALL INTERFACES TO NEAT STRAIGHT LINES AND RECTANGULAR SHAPES AND MAKE GOOD TO MATCH.

BACKFILL ALL TRENCHES AND EXCAVATIONS WITHIN VEHICLE PAVEMENTS FULL DEPTH WITH 20mm FINE CRUSHED ROCK CONSOLIDATED IN MAXIMUM 150 LAYERS TO 96% MODIFIED COMPACTION.

SUBMIT TO THE CONSULTING ENGINEER PRIOR TO THEIR USE MATERIAL PROPERTIES AND SOURCE FOR ALL ROAD MAKING MATERIALS. UNLESS NOTED OTHERWISE PAVEMENT MATERIALS SHALL COMPLY WITH THE REQUIREMENTS OF DSG SPECIFICATION R40 FOR BASE CLASS A AND SUB-BASE 1 MATERIALS.

EACH COMPLETED PAVEMENT LAYER SHALL BE COMPACTED TO A MINIMUM DDR OF 96% FOR SUB-BASE AND 98% FOR BASE COURSE AND PROOF ROLLED IN THE PRESENCE OF THE SUPERINTENDENT AND COUNCIL'S WORKS INSPECTOR WHERE REQUIRED USING A SINGLE AXLE RIGID TRUCK WITH A FULL LEGAL LIMIT LOAD.

CONSTRUCT PAVEMENT BETWEEN NOMINATED LEVELS TO SMOOTH GRADES AND TRANSITION TO DRAIN TO PITS, KERB AND GUTTER, V-DRAINS ETC.

HOTMIX AND PAVED SURFACES SHALL HAVE A BITUMEN EMULSION PRIME COAT APPLIED TO THE CLEAN SWEEPED SURFACE OF THE BASE COURSE AT THE MINIMUM RATE OF 0.15 LM² RESIDUAL BINDER.

CONCRETE COMPRESSIVE STRENGTH SHALL BE :
PAVEMENTS AND GRATED TRENCH - N32
PITS, & MINOR WORKS - N25.
WORKMANSHIP, MATERIALS AND DESIGN SHALL BE IN ACCORDANCE WITH AS3600 AND THE ASSOCIATED CODES LISTED THEREIN AND THE SPECIFICATION.

GRADE AND ROLL MINIMUM 150 TOPSOIL TO ALL BATTERS & DISTURBED AREAS. WHERE NECESSARY TO RAISE LEVELS, PLACE AND CONSOLIDATE GENERAL FILL FROM SITE BENEATH TOPSOIL. HYDROMULCH AND SEED DISTURBED AREAS WITH TYPE A SEED MIX TO DSG SPECIFICATION R70.

CONCRETE PAVEMENTS GENERAL

CONSTRUCT PAVEMENT BETWEEN NOMINATED LEVELS TO SMOOTH GRADES AND TRANSITION TO PITS, HEADWALLS ETC. THE MINIMUM GRADIENT OF ANY AREA ON THE PAVEMENT IS TO BE 1:100. WHERE DISCREPANCIES EXIST ON THE DRAWINGS REFER TO SUPERINTENDENT FOR DIRECTION.

INSTALL 2No. N16 x 2100 LONG TRIMMER BARS AT 45Deg ACROSS ALL RE-ENTRANT CORNERS.

INSTALL ISOLATION JOINTS AT ALL INTERFACES WITH EXISTING OR PROPOSED STRUCTURES.

ALL JOINT SEALANTS SHALL BE INSTALLED IN ACCORDANCE WITH THE MANUFACTURER'S WRITTEN SPECIFICATIONS.

TOLERANCES OF FINISHED SURFACES
MAXIMUM DEVIATION UNDER A 3m STRAIGHT EDGE = +/-10mm
MAXIMUM LEVEL DIFFERENCE FROM DESIGN LEVELS = +/-20mm
CONCRETE THICKNESS AND REINFORCEMENT LOCATION TO AS3600

CURE SURFACE FOR MINIMUM 7 DAYS AFTER PLACEMENT, CONTRACTOR TO SUBMIT TO THE SUPERINTENDENT FOR APPROVAL THE PROPOSED METHOD OF CURING PRIOR TO THE COMMENCEMENT OF PAVEMENT WORKS. PROTECT SURFACE FROM VEHICULAR TRAFFIC DURING CURING PERIOD.

SURVEY CONTROL

DATE OF SURVEY 11/10/2022

HORIZONTAL DATUM AS PER MGA2020 ZONE 55 AND VERTICAL DATUM AS PER AHD

AS SUPPLIED BY VERIS

CONTOUR INTERVAL IS 0.25M

WHILE REASONABLE EFFORT HAS BEEN MADE TO LOCATE ALL VISIBLE ABOVE GROUND SERVICES, THERE MAY BE OTHER SERVICES THAT WERE NOT LOCATED DURING THIS SURVEY.

MACCAFERRI RENO MATTRESS

MACCAFERRI RENO MATTRESS TO BE INSTALLED IN ACCORDANCE WITH RENO MATTRESS INSTALLATION MANUAL REV 1, DATE 19.04.2017
(https://www.geofabrics.co/sites/default/files/installation%20manual%20reno%20mattresses%20eng_rev%201_19042017.pdf)

MACCAFERRI RENO MATTRESS TO BE INSTALLED USING 3 NO. 6M WIDE X 2M LONG MATTRESSES WITH A DEPTH OF 300MM.

DENSE GRADED QUARRY MATERIAL TO BE USED TO FILL MATTRESS. TO ENSURE THE DURABILITY OF THE STRUCTURE, THE ROCK SHOULD BE WEATHER RESISTANT, NON-FRIABLE, INSOLUBLE AND SUFFICIENTLY HARD. MATERIAL TO RANGE FROM 75MM MINIMUM TO MAXIMUM 200MM. MATERIAL SLECTION TO THE APPROVAL OF GCC AND SUPERINTENDENT.

MACCAFERRI RENO MATTRESS WIRE MESH PRODUCTS TO BE BE MACAFERRI RENO MATTRESS GALMAC CODE RGM30-625.

BIDIM A24 GEOTEXTILE TO BE PROVIDED TO MATTRESS-SOIL INTERFACE.

THE FOUNDATION ON WHICH MATTRESSES ARE TO BE PLACED SHALL BE LEVEL AND GRADED TO THE ELEVATIONS AS SHOWN ON THE PROJECT CONSTRUCTION DRAWINGS. THE FOUNDATION SHALL BE SMOOTH AND FREE FROM SURFACE IRREGULARITIES, LOOSE MATERIAL AND VEGETATION. APPROPRIATE MEASURES SHALL BE TAKEN FOR FILTERING AND DRAINAGE OF THE FOUNDATION, AS PER THE PROJECT CONSTRUCTION DRAWINGS. FOUNDATION MATERIAL TO BE PREPARED, INSPECTED AND APPROVED BY SUPERINTENDENT PRIOR TO THE INSTALLATION OF GEOTEXTILE AND RENO MATTRESS.

GLENORCHY CITY COUNCIL
PLANNING SERVICES
APPLICATION No PLN-24-181
DATE RECEIVED 30 April 2025

BA1	19.03.2025	REVISED BUILDING APPROVAL
BA	22.05.2024	BUILDING APPROVAL ISSUE
P4	08.03.2024	CLIENT REVIEW ISSUE
P3	04.03.2024	REVISED PRELIMINARY ISSUE
P2	20/09/2023	ISSUED FOR TW COMMENTS
P1	25/08/2023	PRELIMINARY ISSUE
REV	DATE	REMARK
SAFETY IN DESIGN REPORT PER WHS REGULATIONS		
The following table which will confirm to this design have been identified.		
		N/A
This report does not relieve contributors from their responsibilities under the Act to identify, report, mitigate and manage all aspects of risk and safety.		



JOHNSTONE McGEE & GANDY PTY LTD
117 Harrington Street, Hobart TAS (03) 6231 2555
49-51 Elizabeth Street, Launceston TAS (03) 6334 5548
www.jmg.net.au info@jmg.net.au info@jmg.net.au

PROJECT
GLENORCHY CITY COUNCIL,
REDLANDS DRIVE ROSETTA
DEBRIS BASIN
TITLE
NOTES SHEET 1

Accepted MJR	Date
(Discipline Head)	19.03.2025
Accepted MJR	Date
(Team Leader)	19.03.2025
Approved CUM	Date
(Principal)	19.03.2025
This document must be signed 'Approved' by JMG to authorise it for use. JMG accept no liability whatsoever for unauthorised or unlicensed use.	
SCALES @ A1	DESIGNED BY
NA	TCM
	PLOT DATE
	19/03/2025

DO NOT SCALE. Use only figured dimensions. Locations of structures, fittings, services etc on this drawing are indicative only. CONTRACTOR to check Architects & other project drawings for co-ordination between structures, fittings, fixtures, fittings, services etc. CONTRACTOR to site check all dimensions and exact locations of all items. JMG accepts no responsibility for dimensional information scaled or digitally derived from this document.

PLOT DETAILS	J230352CS-A-NOTES.DWG
PROJECT NO.	230352CS
DWG NO.	REVISION
C01	BA1

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GENERAL

G1 IN THESE NOTES, APPROVED, DIRECTED, REQUIRED, REJECTED & SIMILAR EXPRESSIONS, SHALL MEAN APPROVED, DIRECTED, REQUIRED, REJECTED AND THE LIKE BY THE SUPERINTENDENT THROUGH THE CONTRACTOR.

G2 READ THIS DRAWING IN CONJUNCTION WITH ARCHITECTS AND OTHER DRAWINGS AND SPECIFICATIONS AND WITH SUCH OTHER WRITTEN INSTRUCTION THAT MAY BE ISSUED.

G3 BUILDING SET-OUT AND DIMENSIONS ARE DETERMINED BY THE ARCHITECT. DIMENSIONS EXPRESSED IN MILLIMETERS. UNO. DIMENSIONS SHALL NOT BE OBTAINED BY SCALING THESE DRAWINGS. SETTING OUT DIMENSIONS SHALL BE VERIFIED BEFORE COMMENCING WORK. ANY DISCREPANCIES BETWEEN THESE DRAWINGS AND THE ARCHITECT'S OR OTHER DRAWINGS IS TO BE ADVISED BEFORE PROCEEDING WITH THE WORK.

G4 DURING CONSTRUCTION THE STRUCTURE SHALL BE MAINTAINED IN A STABLE CONDITION & NO PART SHALL BE OVERSTRESSED.

G5 24 HOURS NOTICE REQUIRED FOR WORK REQUIRING INSPECTION.

G6 THE STRUCTURAL WORK SHOWN ON THESE DRAWINGS HAS BEEN DESIGNED IN ACCORDANCE WITH THE NCC & TO THE FOLLOWING CRITERIA:

IMPORTANCE LEVEL : - IL1
DESIGN LIFE: -100 YEARS

DESIGN EVENT APE	SERVICEABILITY	ULTIMATE
WIND	1/25	1/500

G7 THE STRUCTURAL WORK SHOWN ON THESE DRAWINGS HAS BEEN DESIGNED ACCORDING TO AS 1170.2 FOR A REGIONAL WIND SPEED OF 48m/s IN TERRAIN CATEGORY 2.5 SHELTERED & FOR THE FOLLOWING LIVE LOADS:

SLAB: 14 TONNE EXCAVATOR

WALL SURCHARGE: 5kPa

G8 WORK HEALTH & SAFETY NOTICE:
JMG HAVE CONSIDERED THE HAZARDS AND RISKS ASSOCIATED WITH THE CONSTRUCTION, OPERATION, MAINTENANCE AND EVENTUAL DEMOLITION OF THIS PROJECT. THERE ARE A NUMBER OF HAZARDS AND HENCE RISKS WHICH ARE NOT UNIQUE TO THIS PROJECT WHICH NEED TO BE MANAGED DURING THESE PHASES. JMG REMIND CONSTRUCTORS, OPERATORS, MAINTAINERS AND DEMOLISHERS OF THEIR RESPONSIBILITIES UNDER WORK HEALTH & SAFETY ACTS AND REGULATIONS. THE FOLLOWING RISKS HAVE BEEN IDENTIFIED WHICH ARE UNIQUE TO THIS PROJECT:

- NIL

FOUNDATION:

F1 FOUNDING DEPTHS ARE REDUCED LEVELS TO UNDERSIDE OF FOOTINGS SHOWN ON DRAWINGS ARE FOR TENDERING PURPOSES. EXCAVATE THROUGH FILL AS REQUIRED TO PLACE FOOTINGS ACCORDINGLY. ALL EXCAVATIONS SHALL BE APPROVED BEFORE PLACEMENT OF STRUCTURAL FILL, HARDCORE, BLINDING AND/OR REINFORCEMENT.

F2 FOUNDATION MATERIAL SHALL HAVE A UNIFORM BEARING CAPACITY OF 200 kPa MINIMUM.

F3 BASES OF FOOTINGS SHALL BE HORIZONTAL, UNO.

F4 EXCESS DEPTHS AND WIDTHS IN FOUNDATIONS TO THOSE SPECIFIED SHALL BE FILLED WITH MINIMUM A.S. GRADE 15 CONCRETE. THE CONCRETE FILL SHALL NOT BE BONDED TO THE CONCRETE UNLESS APPROVED. THE COST OF FILLING SHALL BE BORNE BY THE CONTRACTOR.

F5 WHERE DETAILED ON THESE DRAWINGS & WHEREVER GROUND WATER IS ENCOUNTERED PROVIDE 50 CONCRETE BLINDING IMMEDIATELY AFTER APPROVAL OF FOUNDATION.

SLABS ON GRADE:

SG1 SUB-BASE PREPARATION
THE SUB-BASE FOR SLABS ON GRADE SHALL BE PREPARED AS FOLLOWS:

- STRIP OFF ALL VEGETATED TOPSOIL AND CUT TO REQUIRED LEVEL. 300 MIN. BELOW ESL (SUBJECT TO FINAL SITE CHECK)
- PROOF ROLL SUB-BASE TO STANDARD SPECIFIED.
- WHERE SUB-BASE DISTURBED FOR EXCAVATIONS, FILL WITH STRUCTURAL FILL TYPE A OR B THOROUGHLY COMPACTED IN 150 MAXIMUM LAYERS.

SG2 BASE PREPARATION
THE BASE FOR SLABS ON GRADE SHALL BE PREPARED AS DETAILED AND AS FOLLOWS:

- FILL WITH STRUCTURAL FILL TYPE A COMPACTED AND WATERED TO 150 MIN. FINISHED THICKNESS. ADDITIONAL FILL REQUIRED BELOW THIS LAYER SHALL BE TYPE A OR B STRUCTURAL FILL COMPACTED AND WATERED, PLACED IN LAYERS NOT EXCEEDING 200 FINISHED THICKNESS. ROLL INTO SUBGRADE WITH 10t STATIC DRUM.
- COMPACTION TO MINIMUM 95% STANDARD COMPACTION TO AS 1289 U.N.O.
- PLACE 25 MAX. SAND BLINDING WATERED & COMPACTED, UNDER ENTIRE SLAB AND SLAB THICKENINGS.
- LAY 0.2mm FORTICON MEMBRANE. TAPE ALL JOINTS AND SEAL ALL PENETRATIONS. PLACE UNDER ENTIRE SLAB INCLUDING SLAB THICKENINGS & INTEGRAL FOOTINGS. TURN UP AT OUTSIDE EDGES.

SG3 STRUCTURAL FILL
STRUCTURAL FILL SHALL BE AS FOLLOWS:

- TYPE A - 20 FINE CRUSHED ROCK
- TYPE B - 40+ FINE CRUSHED ROCK
- TYPE C - 150/200 NOMINAL SIZE DOLERITE SPALLS IN 2

LAYERS.
EXCAVATED MATERIAL NOT TO BE USED WITHOUT APPROVAL.

RETAINING WALL NOTES - REINFORCED MASONRY OR CONCRETE:

RW1 ALL WORK TO BE IN ACCORDANCE WITH THE RELEVANT SAA CODE.

RW2 CONCRETE STRENGTH FOR FOOTINGS 25MPa.

RW3 COVER TO REINFORCEMENT
- 50mm FOOTINGS BOTTOM
- 30mm FOOTINGS TOP
- 55mm WALLS FROM BACKFILL FACE

RW4 CLAY MATERIAL SHALL NOT BE USED AS BACKFILL BEHIND WALLS.

RW5 THE REAR OF THE WALL SHALL BE DRAINED WITH AG DRAINS. PROVIDE 300mm MIN. WIDTH LAYER OF 25mm CRUSHED ROCK BEHIND WALL.

RW6 DO NOT BACKFILL BEHIND WALL UNTIL GROUT OR CONCRETE HAS CURED FOR AT LEAST 14 DAYS.

RW7 PROVIDE BLOCK BREAKS IN BOTTOM COURSE OF MASONRY WALL TO ALLOW CLEAN OUT OF MORTAR DROPPINGS AND TYING OF REINFORCEMENT. FORM UP TO GROUT.

CONCRETE:

C1 WORKMANSHIP, MATERIALS & DESIGN SHALL BE IN ACCORDANCE WITH AS 3600 & ASSOCIATED CODES LISTED THEREIN AND THE SPECIFICATION.

C2 CONCRETE PROPERTIES SHALL BE AS FOLLOWS. REFERENCE TO BE MADE TO THE SPECIFICATION FOR OTHER REQUIREMENTS. SUPPLIER TO DESIGN MIX TO ACHIEVE THESE REQUIRED PROPERTIES. MOIST CURE FOR 3 DAYS MIN. AFTER POUR.

CONCRETE MIX DETAILS						
ELEMENT & LOCATION	A.S. GRADE MPa	MAX. SLUMP	MAX. W/C RATIO	MIN. CEMENT CONT. Kg/m	TOTAL AIR CONT. % VOL.	OTHER MIX CRITERIA
SLABS AND STRUCTURAL CONCRETE	S25 N32	60	0.65	260	4-8	NIL CaCl ₂
FOOTINGS AND MINOR WORKS	N25	60	0.65	260	4-8	NIL CaCl ₂

C3 BEAM DEPTHS ARE WRITTEN FIRST UNO AND INCLUDE SLAB THICKNESS IF ANY.

C4 NO HOLES OR CHASES OTHER THAN THOSE SHOWN SHALL BE MADE WITHOUT APPROVAL.

C5 DO NOT PLACE CONDUITS, PIPES AND THE LIKE WITHIN CONCRETE COVER.

C6 SLABS AND BEAMS ARE TO BE POURED TOGETHER UNLESS NOTED OTHERWISE.

C7 WHERE REINFORCEMENT IS CONTINUOUS THROUGH A POUR BREAK, SCABBLE, REMOVE ALL LOOSE MATERIAL AND DAMPEN THE OLD FACE BEFORE POURING AGAINST IT.

C8 THE USE OF BLENDED CEMENTS, FLY ASH AND OR CHEMICAL AD-MIXTURES SHALL NOT BE PERMITTED WITHOUT WRITTEN APPROVAL.

C9 UNFORMED EXPOSED CONCRETE SURFACES SHALL HAVE AN APPROVED STEEL TROWELLED FINISH UNLESS SHOWN OTHERWISE.

C10 REINFORCEMENT IS REPRESENTED DIAGRAMMATICALLY AND NOT NECESSARILY IN TRUE PROJECTION.

C11 SPLICES IN REINFORCEMENT SHALL BE MADE ONLY AT LOCATIONS AND TO DETAILS SHOWN ON STRUCTURAL DRAWINGS UNLESS APPROVED OTHERWISE.

C12 CONCRETE COVER TO REINFORCEMENT (INCLUDING LIGS) SHALL BE AS FOLLOWS, UNLESS OTHERWISE SHOWN. 60 MIN. FIRE RESISTANCE PERIOD ASSUMED.

EXPOSURE ENVIRONMENT	A.S. 3600 CAT.	ELEMENT	#	CONCRETE AS GRADE	COVER B/T
BELOW GROUND	A2	FOOTINGS	1	25	50
		FOOTINGS	2	25	50
BUILDING EXTERNAL	B1	SLAB	2	32	40

#1 = CAST AGAINST GROUND
#2 = CAST AGAINST FORMWORK
#3 = CAST AGAINST FORTICON MEMBRANE

C13 REINFORCEMENT SHALL NOT BE CUT, WELDED, BENT OR HEATED ON SITE, NOR FITMENT OR SLAB STEEL BE DISPLACED MORE THAN 0.25 TIMES THE NOMINAL SPACING WITHOUT PRIOR APPROVAL.

C14 PLACE INDIVIDUAL BAR CHAIRS AT THE RATE OF 25 PER 10m² OF BOTTOM & TOP SLAB REINFORCEMENT AREA (750 CRS. APPROX) AND AS REQUIRED FOR ADEQUATE SUPPORT IN OTHER MEMBERS. ALL CHAIRS SUPPORTED ON APPROVED TYPE PLATES.

C15 REINFORCEMENT SHALL BE SECURELY WIRED IN PLACE WITHOUT WELDING, UNLESS APPROVED OTHERWISE.

C16 FABRIC SHALL BE RANDOM LAPPED WITH NO MORE THAN TWO SHEETS NESTED TOGETHER. USE ALTERNATIVE DETAIL AS REQUIRED. WHERE FABRIC ORIENTATION IS SHOWN, THIS BAR IS TO BE PLACED WITH MINIMUM COVER TO CONCRETE FACE. (ALTERNATIVE SHEETS WHERE FABRIC NESTED)

END LAP

TYPICAL DETAIL

ALTERNATIVE DETAIL

END LAPS NOT PERMITTED WITH ONE WAY FABRICS ABOVE RL818. END LAP WITH SPLICE BAR AT FOLLOWING CENTRES:
UP TO SL82 N12 @ 400 CRS.
SL92 N12 @ 300 CRS.
SL81 N12 @ 200 CRS.

SIDE LAP

TYPICAL DETAIL

ALTERNATIVE DETAIL AS ABOVE

C17 MESH ORIENTATION FOR WALLS - HORIZONTAL BAR TO BE PLACED TO THE OUTER FACE UNLESS OTHERWISE NOTED. WHERE FABRIC PLACEMENT IS NOT PRACTICAL REPLACE WITH N12@200 EW.

C18 REINFORCEMENT SYMBOLS AND GRADES:


R - DENOTES STRUCTURAL GRADE PLAIN ROUND (GRADE 250R)
N - DENOTES HOT ROLLED DEFORMED BAR (GRADE D500N) TO A.S. 4671
SL - DENOTES RIBBED REINFORCING FABRIC (GRADE D500L) TO A.S. 4671
W - DENOTES HARD-DRAWN PLAIN WIRE (GRADE D500L) TO A.S. 1303.

C19 TRIMMING STEEL NOT DESIGNATED SHALL BE:

ELEMENT	LOCATION	TRIMMING REINFORCEMENT	EXTEND BEYOND CROSS OVER POINT
SLABS	-INTERNAL CORNERS -PENETRATIONS -SETDOWNS >25 DEEP	2/N16 EW TOP AT CORNERS	800

C20 MASONRY OR CONCRETE WALLS OR SIMILAR ELEMENTS MUST NOT BE BUILT ON CONCRETE SLABS OR BEAMS UNTIL FORMWORK AND PROPS SUPPORTING THE SAME HAVE BEEN REMOVED.

C21 FITMENTS:

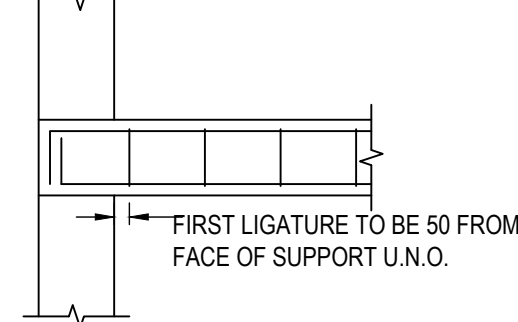

ABBREVIATIONS: (REFER A.S. C21 PART 2)

BOTTOM BRICK/BLOCK CONTROL JOINT
CAST IN PLATE
CONSTRUCTION JOINT
CONTINUOUS FILLET WELD
CONTROL JOINT
DIAMETER
EACH FACE
EACH WAY
EXISTING SURFACE LEVEL
EXPANSION JOINT
FAR FACE
FINISHED FLOOR LEVEL
FULL STRENGTH BUTT WELD
FINISHED SURFACE LEVEL
GALVANISED
GROUND SURFACE LEVEL AS CUT
KLOPASCAL
LIVE LOAD
MEGAPASCAL
NEAR FACE
REDUCED LEVEL
TOP AND BOTTOM
UNLESS NOTED OTHERWISE

BOT
BCJ
CJP
CJ
CFW
CONT J
DIA (OR Ø)
EF
EW
ESL
EJ
FF
FFL
FSBW
FSL
GALV
GSL
kPa
LL
MPa
NF
RL
T&B
UNO

STEELWORK:

S1 WORKMANSHIP, MATERIALS AND DESIGN SHALL BE IN ACCORDANCE WITH A.S. 4100, ASSOCIATED CODES LISTED THEREIN AND THE SPECIFICATION.

S2 UNLESS NOTED OTHERWISE STEEL ELEMENTS SHALL BE OF THE FOLLOWING GRADES:
GENERAL SECTIONS - BHP 300+ (UB/UC/PFC/LARGE ANGLES)
- GRADE 250 TO AS 3678/3679

(OTHER SECTIONS)
RHS & SHS - GRADE 350 TO AS 1163
CHS <= 890 - GRADE 250 TO AS 1163
CHS >= 890 - GRADE 350 TO AS 1163
PURLINS & GIRTS - GRADE C450-Z200 TO AS 1397
DURAGAL - GRADE C450LO TO AS 1163

S3 REFER TO ARCHITECT'S OR OTHER DRAWINGS FOR LINTELS, CLEATS AND MEMBERS NOT SPECIFICALLY SHOWN ON THESE DRAWINGS.

S4 BOLTING PROCEDURES ARE IDENTIFIED AS FOLLOWS:

BOLTING PROCEDURE	GRADE MPa	BOLT TO A.S.	METHOD OF INSTALLATION	NOTES
4.6/s	4.6	AS 1111	SNUG TIGHTENED	
8.8/s	8.8	AS 1252	SNUG TIGHTENED	
8.8/TF	8.8	AS 1252	FULLY TENSIONED LOAD INDICATOR WASHERS.	FRICTION TYPE JOINT
8.8/TB	8.8	AS 1252	FULLY TENSIONED LOAD INDICATOR WASHERS.	BEARING TYPE JOINT

ALL BOLTS TO BE OF SUCH LENGTH THAT AT LEAST ONE FULL THREAD IS EXPOSED BEYOND THE NUT AFTER THE NUT HAS BEEN TIGHTENED.

S5 UNLESS NOTED OTHERWISE, CONNECTIONS SHALL BE AS FOLLOWS:

CONNECTION LOCATION	BOLT NO. &/OR SIZE	PROCEDURE	CLEAT THICKNESS	NOTES
GENERAL MEMBERS	<200 MAX DIM 2/M16	4.6/s	8	WASHER UNDER ROTATING PART
	>200 2/M20	8.8/s	10	
PURLINS & GIRTS	2/M12	4.6/s	8	GALVANISED BOLTS
ROD BRACING	2 NUTS AS SPECIFIED AS LOCK NUTS EACH END	4.6/s	AS DETAILED	HALF MOON WASHER EACH END
HD BOLTS	AS DETAILED	4.6/s	AS DETAILED	50x50x6 WASHER UNDER NUT

NOTE: ALL BOLTS TO BE HOT DIP GALV. U.N.O.

S6 PURLINS SHALL BE SUPPLIED AS SPECIFIED WITH BRIDGING AND TIES TO MANUFACTURER'S SPECIFICATION OR 3000 MAXIMUM UNSUPPORTED LENGTH U.N.O. SUBSTITUTION SHALL NOT BE MADE UNLESS APPROVED.

S7 WELDING CATEGORIES SHALL BE AS FOLLOWS:
UNLESS NOTED OTHERWISE SP TO A.S. 1554
PURLIN AND GIRT CLEATS SP TO A.S. 1554

S8 UNLESS NOTED OTHERWISE ALL FILLET WELDS SHALL BE 6mm CONTINUOUS FILLET WELDS, SP CATEGORY.

S9 ALL BUTT WELDS SHALL BE PRE-QUALIFIED COMPLETE PENETRATION SP CATEGORY AND SHALL UTILISE "RUN-ON RUN-OFF" PLATES.

S10 ELECTRODES SHALL BE:
E41xx OR E48xx TO A.S. 1553 FOR MMAW
W500 TO A.S. 2717 FOR GMAW
W500 TO A.S. 2203 FOR FCAW
W500 TO A.S. 1858 FOR SAW

S11 GROUT UNDER BASE PLATES SHALL BE 2:1 SAND/CEMENT MORTAR MIXED NEARLY DRY AND RAMMED HARD MINIMUM 20 THICK. ALTERNATIVELY USE MASTER BUILDER'S MASTERFLOW TYPE 870A CEMENT GROUT (FLOWABLE GRADE) 20 THICK.

S12 SUSPENDED CEILINGS, AIR CONDITIONING UNITS, DUCTWORK AND SUSPENDED PIPEWORK MUST BE SUITABLY SUPPORTED FROM THE WEB OF PURLINS. SUPPORT FROM THE FLANGE OF PURLINS SHALL NOT BE PERMITTED. LOADS FROM HEAVIER UNITS OR PLANT MUST BE SUITABLY DISTRIBUTED BETWEEN THREE (3) PURLINS.

S13 PREPARE AND PRIME PAINT STEEL AS FOLLOWS:

- INTERNAL STEELWORK
 - PREPARATION - AS 1627.4 CLASS 1
 - PRIME COAT - 50 MICRONS OF ZINC PHOSPHATE
- EXTERNAL STEELWORK
 - PREPARATION - AS 1627.4 CLASS 2.5
 - PRIME COAT - 75 MICRONS OF INORGANIC ZINC
 - ALL COATING TO BE FROM THE SAME MANUFACTURER AND SUBJECT TO ARCHITECT/ENGINEER APPROVAL

S14 STEELWORK TO BE HOT DIP GALVANISED IS AS DESCRIBED OR NOTED AS (GALV) ON THE PROJECT DRAWINGS. PREPARE TO CLASS 2 / AS 1627.4. MAKE GOOD DAMAGE TO GALVANISING WITH "DIMET GALVANITE" UNLESS NOTED OTHERWISE. REFER TO SPECIFICATION FOR BARRIER AND/OR FINISH COATS.

SUSPENDED SLABS ON FILL:

SS1 GENERAL
WHERE SHOWN ON THE PROJECT DRAWINGS USE FILL AS FORMWORK ONLY FOR SUSPENDED SLABS. FILL TO BE PLACED SO AS TO ADEQUATELY SUPPORT CONCRETE UNTIL HARDENED AND SHALL BE FREE OF CONSPICUOUS CLAY CONTENT - USE COAL ASH.

SS2 SUB-BASE PREPARATION
STRIP OFF VEGETATION AND CUT TO REQUIRED LEVEL. PROOF ROLL SUB-BASE AS NOTED IN SPECIFICATION BEFORE PLACING FILL, SAND LAYER, AND FORTICON.


SS3 BASE PREPARATION
THE BASE FOR SUSPENDED SLABS ON FILL SHALL BE AS FOLLOWS:

- FILL AS NOTED IN SECTION SS1
- PLACE SAND LAYER & FORTICON AS NOTED IN SECTION SG2.

LEGEND

SEWER MAIN
SEWER MANHOLE
STORMWATER MAIN
STORMWATER MANHOLE
STORMWATER SIDE ENTRY PIT
WATER MAIN
STOP VALVE
FIRE HYDRANT
PROPERTY WATER CONNECTION
TELSTRA
UNDERGROUND ELEC.
TELSTRA PIT
ELECTRICITY TURRET
LIGHT POLE
LETTERBOX
PROPERTY BOUNDARY
EXISTING FENCE
ASPHALT DRIVEWAY TO DETAIL
CONCRETE LINED SPILLWAY TO DETAIL
NATURAL FLOOR LEVELS

DESIGN FLOOR LEVELS

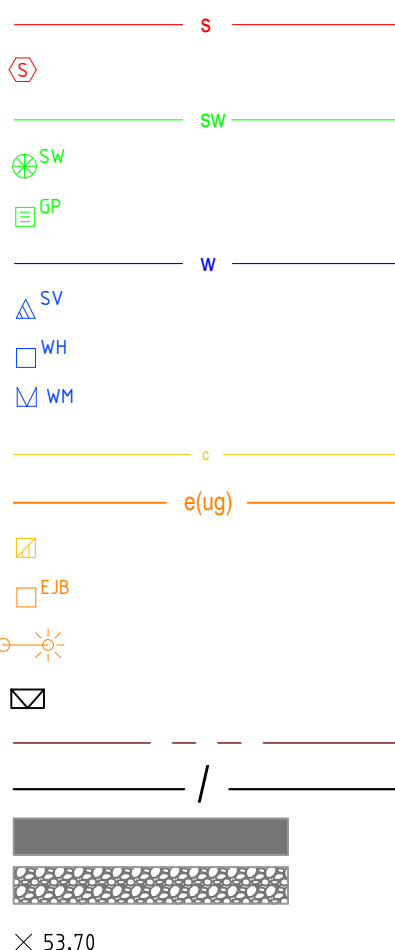

× 53.70

+ 53.84

GLENORCHY CITY COUNCIL
PLANNING SERVICES

APPLICATION No PLN-24-181

DATE RECEIVED 30 April 2025

119.03.2025 REVISED BUILDING APPROVAL
BA 22.05.2024 BUILDING APPROVAL ISSUE
P4 08.03.2024 CLIENT REVIEW ISSUE
P5 04.03.2024 REVISED PRELIMINARY ISSUE
P2 20/09/2023 ISSUED FOR TW COMMENTS
REV 1 25/08/2023 PRELIMINARY ISSUE
REV DATE REMARK

The following table which are unique to this design have been identified:		NIL
This report does not release contractors from their responsibilities under the Act to identify, report, mitigate and manage all aspects of risk and safety.		

JMG
JOHNSTONE McGEE & GANDY PTY LTD

117 Harrington Street, Hobart TAS (03) 6331 2555
49-51 Elizabeth Street, Launceston TAS (03) 6334 5548
www.jmg.net.au info@jmg.net.au info@jmg.net.au

PROJECT
GLENORCHY CITY COUNCIL,
REDLANDS DRIVE ROSETTA
DEBRIS BASIN

TITLE
NOTES SHEET 2

Accepted MJR (Discipline Head)	Date 19.03.2025
Accepted MJR (Team Leader)	Date 19.03.2025
Approved CUM (Principal)	Date 19.03.2025

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NA	MJR	TCM
	PLOT DATE	19/03/2025

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PLOT DETAILS J230352CS-A-NOTES.DWG

PROJECT NO. 230352CS

DWG NO. C02 REVISION BA1

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BA2	15.04.2025	REVISED SCOUR LOCATION
BA1	19.03.2025	REVISED BUILDING APPROVAL
BA	22.05.2024	BUILDING APPROVAL ISSUE
P4	08.03.2024	CLIENT REVIEW ISSUE
P3	06/12/2023	RETAINING WALL OPTION
P2	20/09/2023	ISSUED FOR TW COMMENTS
P1	25/08/2023	PRELIMINARY ISSUE
REV	DATE	REMARK

SAFETY IN DESIGN REPORT PER WHS REGULATIONS	
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49-51 Elizabeth Street, Launceston TAS (03) 6334 6548
www.jmg.net.au infohbt@jmg.net.au infofn@jmg.net.au

PROJECT
GLENORCHY CITY COUNCIL,
REDLANDS DRIVE ROSETTA
DEBRIS BASIN

TITLE
GENERAL ARRANGEMENT

Accepted MJR (Discipline Head)		Date 15/04/2025
Accepted MJR (Team Leader)		Date 15/04/2025
Approved CJM (Principal)		Date 15/04/2025

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1:100	MJR	TCM
	PLOT DATE	16/04/2025

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PLOT DETAILS J230352CS-B-PLANS.DWG

PROJECT NO. 230352CS

DWG NO. C03	REVISION BA2
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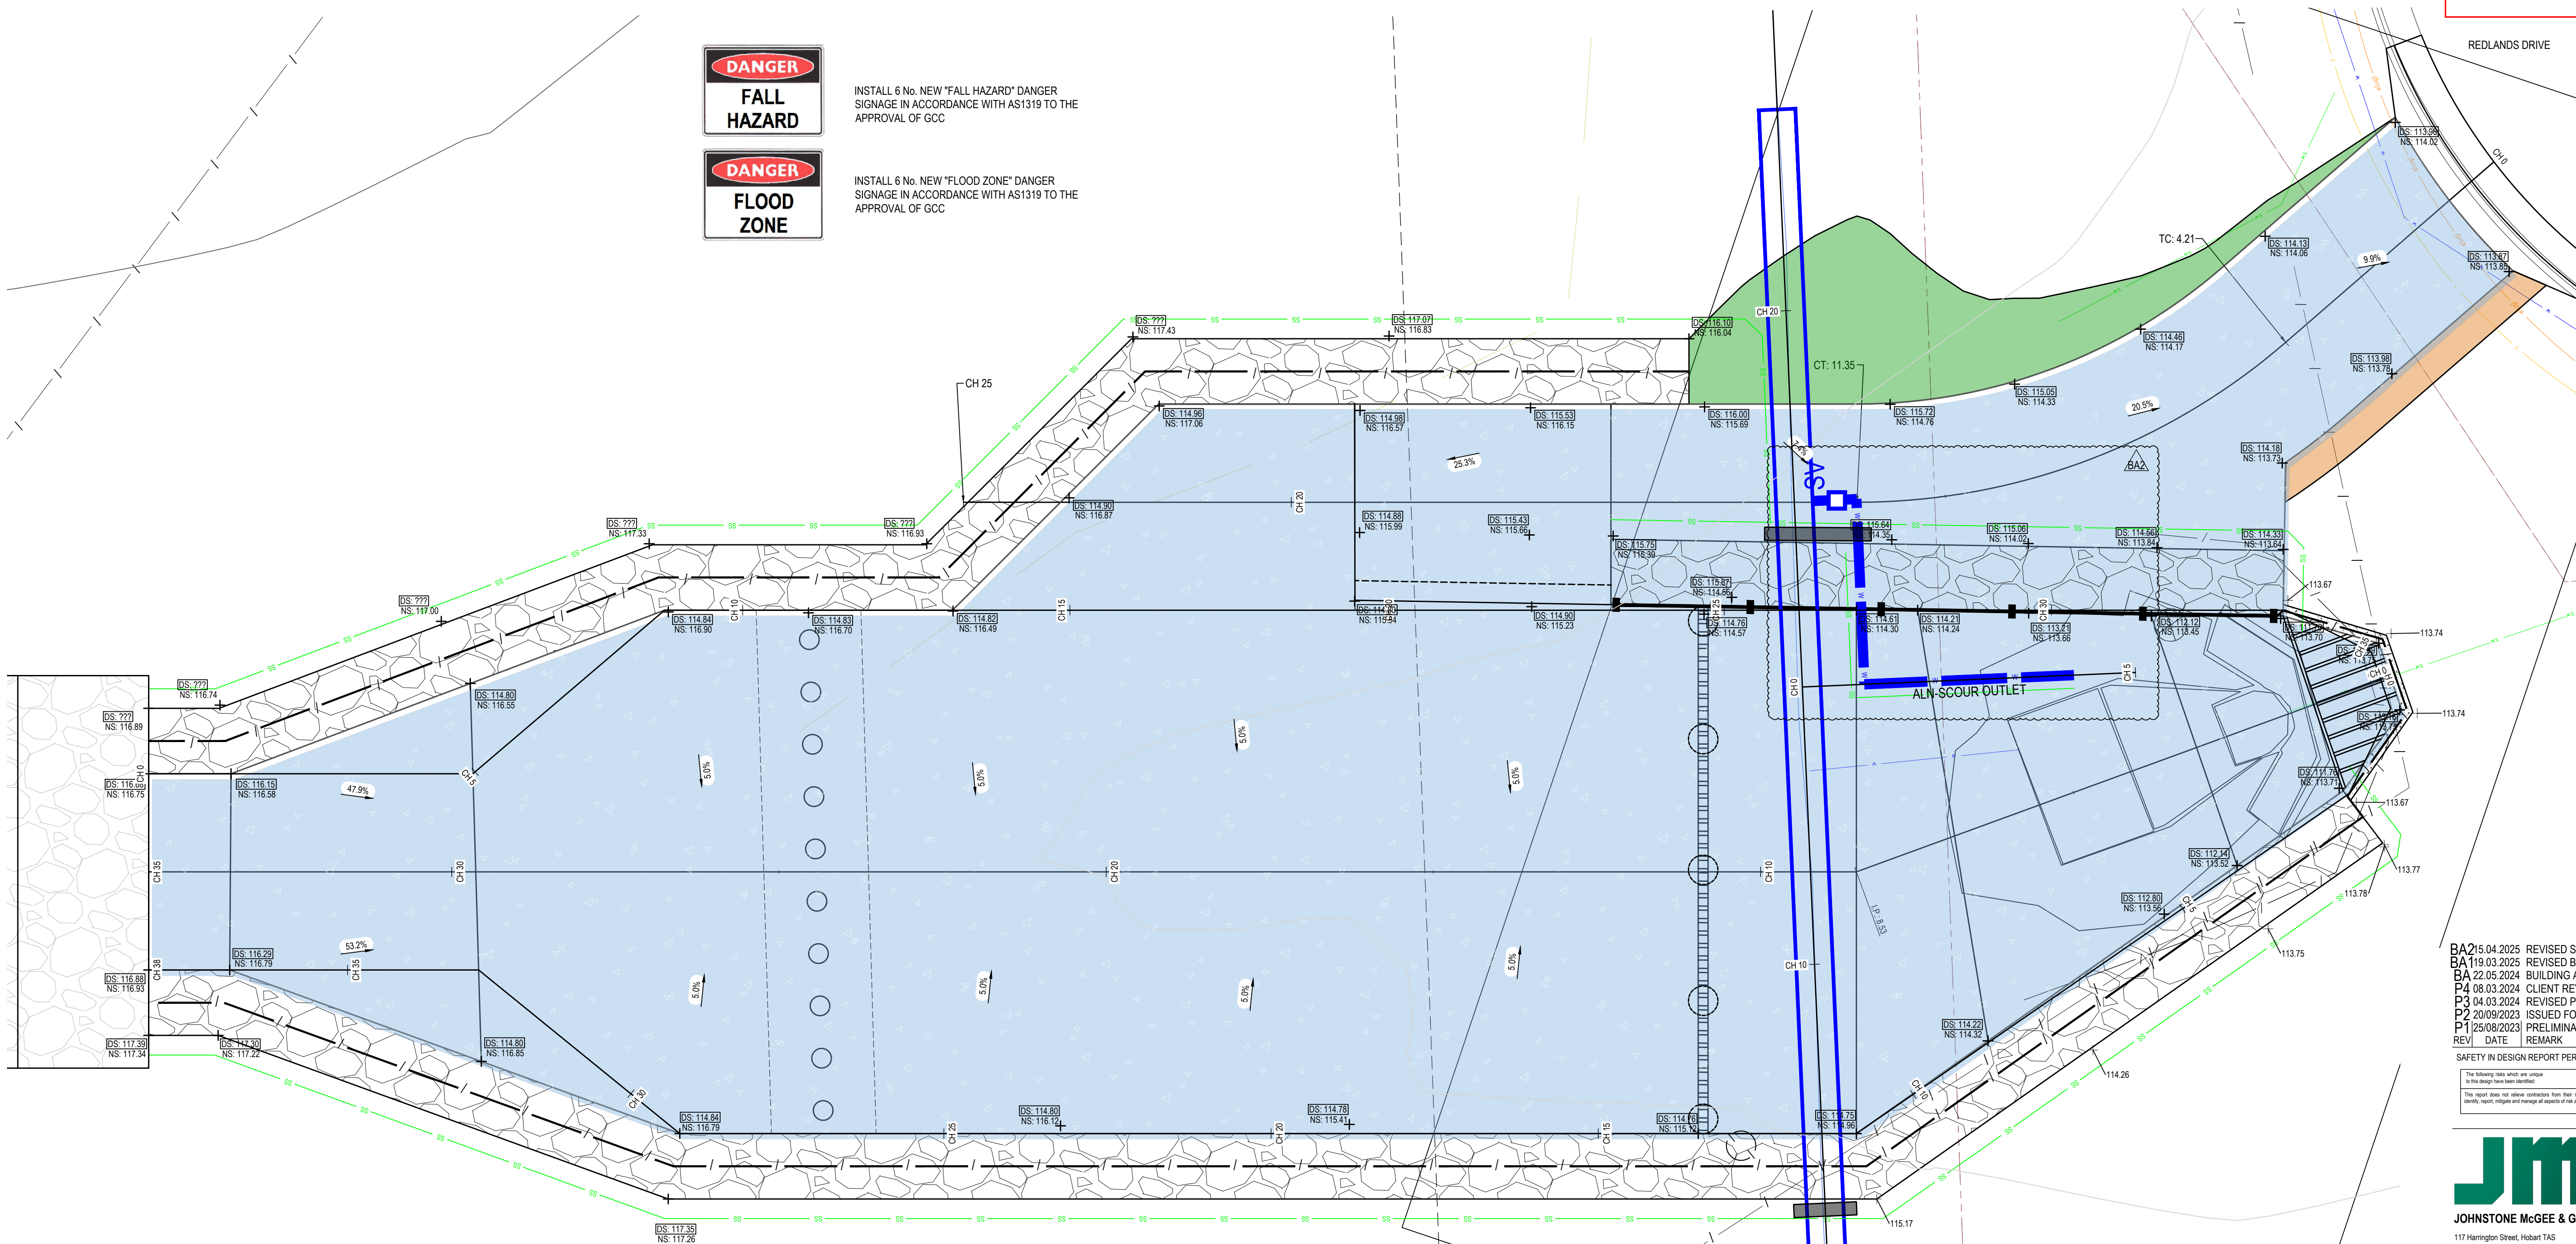
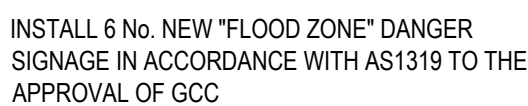
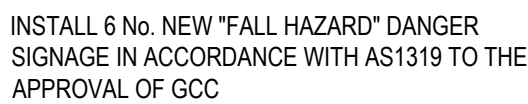
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WARNING - BEWARE OF UNDERGROUND SERVICES
THE LOCATION OF UNDERGROUND SERVICES ARE APPROXIMATE
ONLY AND THE EXACT POSITION SHOULD BE PROVEN ON SITE.
NO GUARANTEE IS GIVEN THAT ALL SERVICES ARE SHOWN.

**GLENORCHY CITY COUNCIL
PLANNING SERVICES**

APPLICATION No PLN-24-181

DATE RECEIVED 30 April 2025



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P2	20/09/2023	ISSUED FOR TW COMMENTS
P1	25/08/2023	PRELIMINARY ISSUE
REV	DATE	REMARK

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www.jmg.net.au infohbt@jmg.net.au infoaln@jmg.net.au

PROJECT
GLENORCHY CITY COUNCIL,
REDLANDS DRIVE ROSETTA
DEBRIS BASIN

TITLE
LEVELS AND ALIGNMENT
PLAN

Accepted MJR (Discipline Head)	<i>MJC</i>	Date 15/04/2025
Accepted MJR (Team Leader)	<i>MJC</i>	Date 15/04/2025
Approved CJM (Principal)	<i>CJM</i>	Date 15/04/2025

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1:100	MJR	TCM
	PLOT DATE	16/04/2025

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




PLOT DETAILS J230352CS-B-PLANS.DWG

PROJECT NO. 230352CS




DWG NO.	REVISION
C04	BA2

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	MASS CONCRETE RETAINING WALL TO DETAIL
	TOP SOIL AND SEED
	NEW CONCRETE BASIN SLAB AND ACCESS TO DETAIL
	VERGE
	MACCAFERRIE RENO MATTRESS

DEBRIS BASIN LEVELS & FINISHES PLAN
SCALE: 1:50



BA11	19.03.2025	REVISED BUILDING APPROVAL
BA22	05.2024	BUILDING APPROVAL ISSUE
P408	03.2024	CLIENT REVIEW ISSUE
P304	03.2024	REVISED PRELIMINARY ISSUE
P220	09/2023	ISSUED FOR TW COMMENTS
P125	08/2023	PRELIMINARY ISSUE
REV	DATE	REMARK

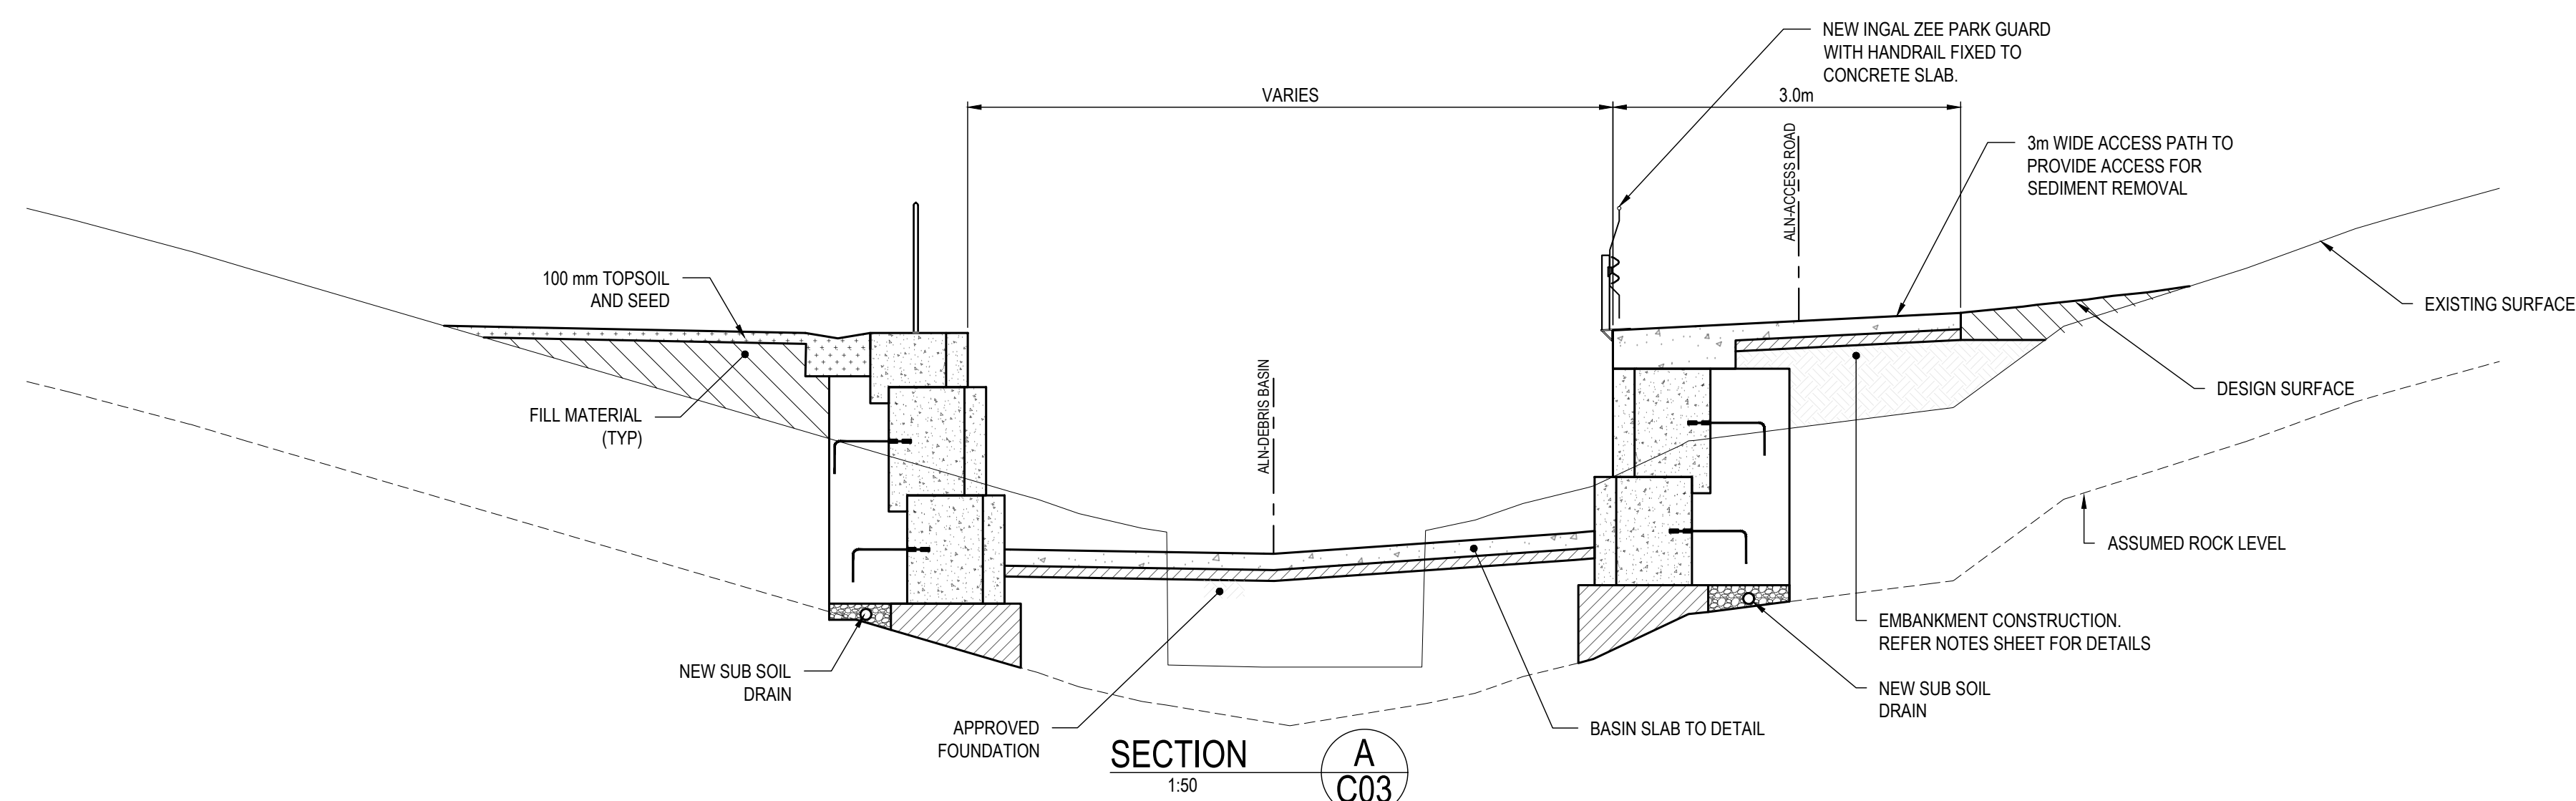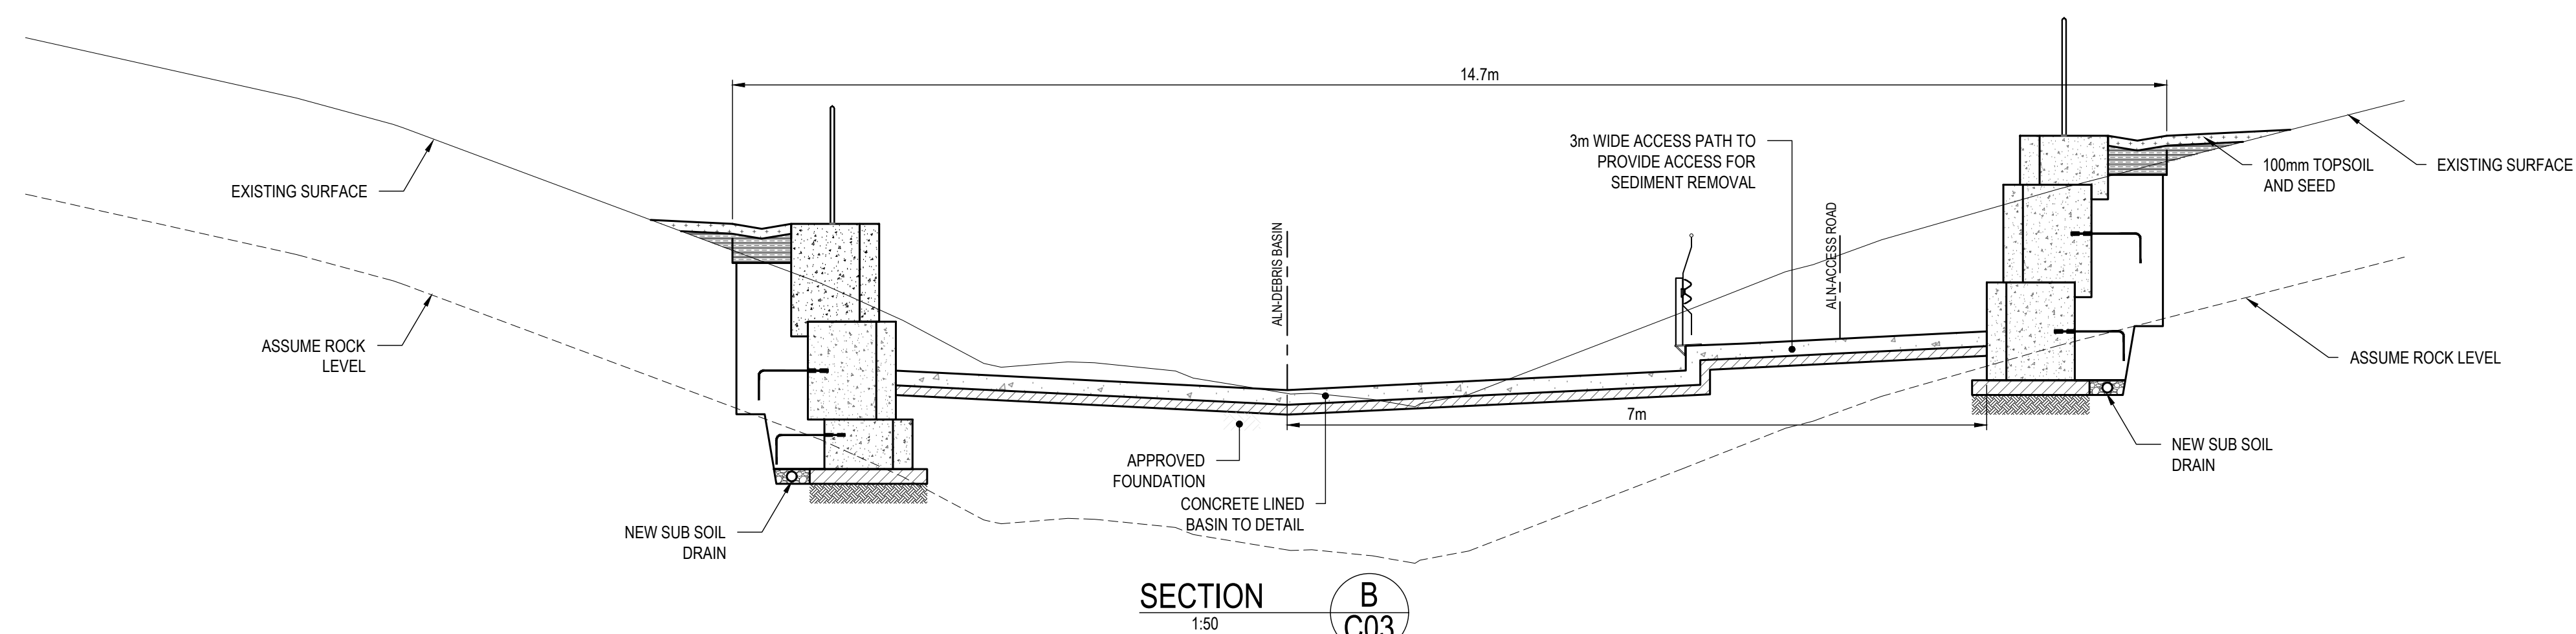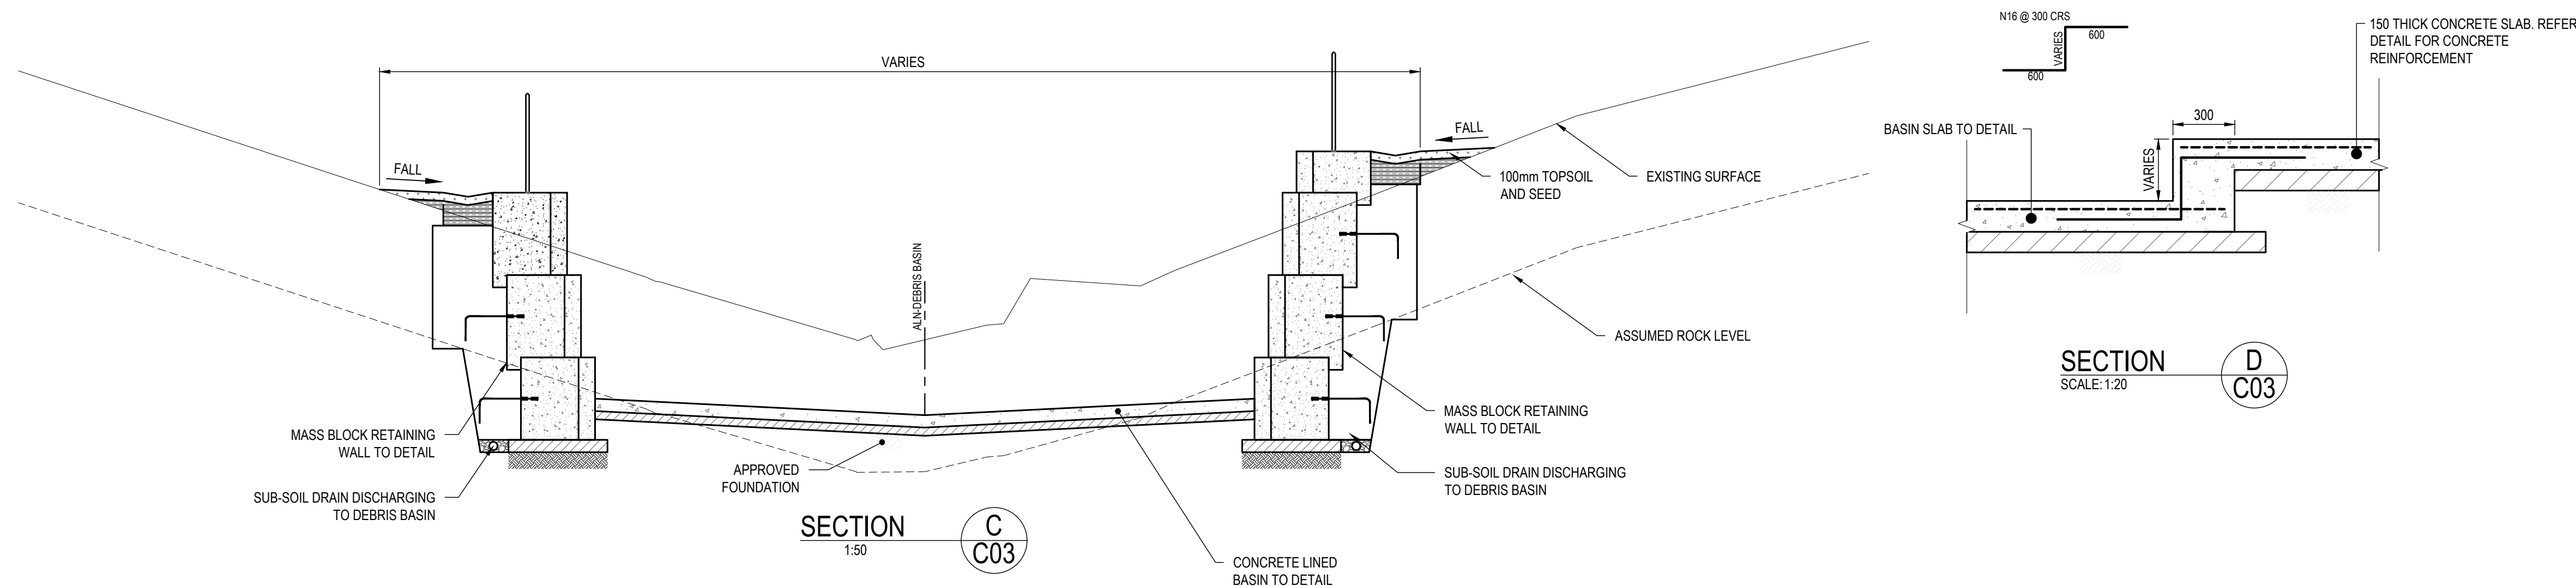SAFETY IN DESIGN REPORT PER WHS REGULATIONS	
The following risks which are unique to this design have been identified:	NL
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117 Harrington Street, Hobart TAS (03) 6231 2555
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www.jmg.net.au infohbt@jmg.net.au infohln@jmg.net.au

PROJECT
GLENORCHY CITY COUNCIL,
REDLANDS DRIVE ROSETTA
DEBRIS BASIN

TITLE
DEBRIS BASIN TYPICAL
DETAILS AND SECTIONS
SHEET 1

Accepted MJR (Discipline Head)		Date 19.03.2025
Accepted MJR (Team Leader)		Date 19.03.2025
Approved CJM (Principal)		Date 19.03.2025

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SCALES @ A1	DESIGNED BY	DRAWN BY
AS SHOWN	MJR	TCM
	PLOT DATE	19/03/2025

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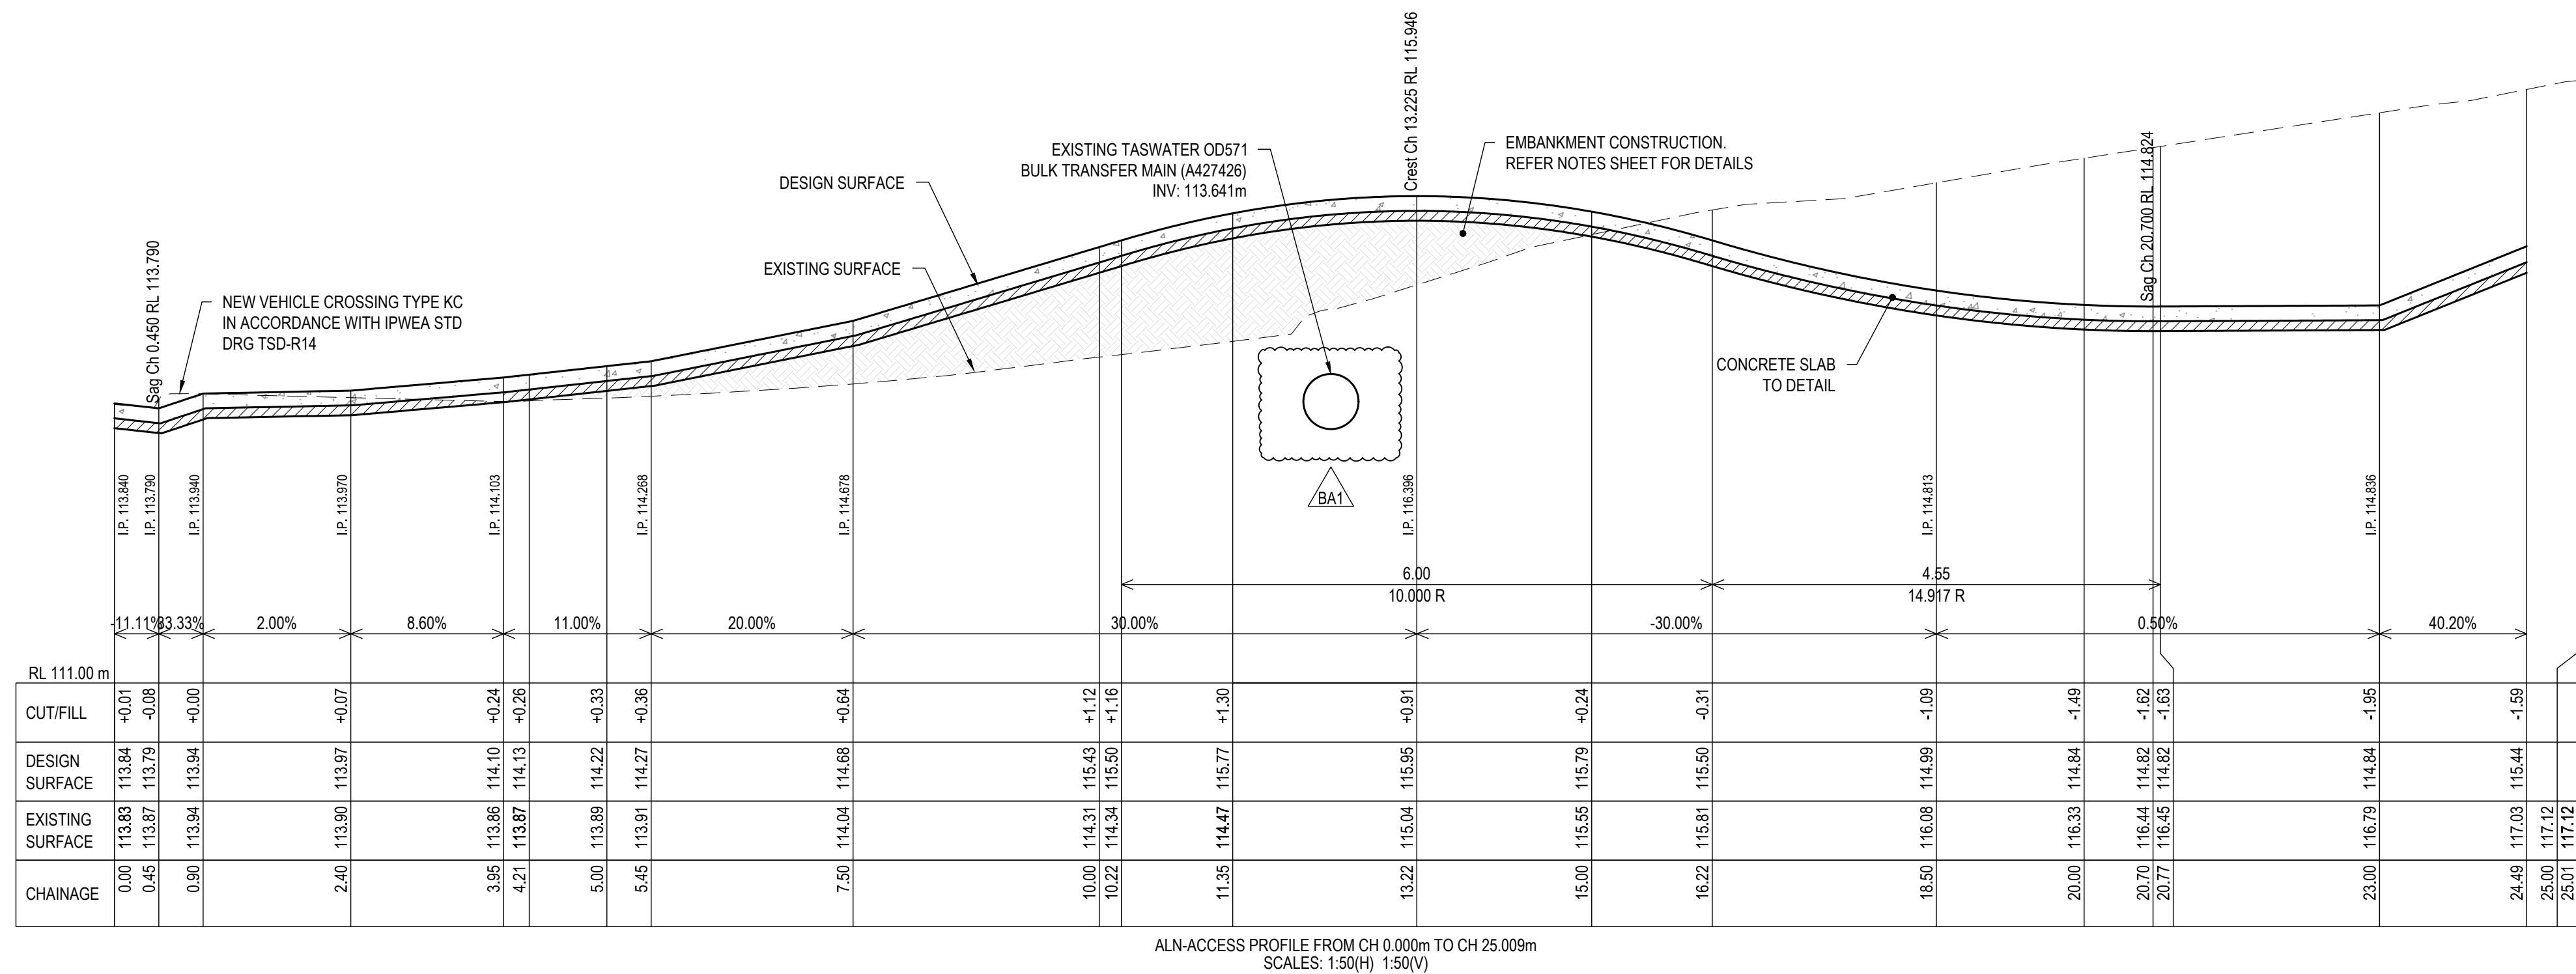
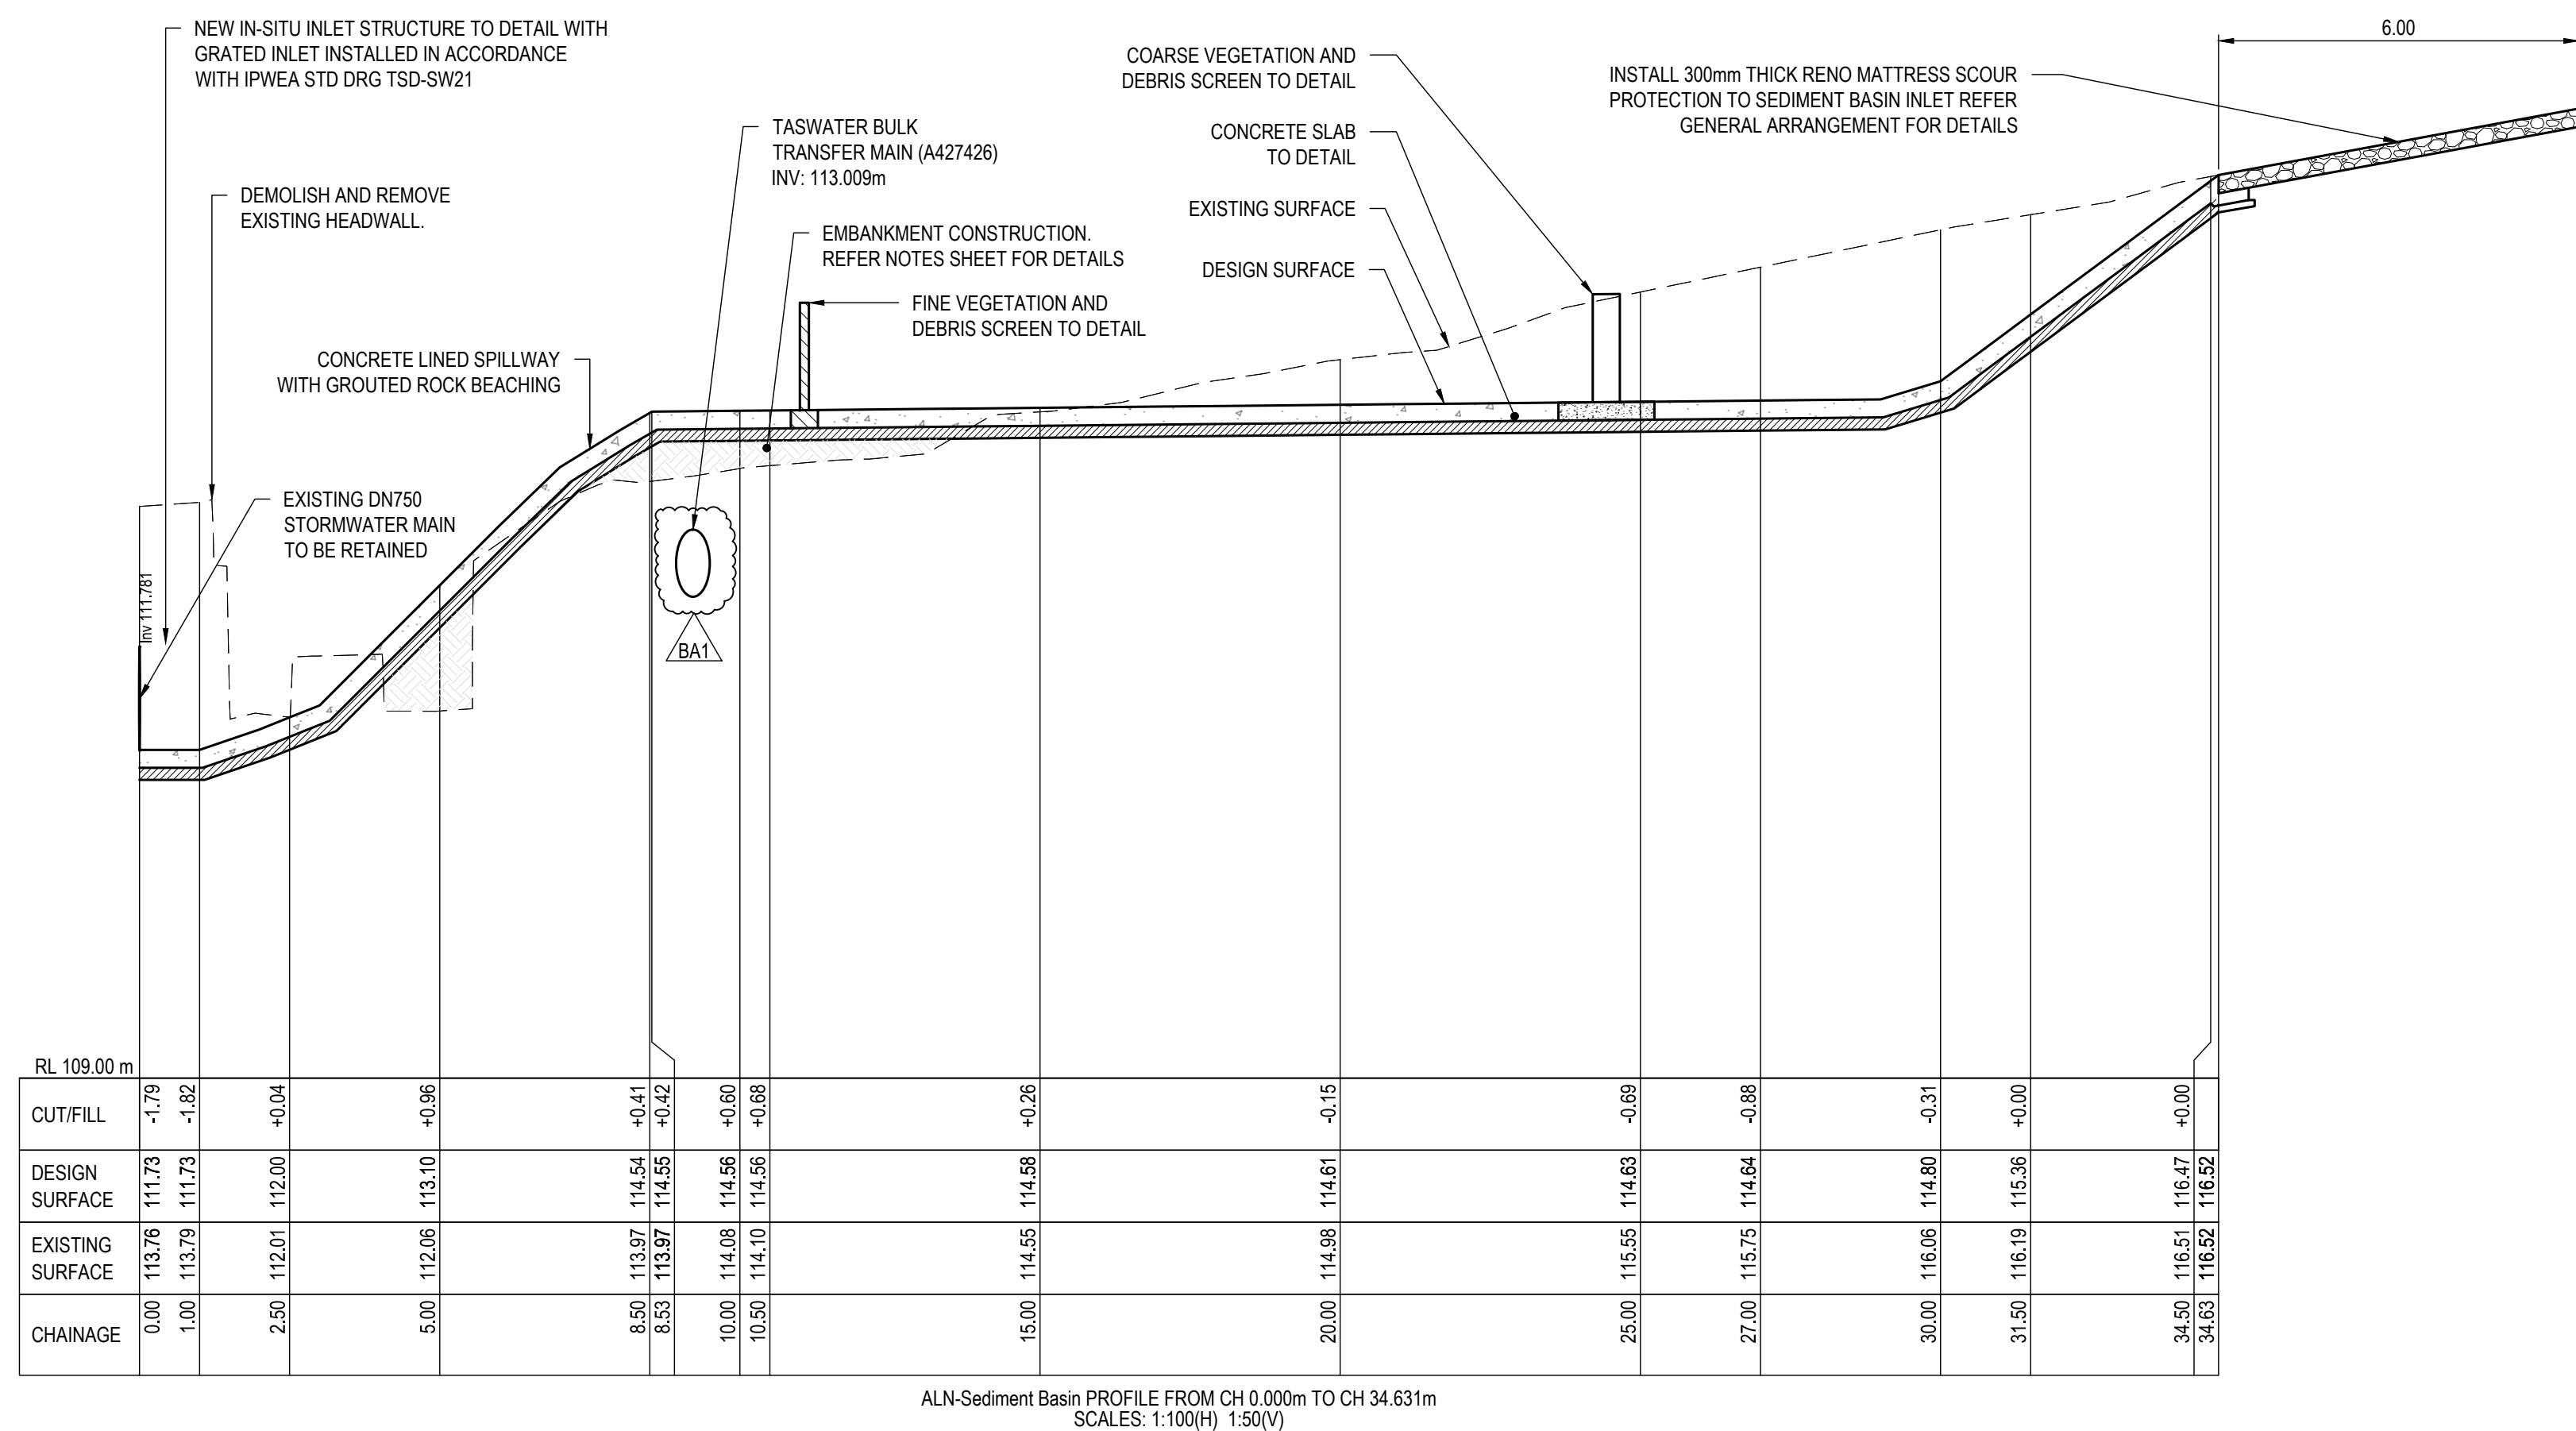
PLOT DETAILS J230352CS-C-DETAILS.DWG

PROJECT NO. 230352CS

DWG NO.	REVISION
C05	BA1

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BA1	19.03.2025	REVISED BUILDING APPROVAL
BA2	22.05.2024	BUILDING APPROVAL ISSUE
P4	08.03.2024	CLIENT REVIEW ISSUE
P3	04.03.2024	REVISED PRELIMINARY ISSUE
P2	20/09/2023	ISSUED FOR TWO COMMENTS
P1	25/08/2023	PRELIMINARY ISSUE
REV	DATE	REMARK




SAFETY IN DESIGN REPORT PER WHS REGULATIONS

<p>The following risks which are unique to this design have been identified:</p> <p>This report does not relieve contractors from their responsibilities under the Act to identify, report, mitigate and manage all aspects of risk and safety.</p>	<p>Nil</p>
---	------------



PROJECT
GLENORCHY CITY COUNCIL,
REDLANDS DRIVE ROSETTA
DEBRIS BASIN

TITLE
BASIN PROFILES

Accepted MJR (Discipline Head)		Date 19.03.2025
Accepted MJR (Team Leader)		Date 19.03.2025
Approved CJM (Principal)		Date 19.03.2025

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AS SHOWN	MJR	TCM
	PLOT DATE	19/03/2025





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PLOT DETAILS J230352CS-C-DETAILS.DWG





PROJECT NO. 230352CS	
DWG NO. C06	REVISION BA1

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ALN-Sediment Basin CROSS SECTIONS
SCALES: 1:100(H) 1:100(V)



BA1 19.03.2025 REVISED BUILDING APPROVAL
P4 22.05.2024 BUILDING APPROVAL ISSUE
P3 08.03.2024 CLIENT REVIEW ISSUE
P2 04.03.2024 REVISED PRELIMINARY ISSUE
P1 20.09.2023 ISSUED FOR TW COMMENTS
REV DATE REMARK

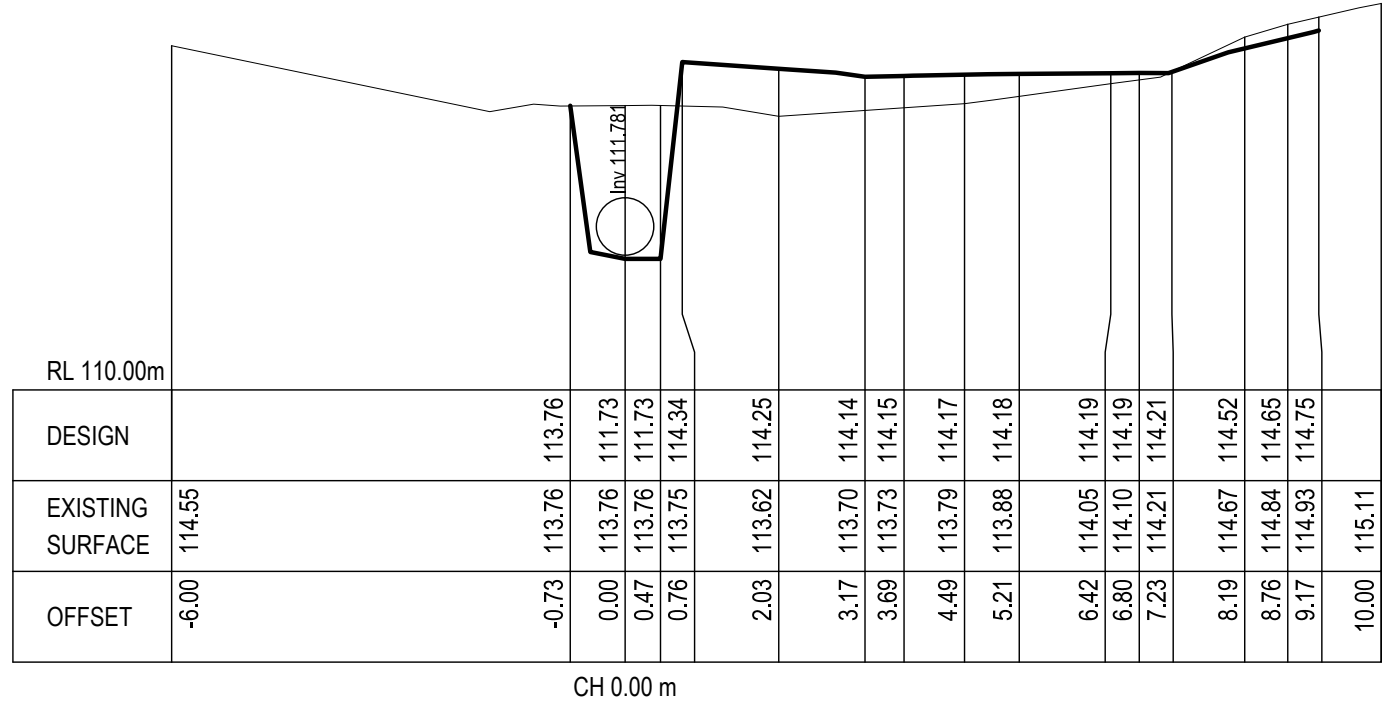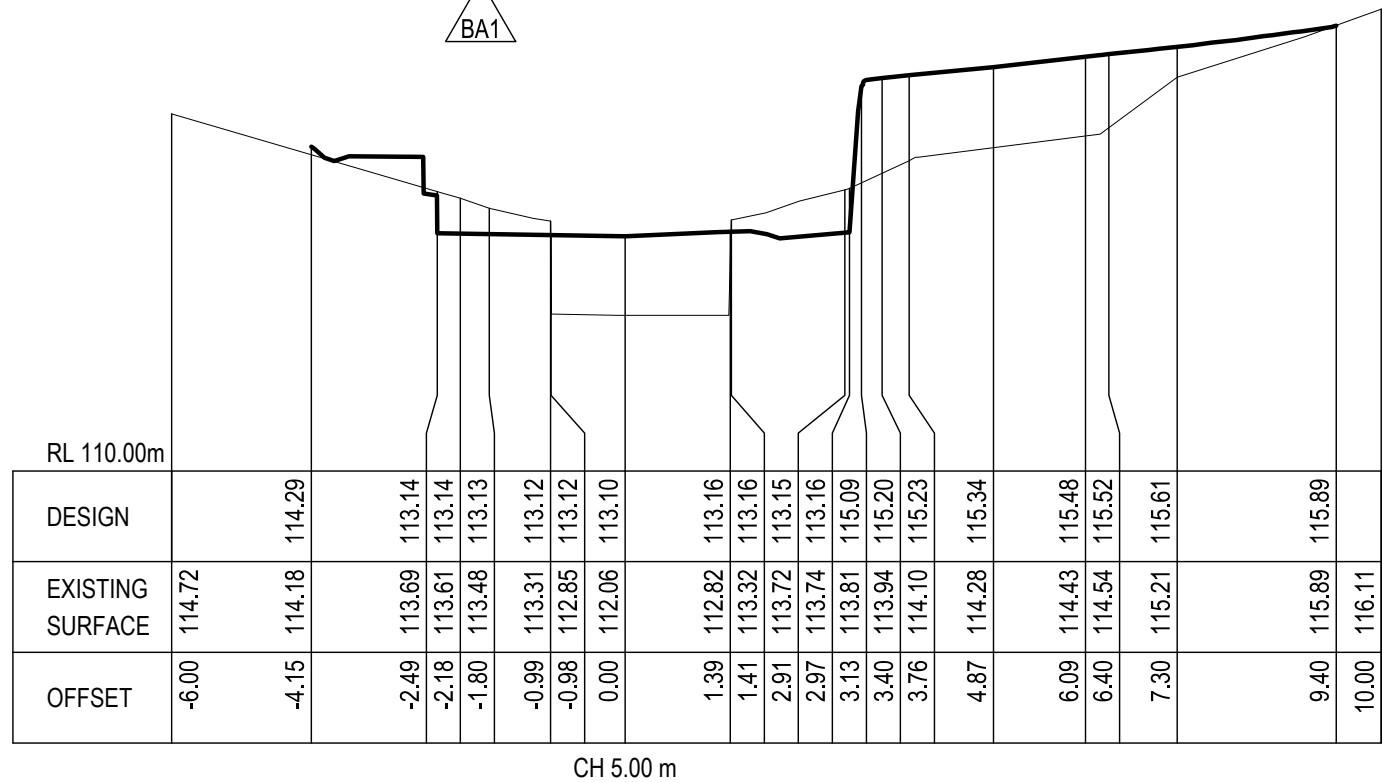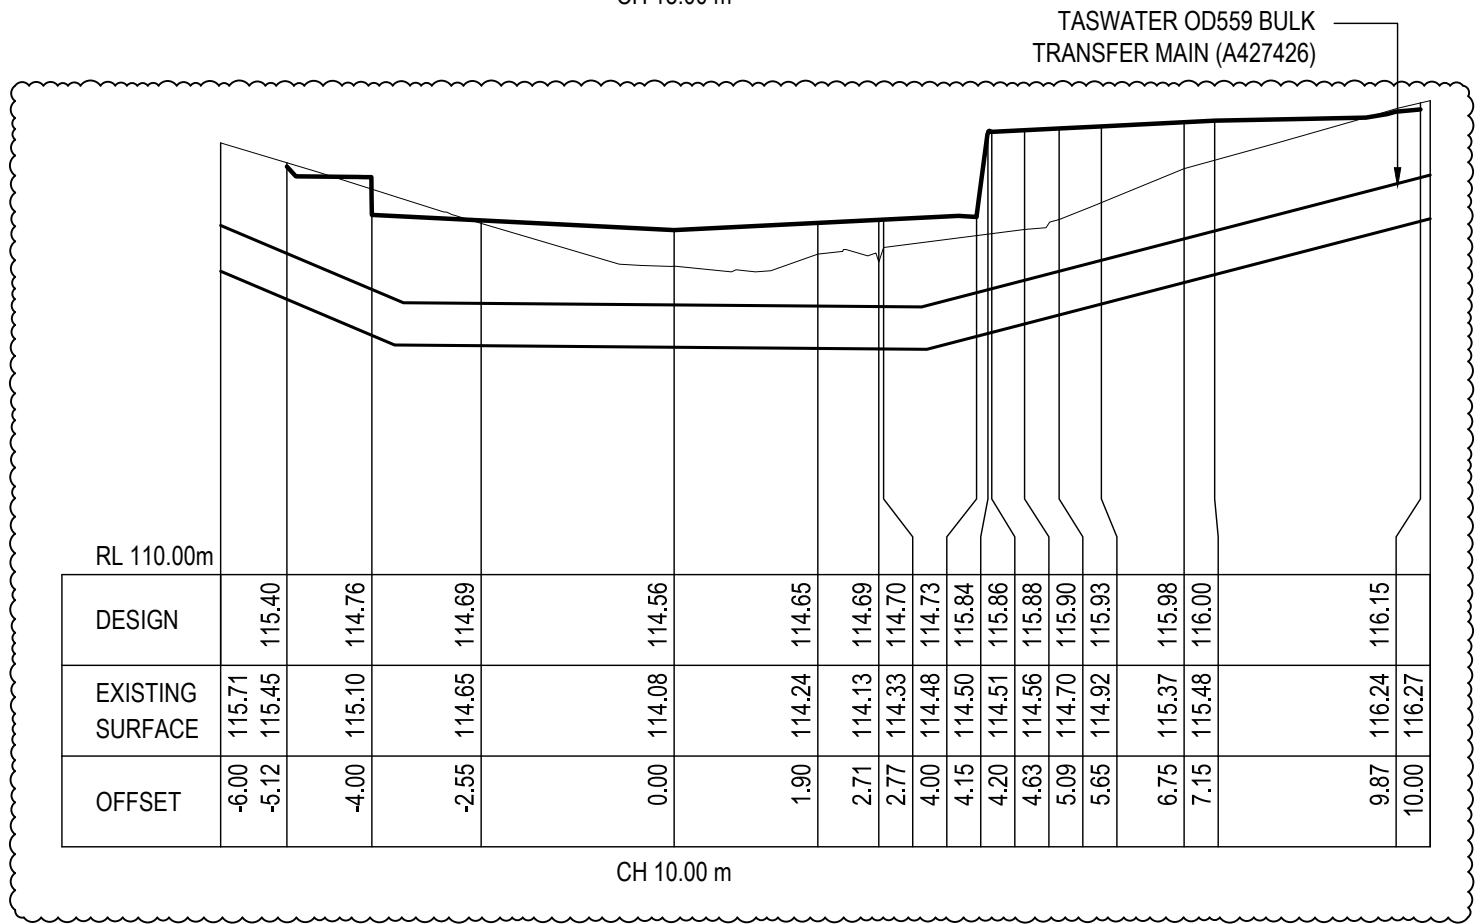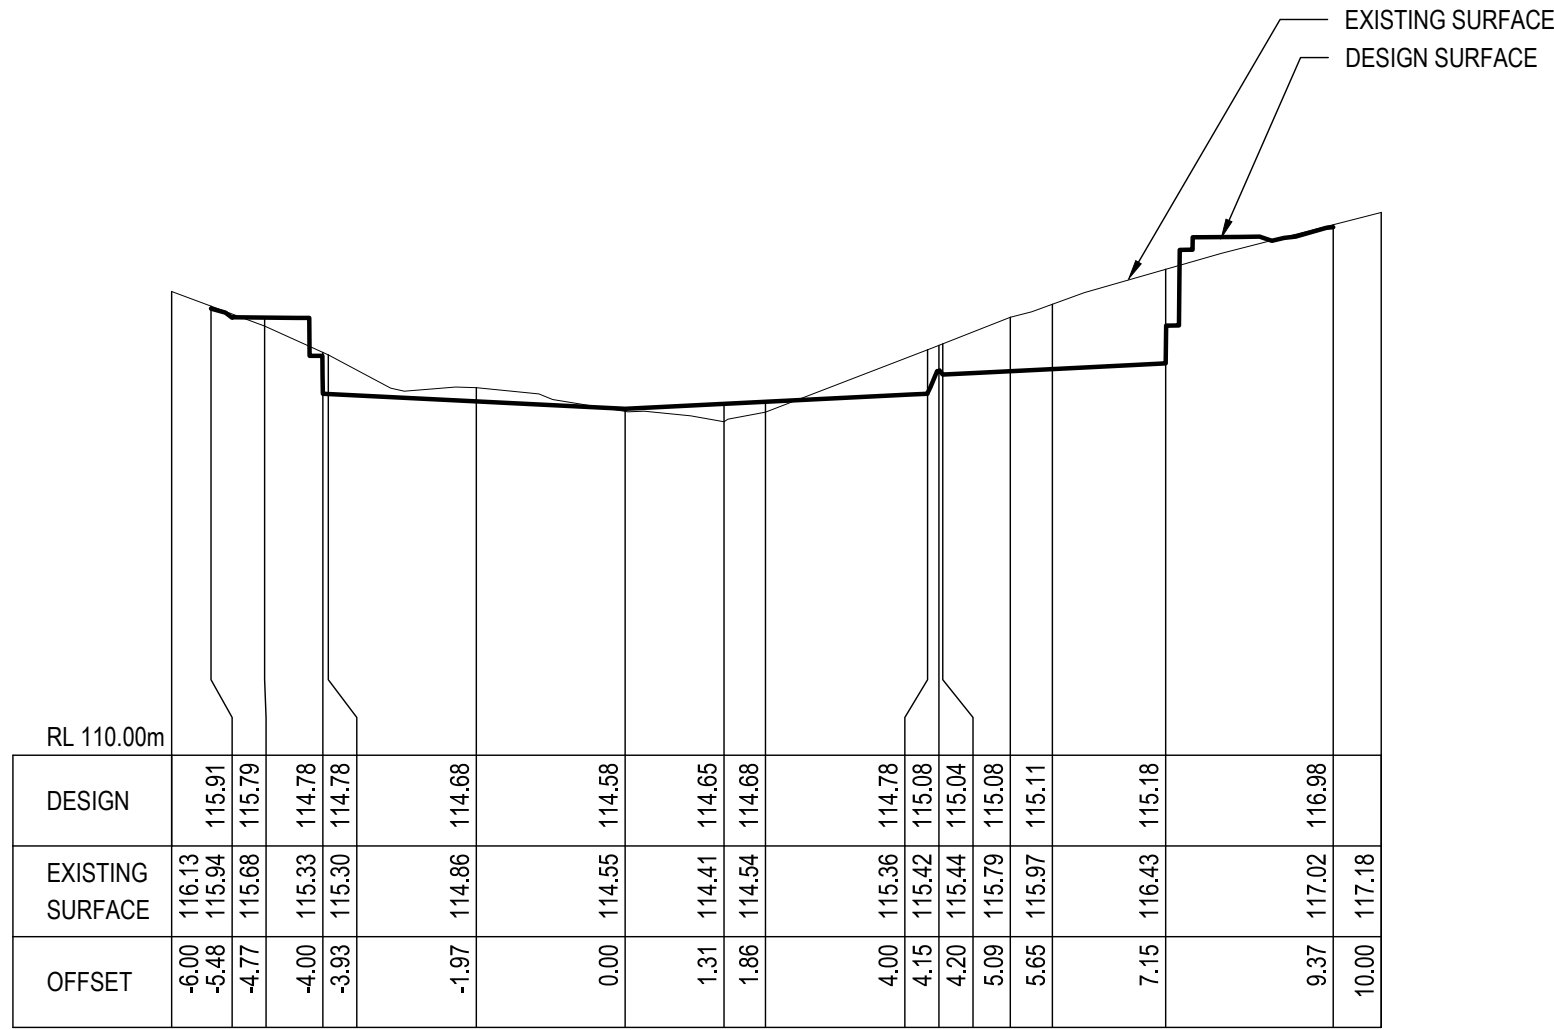SAFETY IN DESIGN REPORT PER WHS REGULATIONS	
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117 Harrington Street, Hobart TAS
49-51 Elizabeth Street, Launceston TAS
www.jmg.net.au info@jmg.net.au

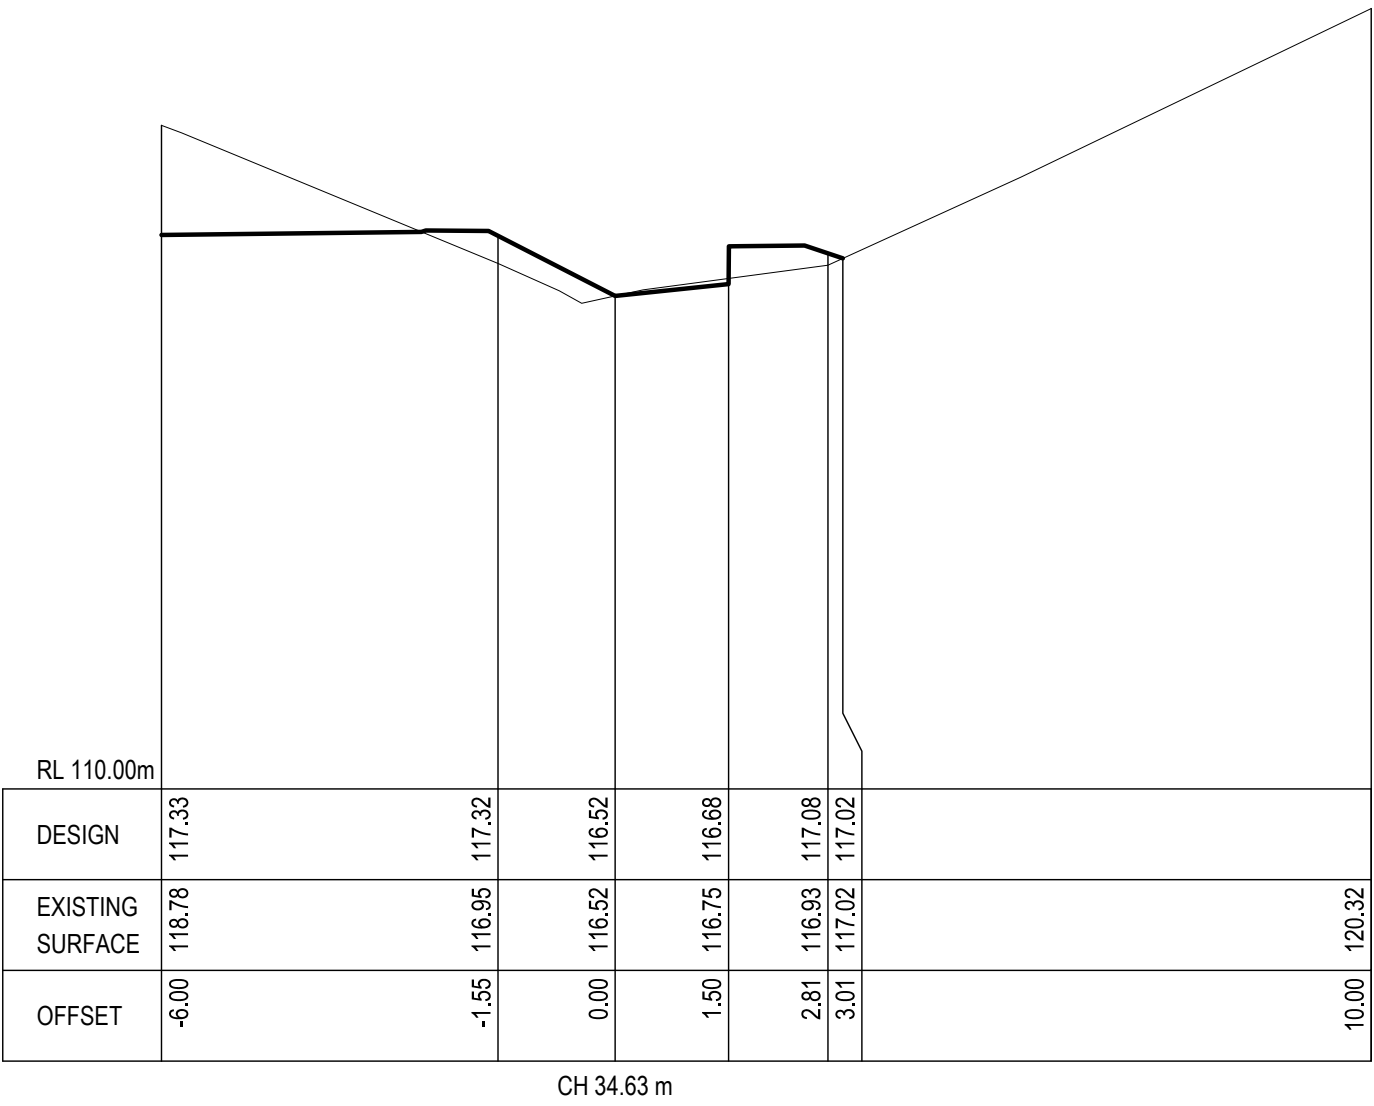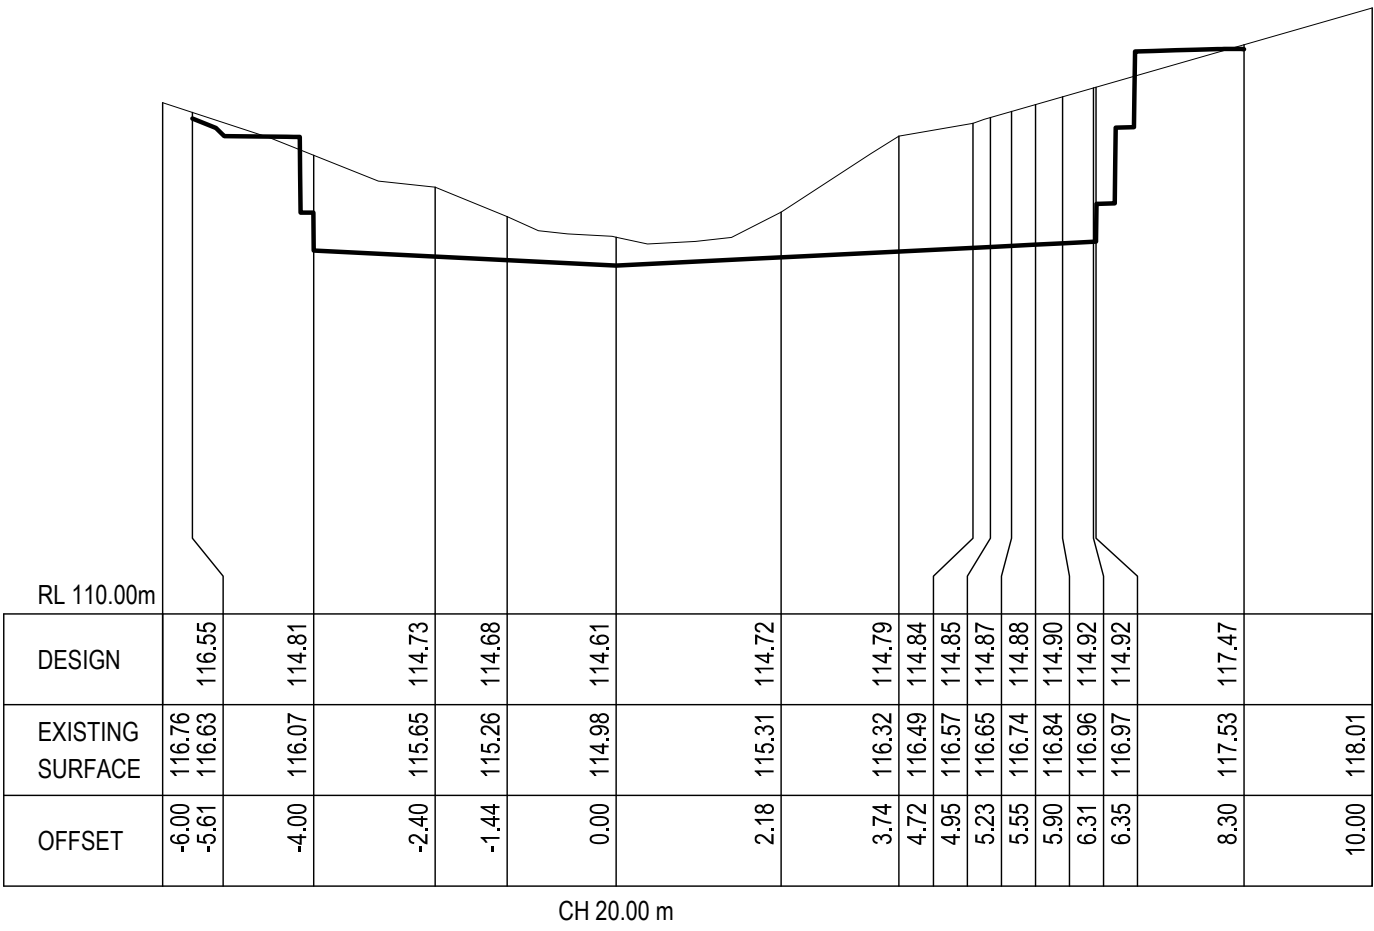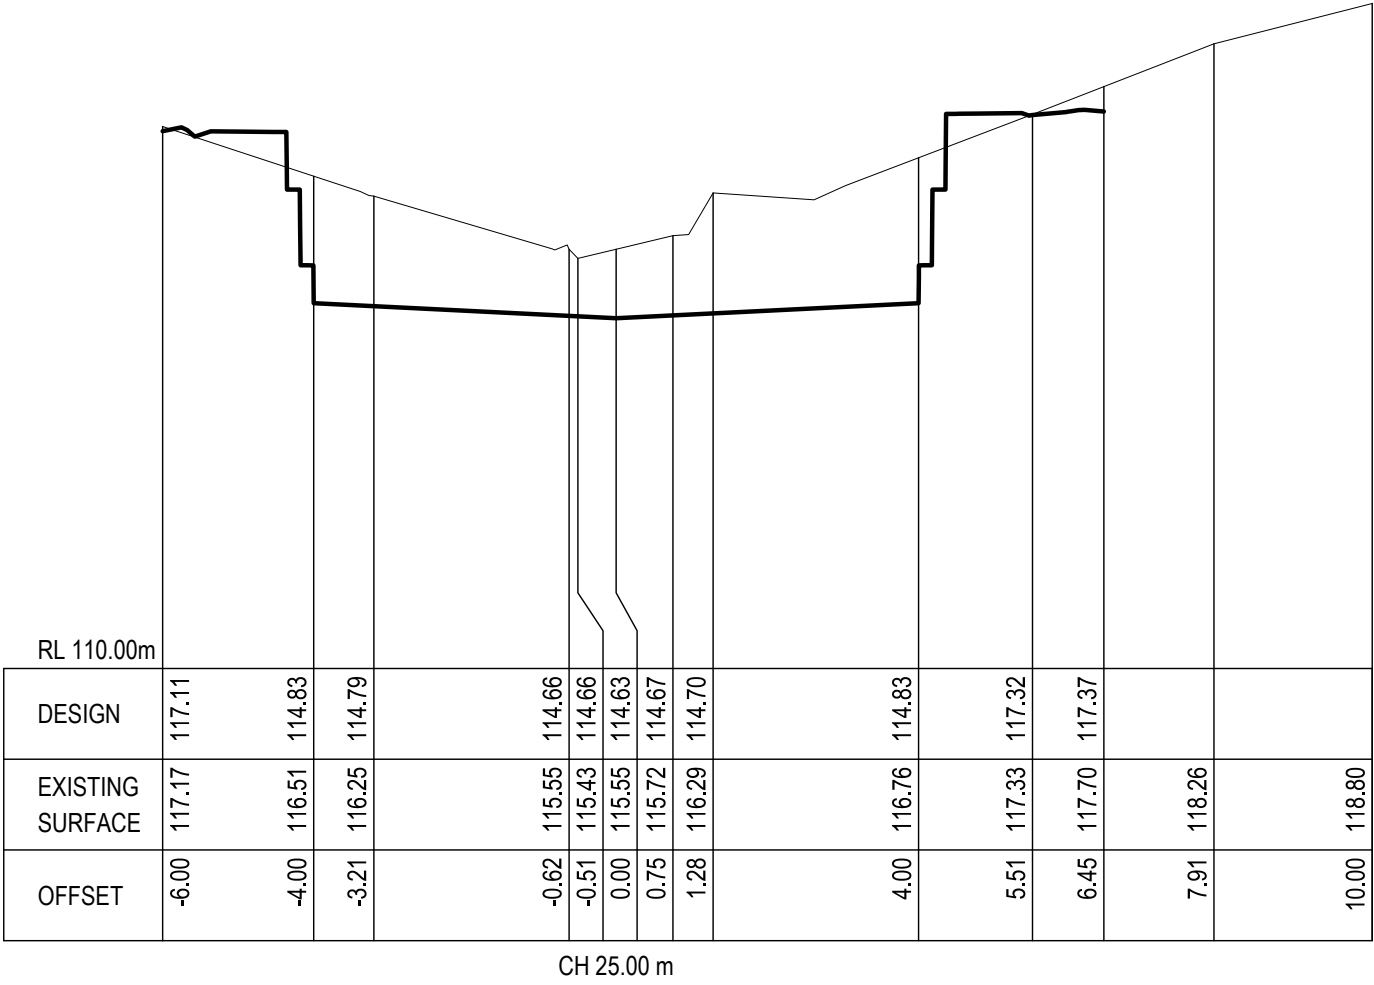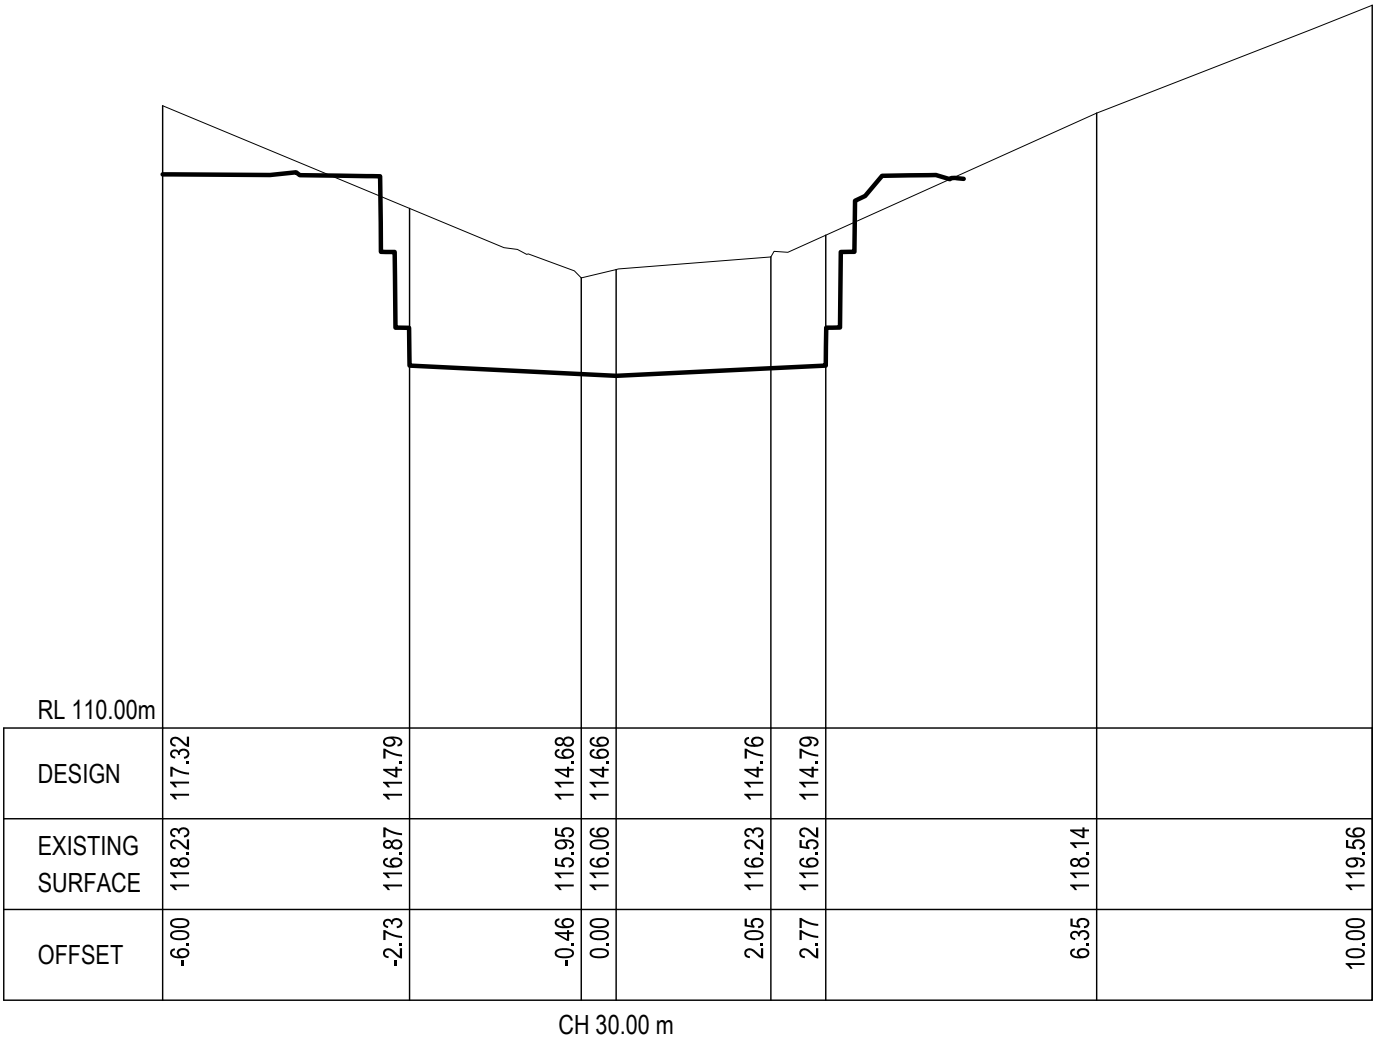(03) 6331 2555
(03) 6334 5548
info@jmg.net.au

PROJECT
GLENORCHY CITY COUNCIL,
REDLANDS DRIVE ROSETTA
DEBRIS BASIN

TITLE
DEBRIS BASIN CROSS
SECTIONS

Accepted (Discipline Head)	MJR	Date	19.03.2025
Accepted (Team Leader)	MJR	Date	19.03.2025
Approved (Principal)	CM	Date	19.03.2025
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SCALES @ A1	DESIGNED BY	DRAWN BY
AS SHOWN	MJR	TCM
PLOT DATE	19/03/2025	


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PLOT DETAILS J230352CS-C-DETAILS.DWG


PROJECT NO. 230352CS

DWG NO.	REVISION
C07	BA1

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ALN-LHS RETAINING WALL PROFILE FROM CH 0.000m TO CH 37.592m
SCALES: 1:50(H) 1:50(V)

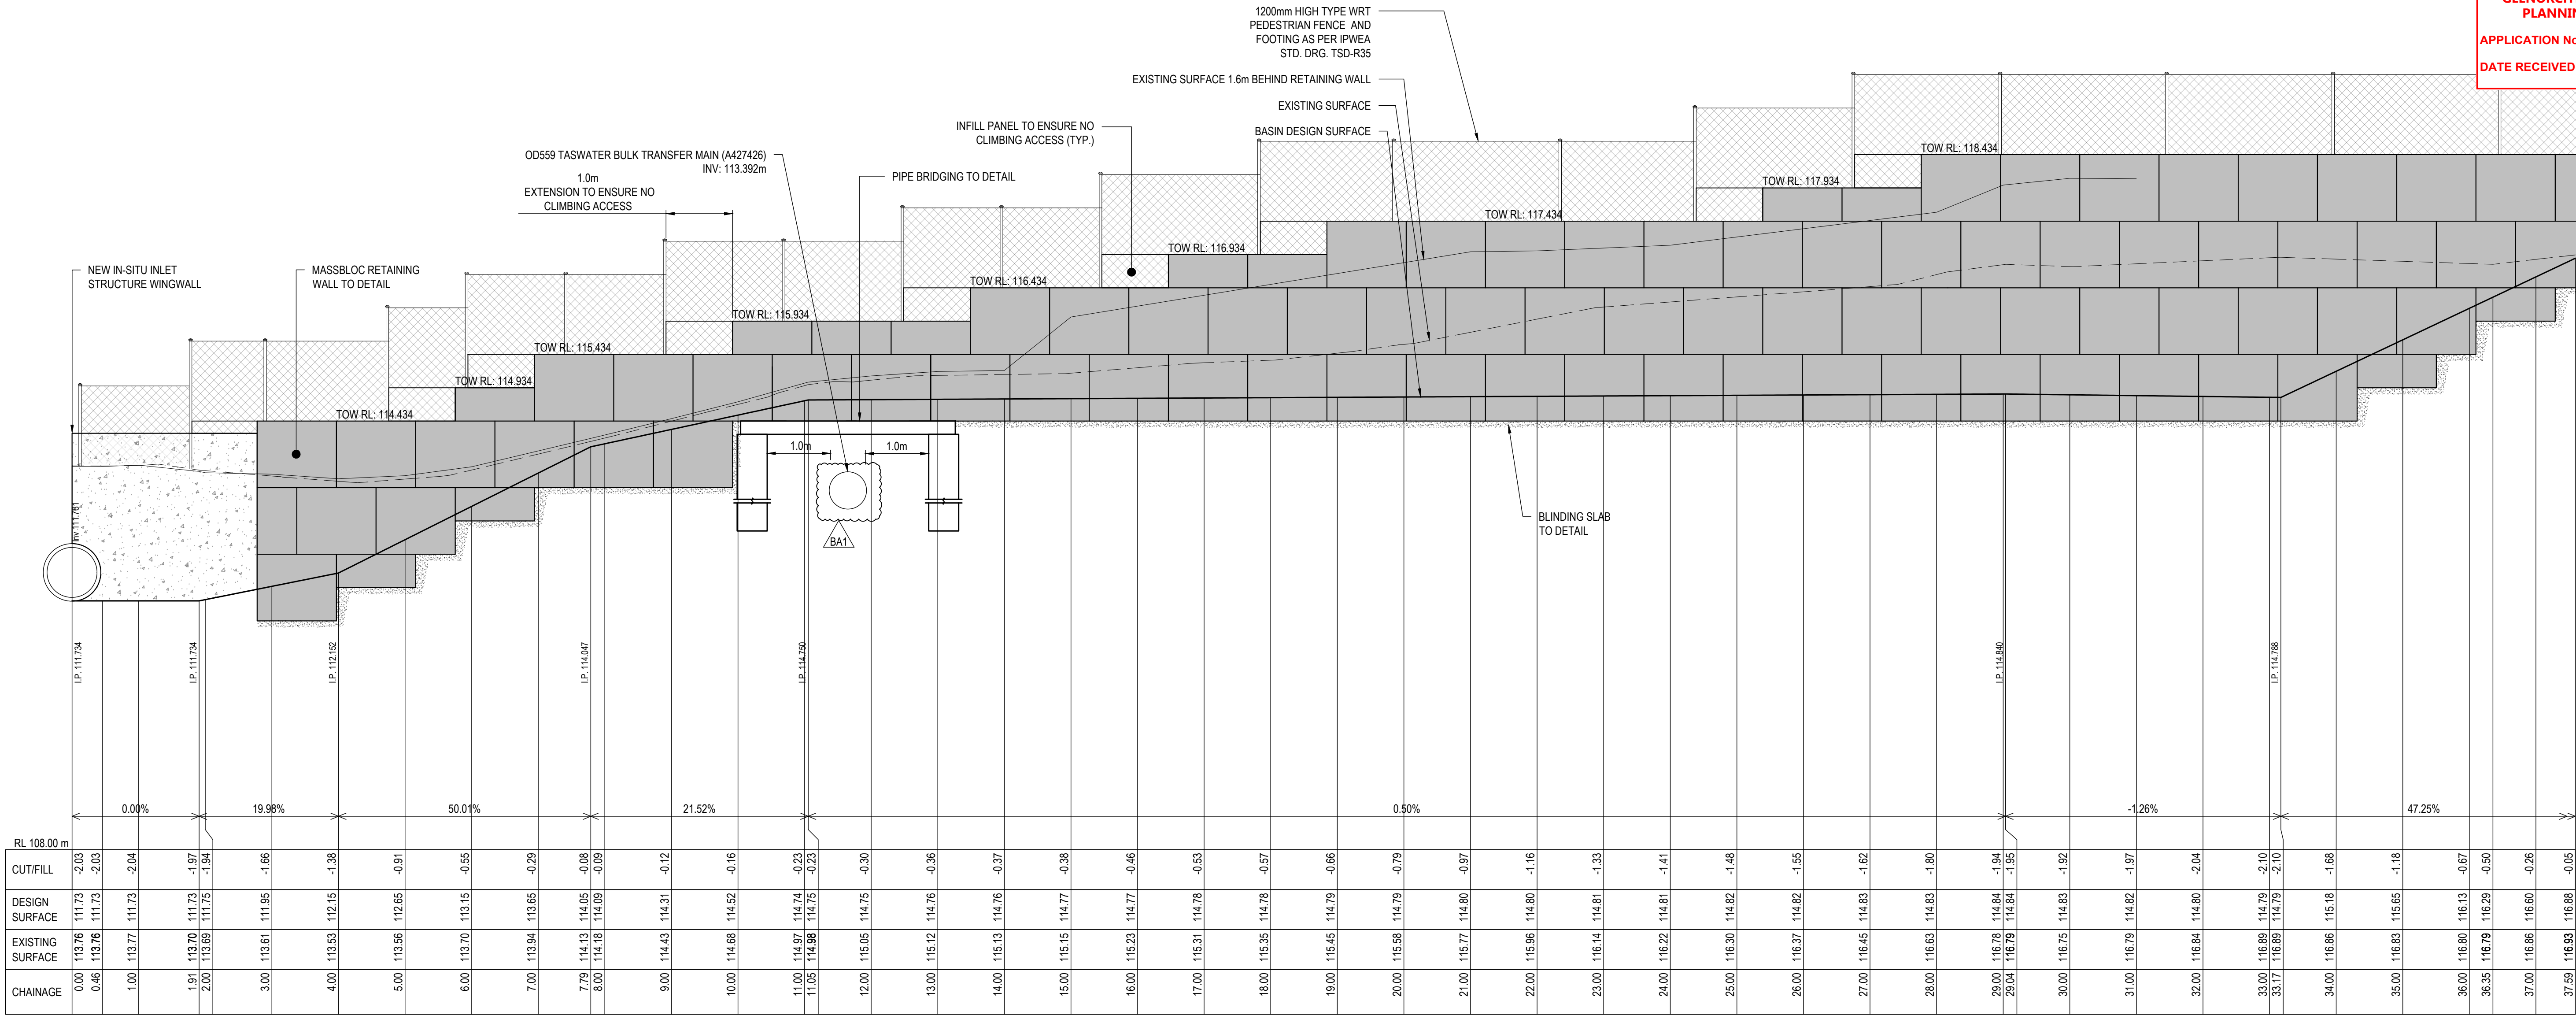

ALN-RHS RETAINING WALL PROFILE FROM CH 0.000m TO CH 25.299m
SCALES: 1:50(H) 1:50(V)

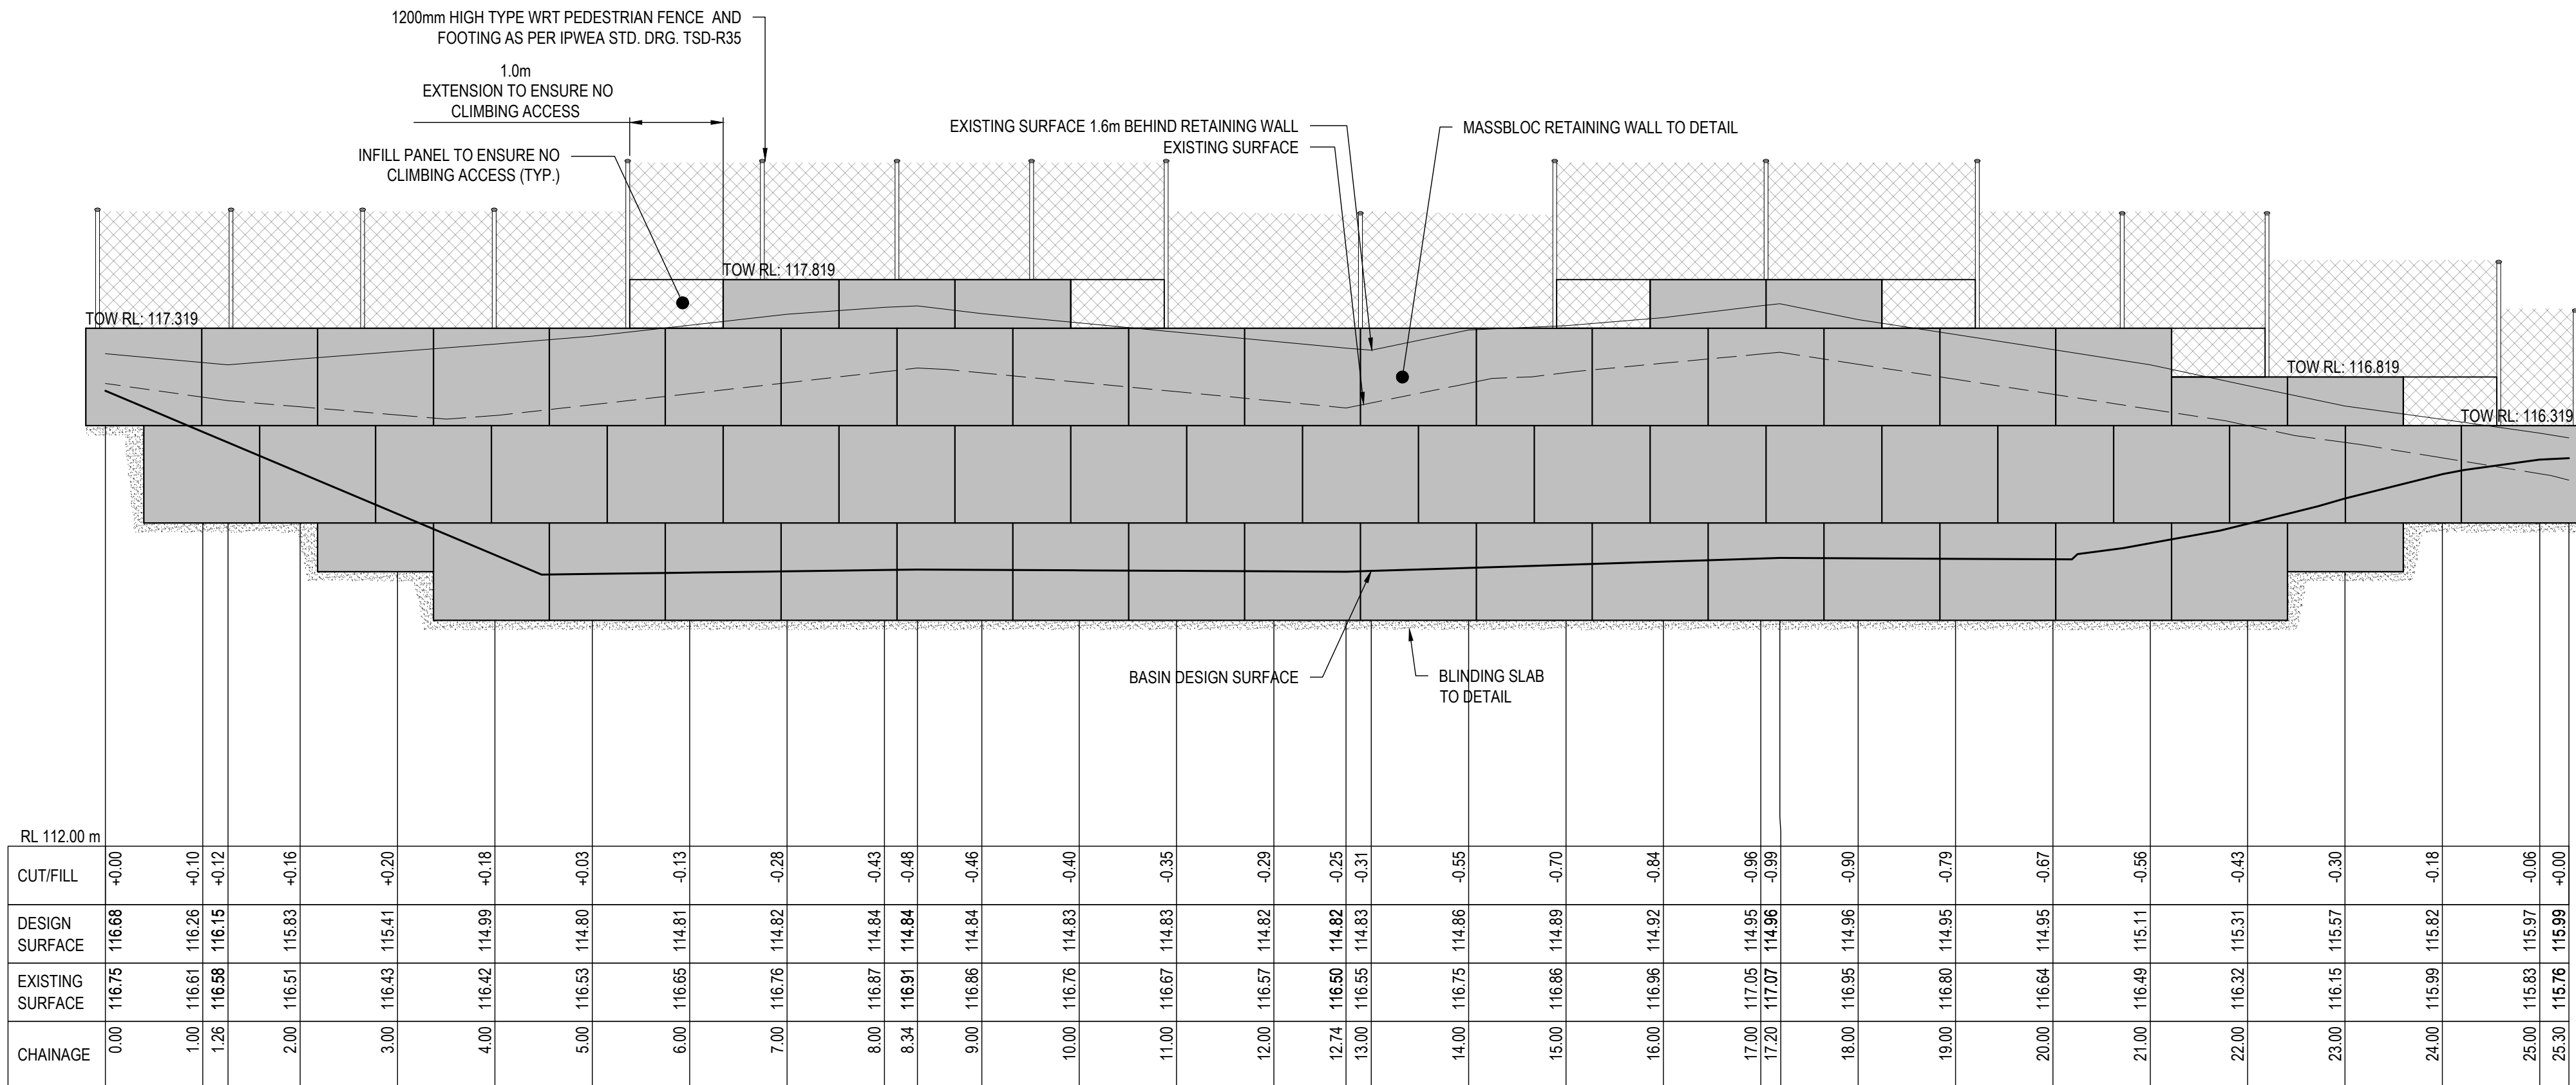BA1	19.03.2025	REVISED BUILDING APPROVAL
BA	22.05.2024	BUILDING APPROVAL ISSUE
P4	08.03.2024	CLIENT REVIEW ISSUE
P3	04.03.2024	REVISED PRELIMINARY ISSUE
P2	20.09.2023	ISSUED FOR TW COMMENTS
P1	25.08.2023	PRELIMINARY ISSUE
REV	DATE	REMARK

SAFETY IN DESIGN REPORT PER WHS REGULATIONS	
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PROJECT
GLENORCHY CITY COUNCIL,
REDLANDS DRIVE ROSETTA
DEBRIS BASIN

TITLE
RETAINING WALL
ELEVATIONS
SHEET 1

Accepted (Discipline Head)	MJR	Date	19.03.2025
Accepted (Team Leader)	MJR	Date	19.03.2025
Approved (Principal)	CJM	Date	19.03.2025

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AS SHOWN	MJR	TCM
	PLOT DATE	19/03/2025


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PLOT DETAILS J230352CS-C-DETAILS.DWG

PROJECT NO. 230352CS

DWG NO.	REVISION
C08	BA1

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BA1	19.03.2025	REVISED BUILDING APPROVAL
BA	22.05.2024	BUILDING APPROVAL ISSUE
P2	08.03.2024	CLIENT REVIEW ISSUE
P1	04.03.2024	PRELIMINARY ISSUE
REV	DATE	REMARK

SAFETY IN DESIGN REPORT PER WHS REGULATIONS	
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www.jmg.net.au infoh@jmg.net.au info@jmg.net.au

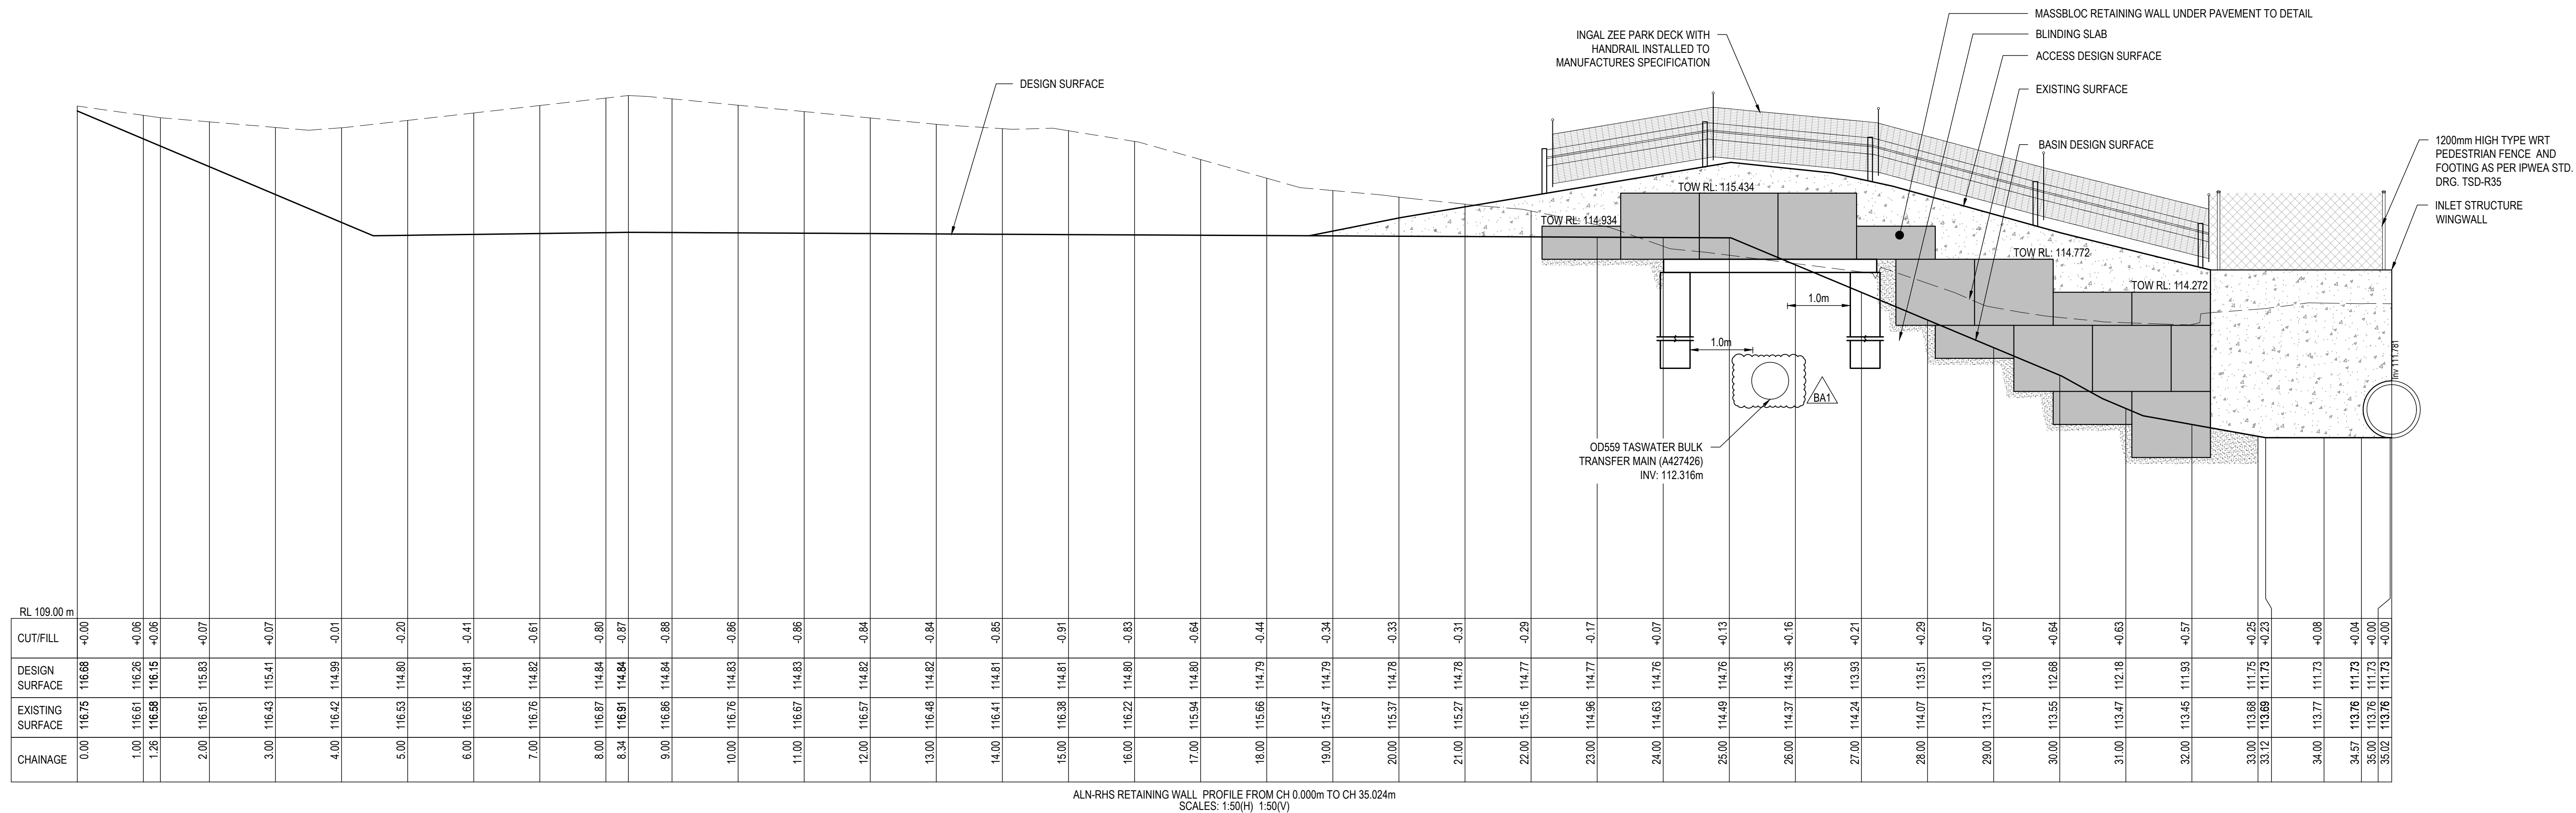PROJECT
GLENORCHY CITY COUNCIL,
REDLANDS DRIVE ROSETTA
DEBRIS BASIN

TITLE
RETAINING WALL
ELEVATIONS
SHEET 2

Accepted MJR (Discipline Head)	<i>MJR</i>	Date 19.03.2025
Accepted MJR (Team Leader)	<i>MJR</i>	Date 19.03.2025
Approved CJM (Principal)	<i>CJM</i>	Date 19.03.2025

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SCALES @ A1	DESIGNED BY	DRAWN BY
(V)1:50	MJR	TCM
(H)1:50	PLOT DATE	19/03/2025

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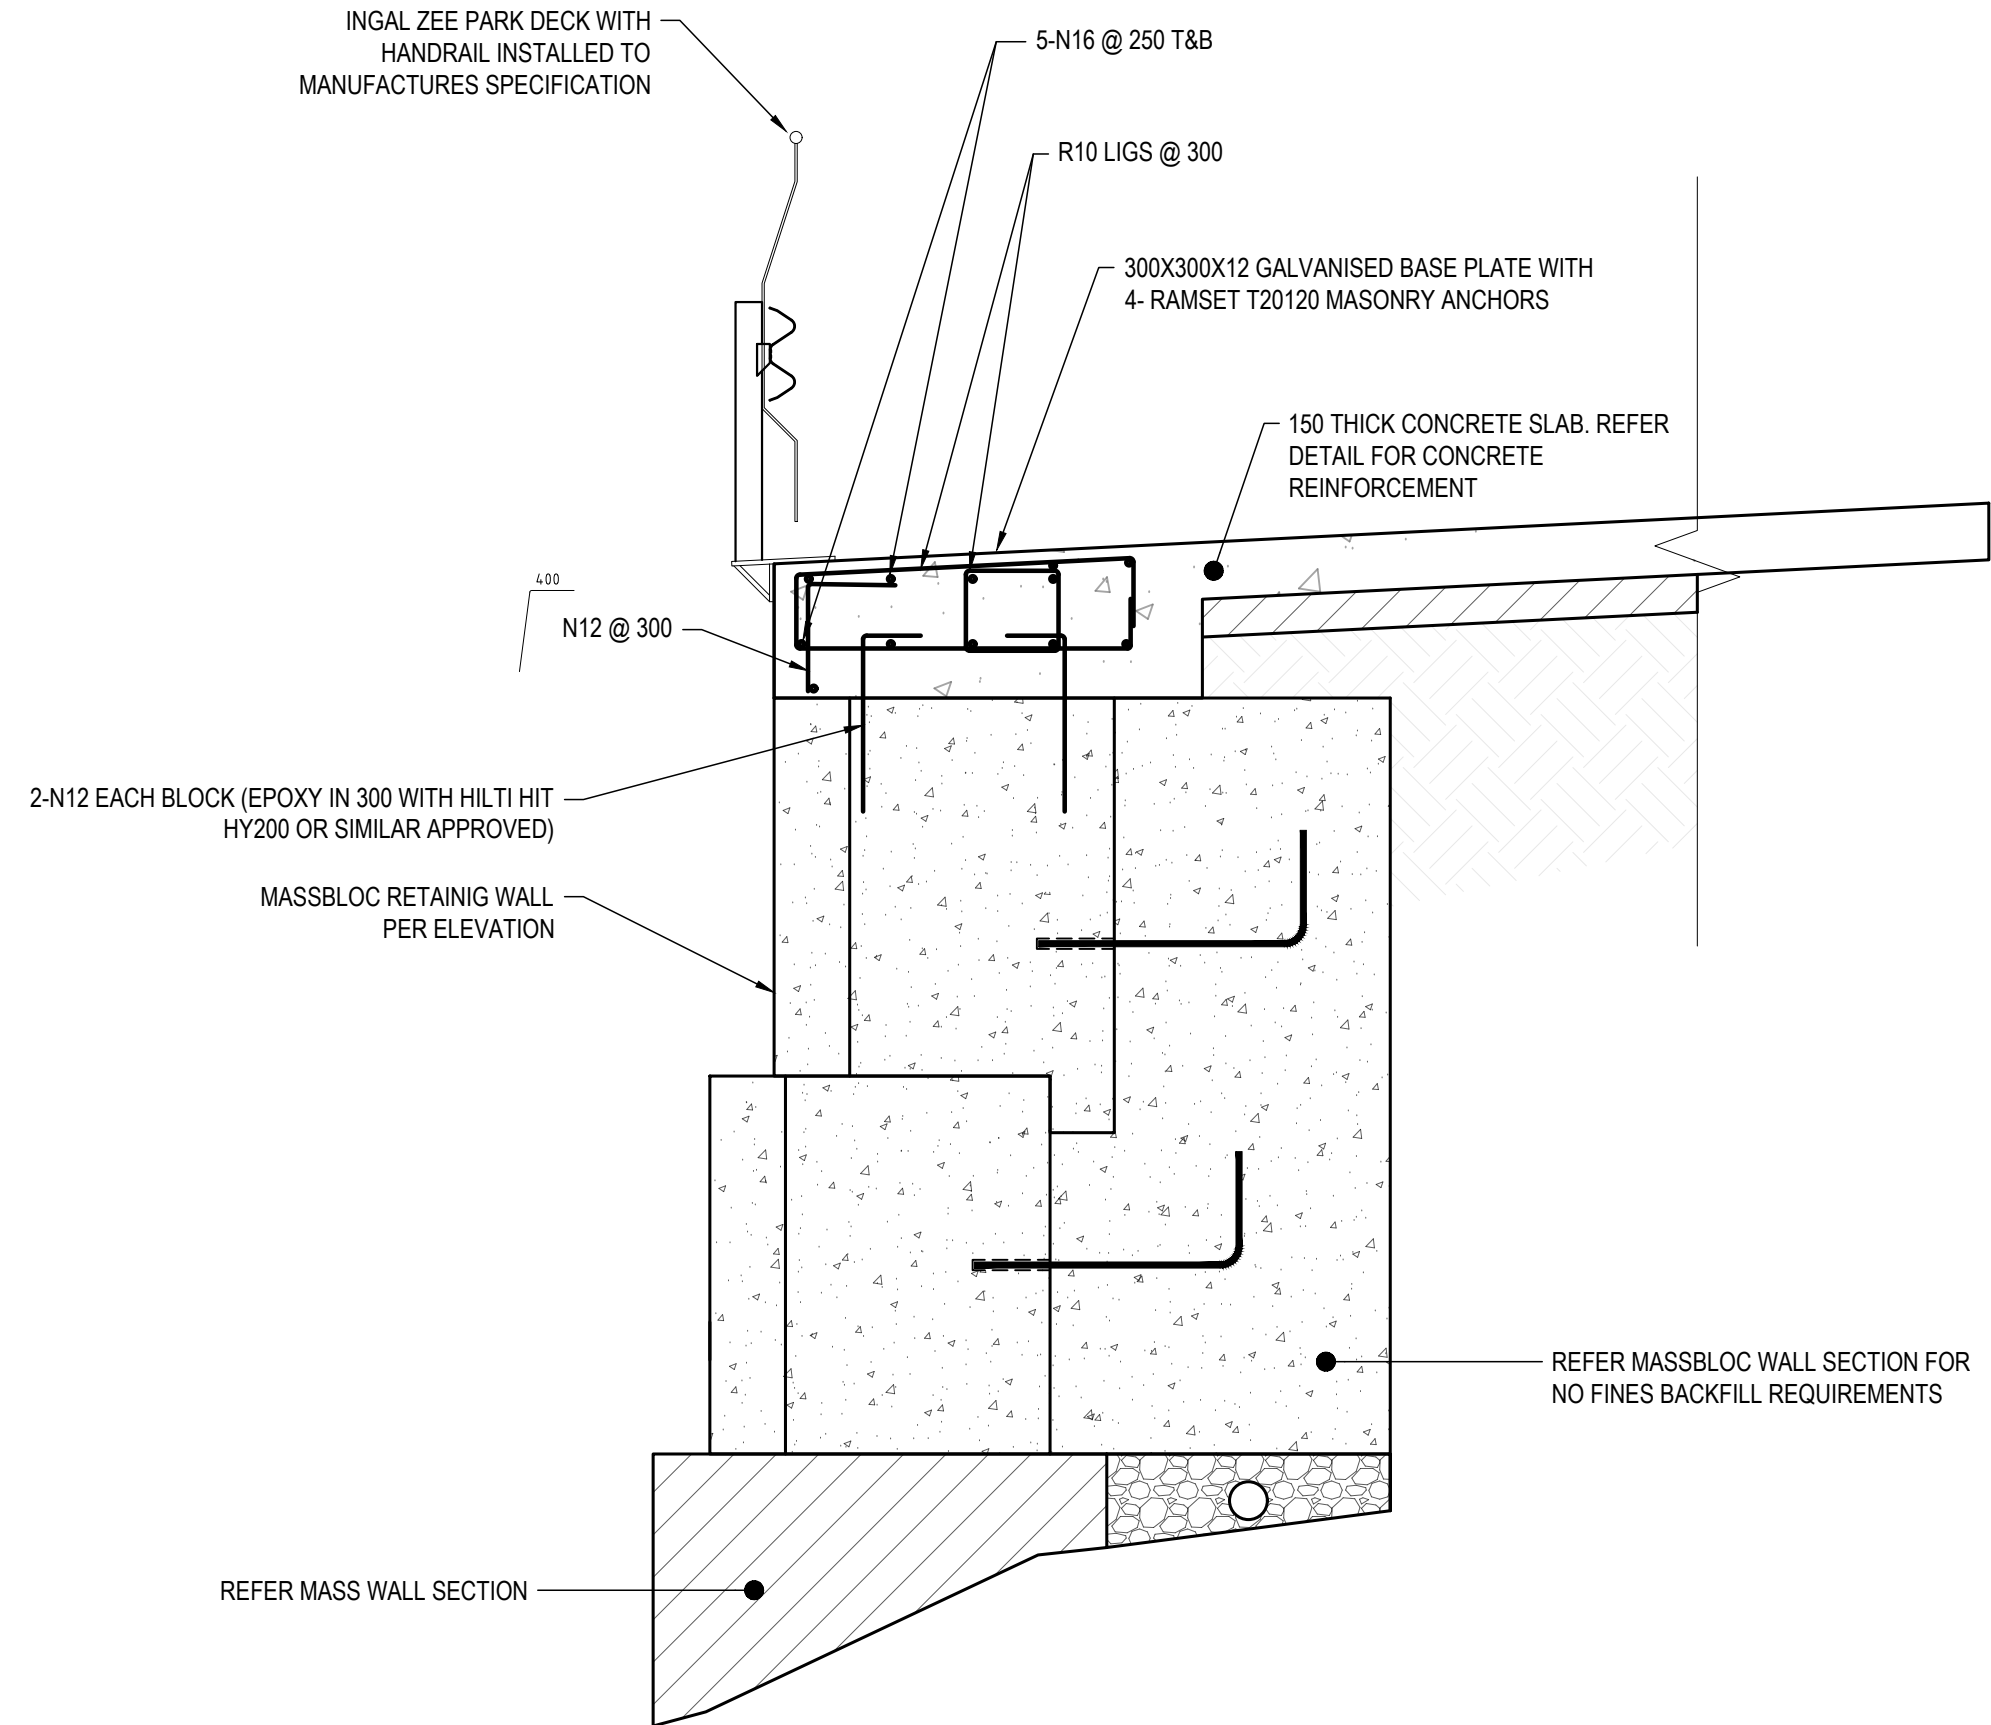
PLOT DETAILS J230352CS-C-DETAILS.DWG

PROJECT NO. 230352CS


DWG NO.	REVISION
C09	BA1

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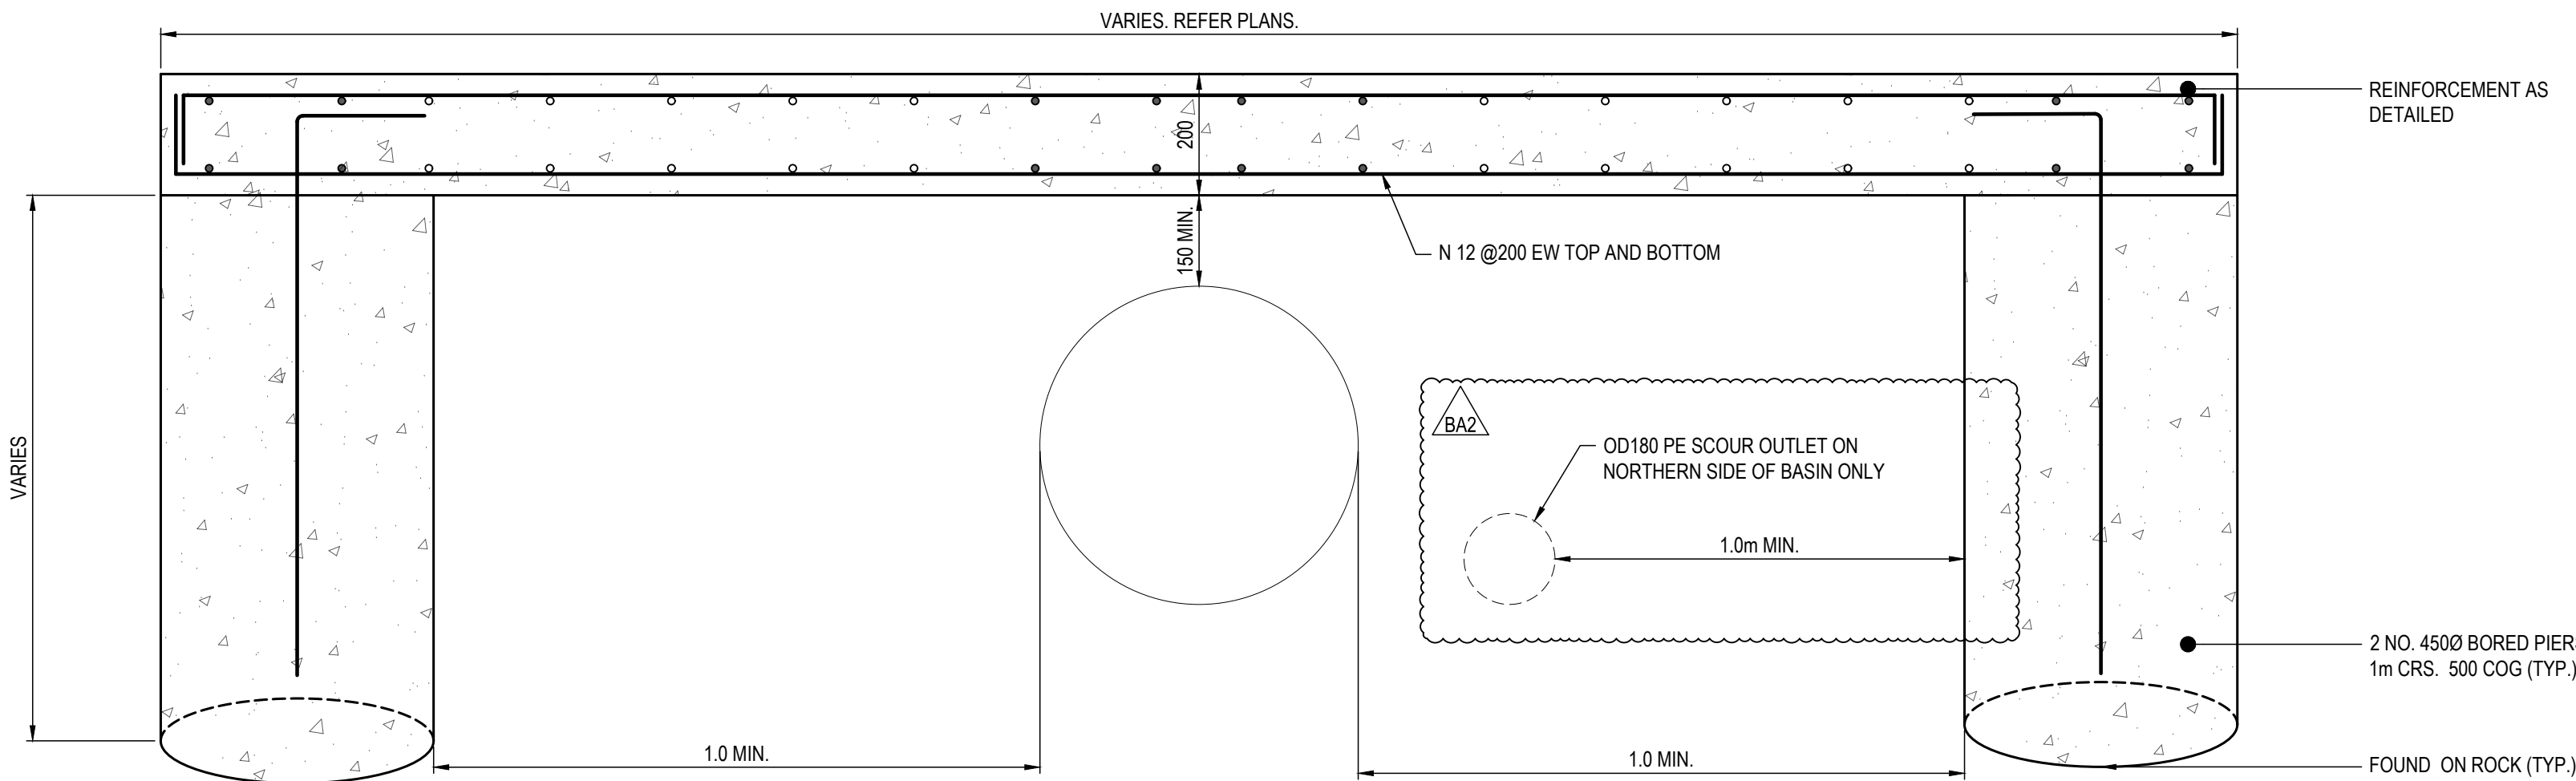
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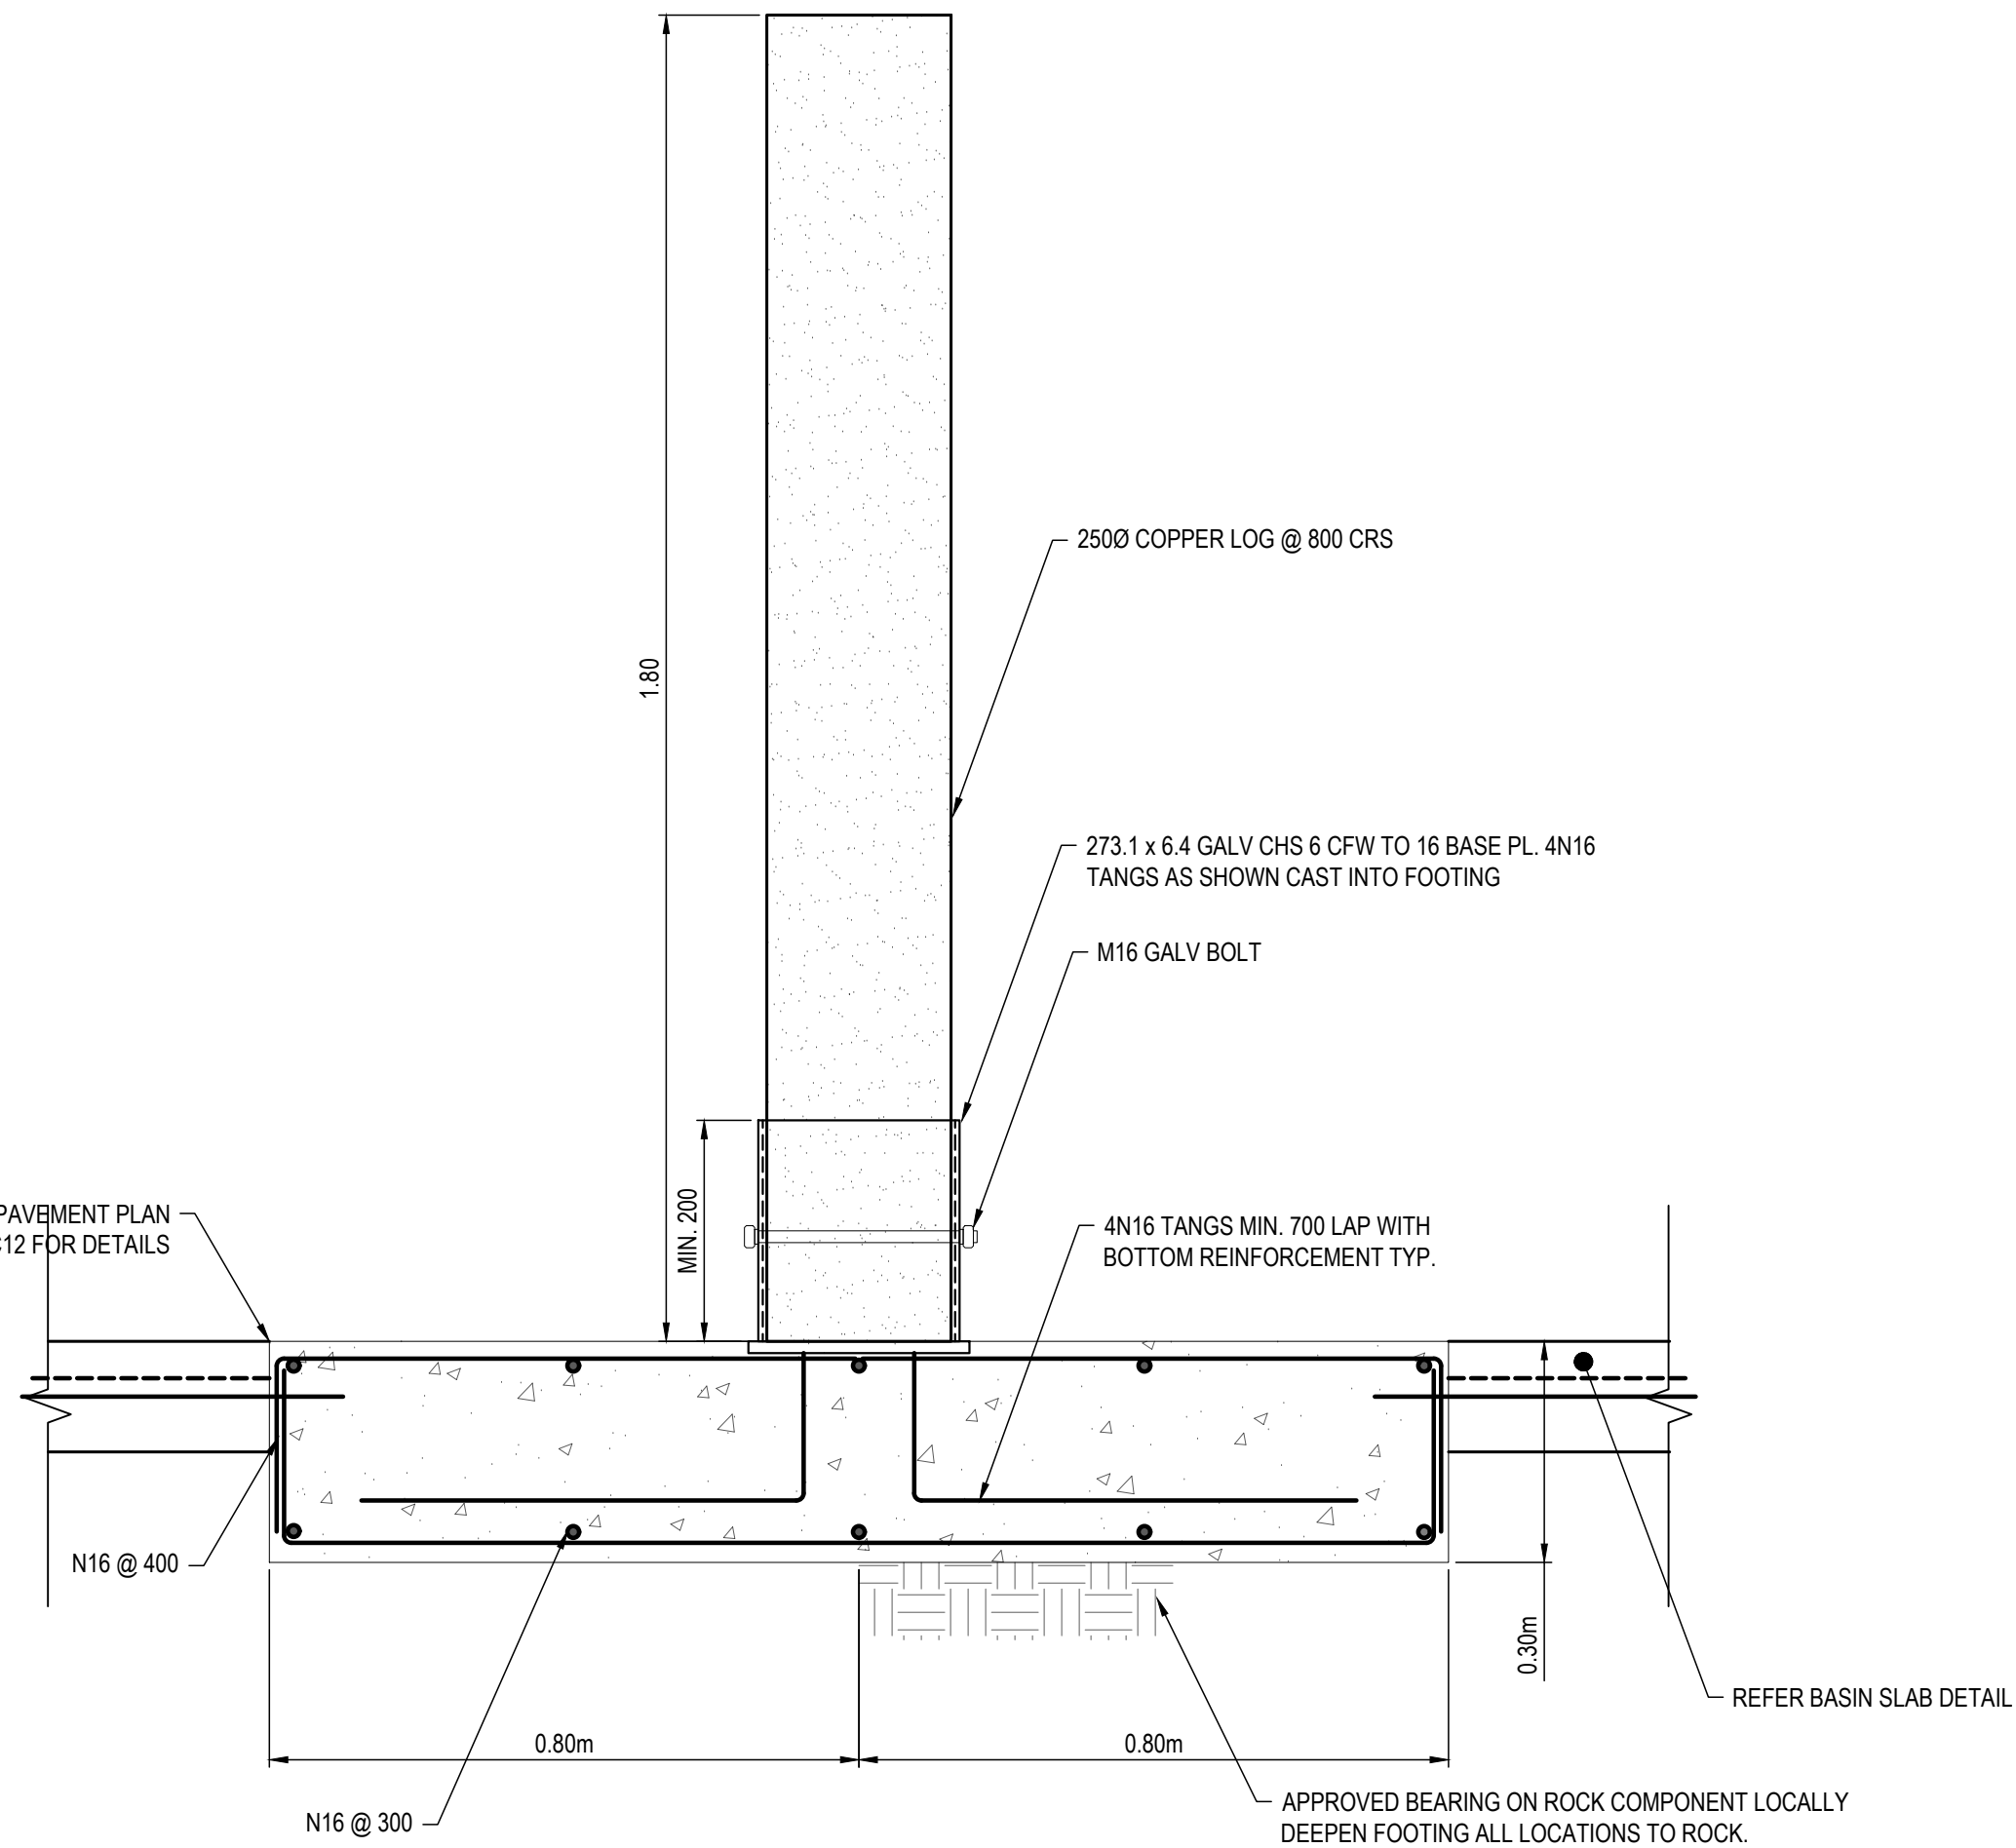
MASSBLOC RETAINING WALL UNDER PAVEMENT TYPICAL SECTION
SCALE: 1:20




BULK TRANSFER WATER MAIN BRIDGING ELEVATION
SCALE: 1:10

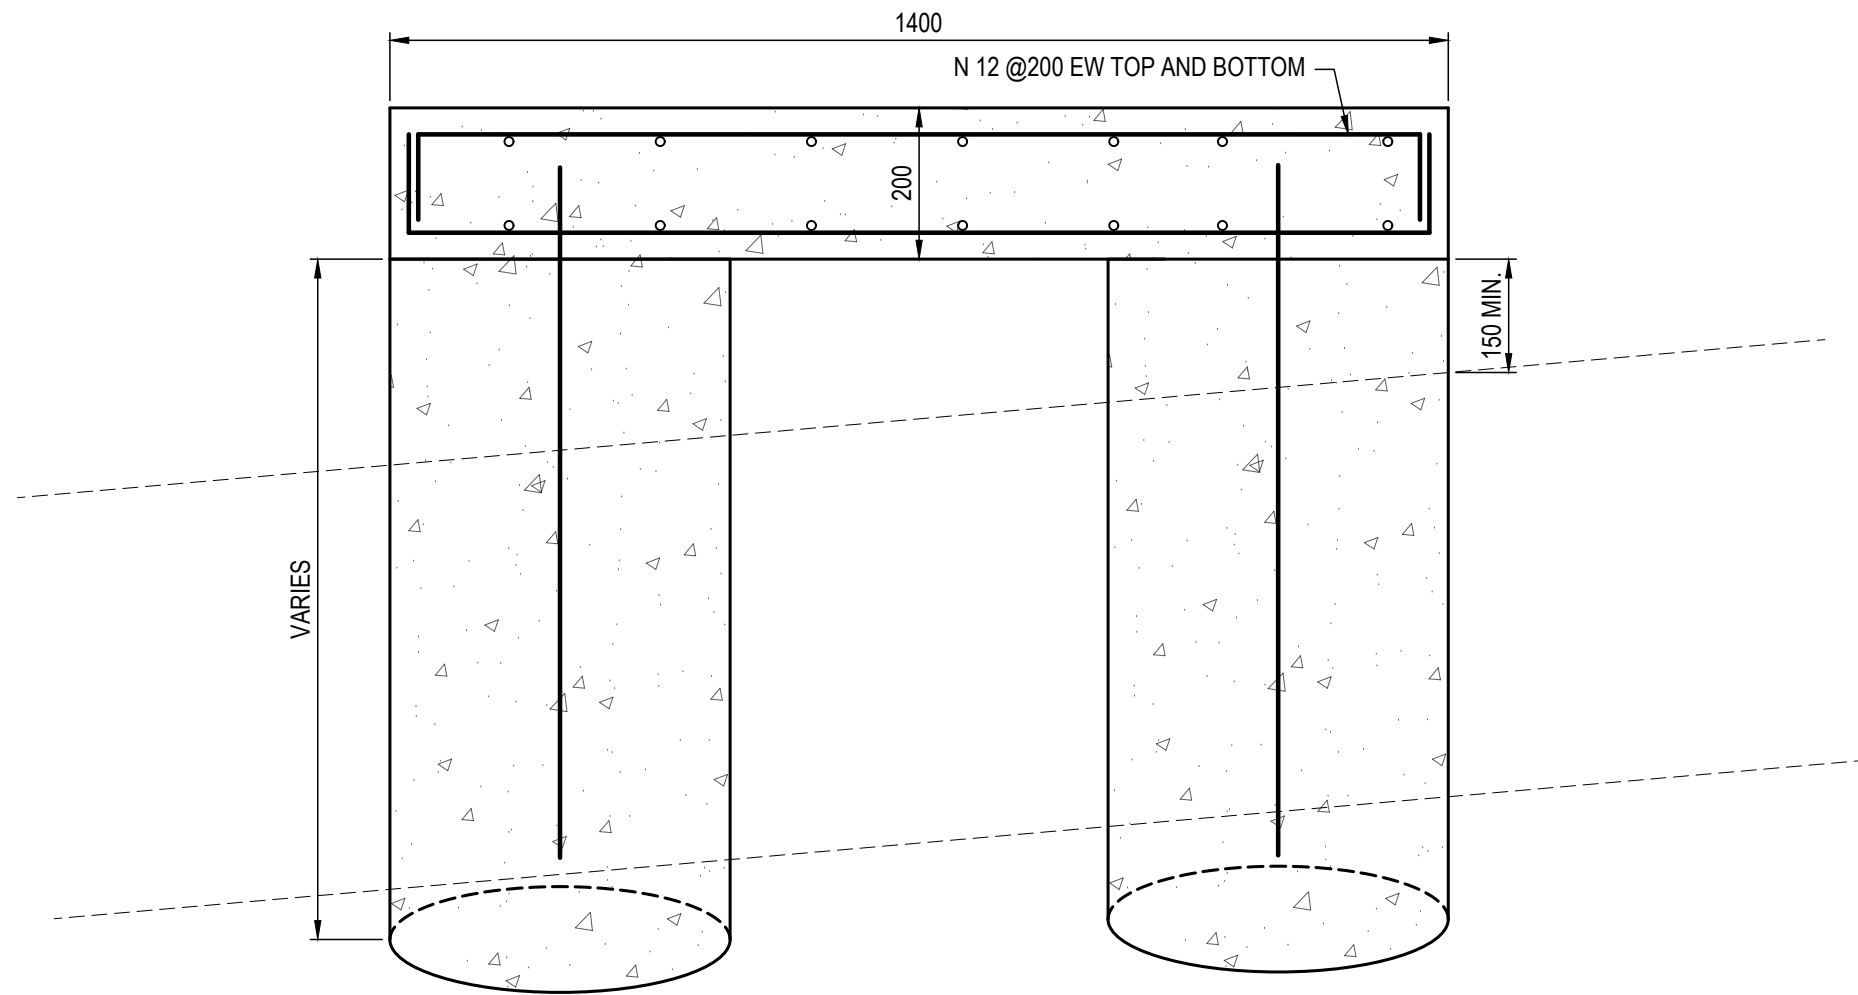

BULK TRANSFER WATER MAIN BRIDGING SECTION
SCALE: 1:10



COARSE VEGETATION AND DEBRIS SCREEN DETAIL
SCALE: 1:10

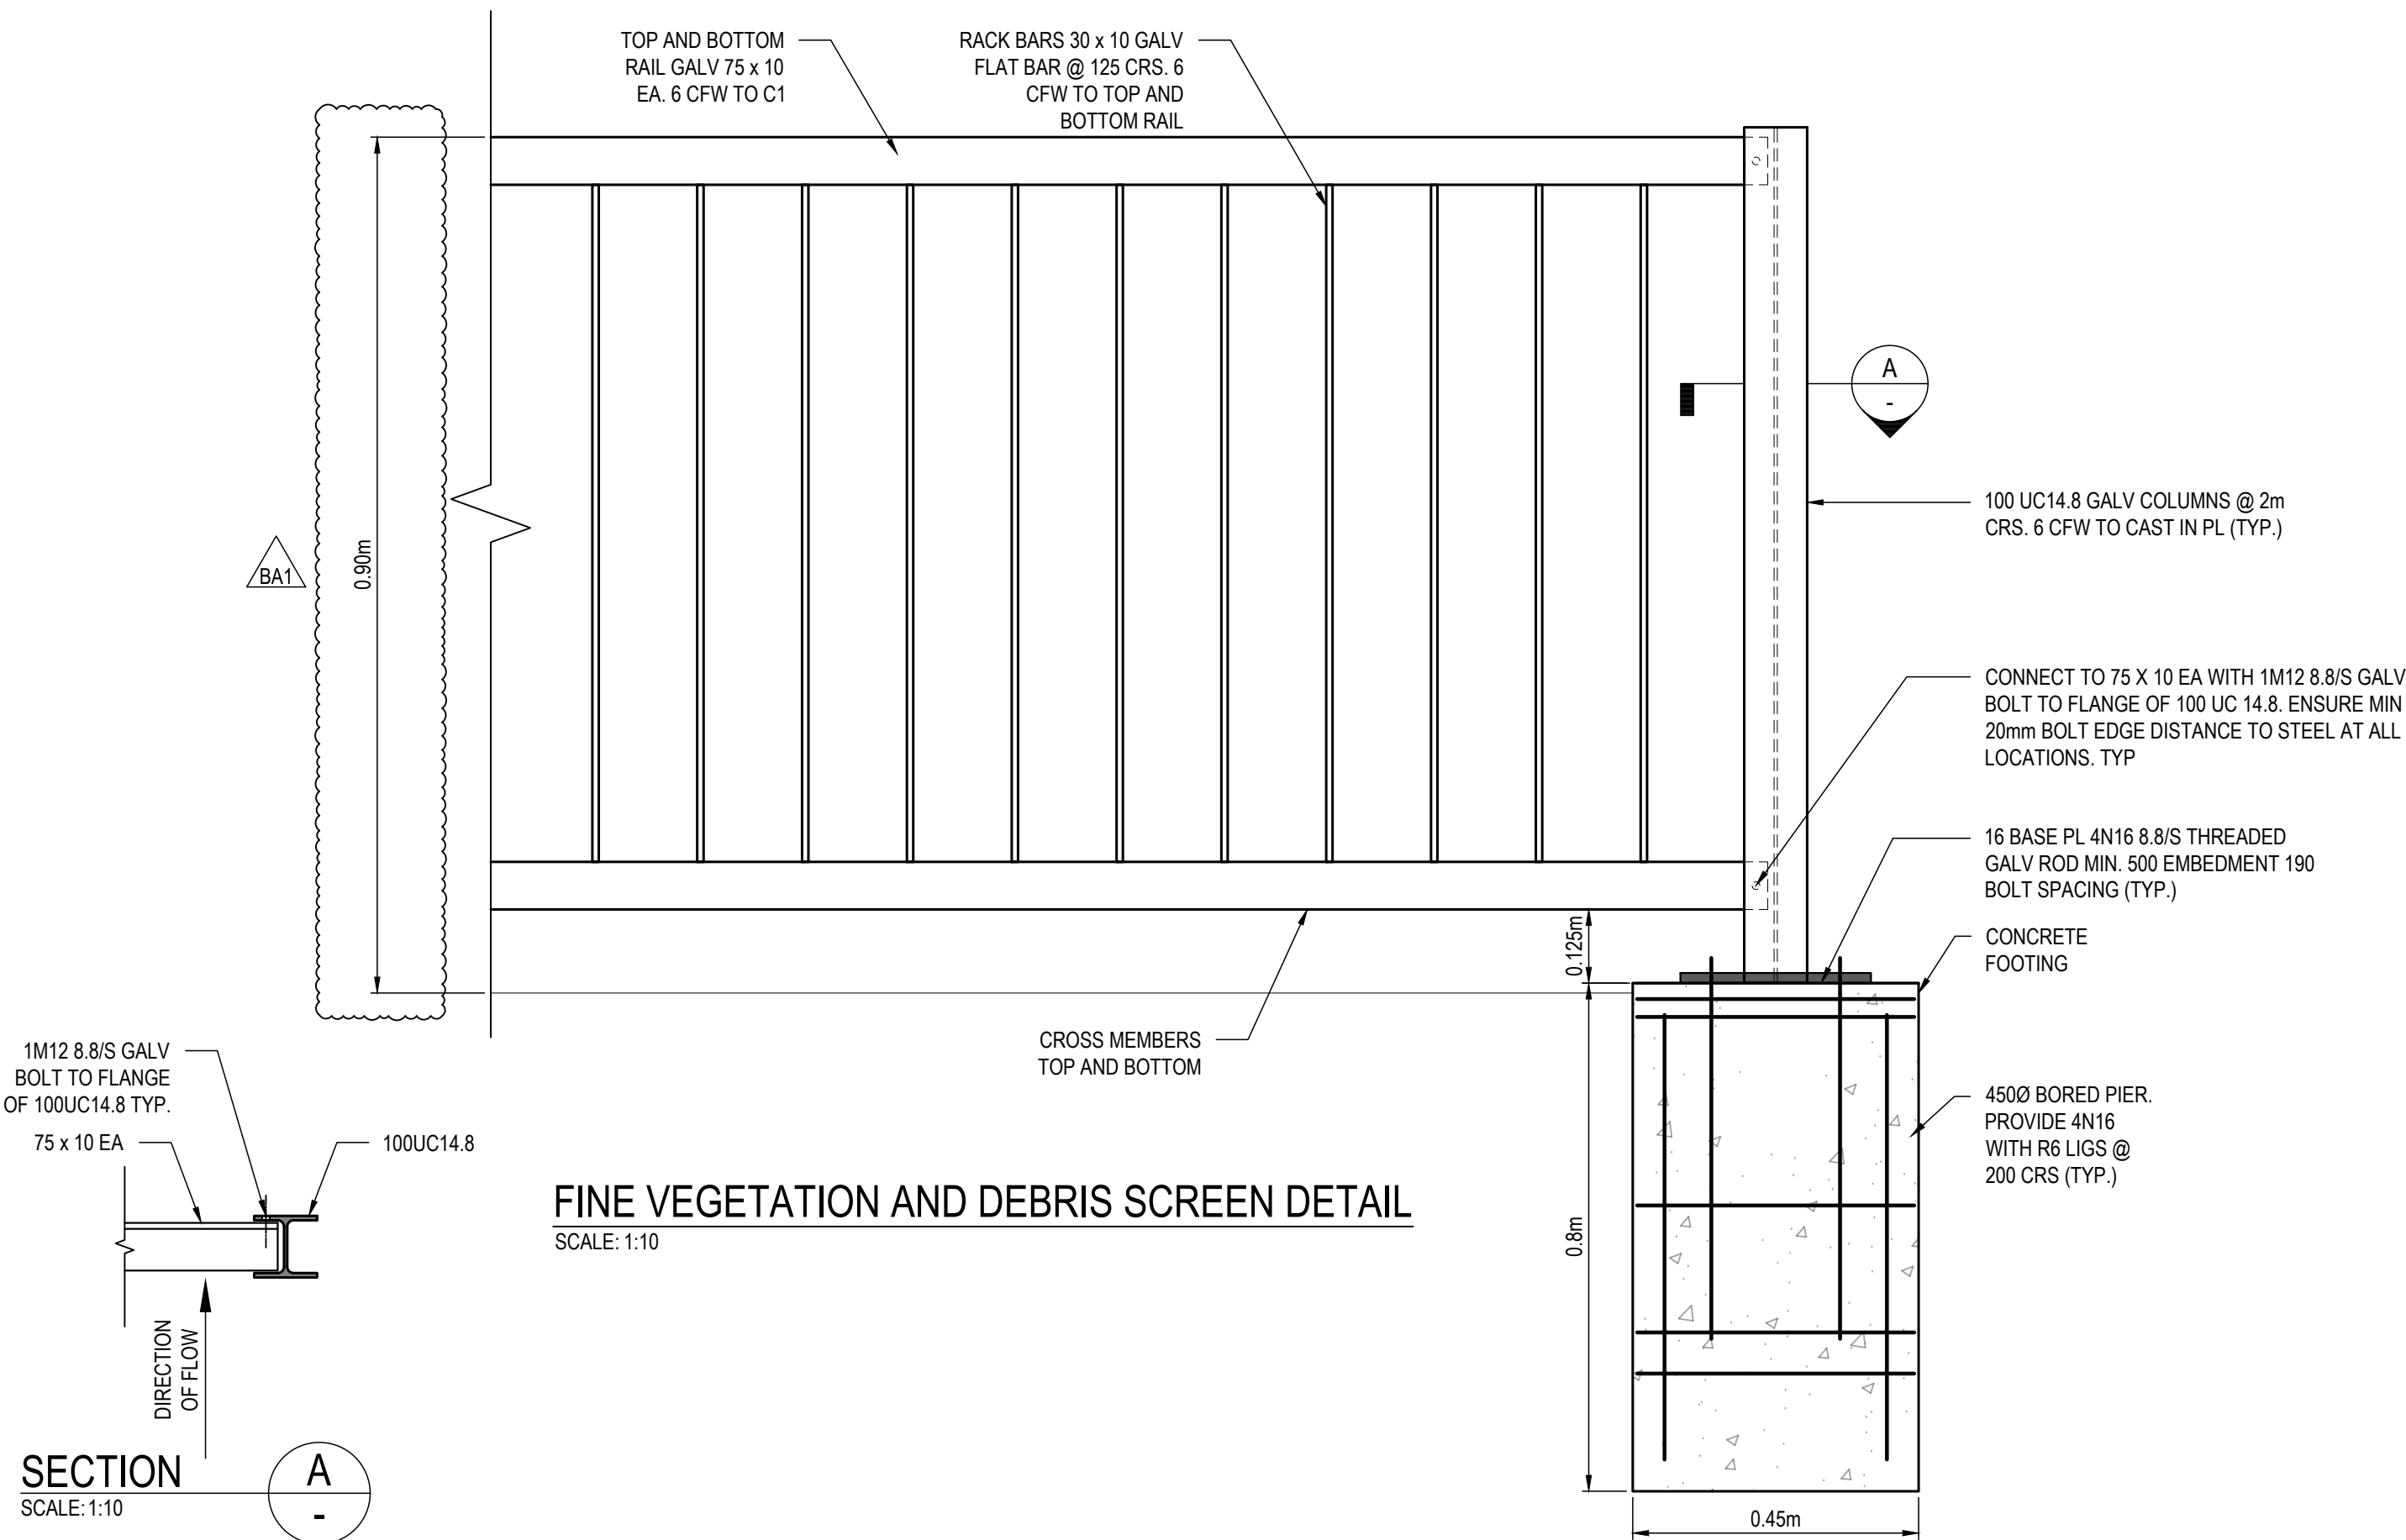

FINE VEGETATION AND DEBRIS SCREEN DETAIL
SCALE: 1:10

BA2	15/04/2025	REVISED SCOUR LOCATION
BA	19/03/2025	REVISED BUILDING APPROVAL
BA	22/05/2024	BUILDING APPROVAL ISSUE
P2	08/03/2024	CLIENT REVIEW ISSUE
P1	04/03/2024	PRELIMINARY ISSUE
REV	DATE	REMARK
SAFETY IN DESIGN REPORT PER WHS REGULATIONS		
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PROJECT
GLENORCHY CITY COUNCIL,
REDLANDS DRIVE ROSETTA
DEBRIS BASIN

TITLE
STRUCTURAL DETAILS
SHEET 1

Accepted	MJR	Date	15/04/2025
(Discipline Head)			
Accepted	MJR	Date	15/04/2025
(Team Leader)			
Approved	CJM	Date	15/04/2025
(Principal)			

AS SHOWN	MJR	TCM
PLOT DATE	16/04/2025	



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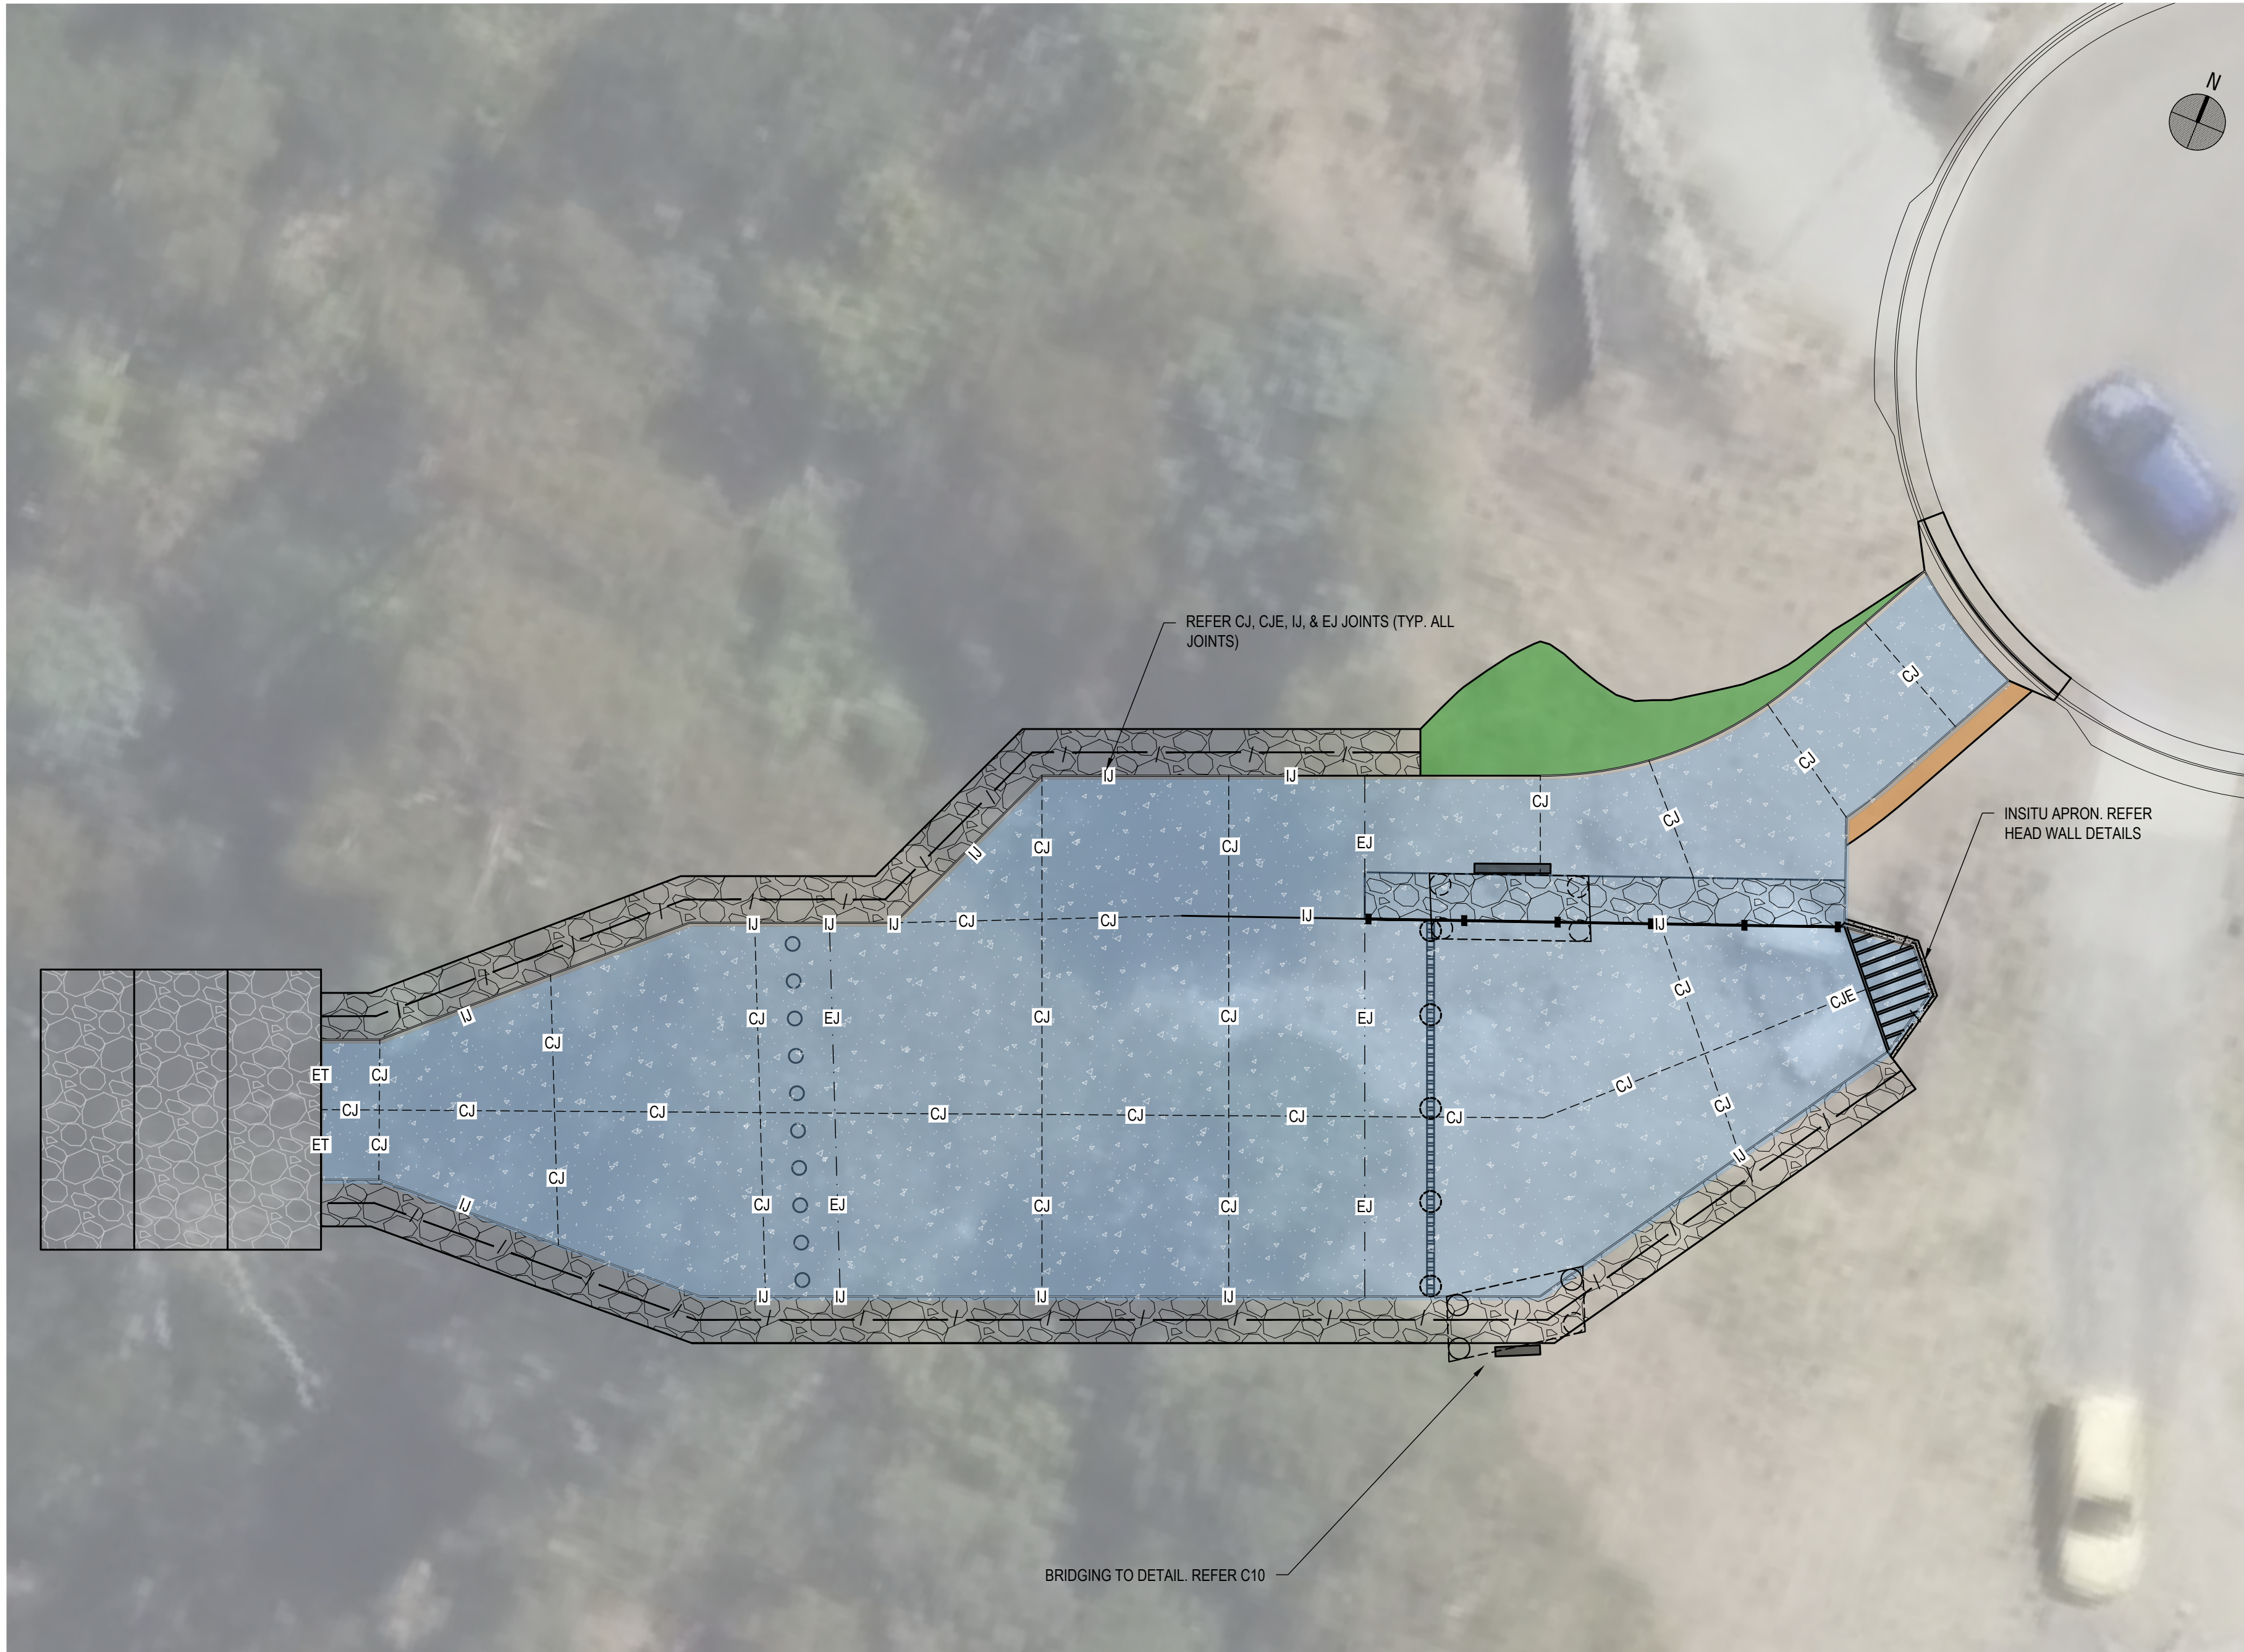
PLOT DETAILS J230352CS-C-DETAILS.DWG

PROJECT NO. 230352CS



DWG NO. C10 REVISION BA2

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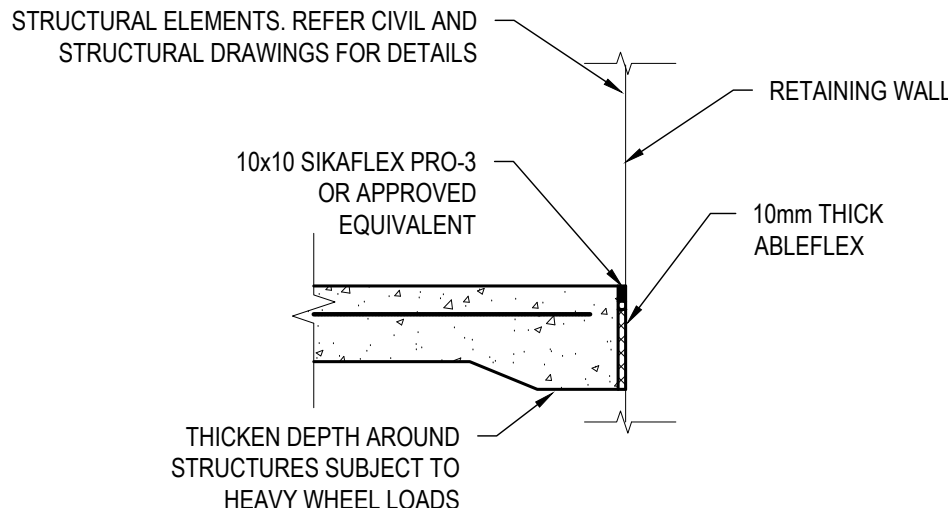


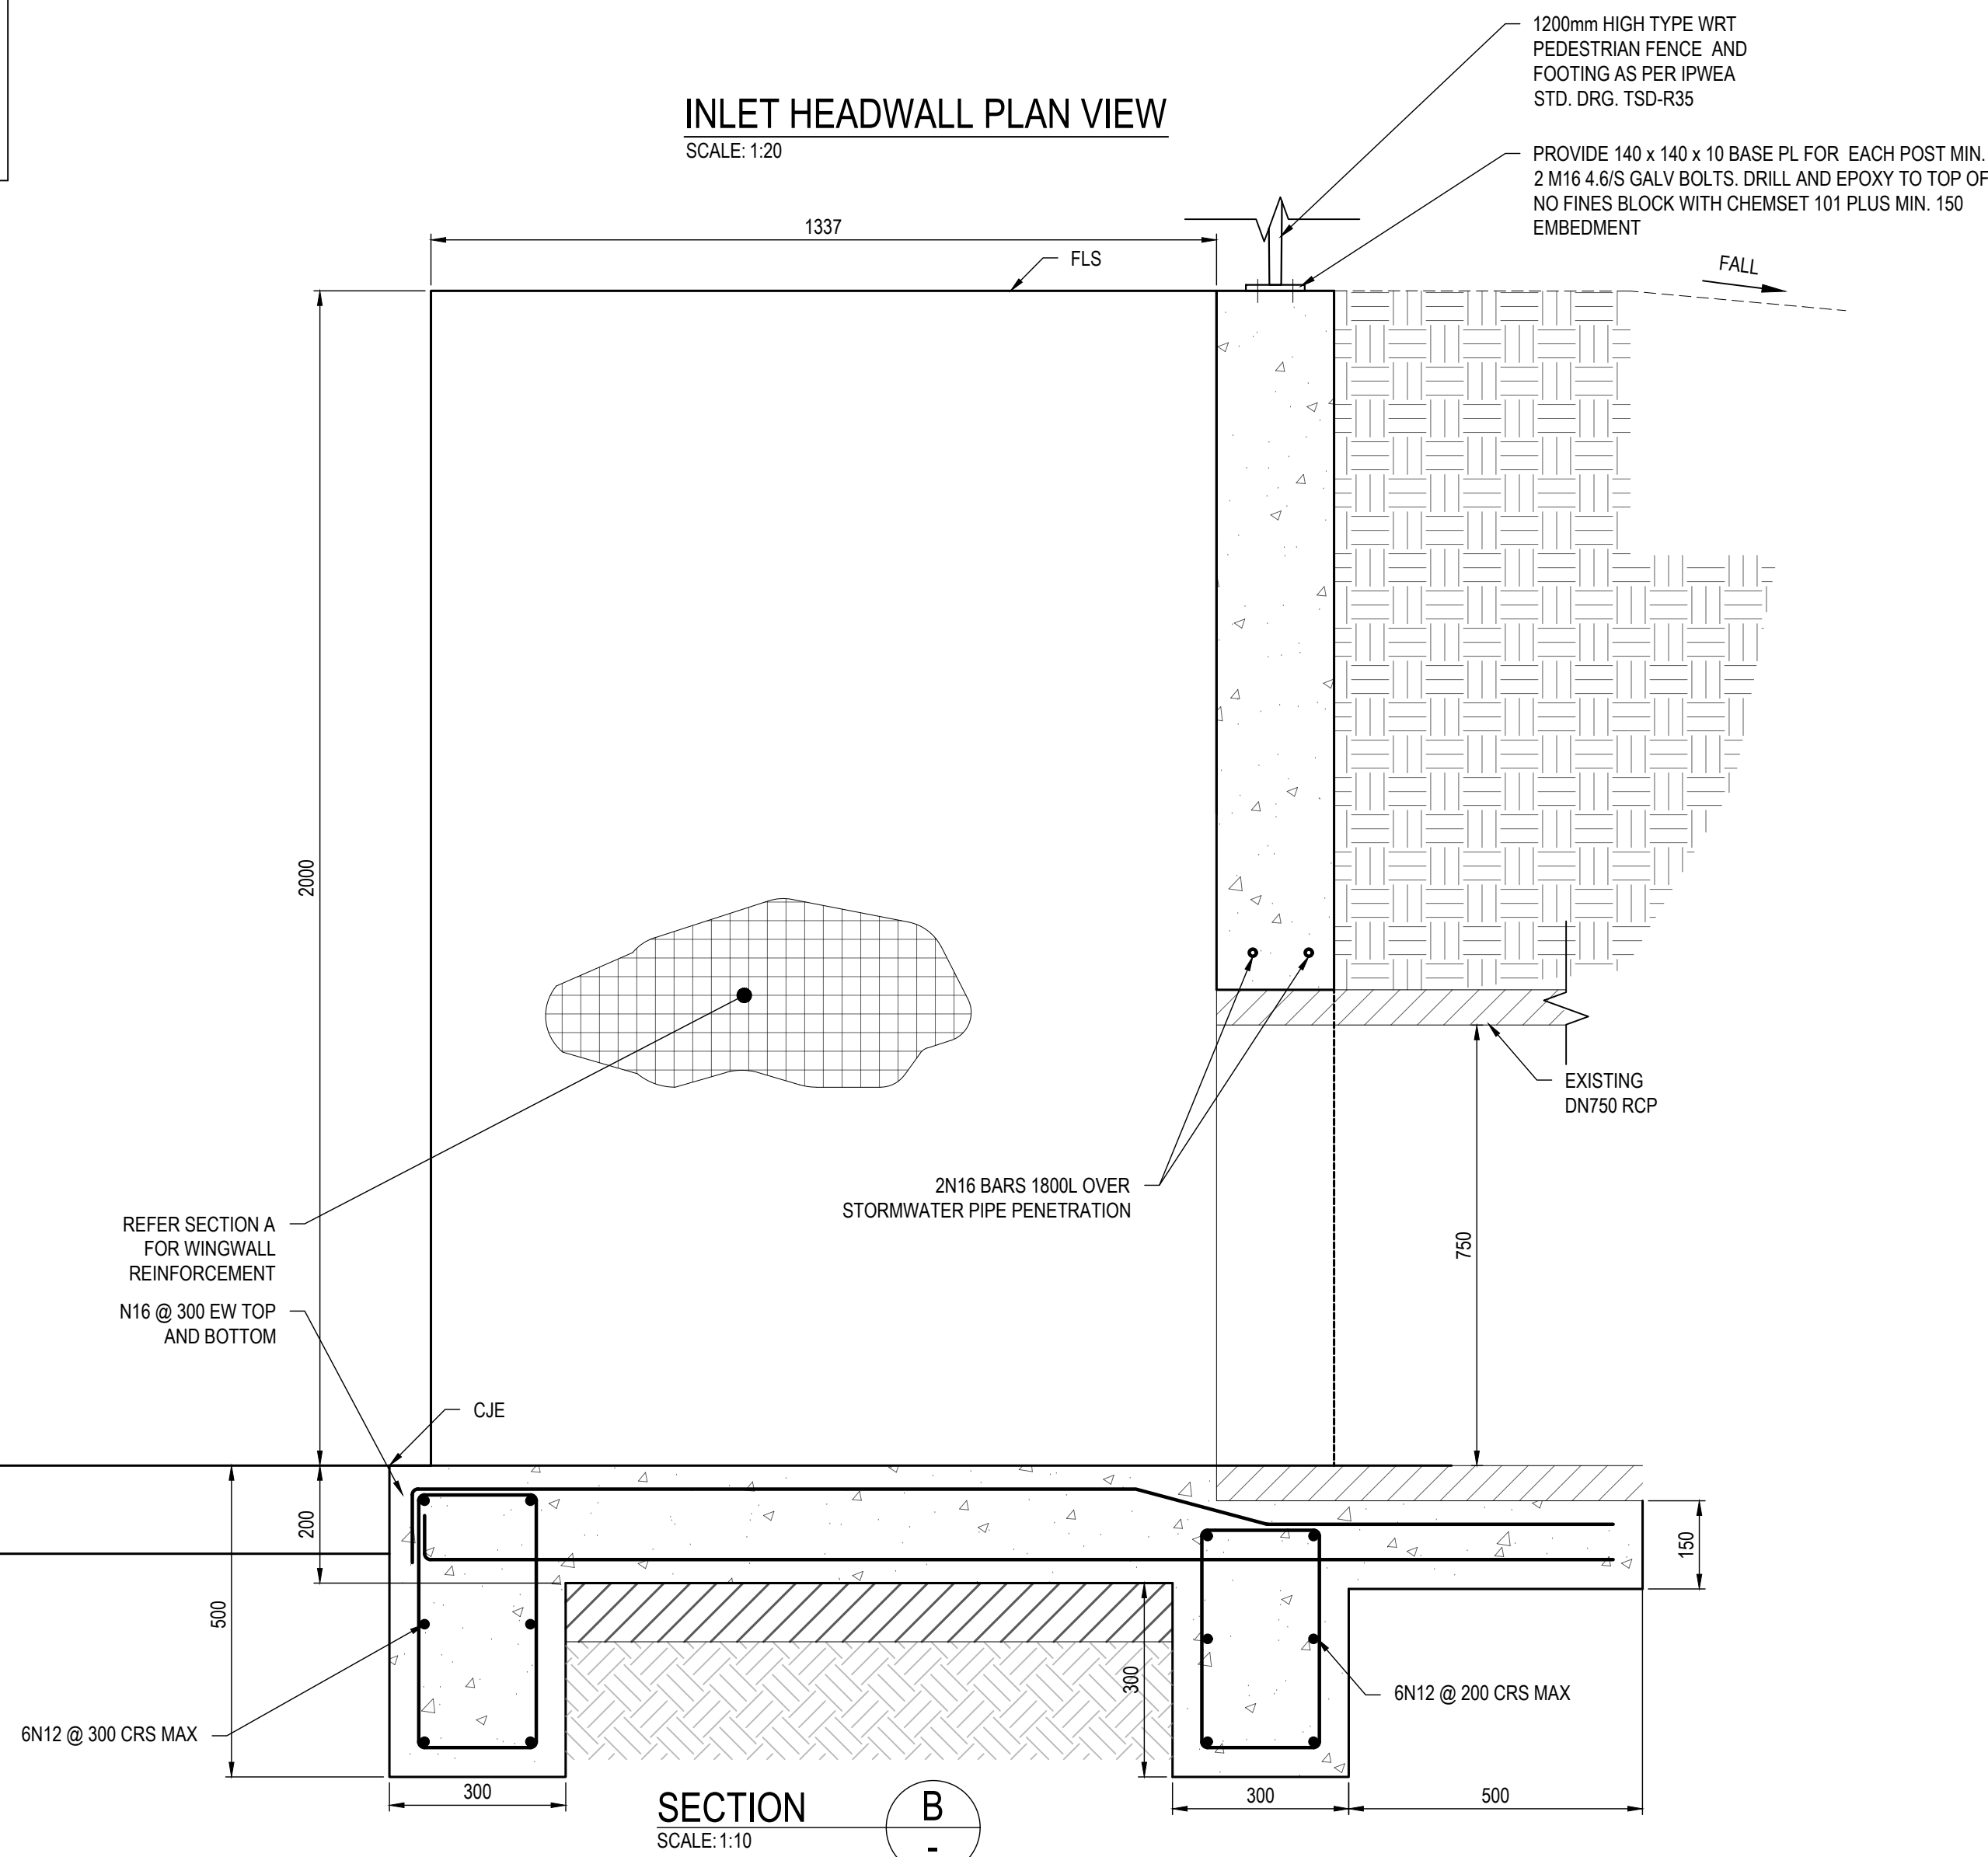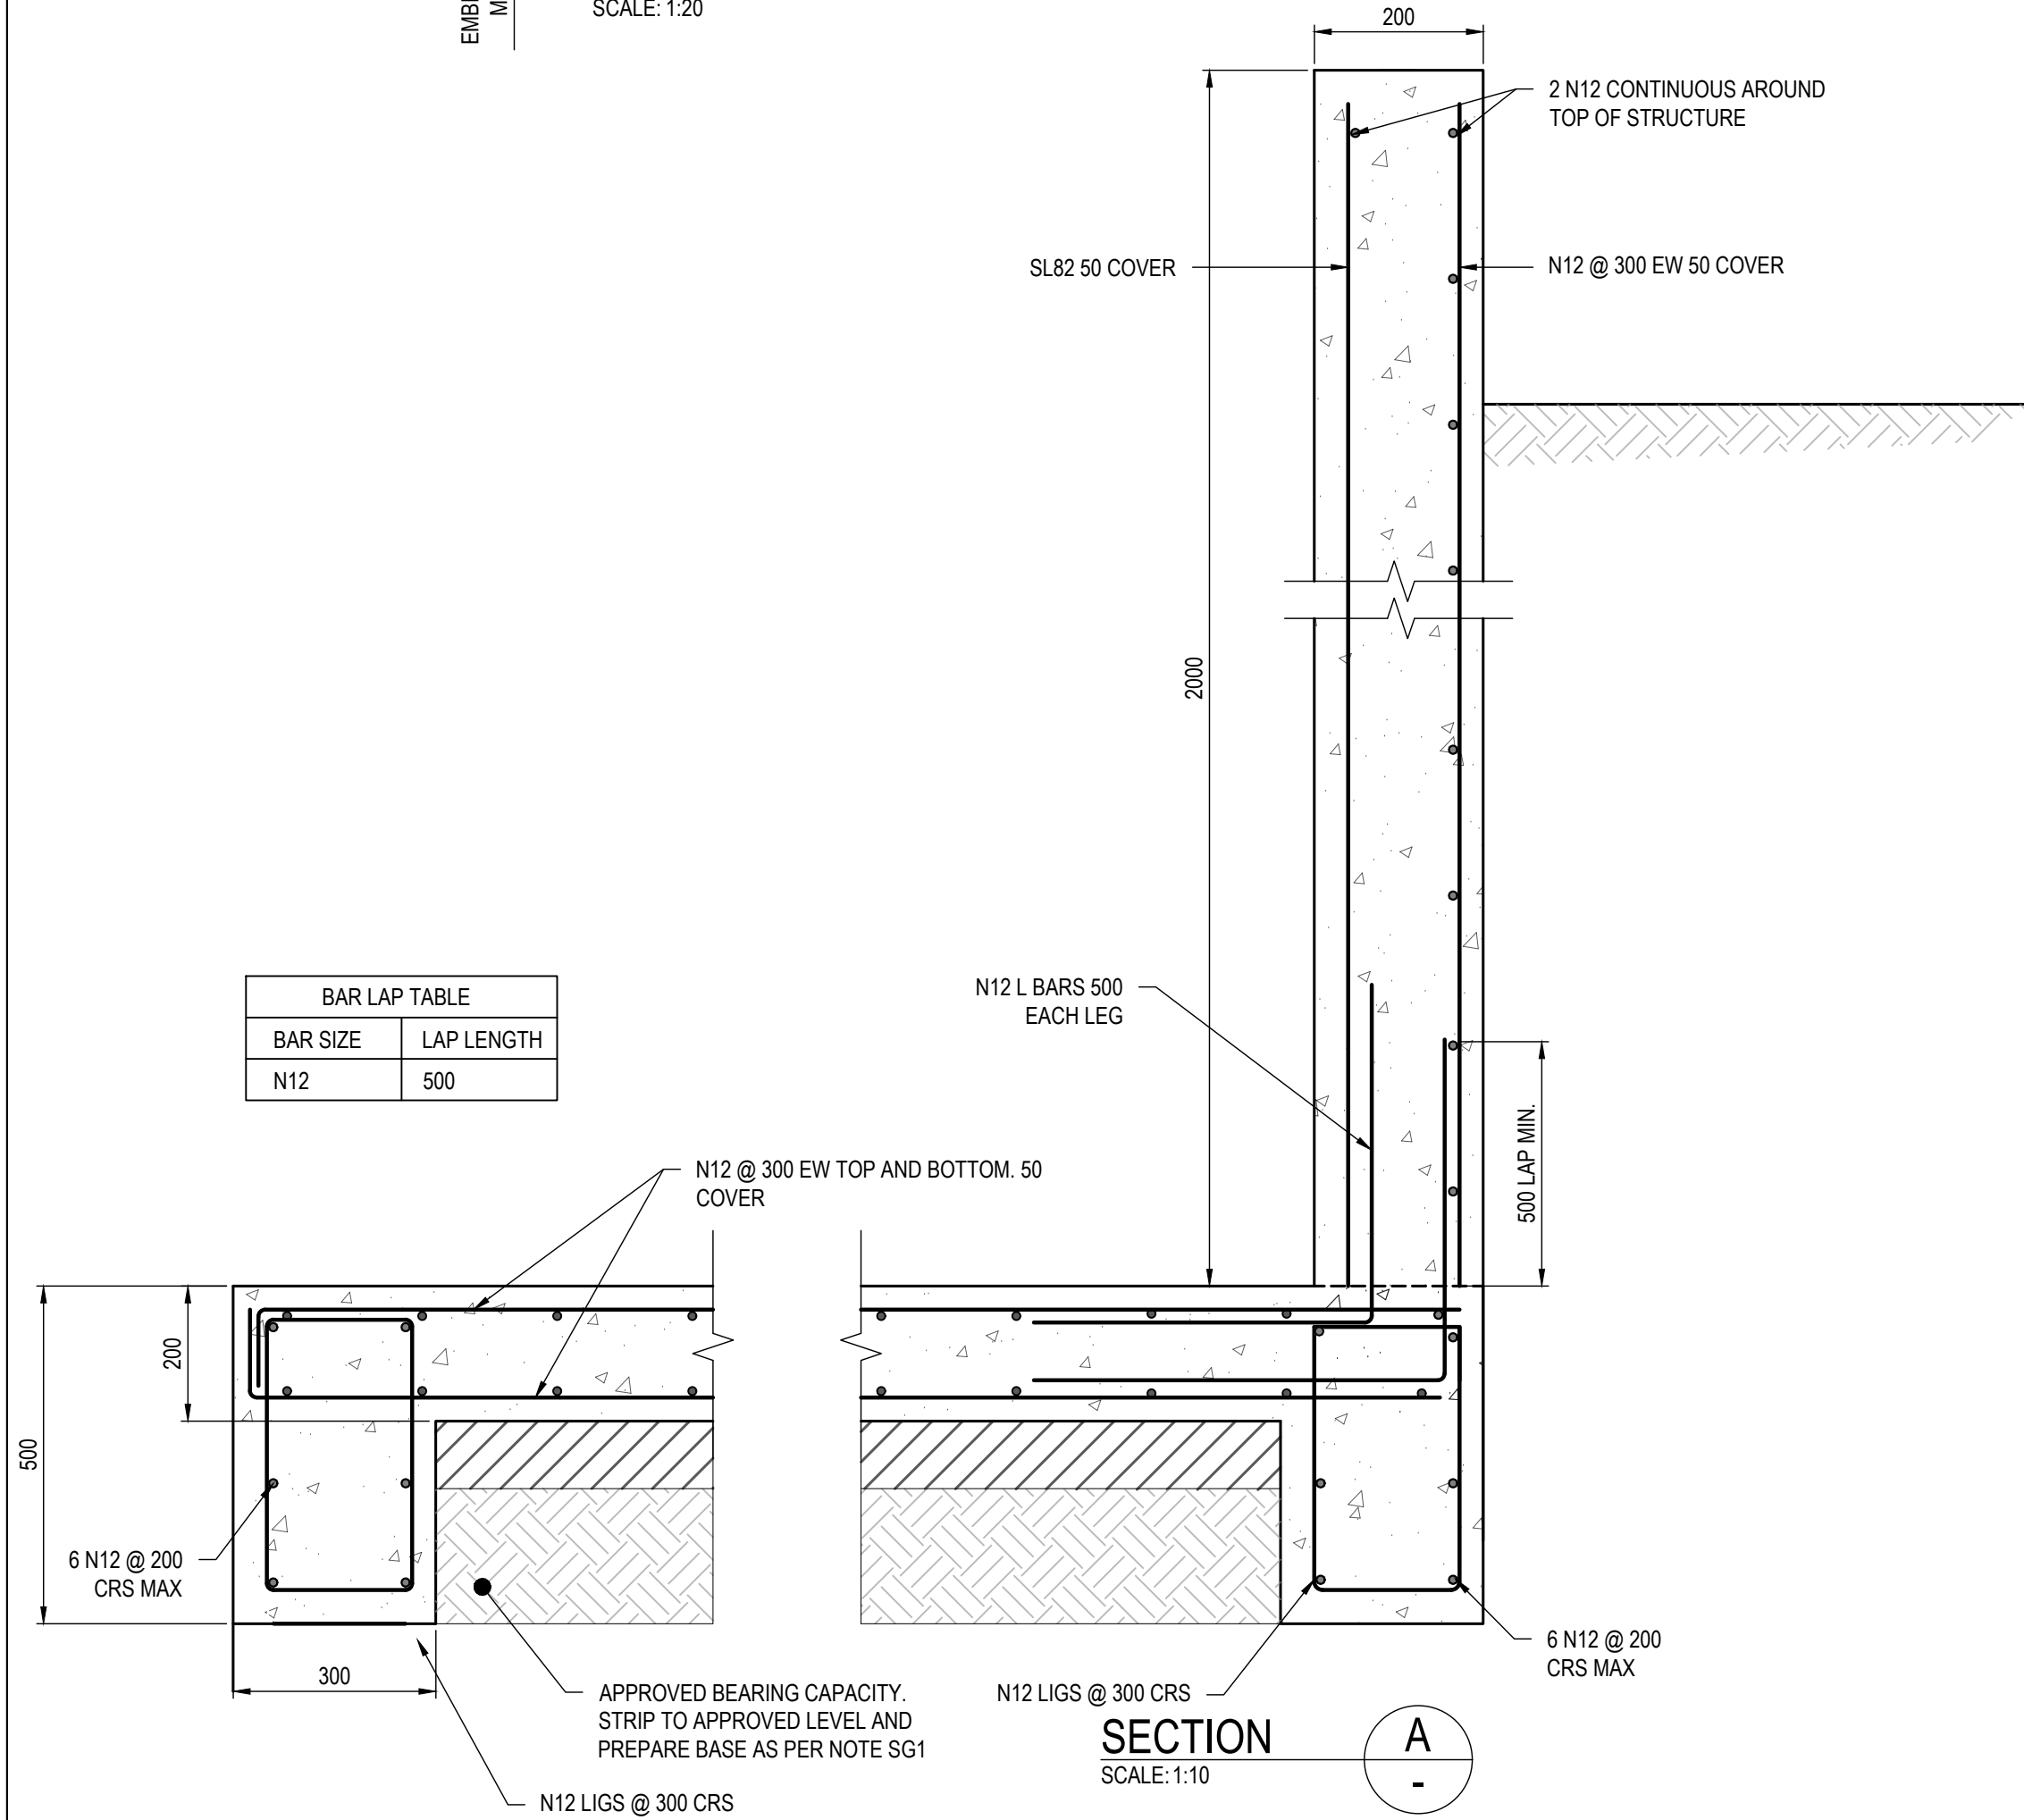


JOINTING PLAN
SCALE: 1:100

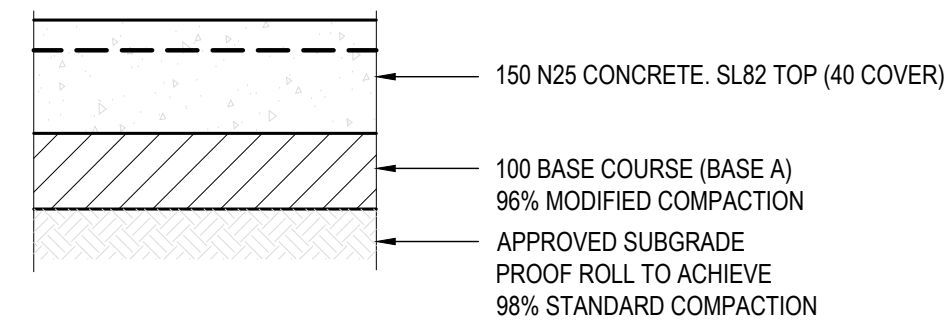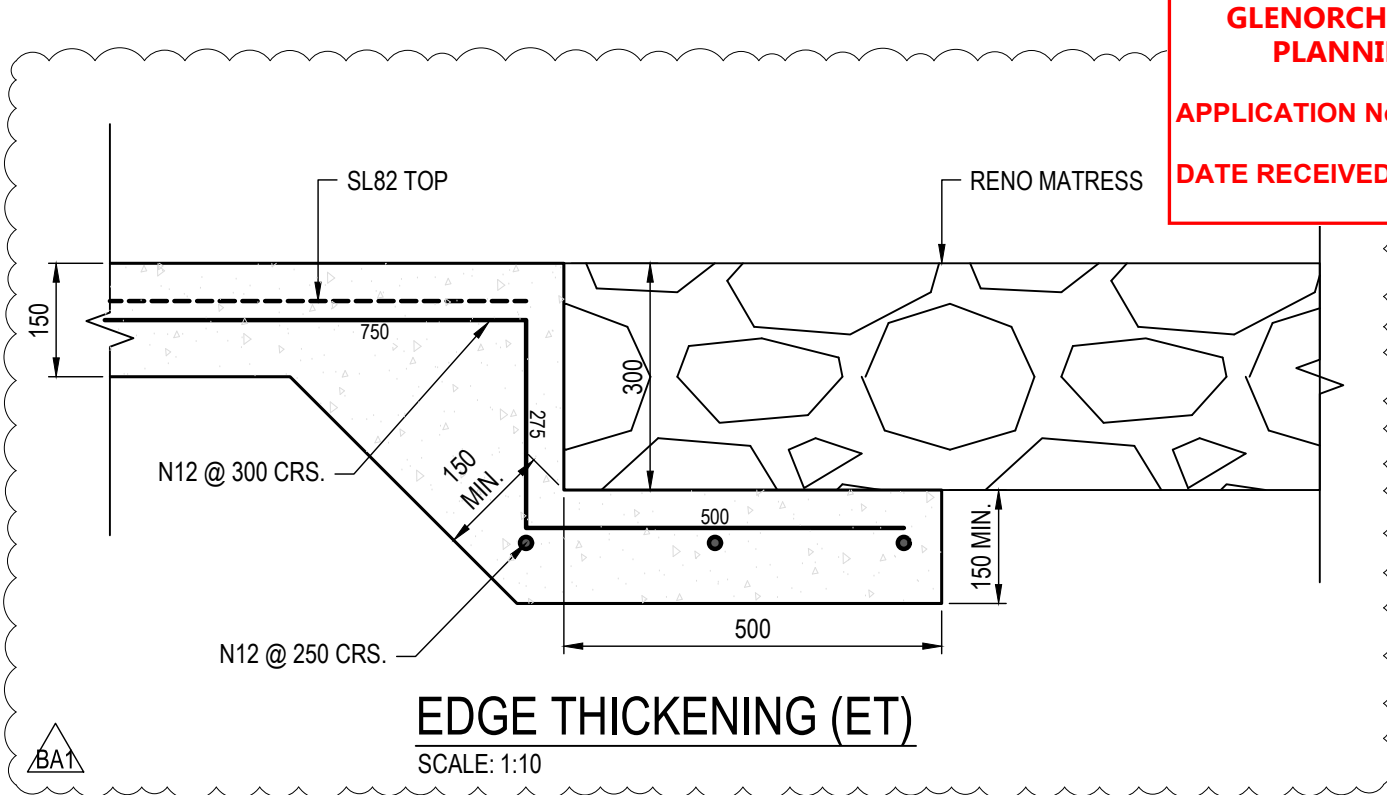


NOTE: PROVIDE CONTROL JOINTS (CJ) AT MAX. 4m CENTRES
CONCRETE BASIN SLAB DETAIL
SCALE: 1:10




ISOLATION JOINT (IJ)
SCALE 1:10

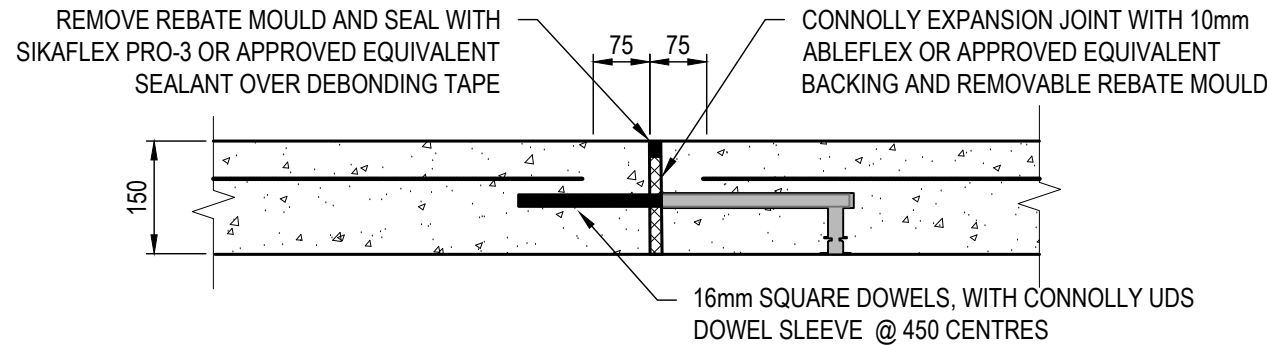

EXPANSION JOINT (EJ) WITHIN CONTINUOUS POUR
SCALE 1:10

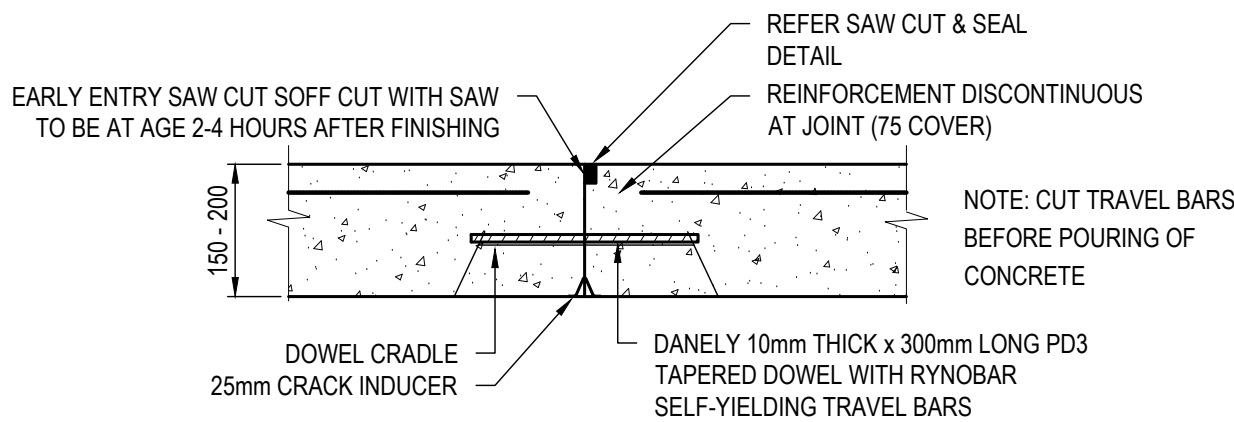

CONTRACTION JOINT (CJ)
FOR CONTINUOUS POUR
SCALE 1:10

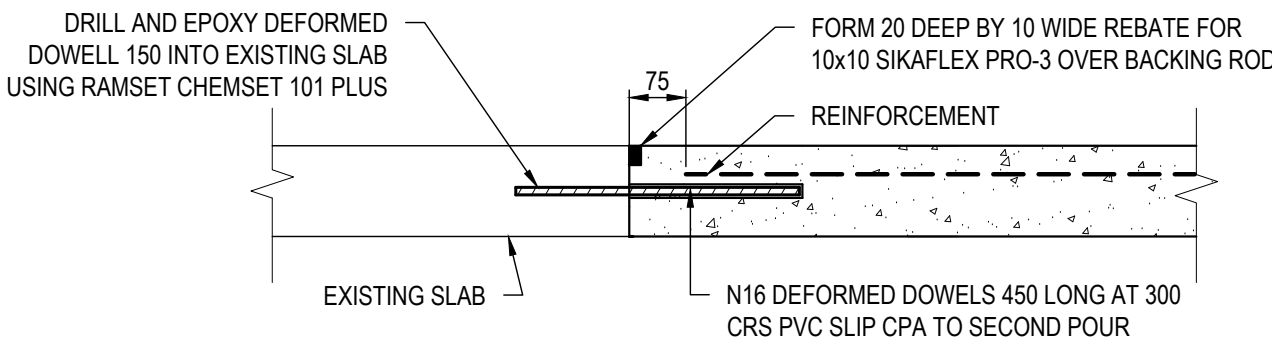

CONCRETE JOINT WITH EXISTING SLAB (CJE)
SCALE 1:10

BA	19.03.2025	REVISED BUILDING APPROVAL
BA	22.05.2024	BUILDING APPROVAL ISSUE
P2	08.03.2024	CLIENT REVIEW ISSUE
P1	04.03.2024	PRELIMINARY ISSUE
REV	DATE	REMARK
SAFETY IN DESIGN REPORT PER WHS REGULATIONS		
The following table shows the status of this design have been identified.		
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PROJECT
**GLENORCHY CITY COUNCIL,
REDLANDS DRIVE ROSETTA
DEBRIS BASIN**

TITLE
JOINTING PLAN

Accepted MJR	Date 19.03.2025
Accepted MJR	Date 19.03.2025
Approved CUM	Date 19.03.2025

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1:100	MJR	TCM
	PLOT DATE	16/04/2025

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PLOT DETAILS J230352CS-D-PAVEMENT PLAN.DWG

PROJECT NO. **230352CS**

DWG NO.	REVISION
C12	BA1

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GENERAL

- CONTRACTOR TO CONFIRM ONSITE THE SIZE OF EXISTING MSCL MAIN PRIOR TO ANY CONSTRUCTION WORKS, INCLUDING FABRICATION OF NEW MAIN, BEING UNDERTAKEN. IF DISCREPANCIES TO DESIGN DOCUMENTATION ARE FOUND, SUPERINTENDENT TO BE NOTIFIED AND CONTRACTOR TO AWAIT FURTHER INSTRUCTION FROM SUPERINTENDENT PRIOR TO PROCEEDING.
- THE CONTRACTOR WILL PROVIDE THE FOLLOWING STEEL PIPE AND FITTINGS:
 - OD559 X 5mm WALL THICKNESS, SINTAKOTE MSCL PIPE (WITH INTERNAL SEAL COAT).
 - ONE (1) 13.5M EFFECTIVE LENGTH OF PLAIN END
 - ONE (1) 12.2M EFFECTIVE LENGTH OF PLAIN END
 - ONE (1) 6m LENGTH OF OD180 PE PN16 PIPE.
 - ONE (1) DN150 PN16 FL-FL GATE VALVE WITH SPINDLE RISER AND TRAFFICABLE VALVE BOX.
 - TWO (2) OD180 PN16 STUB FLANGED 90° BENDS
 - ONE (1) OD180 PN16 STUB FLANGE AND BACKING PLATE
- IT IS THE CONTRACTORS RESPONSIBILITY TO APPLY FOR AND OBTAIN ALL REQUIRED PERMITS AND APPROVALS SUCH AS TASWATER COW AND PERMIT TO CONSTRUCT PRIOR TO THE COMMENCEMENT OF WORKS.
- THE CONTRACTOR SHALL PROVIDE A CONSTRUCTION MANAGEMENT PLAN (CMP) DETAILING HOW THE WORKS ARE TO BE UNDERTAKEN WITH DUE CONSIDERATION TO ONGOING OPERATIONS, SAFETY AND THE ENVIRONMENT. THE PLAN SHALL INCLUDE COMMISSIONING AND CUT OVER AND BE PREPARED WITH INPUT FROM TASWATER OPERATIONS AND BE APPROVED BY THE PROJECT MANAGER.
- IT IS THE CONTRACTORS RESPONSIBILITY TO PROVIDE TRAFFIC AND PEDESTRIAN MANAGEMENT DURING THE WORKS.
- REFER TO TASWATER CDO DOCUMENTATION FOR ENVIRONMENTAL AND NATURAL VALUE DETAILS INCLUDING CONTRACTOR REQUIREMENTS FOR THE DEVELOPMENT, IMPLEMENTATION AND RECORDING OF MANAGEMENT PLANS FOR:
 - WEED PESTS AND DISEASE
 - FLORA AND FAUNA
 - SOIL MANAGEMENT
 - EROSION AND SEDIMENT CONTROL
 - UNANTICIPATED FINDS
 - MACHINERY, PLANT AND VEHICLE CLEAN-DOWN
- ALL WORKS SHALL BE UNDERTAKEN IN ACCORDANCE WITH TASWATERS ENVIRONMENTAL REQUIREMENTS RELATING TO TOP SOIL MANAGEMENT, EROSION AND SEDIMENT CONTROL, WEED CONTROL, FLORA AND FAUNA MANAGEMENT
- THE LOCATION AND DEPTH OF ALL EXISTING SERVICES SHALL BE IDENTIFIED AND PROVEN ON-SITE PRIOR TO COMMENCING EXCAVATIONS.
- PROPRIETARY PRODUCTS ARE TO BE INSTALLED IN ACCORDANCE WITH THE MANUFACTURER'S WRITTEN INSTRUCTIONS.
- STEEL PIPE TO BE INSTALLED IN ACCORDANCE WITH MANUFACTURERS INSTRUCTIONS - REFER 'SINTAKOTE STEEL PIPELINE SYSTEMS HANDLING & INSTALLATION' GUIDELINE AVAILABLE FROM STEELMAINS.
- STEEL PIPE COATINGS SHALL BE TESTED FOR DEFECTS USING A 'SPARK TESTER' WITH A VOLTAGE OF 12kv IMMEDIATELY PRIOR TO INSTALLATION IN THE TRENCH. TESTING SHALL BE CARRIED OUT IN ACCORDANCE WITH AS 3894.1.
- COATING DEFECTS SHALL BE REPAIRED IN ACCORDANCE WITH THE PIPE MANUFACTURERS RECOMMENDATIONS AND TO THE APPROVAL OF THE SUPERINTENDENT.
- WELDING AND NON DESTRUCTIVE TESTING SHALL BE CARRIED OUT IN ACCORDANCE WITH CLAUSE "WELDING OF STEEL PIPELINES" IN PART 2 OF WSA03, MRWA EDITION.
- STEEL PIPE SPECIALS SHALL BE PLAIN ENDS UNO, BE MANUFACTURED USING THE PIPE SUPPLIED IN ACCORDANCE WITH THE DIMENSIONS SHOWN ON THE DRAWINGS AND WITH CLAUSE "FABRICATION OF STEEL FITTINGS" IN PART 2 OF WSA03, MRWA EDITION. PROTECTIVE EXTERNAL COATINGS SHALL BE REINSTATED USING RAYCHEM WPCB HEAT SHRINK SLEEVES. CEMENT MORTAR LINING TO BE REINSTATED IN ACCORDANCE WITH MANUFACTURERES INSTRUCTIONS.
- CORROSION PROTECTION AT JOINTS OF PIPES SHALL BE IN ACCORDANCE WITH DWG MRWA-W-400.
- ALL FLANGES ARE TO BE DRILLED TO AS4087 CLASS 16 U.N.O. GASKETS TO BE COMPOSITE FIBRE 1.5mm THICK TEADIT NA1000 C6327 OR EQUIVALENT
- GATE VALVES SHALL BE RESILIENT SEATED SLUICE VALVES TO AS2638.2 RATED TO MINIMUM CLASS PN16
- ALL REDUNDANT PIPE TO BE FULLY REMOVED
- A DETECTABLE MARKER TAPE WITH THE WORDING 'WATER MAIN' SHALL BE PLACED OVER ALL WATER MAINS FOR FULL LENGTH ON TOP OF THE BEDDING.
- CONTRACTOR TO AVOID PLACEMENT OF LOAD (INCLUDING VEHICLE TRAFFIC) OVER EXISTING TRUNK MAIN WHILE IT IS IN SERVICE. PROVIDE ADEQUATE TEMPORARY PROTECTION OVER THE MAIN IF CROSSING THE TRUNK MAIN IS NECESSARY.
- CONTRACTOR IS ADVISED THAT EXISTING PIPE COATING MAY CONTAIN ASBESTOS AND SHALL INVESTIGATE THIS PRIOR TO CONDUCTING THE WORK. IF ASBESTOS IS PRESENT THE CONTRACTOR SHALL HANDLE APPROPRIATELY.
- CLEAN, DISINFECT AND PRESSURE TEST ALL PIPEWORK IN ACCORDANCE WITH WSA STANDARD SPECIFICATION CONSTRUCTION CLAUSE 19 PRIOR TO CONNECTION TO EXISTING INFRASTRUCTURE. ALL PIPELINES MUST BE INSPECTED BY TASWATER PRIOR TO BACKFILL. FOLLOWING BACKFILL PRESSURE TEST TO 1500kpa AT THE LOW POINT OF THE SYSTEM FOR A MINIMUM 2 HOURS. PIPELINE DESIGN PRESSURE IS 900Kpa. CONTRACTOR TO FURNISH ANY TEMPORARY FITTINGS WITH PRESSURE GAUGE, FILLING AND AIR RELEASE APPURTENANCES FOR HYDROTESTING. CONTRACTOR TO PROVIDE ADEQUATE TEMPORARY RESTRAINTS AT PIPE ENDS FOR THE HYDROTEST. ANY DEFECTS FOUND DURING TESTING ARE TO BE REPAIRED BY THE CONTRACTOR AT THEIR EXPENSE.
- CONNECTIONS TO EXISTING TASWATER INFRASTRUCTURE TO BE PERFORMED BY AN ACCREDITED TASWATER CONTRACTOR AT CONTRACTORS COST UNLESS SPECIFIED OTHERWISE BY TASWATER. CONTRACTOR IS RESPONSIBLE FOR CO-ORDINATION OF ALL WORKS WITH TASWATER.
- THE CONTRACTOR SHALL ENSURE THAT WATER MAINS INCLUDING ALL TEES, BENDS, VALVES AND PROPERTY CONNECTION LINES ARE LEFT EXPOSED UNTIL SUCH TIME AS THEY HAVE BEEN LOCATED BY THE SURVEYOR UNDERTAKING THE AS CONSTRUCTED SURVEY. THE SURVEYOR SHALL BE PROVIDED WITH AT LEAST 48hrs ADVANCE NOTICE TO ALLOW THEM TO ATTEND THE SITE. FAILURE TO DO SO MAY RESULT IN THE CONTRACTOR HAVING TO RE-EXPOSE ALL PIPEWORK TO ALLOW ACCURATE PICK UP OF THE SERVICE.
- WHERE MANAGED BY THE THE CONTRACTOR, THE CONTRACTOR SHALL ENSURE THE AS-CONSTRUCTED DRAWINGS, SURVEY & CONTROL AND DATA COLLECTION IS UNDERTAKEN AND PROVIDED TO TASWATER IN ACCORDANCE WITH TASWATERS ASSET SPATIAL DATA SPECIFICATION

BACKFILL MATERIAL

TYPE 1 - BACKFILL MATERIAL FOR TRAFFICABLE AREA

PLACE AND COMPACT FULL DEPTH (FROM TOP OF PIPE EMBEDMENT (LO) TO EXISTING SURFACE LEVELS) WITH 20MM COMPACTED FINE CRUSHED ROCK (BASE CLASS A) CONSOLIDATED IN LAYERS NO GREATER THAN 200MM LOOSE TO ACHIEVE THE MINIMUM 95% OF MAXIMUM DRY DENSITY RATIO TO AS1289.5.1.1

REINSTATE SURFACE AS FOLLOWS:

FINISHED SURFACE LEVELS TO MATCH EXISTING SURFACE LEVELS PRIOR TO EXCAVATION UNLESS NOTED OTHERWISE TO ALLOW FOR FUTURE TRIMMING AND PAVEMENT CONSTRUCTION.

PIPE BEDDING & EMBEDMENT MATERIAL

TYPE A: TO BE 20MM CEMENT TREATED CLASS 3 FCR. EMBEDMENT MATERIAL SHALL BE COMPACTED IN MAXIMUM 150MM LAYERS TO ACHIEVE A MINIMUM 95% OF MAXIMUM DRY DENSITY RATIO TO AS1289.5.1.1

- FOR EXCAVATIONS >1.5M DEEP PROVIDE BENCHING OR SHORING WHERE REQUIRED.
- MINIMUM COVER AND CLEARANCE FOR ANY SERVICE RELOCATION WORKS TO BE IN ACCORDANCE WITH THE RELEVANT AUTHORITIES STANDARD REQUIREMENTS.
- WAVELAY DETECTABLE UNDERGROUND WARNING TAPE (TEXT AND COLOUR IN ACCORDANCE WITH AS2648.1:1995) OR SIMILAR APPROVED PRODUCT. INSTALLATION IN ACCORDANCE WITH WSA 04-2005-2.1
- SUBMIT TO THE SUPERINTENDENT TO THEIR USE, MATERIAL PROPERTIES AND SOURCE FOR ALL BEDDING, HAUNCHING, BACKFILL AND ROAD PAVEMENT MATERIALS. PAVEMENT MATERIALS SHALL COMPLY WITH THE REQUIREMENTS OF DSG SPECIFICATION R40 FOR BASE CLASS A AND SUB-BASE 1 MATERIALS.
- REINSTATE ALL GROUND SURFACES TO MATCH EXISTING. STOCKPILE STRIPPED TOPSOIL FOR SPREADING ON TRENCHES AND DISTURBED AREAS AND PROVIDE IMPORTED MATERIAL AS REQUIRED TO ENSURE MINIMUM TOPSOIL DEPTHS AS SHOWN ON THE DRAWINGS. TOPSOIL TO BE WEED FREE FROM AND SOURCE APPROVED BY THE PROJECT MANAGER. ALL EXCESS EXCAVATED MATERIAL SHALL BECOME THE PROPERTY OF THE CONTRACTOR AND SHALL BE DISPOSED OF OFF SITE AT THE

CONTRACTORS COST UNLESS APPROVED OTHERWISE BY THE PROJECT MANAGER.

COMMISSIONING


- THE CONTRACTOR SHALL COMPLETE THE SPECIFIED INSPECTIONS, ACCEPTANCE TESTS AND PROCEDURES BEFORE THE WORKS MAY BE CONNECTED TO THE EXISTING SYSTEM.
- ANY DEFECTS MUST BE REPAIRED BY THE CONTRACTOR AND THE INSPECTION AND/OR TEST REPEATED UNTIL THE PRINCIPAL IS SATISFIED THAT THE WHOLE OF THE WORKS MEETS THE TESTING REQUIREMENTS.
- ALL TESTS AND INSPECTIONS SHALL BE WITNESSED BY THE PRINCIPAL. THE CONTRACTOR SHALL GIVE THE PRINCIPAL TWO WEEKS' NOTICE OF ITS INTENTION TO PERFORM ANY TEST, SO THAT THE PRINCIPAL MAY ARRANGE TO ATTEND AND WITNESS THE TESTS.
- THE RESULTS OF ALL TESTS AND COMMISSIONING SHALL BE RECORDED AND SIGNED OFF BY THE CONTRACTOR AND WITNESSED BY THE PRINCIPAL. THE CONTRACTOR MUST PROVIDE ITS PROPOSED COMMISSIONING PLAN.

SURVEY CONTROL

- DATE OF SURVEY 11/11/2022 WITH FURTHER SURVEY AND POTHOLING UNDERTAKEN ON 07/07/2023 AND 12/02/2025.
- HORIZONTAL DATUM IS GDA2020 MGA ZONE 55
- VERTICAL DATUM IS AHD83
- WHILE REASONABLE EFFORT HAS BEEN MADE TO LOCATE ALL VISIBLE ABOVE GROUND SERVICES, THERE MAY BE OTHER SERVICES THAT WERE NOT LOCATED DURING THIESE SURVEYS


REFERENCED STANDARD DRAWINGS:

MRWA-W-201	PIPELINE EMBEDMENT AND TRENCH BACKFILL
MRWA-W-202	PIPE TRENCH DETAILS
MRWA-W-203	SPECIAL EMBEDMENT SYSTEMS
MRWA-W-208	SLOPING MAINS AND TRENCH DRAINAGE
MRWA-W-209	TRENCH BULKHEADS AND TRENCHSTOPS
MRWA-W-300	VALVE AND HYDRANT MARKING ARRANGEMENTS
MRWA-W-301	VALVE AND HYDRANT MARKING DETAILS
MRWA-W-302	VALVE SURFACE FITTINGS TRAFFICABLE & NON-TRAFFICABLE AREAS
MRWA-W-306B	FLANGE DETAILS AND FLANGE FASTENING REQUIREMENTS
MRWA-W-400	STEEL PIPELINE JOINTING

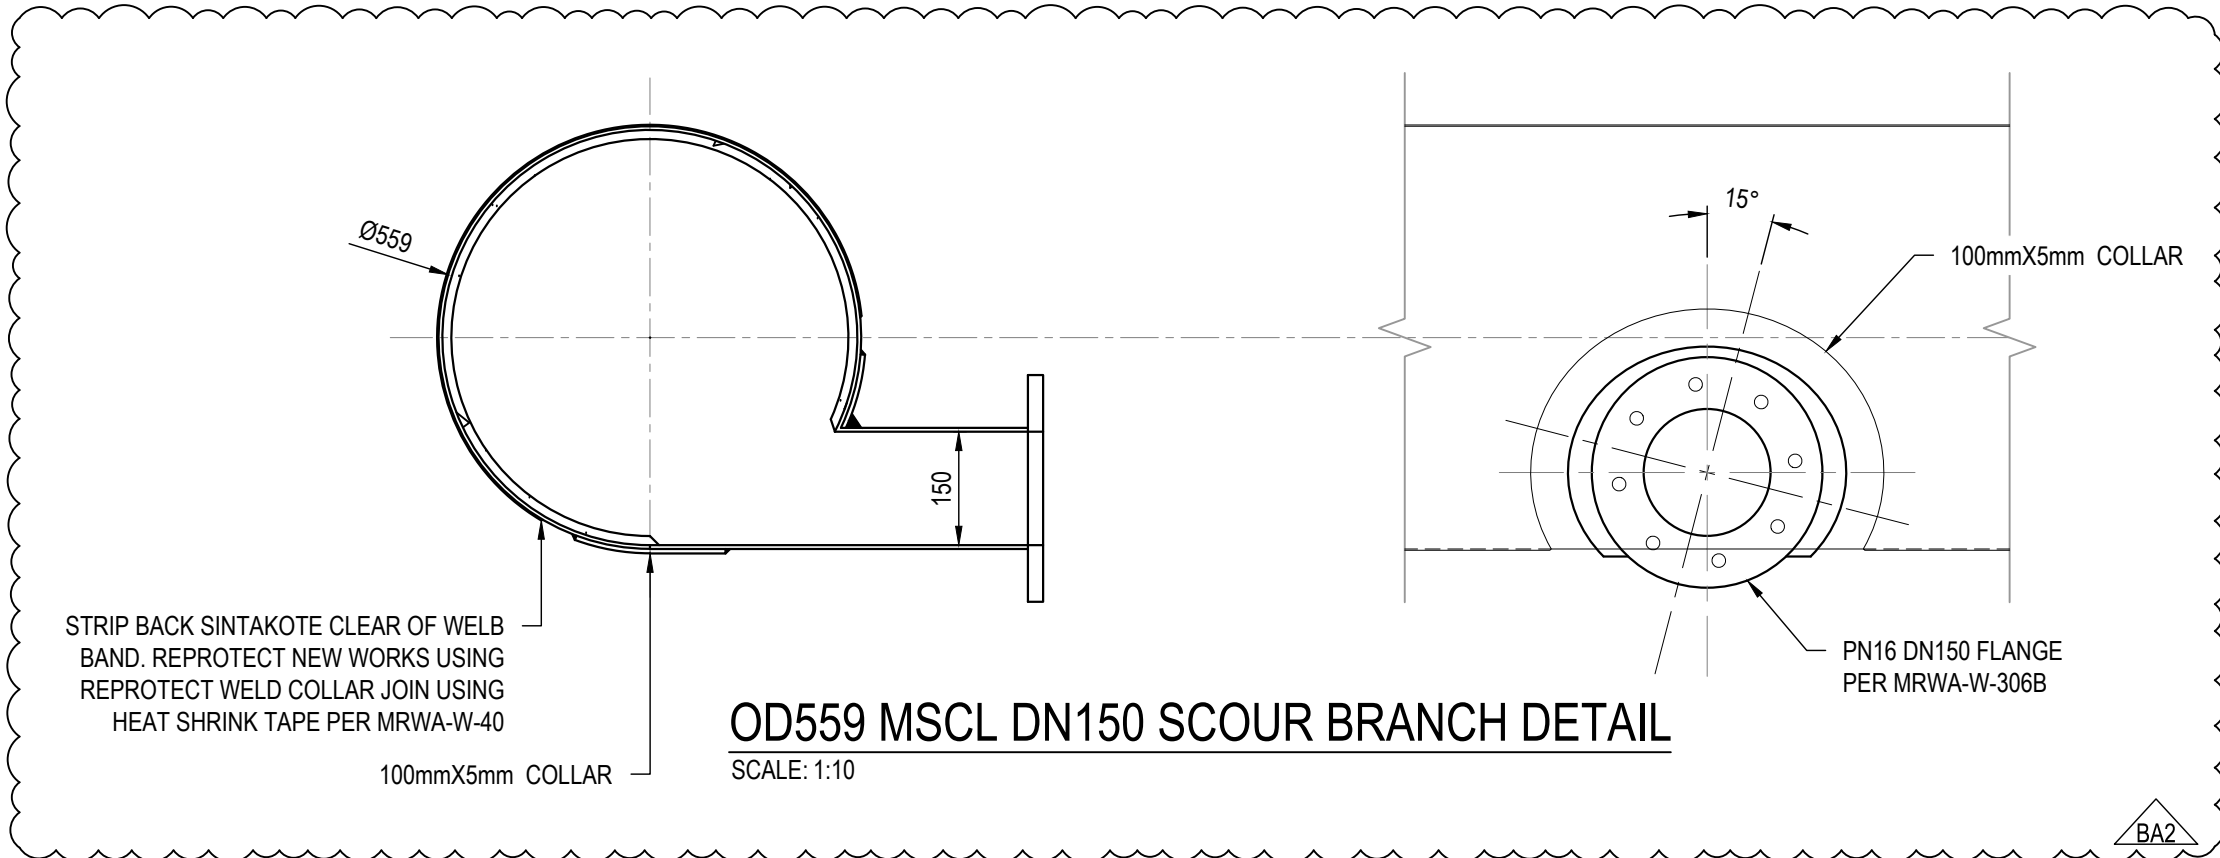


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GLENORCHY CITY COUNCIL
PLANNING SERVICES
APPLICATION No. PLN-24-181
DATE RECEIVED 30 April 2025

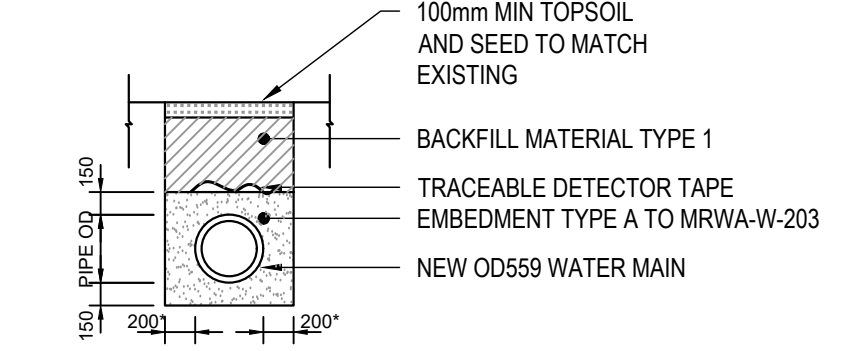


TYPICAL TRENCH DETAIL
PIPE IN NATURE STRIP

SCALE 1:50

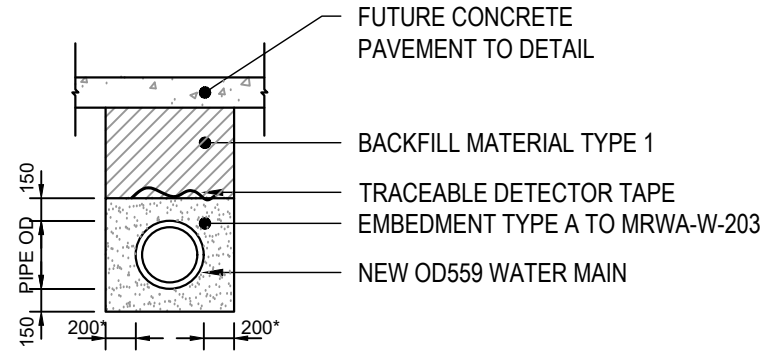


TYPICAL TRENCH DETAIL
PIPE UNDER FUTURE BASIN PAVEMENT

SCALE 1:50

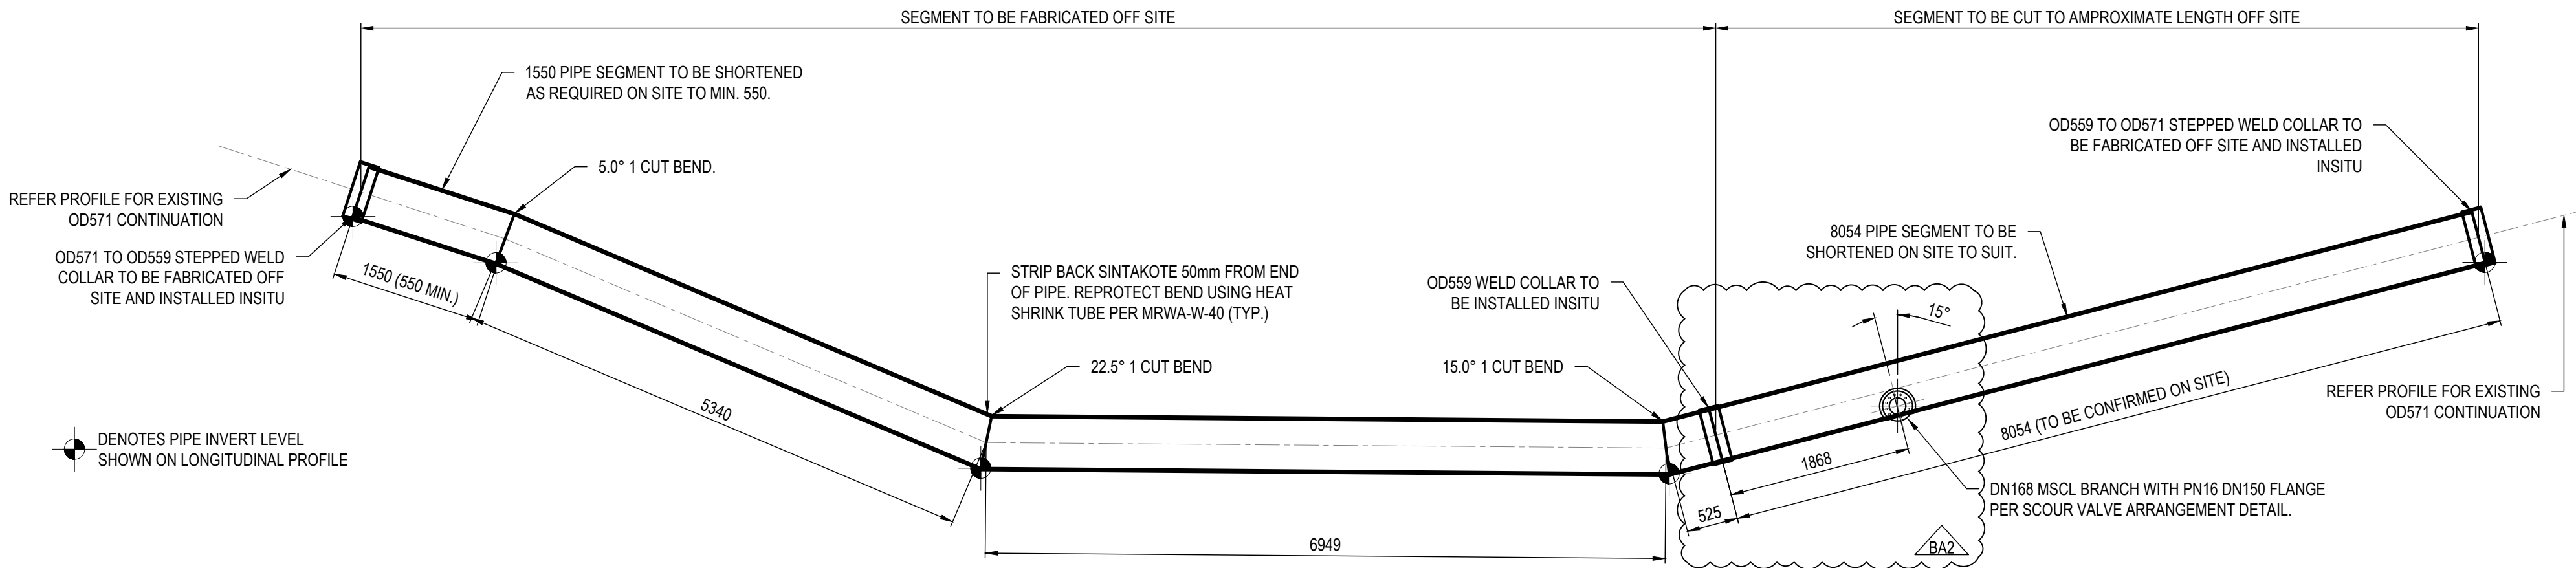


PIPE BEND AND JOINT ELEVATION

SCALE: 1:50

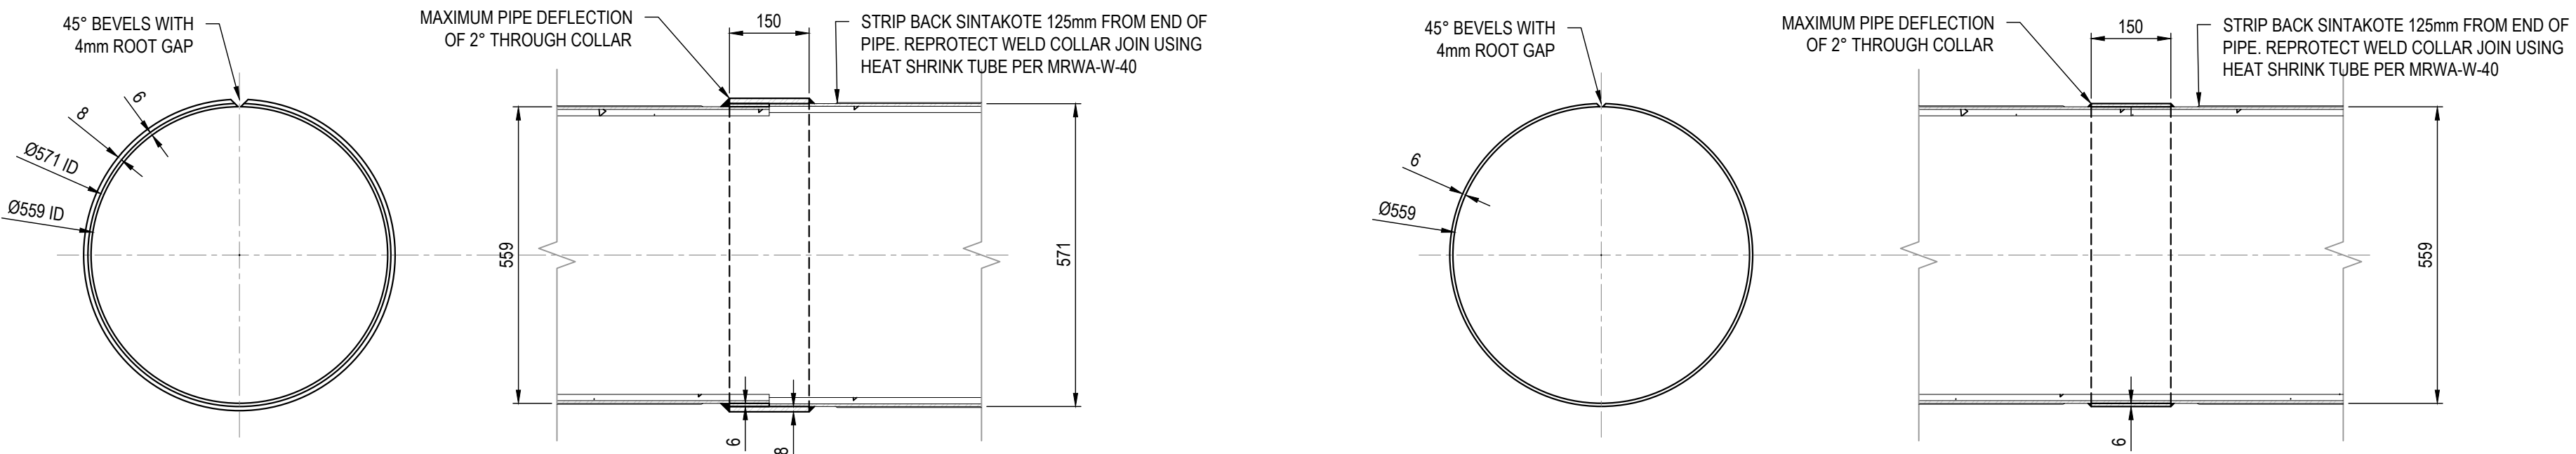

OD559 TO OD571 STEPPED WELD COLLAR DETAIL

SCALE: 1:10

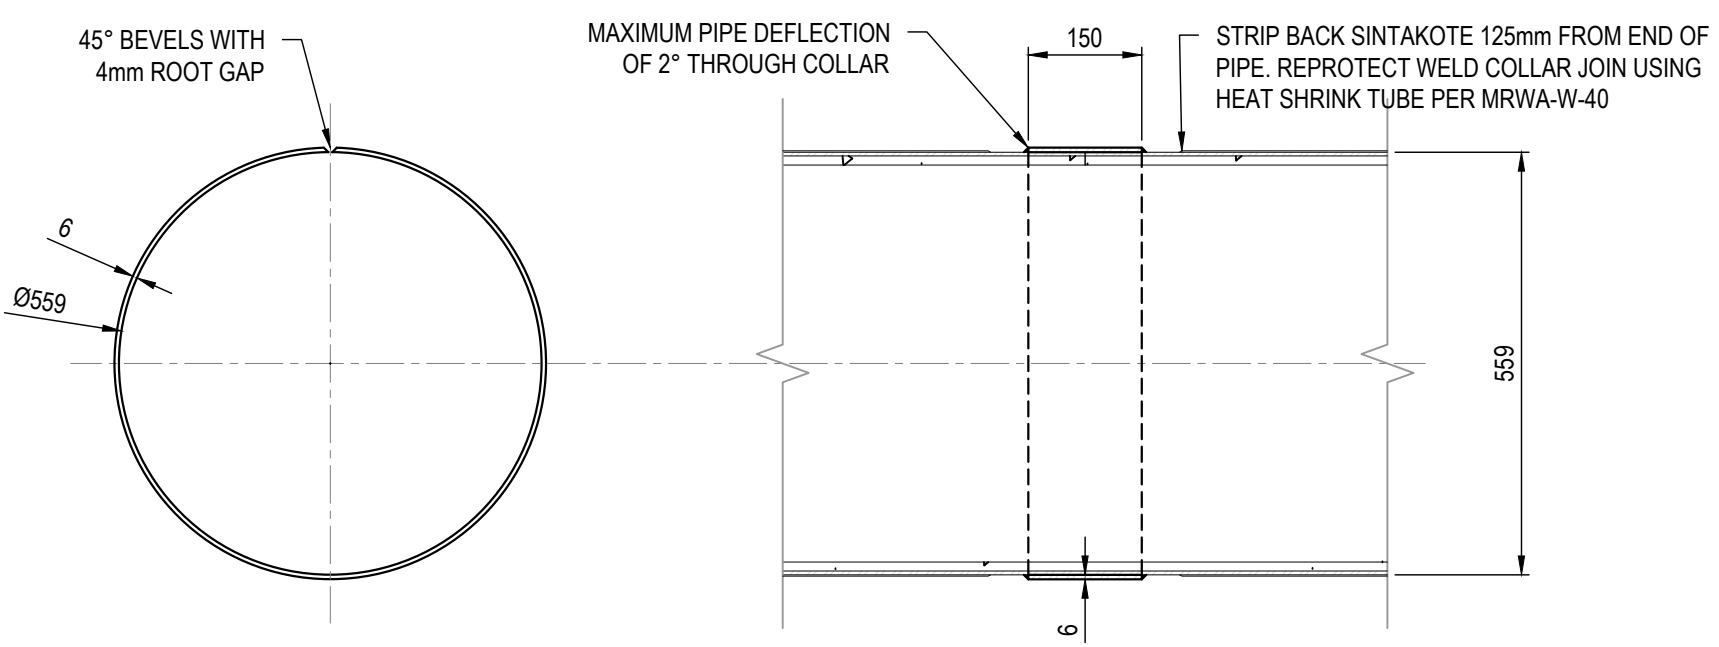

OD559 WELD COLLAR DETAIL

SCALE: 1:10

BA215 04.2025 REVISED SCOUR LOCATION
BA119 03.2025 REVISED BUILDING APPROVAL
P114 03.2025 PRELIMINARY ISSUE
REV DATE REMARK

SAFETY IN DESIGN REPORT PER WHS REGULATIONS	
This drawing shall not be used for any other purpose than that for which it was prepared.	YES
This report does not release contractors from their responsibilities under the Act to identify, report, mitigate and manage all aspects of risk and safety.	



JOHNSTONE McGEE & GANDY PTY LTD
117 Harrington Street, Hobart TAS (03) 6331 2555
49-51 Elizabeth Street, Launceston TAS (03) 6334 5548
www.jmg.net.au info@jmg.net.au info@jmg.net.au

PROJECT
GLENORCHY CITY COUNCIL,
REDLANDS DRIVE ROSETTA
DEBRIS BASIN

TITLE
WATERMAIN LOWERING
NOTES & DETAILS

Accepted JMB (Discipline Head)	Date 15/04/2025
Accepted MJR (Team Leader)	Date 15/04/2025
Approved CUM (Principal)	Date 15/04/2025
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AS SHOWN	TCM
PLOT DATE	15/04/2025





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PLOT DETAILS J230352CS-E-WATER MAIN REPLACEMENT.DWG

PROJECT NO. 230352CS

DWG NO. C100 REVISION BA2

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**GLENORCHY CITY COUNCIL
PLANNING SERVICES**

APPLICATION No PLN-24-181

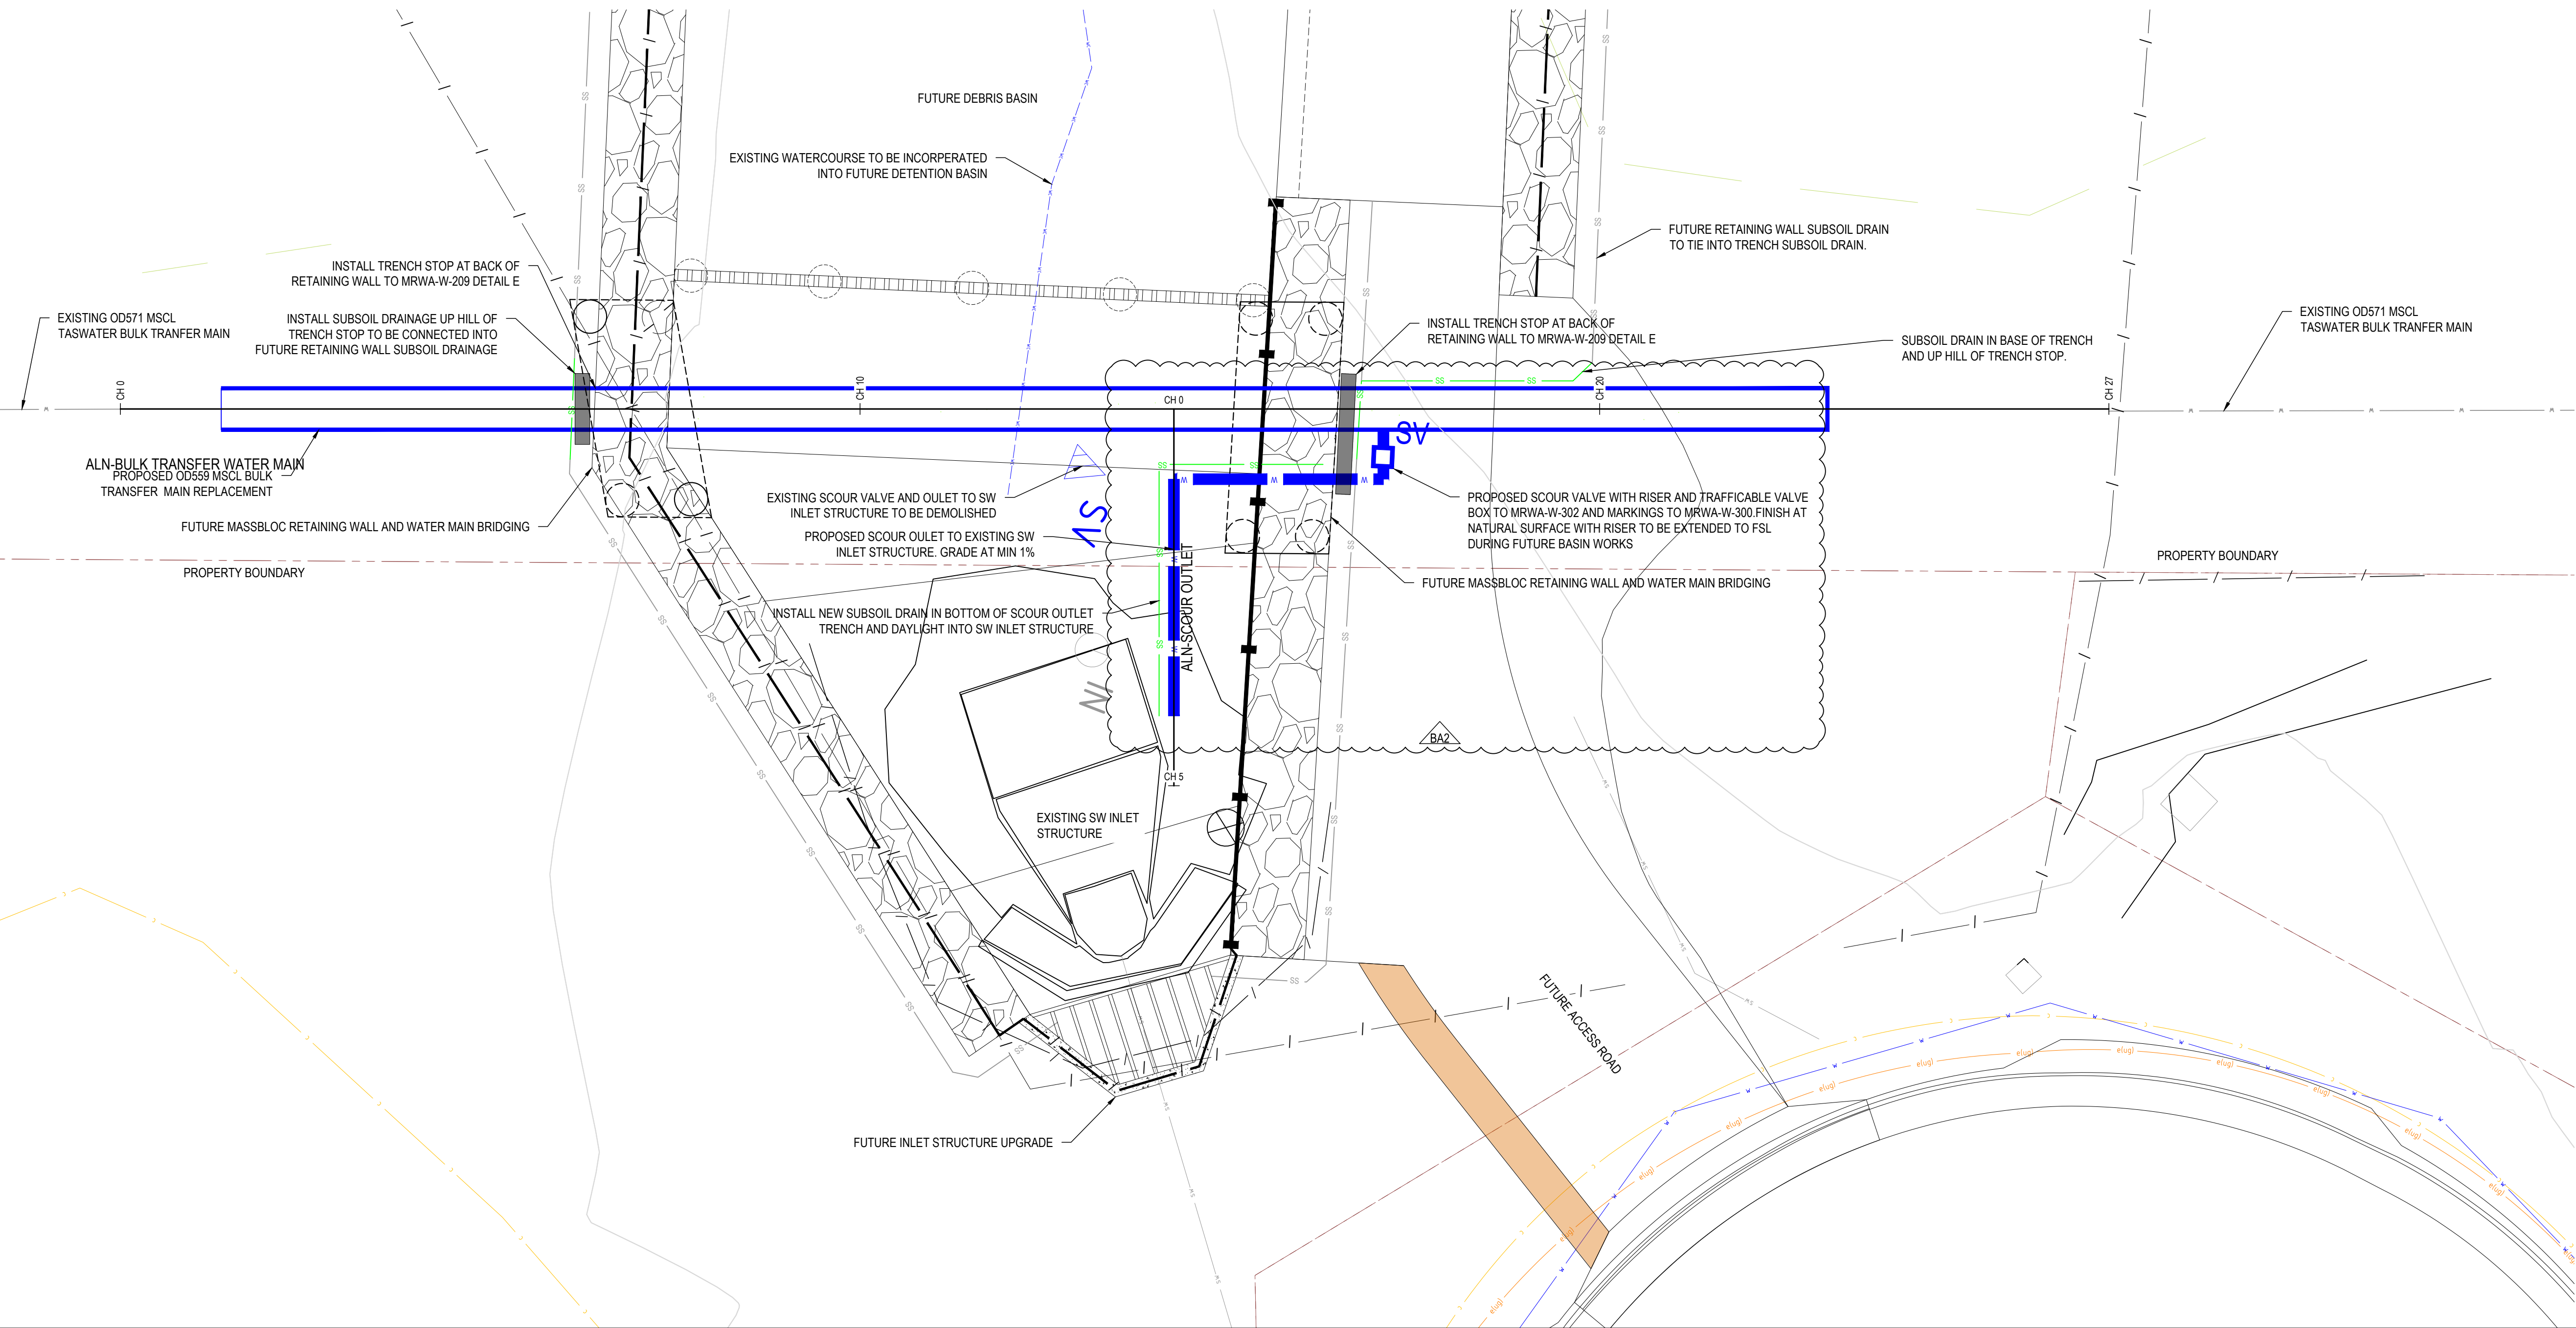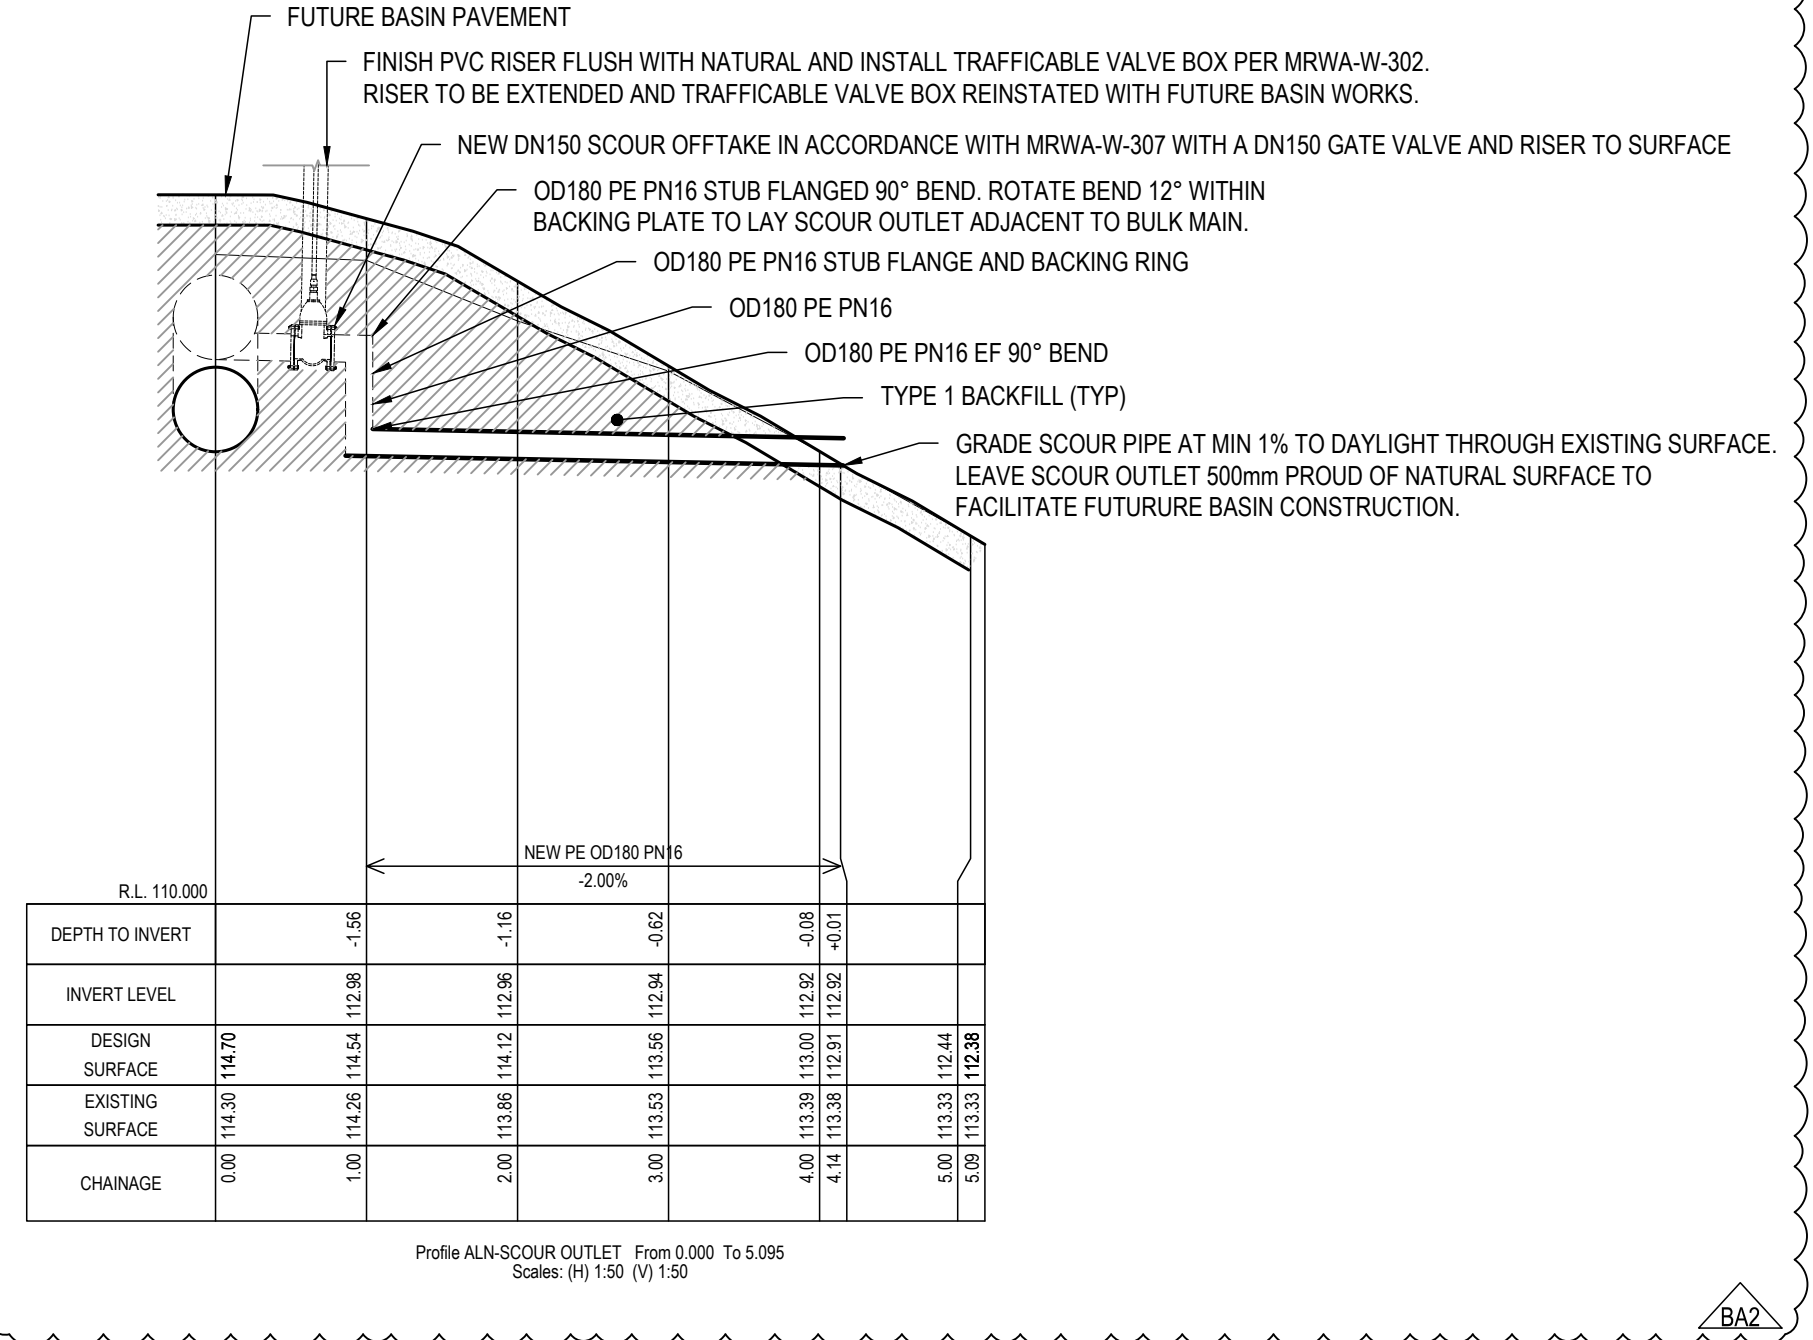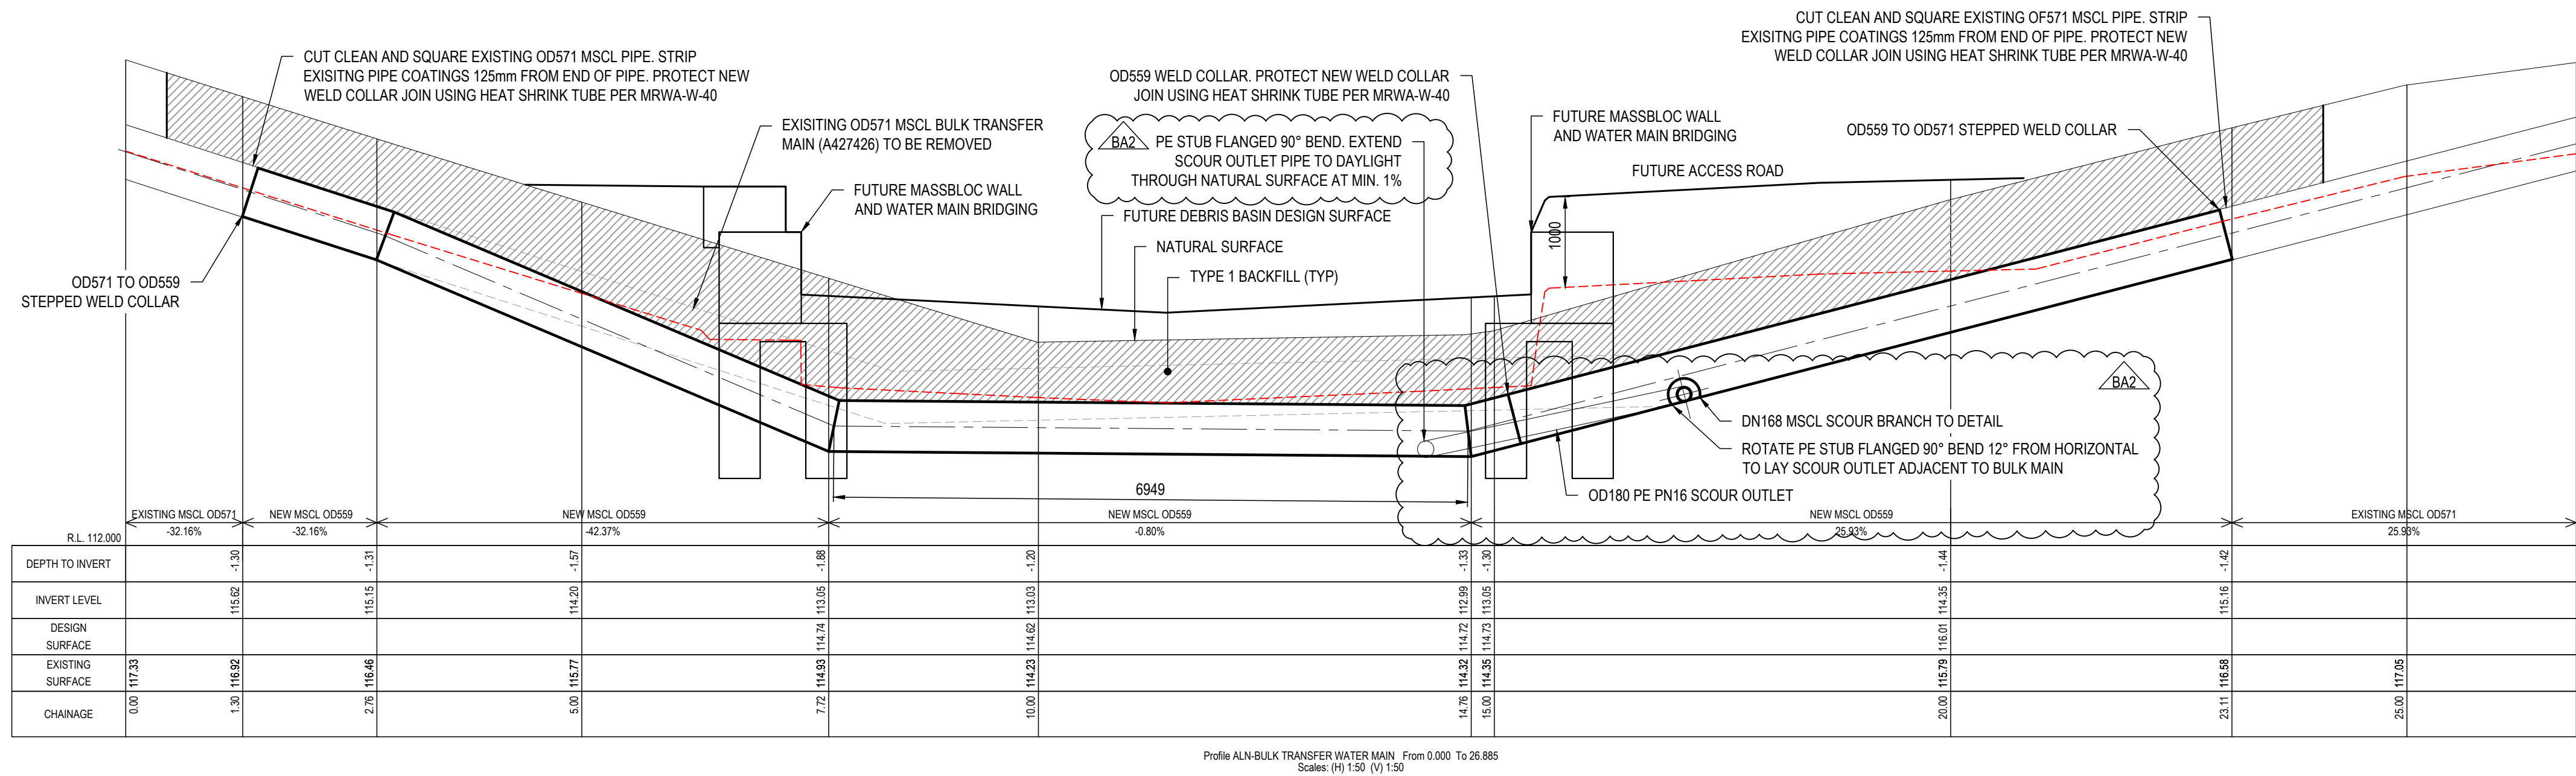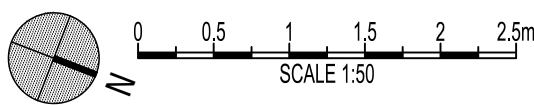DATE RECEIVED 30 April 2025

BA2	15.04.2025	REVISED SCOUR LOCATION
BA1	19.03.2025	REVISED BUILDING APPROVA
P1	14.03.2025	PRELIMINARY ISSUE
REV	DATE	REMARK

SAFETY IN DESIGN REPORT PER WHS REGULATIONS	
The following risks which are unique to this design have been identified:	NL
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www.jmg.net.au infohbt@jmg.net.au infohn@jmg.net.au

PROJECT
GLENORCHY CITY COUNCIL
REDLANDS DRIVE ROSETTA
DEBRIS BASIN

TITLE
WATERMAIN LOWERING
GENERAL ARRANGEMENT
& PROFILES

Accepted (Discipline Head)	JMB		Date	15/04/2025
Accepted (Team Leader)	MJR		Date	15/04/2025
Approved (Principal)	CJM		Date	15/04/2025

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1:500	MJR	TCM
	PLOT DATE	15/04/2025

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PLOT DETAILS J230352CS-E-WATER MAIN REPLACEMENT
PROJECT NO. 230352CS

DWG NO.	REVISION
C101	BA2

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SOIL AND WATER MANAGEMENT NOTES

CONTRACTOR IS RESPONSIBLE FOR THE MAINTENANCE OF THE STORMWATER SYSTEM THROUGH TO FINAL CERTIFICATE.

CONTRACTOR TO CLEANOUT SILT FENCES AND STRAW BALE SEDIMENT TRAPS WEEKLY (AND FOLLOWING HEAVY RAIN EVENTS) TO MAINTAIN EFFECTIVENESS OF SEDIMENT CONTROL MEASURES.

CONTRACTOR RESPONSIBLE FOR ANY REPAIR/RE-ERECTION OF SEDIMENT CONTROL MEASURES THAT MAY BE REQUIRED FOR THE ENTIRE DURATION OF CONSTRUCTION AND MAINTENANCE PERIOD.

STRAW BALE SEDIMENT TRAPS TO BE CONSTRUCTED FROM GEOFABRIC WRAPPED STRAW BALES EMBEDDED INTO EARTH ACROSS DRAINAGE PATH AND ANCHORED IN PLACE WITH TWO STAR PICKETS PER BALE.

SILT FENCES TO BE CONSTRUCTED FROM SYNTHETIC FILTER SUPPORTED AT TWO METER INTERVALS BY 1.5M HIGH STAR PICKETS PARALLEL WITH LAND CONTOURS. EXCAVATE 0.15M DEEP TRENCH TO UP SLOPE SIDE OF FENCE WHILST ALSO LOCATING SPOIL TO UP SLOPE SIDE OF FENCE. PLACE BOTTOM OF SYNTHETIC FILTER IN TRENCH AND BACKFILL WITH EXCAVATED MATERIAL.

LOCATE EXISTING BELOW GROUND SERVICES PRIOR TO DRIVING IN STAR PICKETS.

CONTROLS TO BE AMENDED AS REQUIRED DURING CONSTRUCTION TO SUIT STAGING OF WORKS.

CONTRACTOR IS TO WASH DOWN ALL EARTHMOVING MACHINERY ENTERING AND EXITING SITE (AND ALL TRUCKS THAT ARE CONTAMINATED WITH MUD FROM SITE).

ALL DISTURBED AREAS OF THE WORKS TO BE TOP SOILED AND VEGETATED WITH TYPE A SEED MIX TO DSG SPECIFICATION R70.3.

CONTRACTOR TO REFER TO DERWENT ESTUARY PROGRAM FACTS SHEETS 'SOIL AND WATER MANAGEMENT ON BUILDING AND CONSTRUCTION SITES' AVAILABLE FROM [HTTPS://WWW.DERWENTESTUARY.ORG.AU/STORMWATER/](https://www.derwentestuary.org.au/stormwater/) FOR REQUIREMENTS OF ALL SOIL AND WATER MANAGEMENT DEVICES.

THIS PROPOSED SOIL AND WATER MANAGEMENT PLAN IS PROVIDED AS GUIDANCE ONLY. IT IS ULTIMATELY THE CONTRACTORS RESPONSIBILITY TO INSTALL, MONITOR AND MAINTAIN APPROPRIATE SWMP MEASURES IN ORDER TO PROTECT NEIGHBOURING PROPERTIES AND AUTHORITY INFRASTRUCTURE.

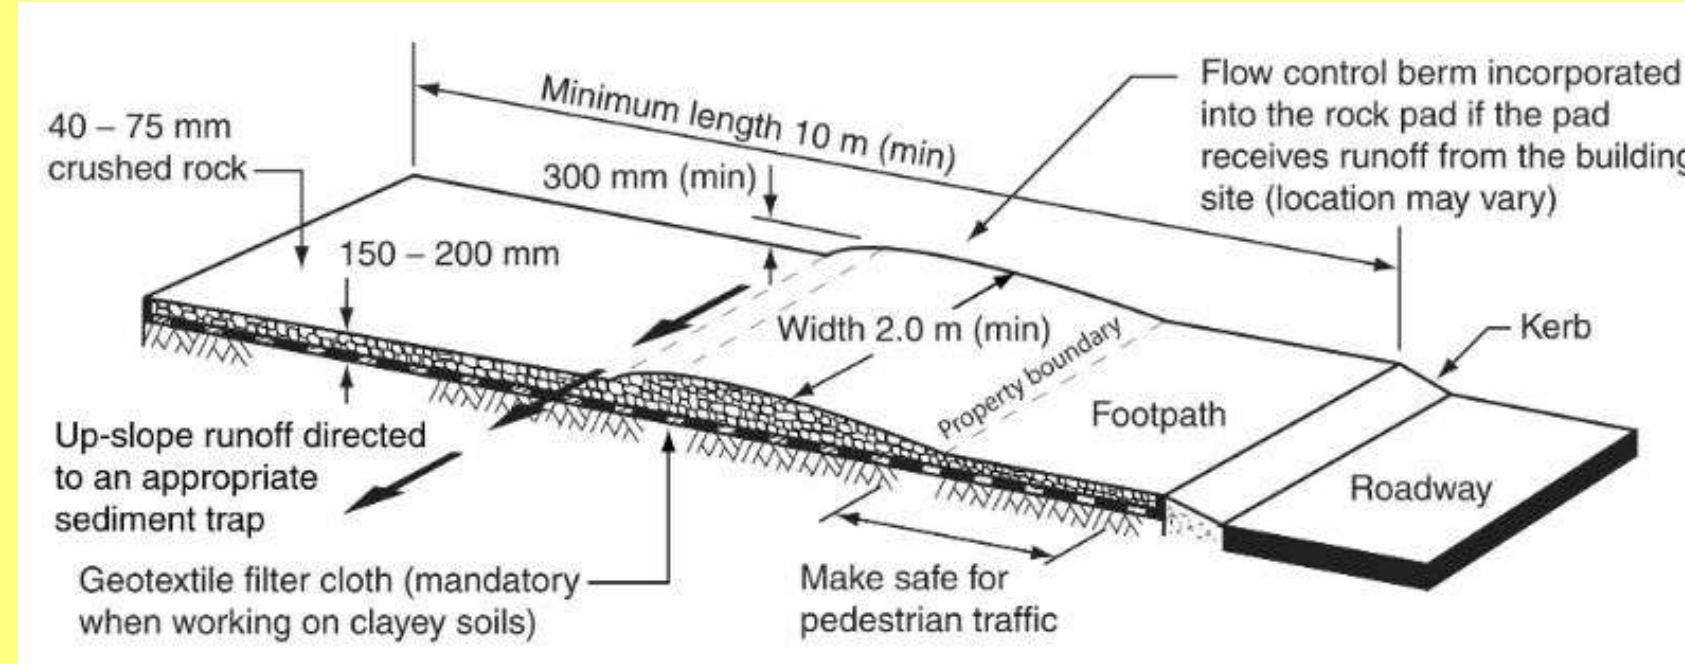


Figure 16: Dimensions and construction details for rock entry/exit pad for small building sites. For large construction sites the minimum length of stabilised site access structures is 15 metres, and a minimum width of 3 metres. Figure from Catchments and Creeks Pty Ltd.

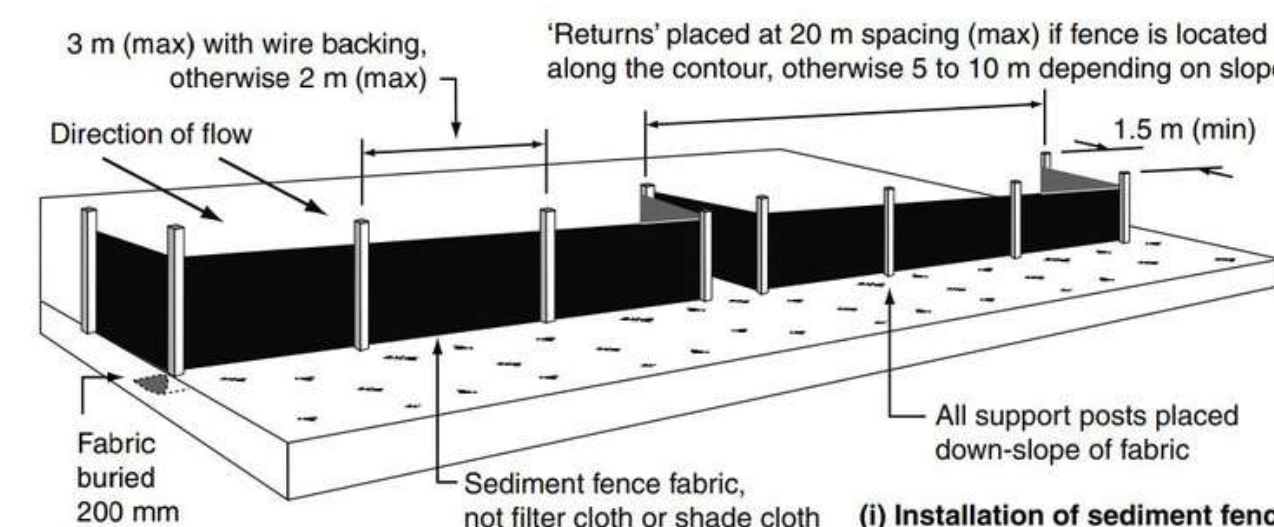


Figure 22: Nominal dimensions and construction details for sediment fence installation. Figure from Catchments and Creeks Pty Ltd.

Sediment Fence Typical
Provide supports at every 5m when perpendicular to the slope and at 15m when along the slope

Provide Rock check dam prior to excavation of upstream basin.

Temporary Stockpiling area.
Maintain at max 2:1 slope and less than 2m with additional earth bank on upstream if required

Extent of works within Landscape Conservation Zone

No works to occur within Environmental Management Zone

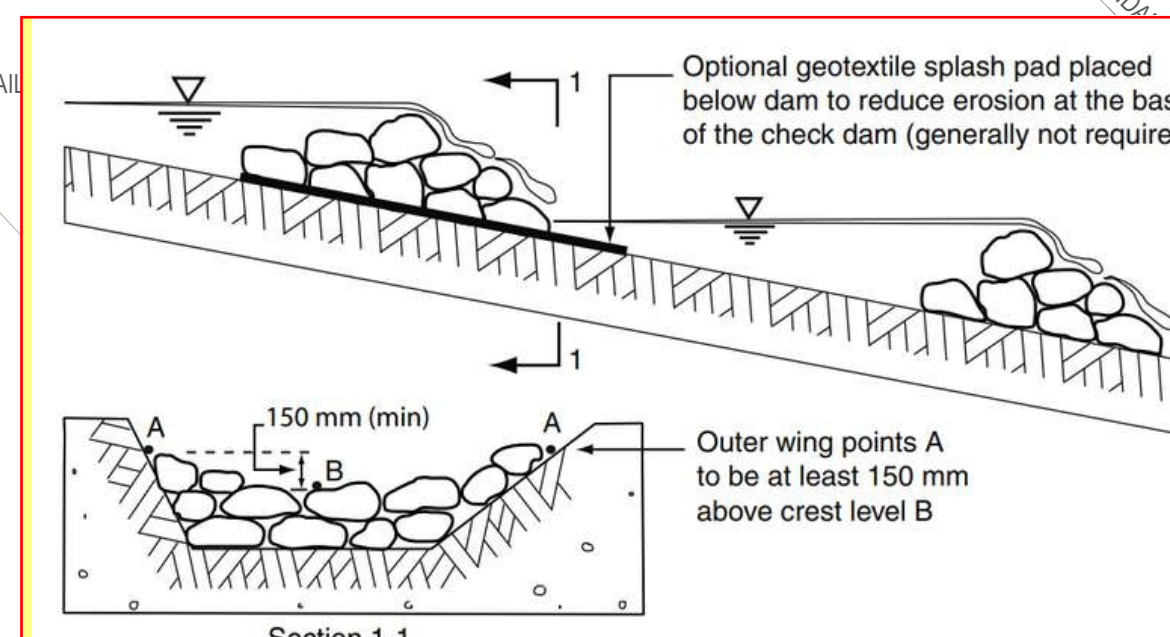


Figure 5: Cross-section and plan diagrams indicating the dimensions and construction details of a temporary check dam, shown in profile. Figure from Catchments and Creeks Pty Ltd.

Typical Check Dam Detail
Not to Scale

PROJECT
GLENORCHY CITY COUNCIL,
REDLANDS DRIVE ROSETTA
DEBRIS BASIN

TITLE
EROSION AND SEDIMENT
CONTROL PLAN

Endorsed by

Manager AED, GCC
GLENORCHY CITY COUNCIL

15 REDLANDS
DRIVE ROSETTA
CT: 160921/1



Area = 33 sqm
Rainfall intensity = 85.4mm/hr (5% AEP 5 min)
Runoff coefficient Cpost= 1 (fully impervious)

Discharge $Q_{post} = (1 \times 85.4 \text{ mm/hr} \times 33 \text{ sqm}) / 3600$
 $Q_{post} = 0.78 \text{ l/sec}$

Pre developed discharge considering
 $C_{pre} = 0.4$ (grassed area/natural ground)
 $Q_{pre} = 0.31$ l/sec

Kerb inlet capacity at the Cul - de - Sac
See below snip for calculation
 $Q = 12 / \text{sec}$ (for 100% capture rate)

Increase in additional stormwater run off to the kerb and gutter = $Q_{\text{post}} - Q_{\text{pre}}$
 = 0.47 l/sec
 Only ~ 4% of the kerb inlet capacity


Section 4.4.4.4 of HEC 22 states that the capacity of a combination inlet should be the capacity of the grate plus the capacity of the portion of the kerb inlet that is upstream of the grate. The portion of the kerb inlet adjacent to the grate is ignored. It is assumed that the grate is located at the lower end of the longer kerb inlet.

1. Inputs - Enter appropriate values in the yellow cells and press the 'Calculate' button.

Upstream Road Profile Characteristics		Inlet Characteristics		
Road Crossfall or Side Slope (%)	3	Total Kerb Inlet Length (m)	0	Set this to zero for a grate alone
Gutter Crossfall (%)	8	Gutter Crossfall at the Inlet (%)	16	
Longitudinal Grade (%)	1	Grate Length (m)	0.9	Set this to zero for a kerb inlet alone
Gutter Width (m) (low point to edge)	0.45	Grate Width (m)	0.45	Set this to zero for a kerb inlet alone
Half Road Width (incl. Gutter) (m)	6.5	Grate Type (1 to 7) - Sect. 4.4.3, HEC22	7	(see 'Grate Types' sheet)
Gutter Depth (Kerb Height) (m)	0.15			1 - Reticuline 5 - Curved Vane
Gutter Face Slope (degrees)	80	0° - flat, 90° - vertical	Calculate	2 - 30°-85 Tilt Bar 6 - P-30
Manning's n of Street	0.014			3 - P-50x100 7 - P-50
Manning's n of Gutter	0.012			4 - 45°-85 Tilt Bar
Flow Adjustment Factor	1	1.0 in HEC 22; in Australian practice 0.8 for vertical gutter face, 0.9 for sloping face. (See comment to right.)		

2. Captured flowrates are given in the following table for the flowrates entered in the first column.

	Flow Characteristics		Kerb Inlet Results			Grate Results								Total	transferred to DRA			
Approach	Flow	Flow	Required		Flow			Velocity	Frontal	Captured	Captured	Captured	Flow	Total Flow				
Flowrate	Depth	Width	Length	Efficiency	Captured	Remaining	Flow	Difference	Flow	Frontal	Side	Flow	Captured	Captured	Approach	Total Flow		
(m³/s)	(m)	(m)	(m)	Ratio	by Kerb	Flowrate	Velocity	(m/s)	Ratio	Flow Ratio	Flow Ratio	Ratio	by Grate	(m³/s)	Flowrate	Captured		
					Inlet	(m³/s)	(m/s)					(m³/s)	(m³/s)		(m³/s)	(m³/s)		
					(m³/s)													
0	These values are fixed.													0.000000	0.000	0.000		
0.001	100% capture is assumed for a low flowrate (1 L/s) to avoid possible stability problems in DRAINS.															0.001000	0.001	0.001
0.002	0.024473	0.3102333	0	0	0	0.002	0.5268375	0	1	1	0.474022	1	0.002	0.002000	0.002	0.002		
0.004	0.031738	0.4023228	0	0	0	0.004	0.6265188	0	1	1	0.397493	1	0.004	0.004000	0.004	0.004		
0.006	0.03695	0.4880173	0	0	0	0.006	0.6926109	0	0.999751	1	0.355158	0.999839	0.005999	0.005999	0.006	0.006		
0.008	0.041086	0.6258784	0	0	0	0.008	0.7295067	0	0.988889	1	0.334063	0.992601	0.0079408	0.007941	0.008	0.008		
0.01	0.044501	0.739702	0	0	0	0.01	0.7520015	0	0.966498	1	0.322014	0.977286	0.0097729	0.009773	0.010	0.010		
0.012	0.047422	0.8370682	0	0	0	0.012	0.7691959	0	0.939821	1	0.313195	0.958669	0.011504	0.011504	0.012	0.012		
0.014	0.049991	0.9227291	0	0	0	0.014	0.7837914	0	0.912507	1	0.305964	0.939277	0.0131499	0.013150	0.014	0.013		
0.016	0.052298	0.9996134	0	0	0	0.016	0.7968578	0	0.886104	1	0.299681	0.920236	0.0147238	0.014724	0.016	0.015		

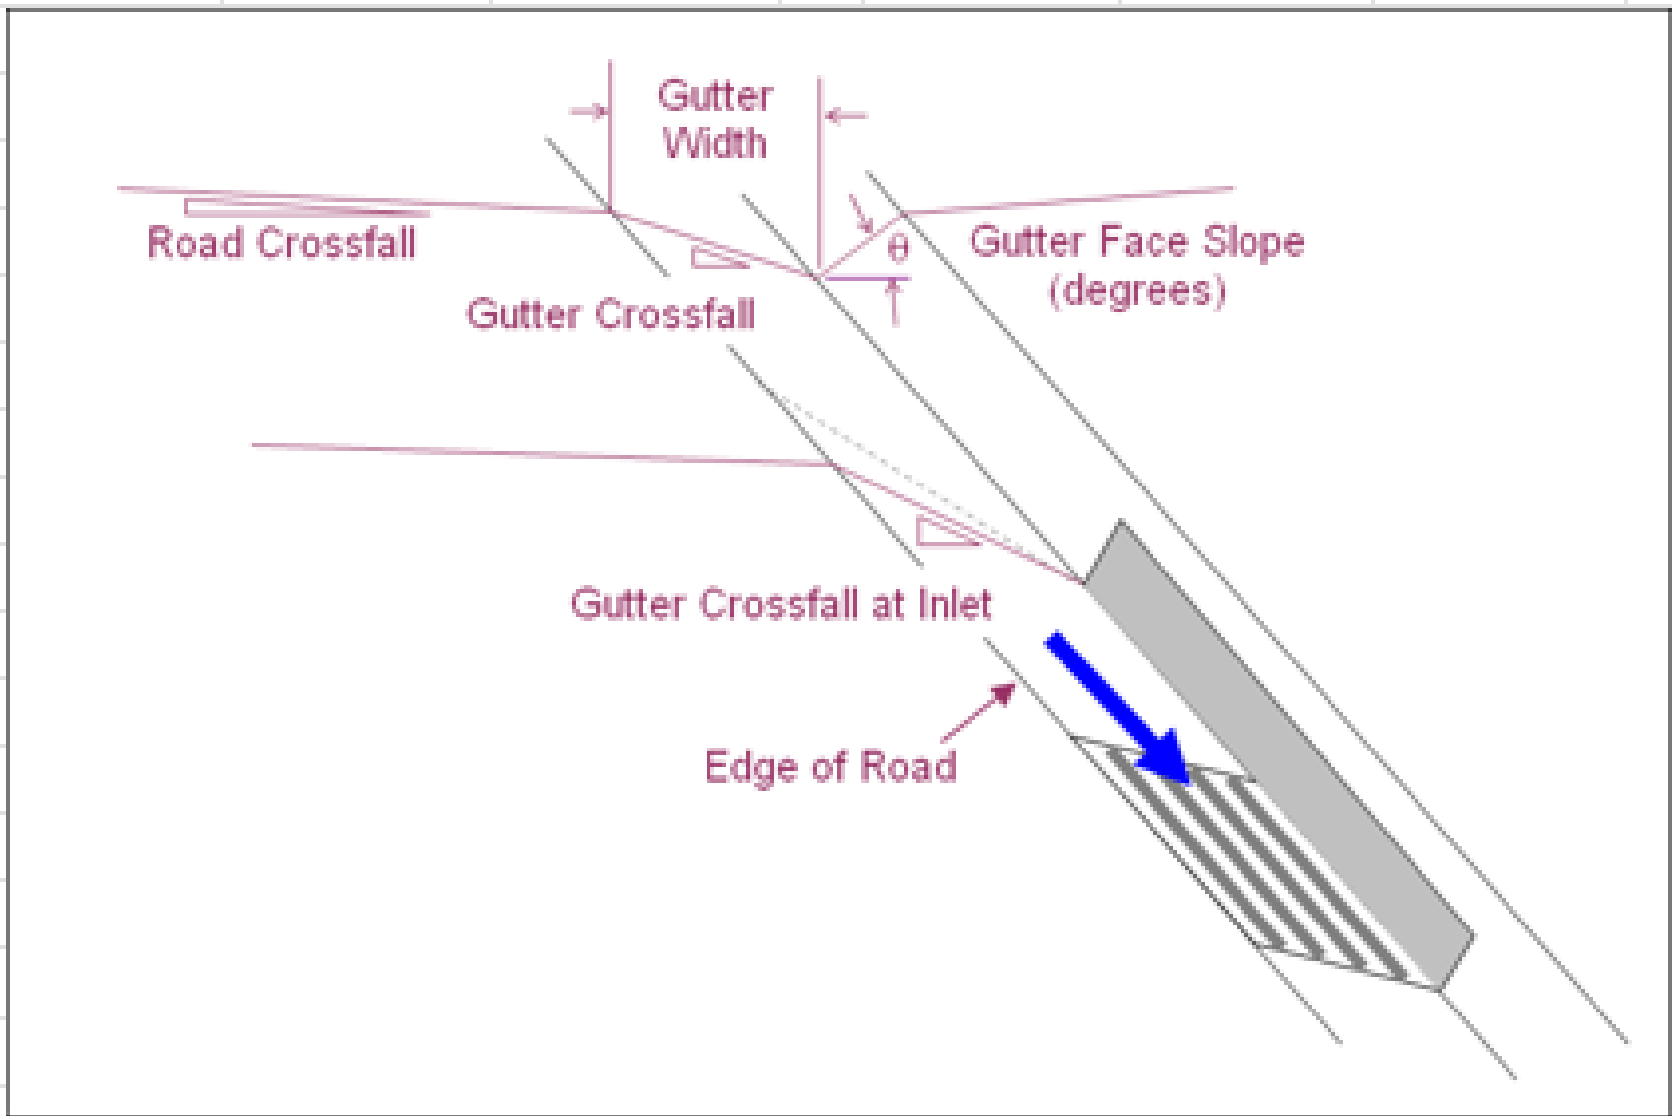

3. Inlet Capacity Relation can be copied and transferred to *DRAINS*

BA	22.05.2024	BUILDING APPROVAL ISSUE
P4	08.03.2024	CLIENT REVIEW ISSUE
P3	04.03.2024	REVISED PRELIMINARY ISSUE
P2	20/09/2023	ISSUED FOR TW COMMENTS
P1	25/08/2023	PRELIMINARY ISSUE
REV	DATE	REMARK

SAFETY IN DESIGN REPORT PER WHS REGULATIONS

The following risks which are unique to this design have been identified	NIL
<p>This report does not relieve contractors from their responsibilities under the Act to identify, report, mitigate and manage all aspects of risk and safety.</p>	






JOHNSTONE MCGEE & GANDY PTY LTD

117 Harrington Street, Hobart TAS (03) 6231 2555
49-51 Elizabeth Street, Launceston TAS (03) 6334 5548
www.jmg.net.au info@jmg.net.au info@jmg.net.au

PROJECT
GLENORCHY CITY COUNCIL,
REDLANDS DRIVE ROSETTA
DEBRIS BASIN

TITLE
LEVELS AND ALIGNMENT
PLAN

Accepted (Discipline Head)	CJM 	Date 22.05.2024
Accepted (Team Leader)	MJR 	Date 22.05.2024
Approved (Principal)	CJM 	Date 22.05.2024

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SCALES @ A1	DESIGNED BY	DRAWN BY
1:100	MJR	JFB
	PLOT DATE	24/05/2024

DO NOT SCALE. Use only figured dimensions. Locations of structure, fittings, services etc. on this drawing are indicative only. CONTRACTOR to check Architects & other project drawings for co-ordination between structure, fabric, fixtures, fittings, services etc. CONTRACTOR to site check all dimensions and exact locations of all items. JMG accepts no responsibility for dimensional information scaled or digitally derived from this document.

PLOT DETAILS J230352CS-B-PLANS.DWG

PROJECT NO. 230352CS

DWG NO.	REVISION
C04	BA

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