GLENORCHY PLANNING AUTHORITY ATTACHMENTS MONDAY, 11 AUGUST 2025




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PLANNING

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GPA - Attachment 1 168A Abbotsfield Road Claremont

Site Plan, Advertised Plans and TasWater Referral





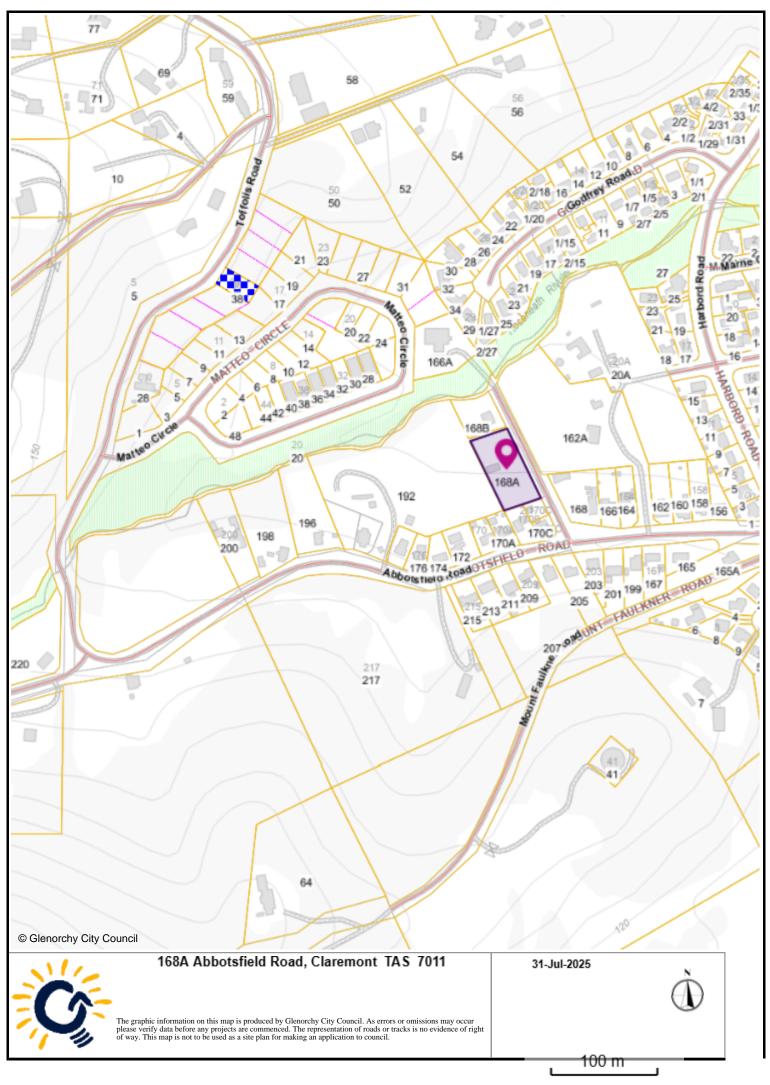

U249 - PROPOSED CUNIC UNIT DEVELOPMENT 168a Abbotsfield Road CLAREMONT

| SHEET | | DRAWING TITLE | SHEET | | DRAWING TITLE |
|-------|---|-------------------------|-------|---|--------------------|
| 0.4 | _ | OITE DI ANI | 40 | _ | |
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| 06 | В | UNIT 3 FLOOR PLAN | 20 | В | UNIT 10 FLOOR PLAN |
| 07 | В | UNIT 3 ELEVATIONS | 21 | В | UNIT 10 ELEVATIONS |
| 80 | В | UNIT 4 FLOOR PLAN | 22 | В | UNIT 11 FLOOR PLAN |
| 09 | В | UNIT 4 ELEVATIONS | 23 | В | UNIT 11 ELEVATIONS |
| 10 | В | UNIT 5 FLOOR PLAN | 24 | В | UNIT 12 FLOOR PLAN |
| 11 | В | UNIT 5 ELEVATIONS | 25 | В | UNIT 12 ELEVATIONS |
| | | | | | |

The use and development must be undertaken and completed in accordance with the approved plans, except for changes required to comply with planning permit conditions. The use and development must not be otherwise changed without the approval of Council.

GLENORCHY CITY COUNCIL PLANNING SERVICES

APPLICATION No.: PLN-24-270

SITE IS NOT BUSHFIRE PRONE AREA AS PER

DATE RECEIVED:

06/11/2024

| | | | | | |]. |
|-----|--|--------------------|-------|---------|--------------|----|
| | Remove individual bin storage from each unit, provide screened communal bin storage area to parking area. Update all relevant plans. | 5 November 2024 | ST | RJ | 01 - 01c |]. |
| В | CLIENT CHANGES: Remove additional roof from container units, change laserlite roof to trimdek. Update all relevant plans and Shadow Diagrams (Separate drawing set) | 2 August 2024 | ST | CK | 01a, 02 - 25 |]. |
| Α | CLIENT CHANGES: Provide Private Open Space plan, show Flood Prone Hazard Area, provide details on Communal Area, provide Shadow Diagrams (Separate drawing set) | 11 July 2024 | ST | CK | 01, 01b, 01c |]. |
| | DA PLAN SET | 25 June 2024 | ST | CK | 01 - 25 | ۱. |
| No. | Amendment | Date | Drawn | Checked | Sheet | 1 |


| Notes |
|--|
| Builder to verify all dimensions and levels on site prior to commencement of work |
| All work to be carried out in accordance with the current National Construction Code. |
| All materials to be installed according to manufacturers specifications. |
| Do not scale from these drawings. |
| No changes permitted without consultation with designer. |


| vork | Designer: | Client / Project info |
|------|---|------------------------------------|
| VOIR | ANOTHER PERSPECTIVE PTY LTD | PROPOSED CUNIC UNIT DEVELOPMENT |
| de. | PO BOX 21 NEW TOWN LIC. NO. 685230609 (S. Turvey) Ph: (03) 6231 4122 Fx: (03) 6231 4166 | 168a Abbotsfield Road CLAREMONT |
| n | Email: info@anotherperspective.com.au | |

| oil Classification: | TB |
|--|-------------------|
| itle Reference: | CT61276/2 |
| loor Areas: | Refer to Plan |
| orch / Deck Areas: | Refer to Plan |
| Vind Speed: | TBI |
| Climate Zone: | |
| Ipine Zone: | N/A |
| Corrosion Environment: | LOV |
| Certified BAL: | NOT BUSHFIRE PRON |
| esigned BAL: | NOT BUSHFIRE PRON |
| Refer to Standard Notes for Explanation) | |
| | |


| | GLENORCHY. No additional restrictions for construction methor materials apply. |
|-----------------------|---|
| TBC 76/27 Plans | COVER SHEET |


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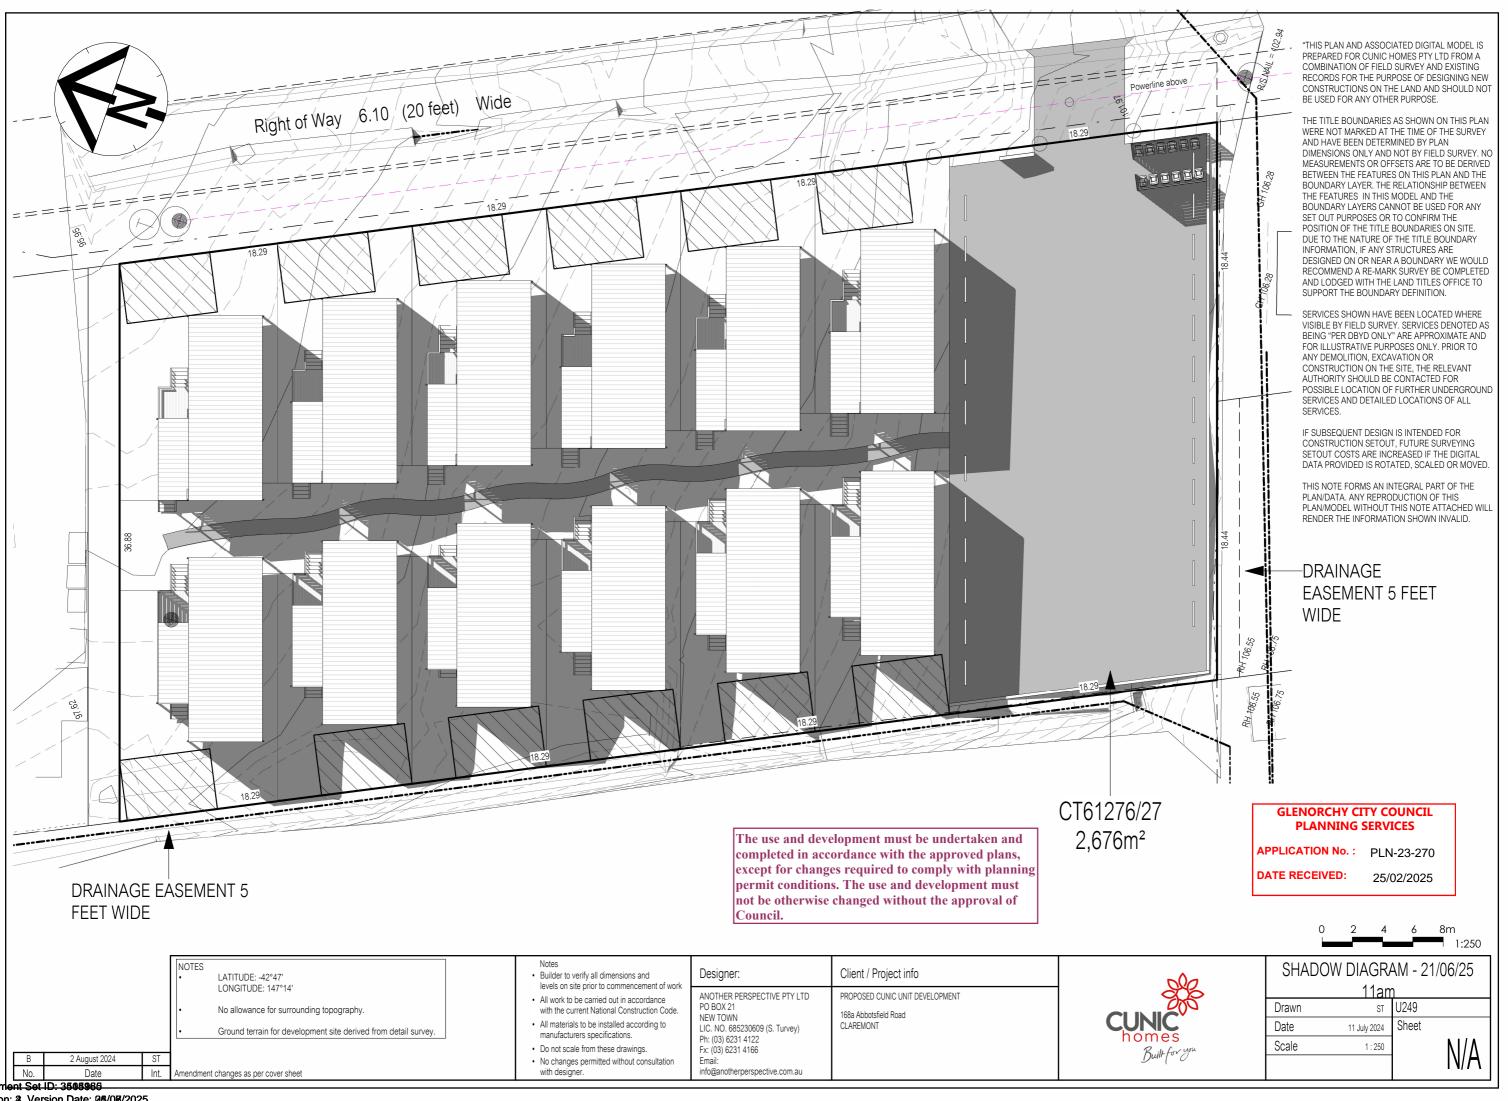


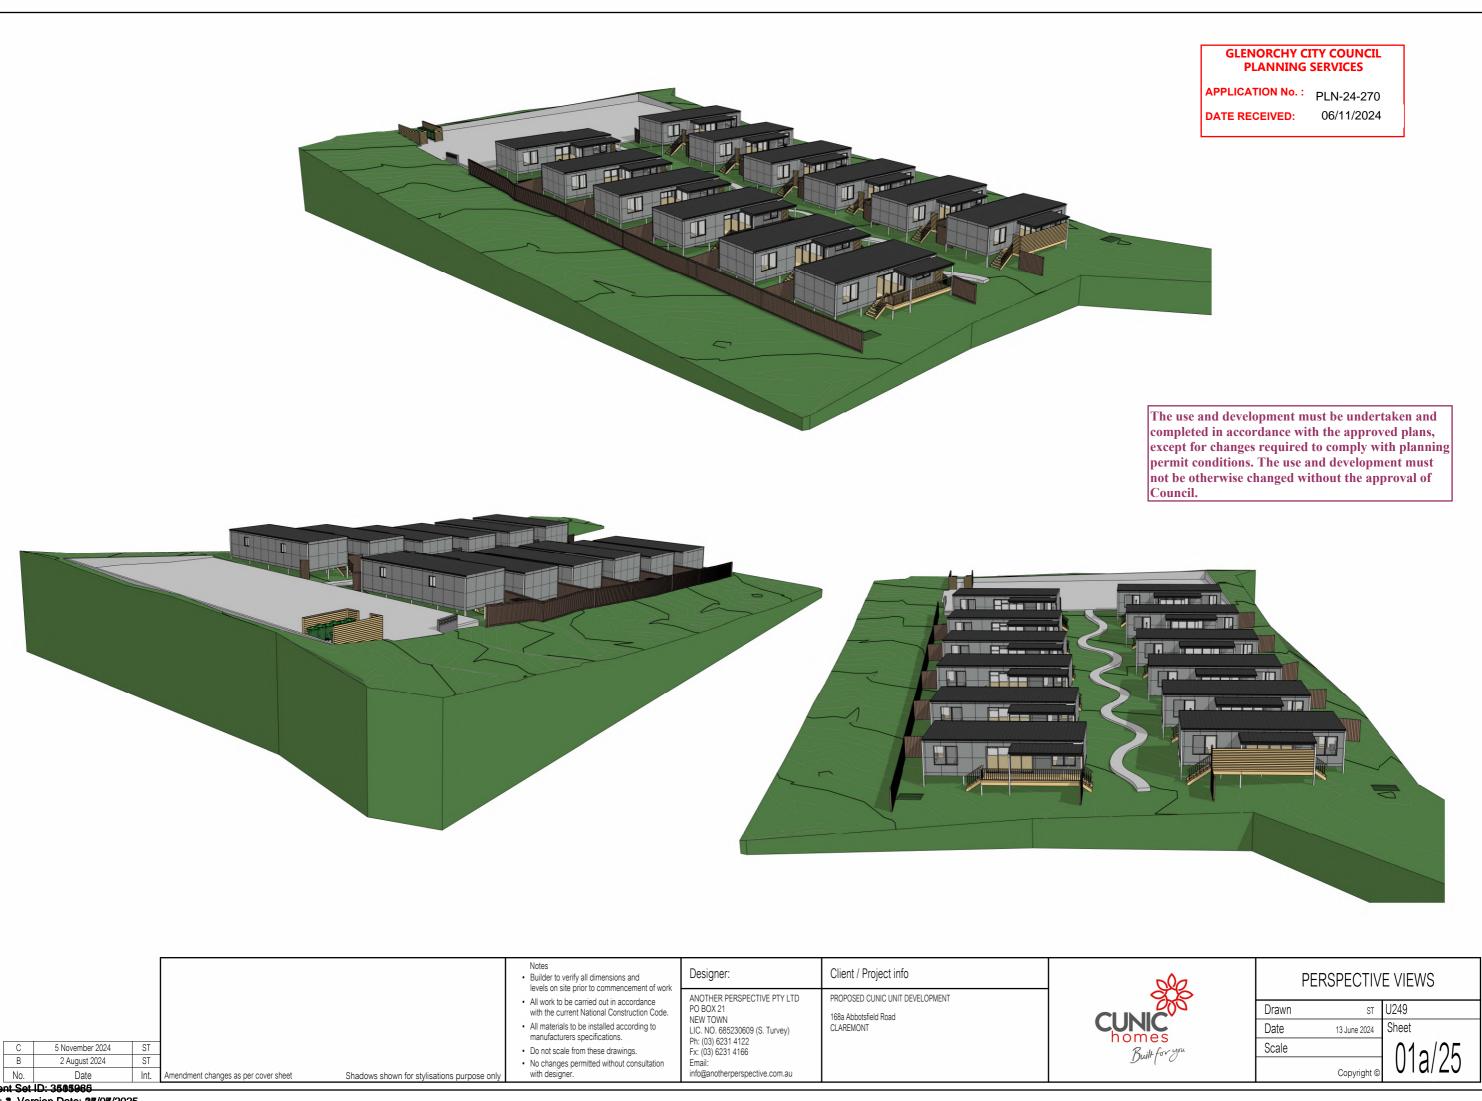


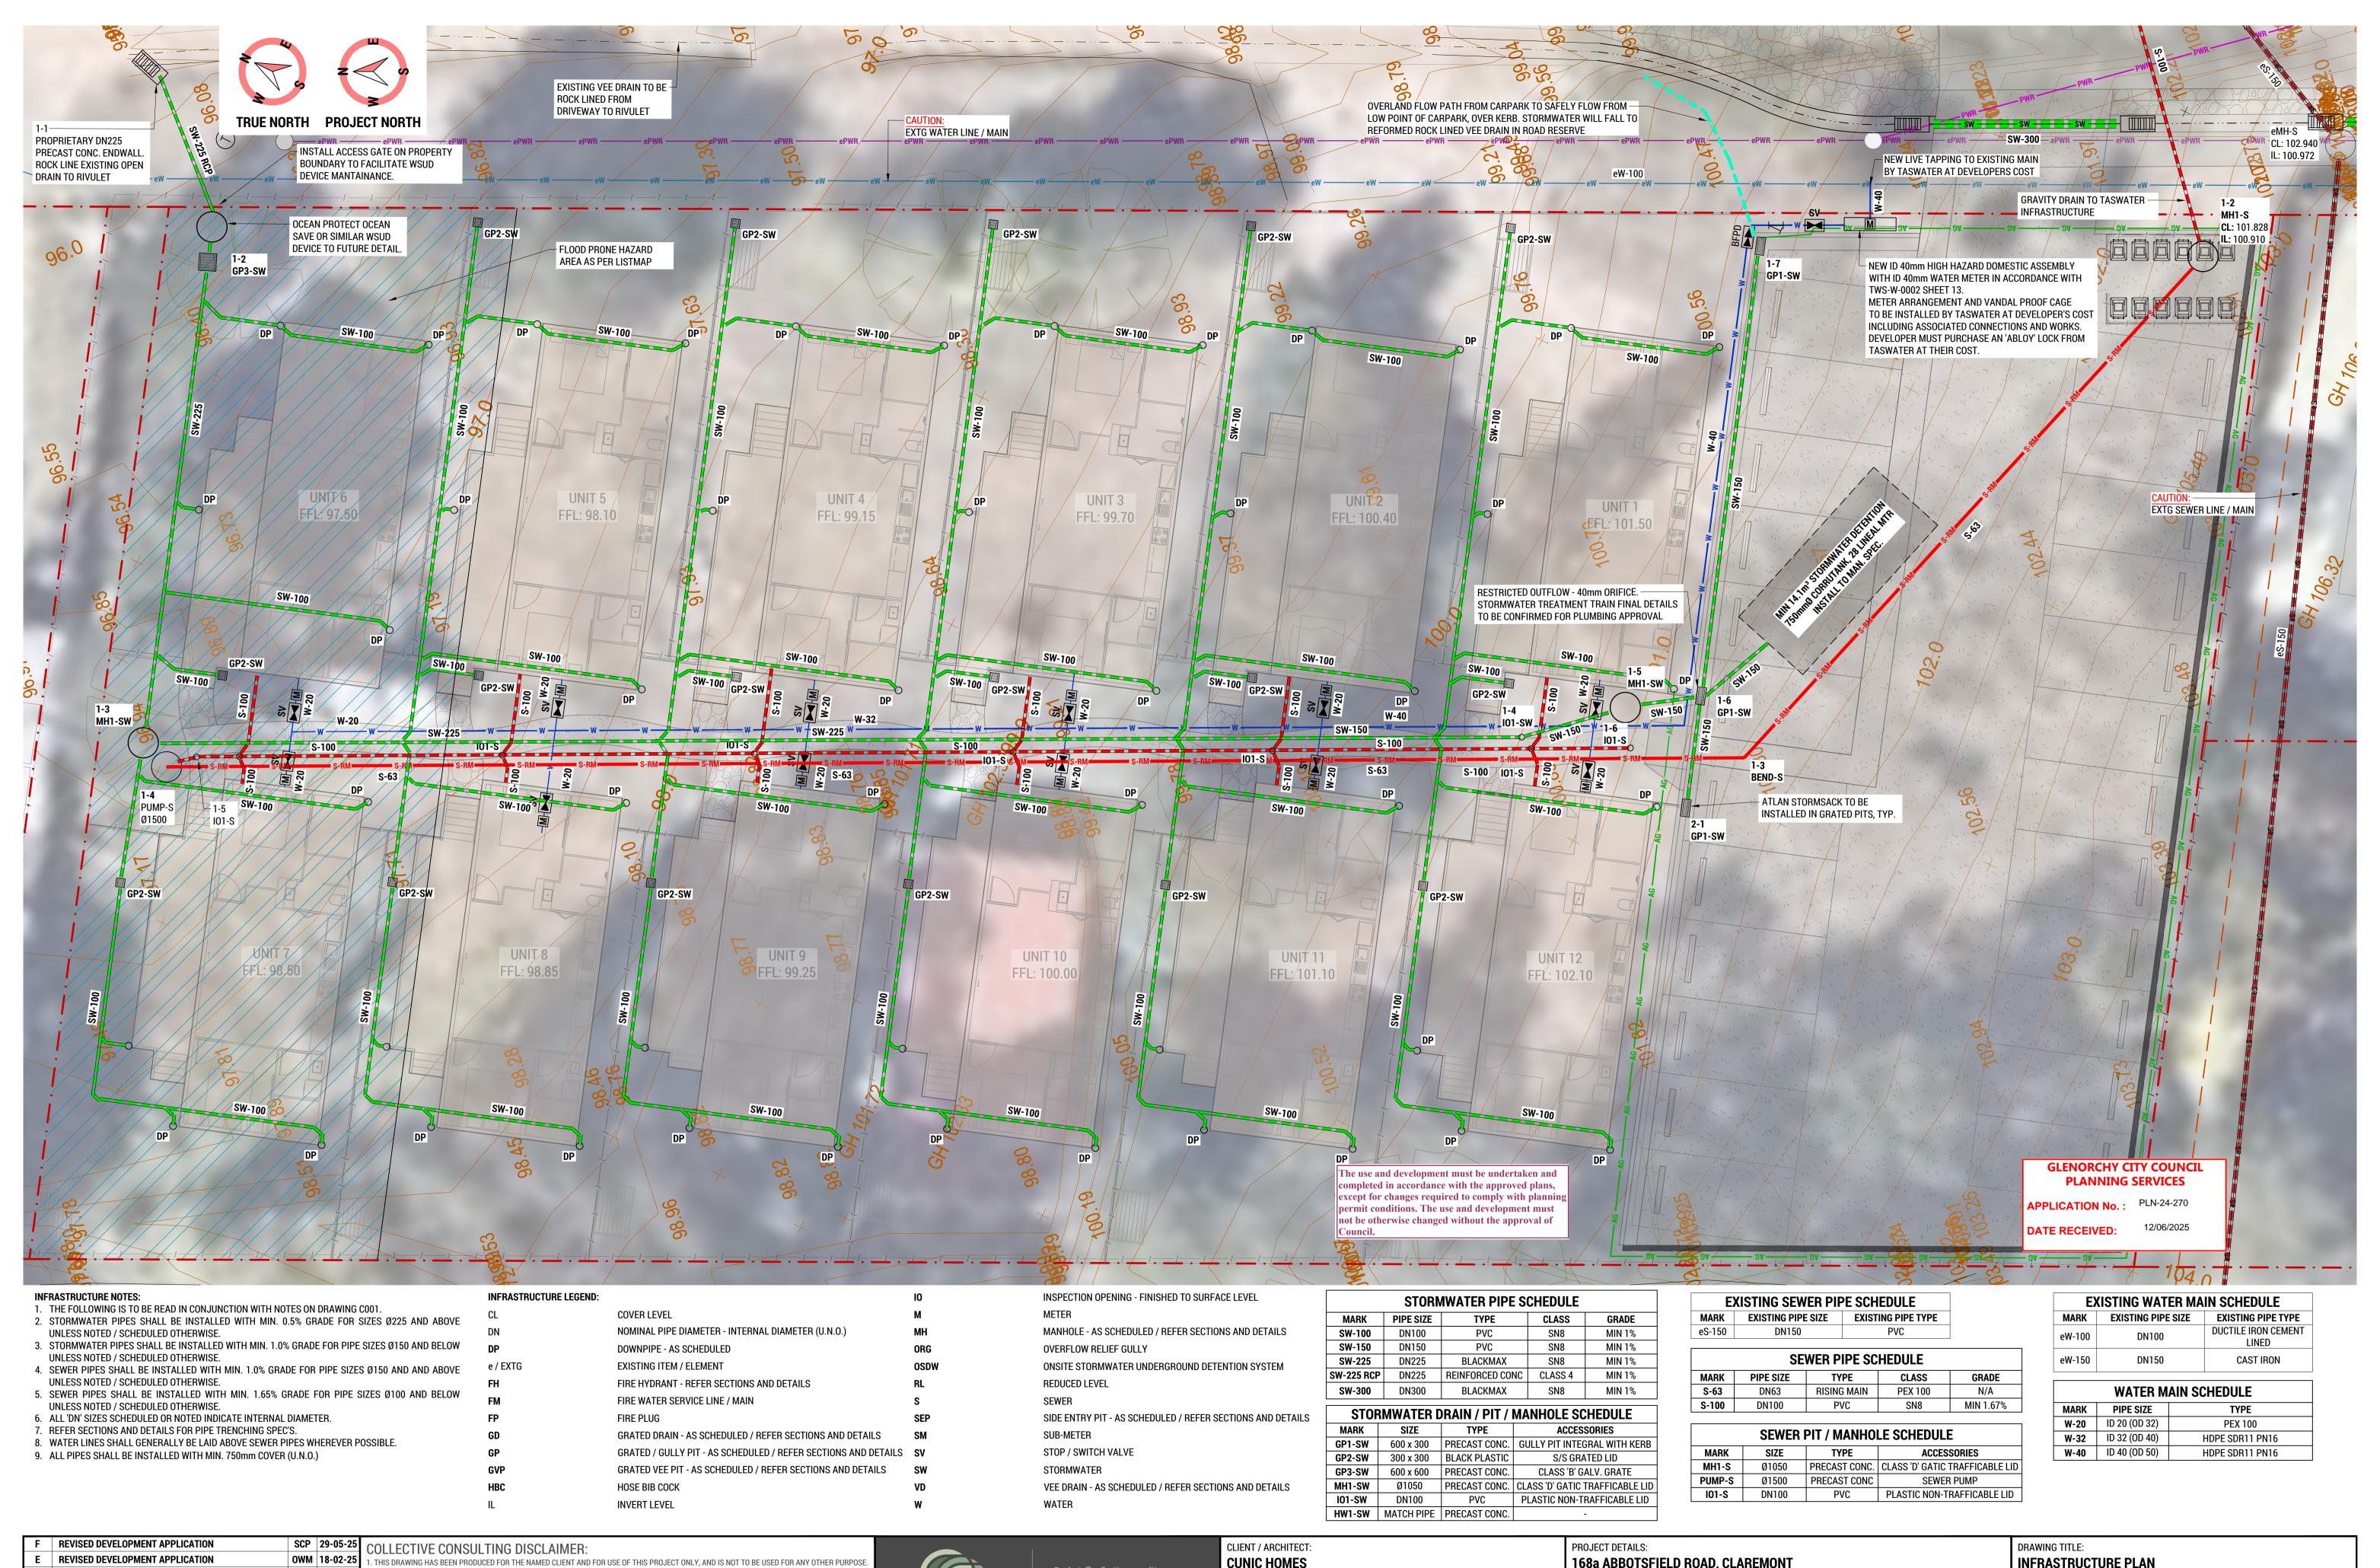
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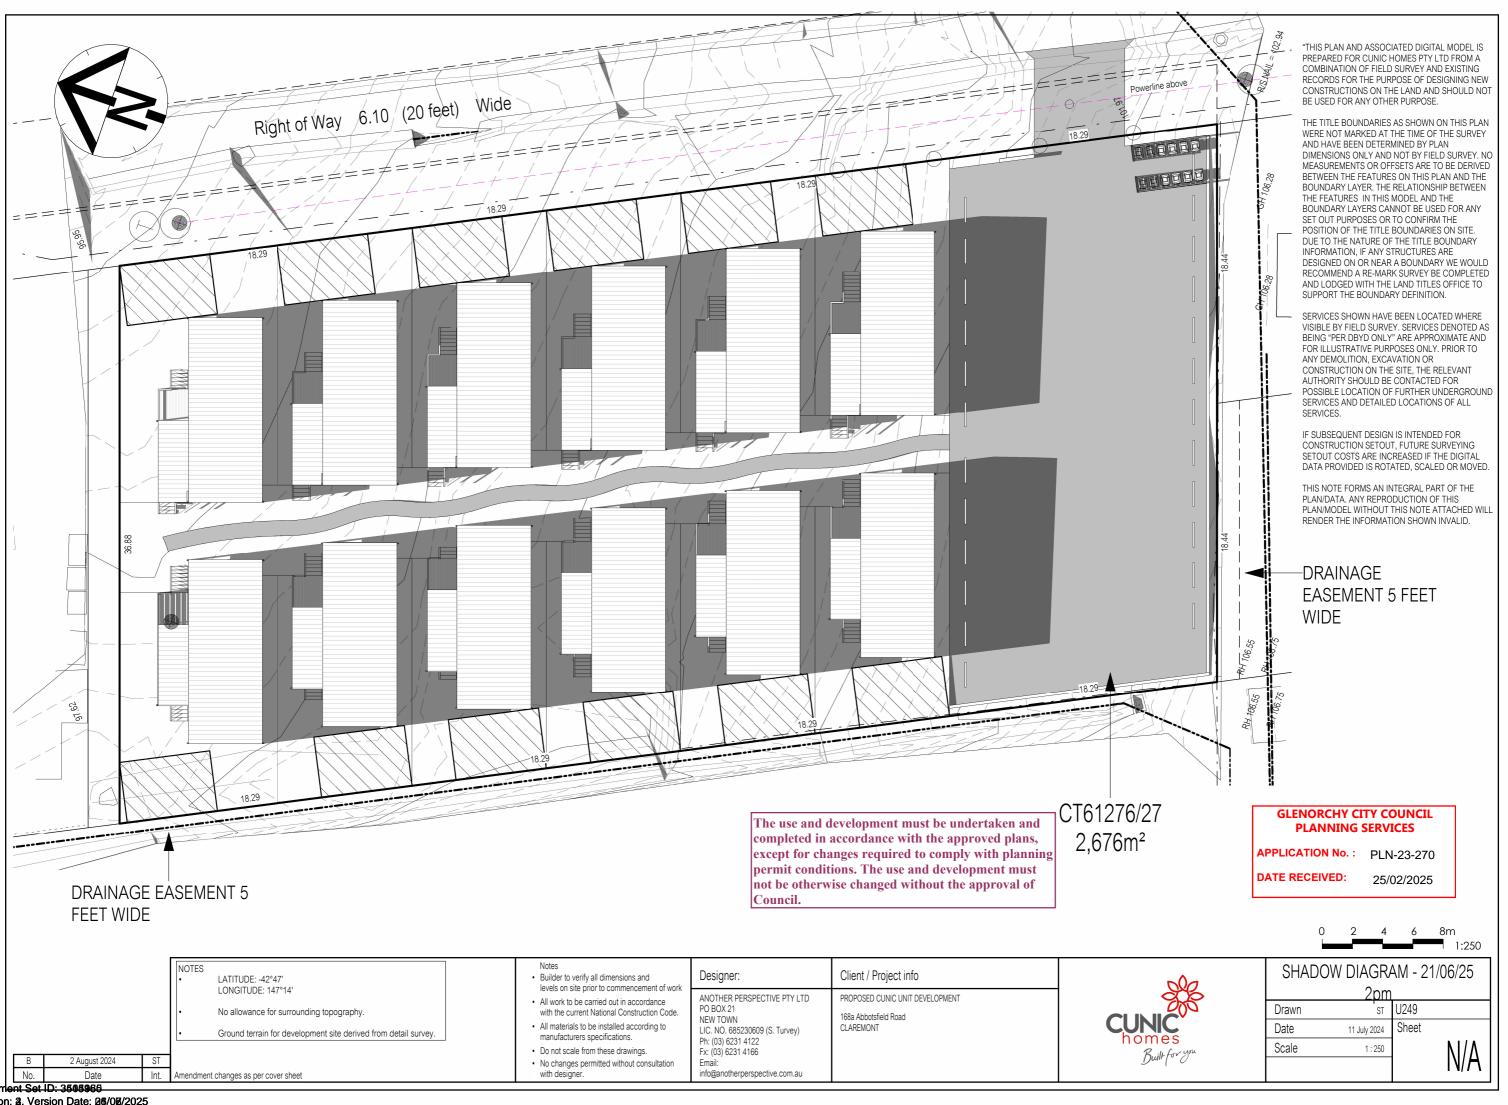





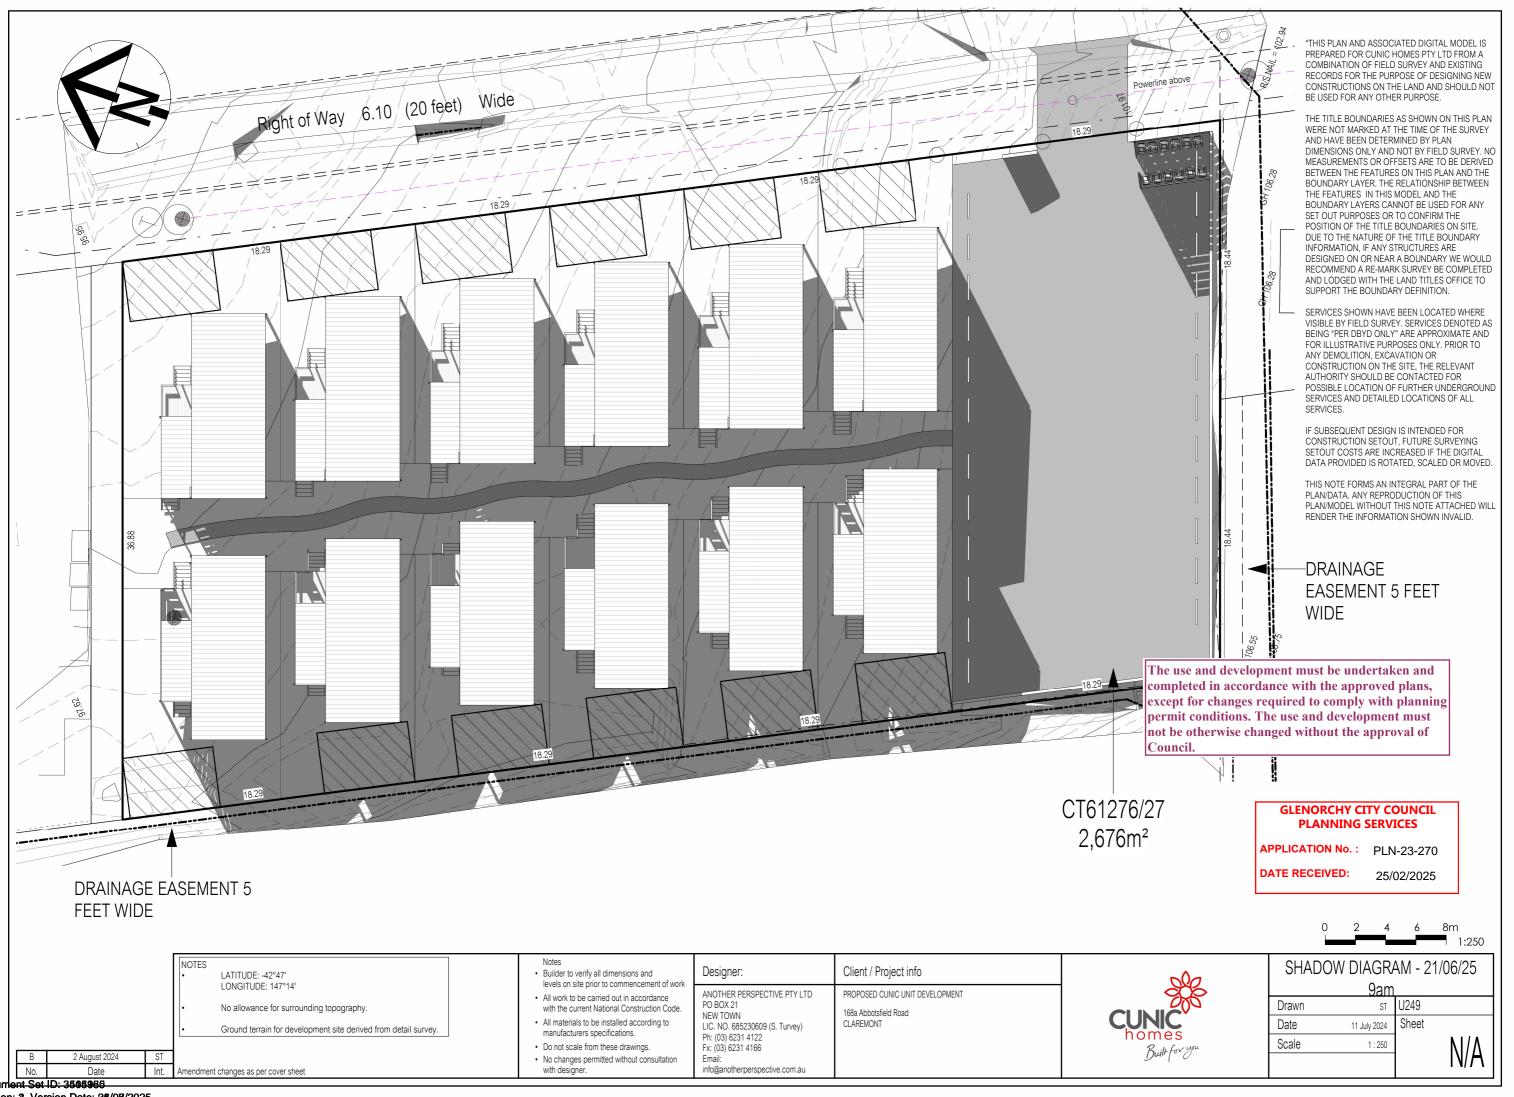

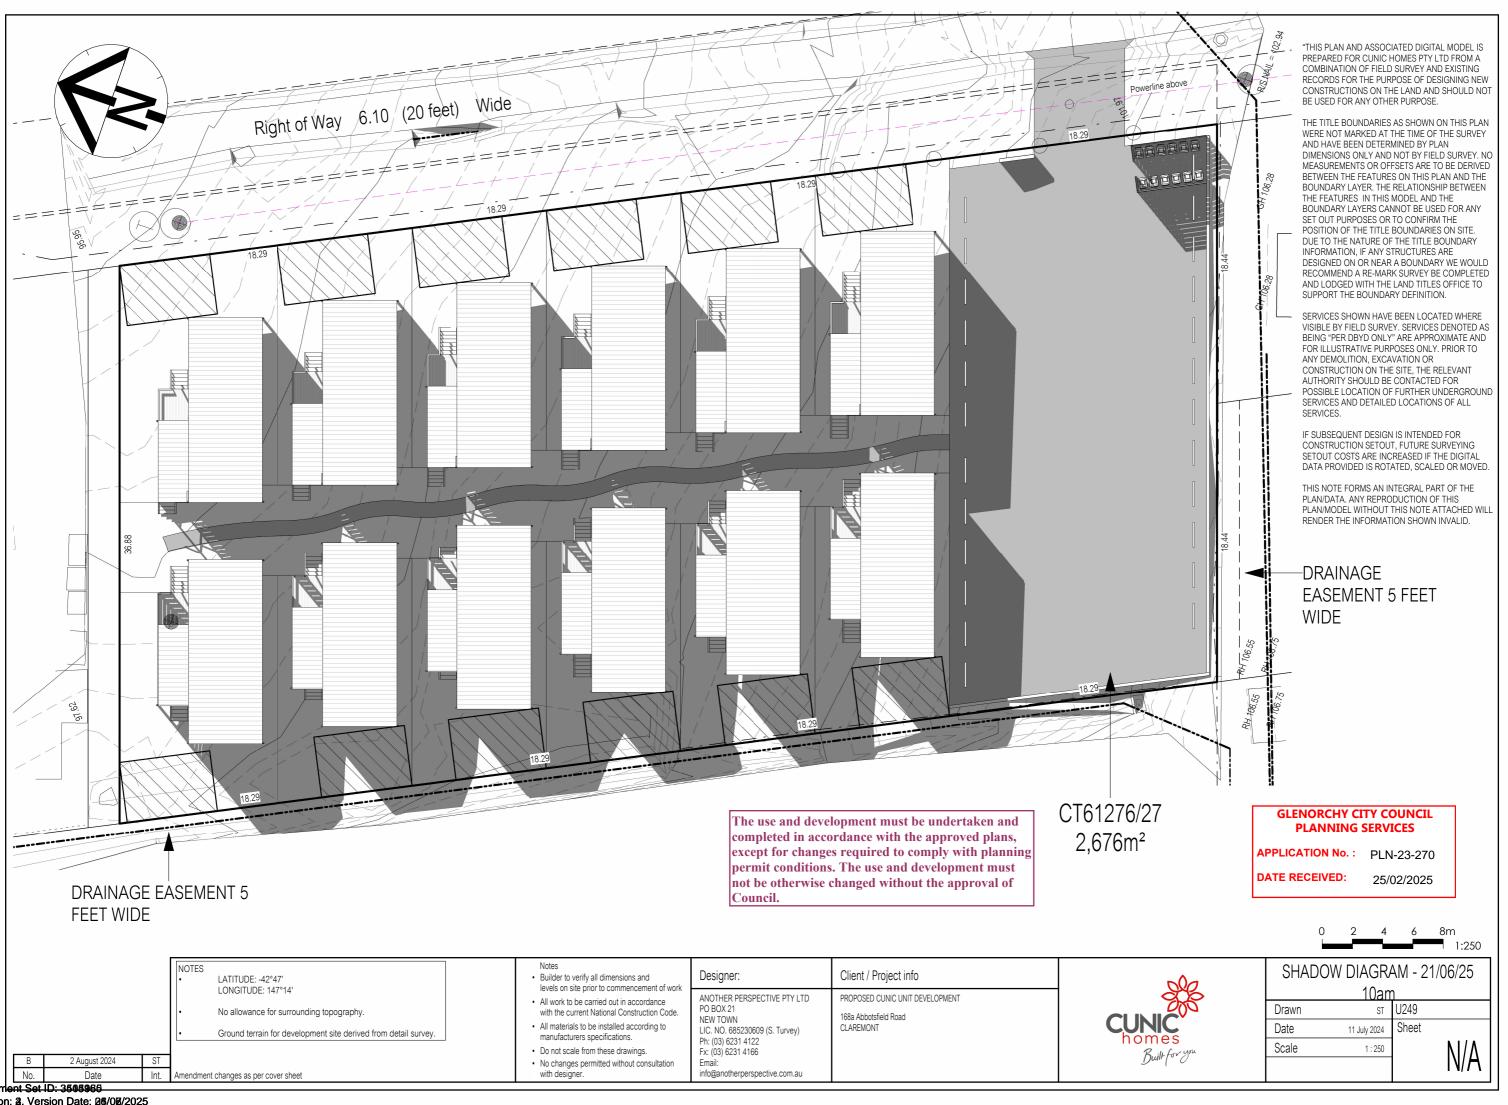


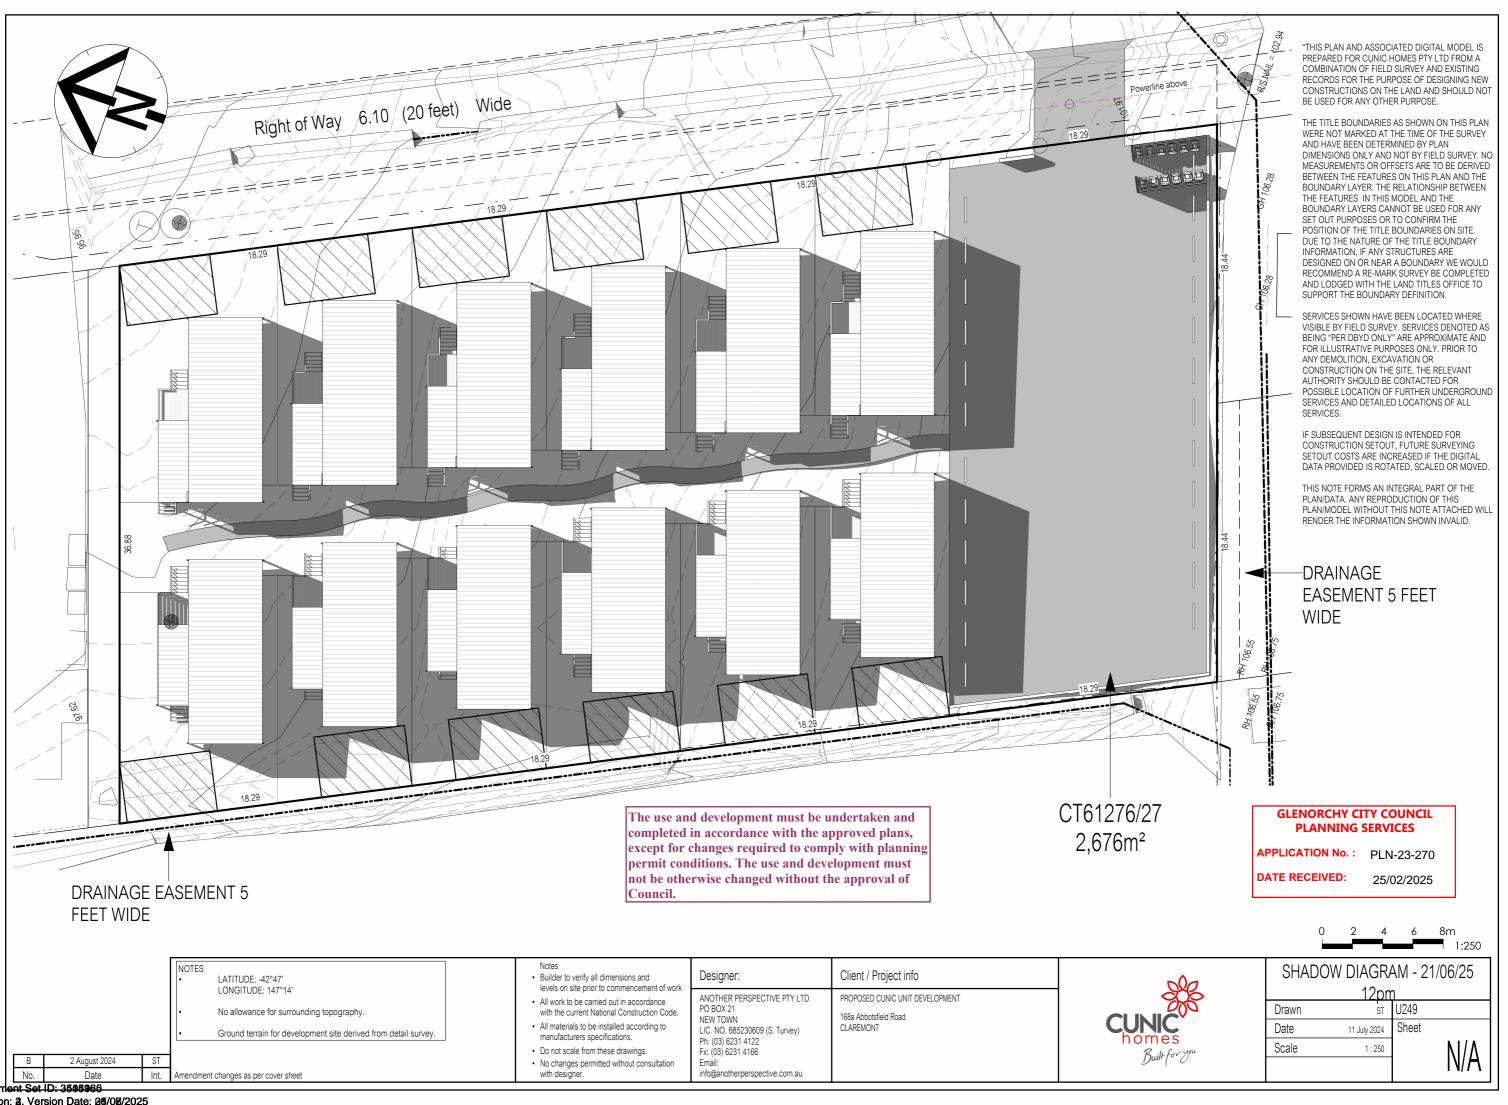


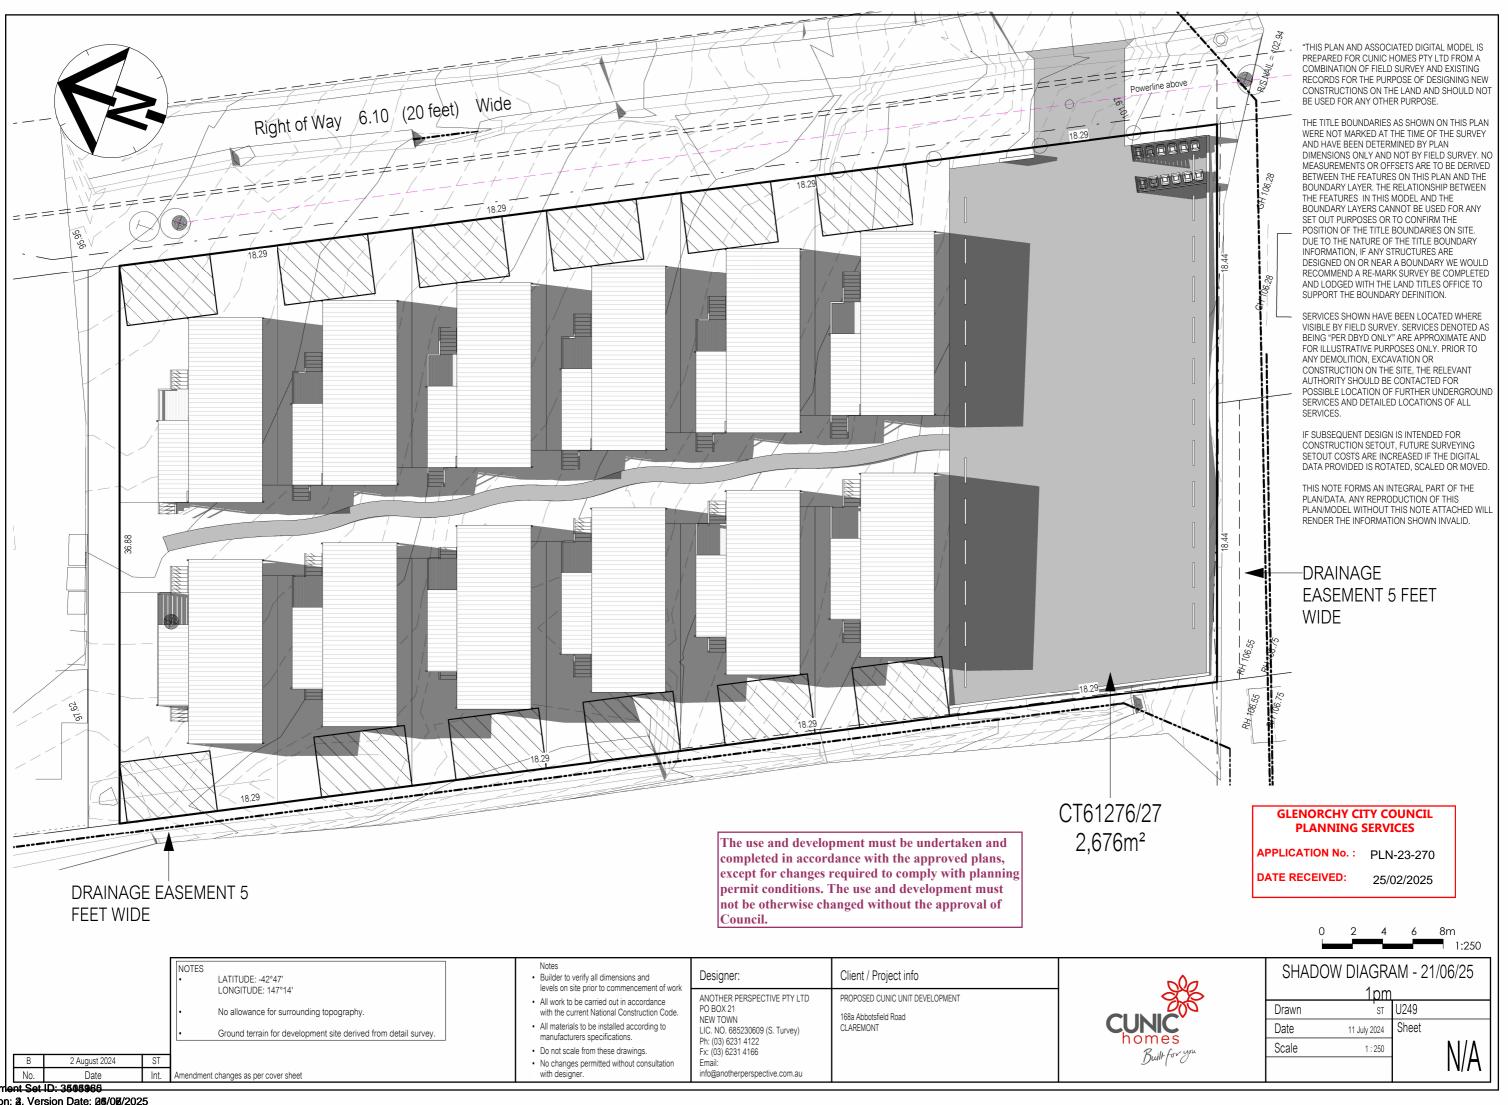


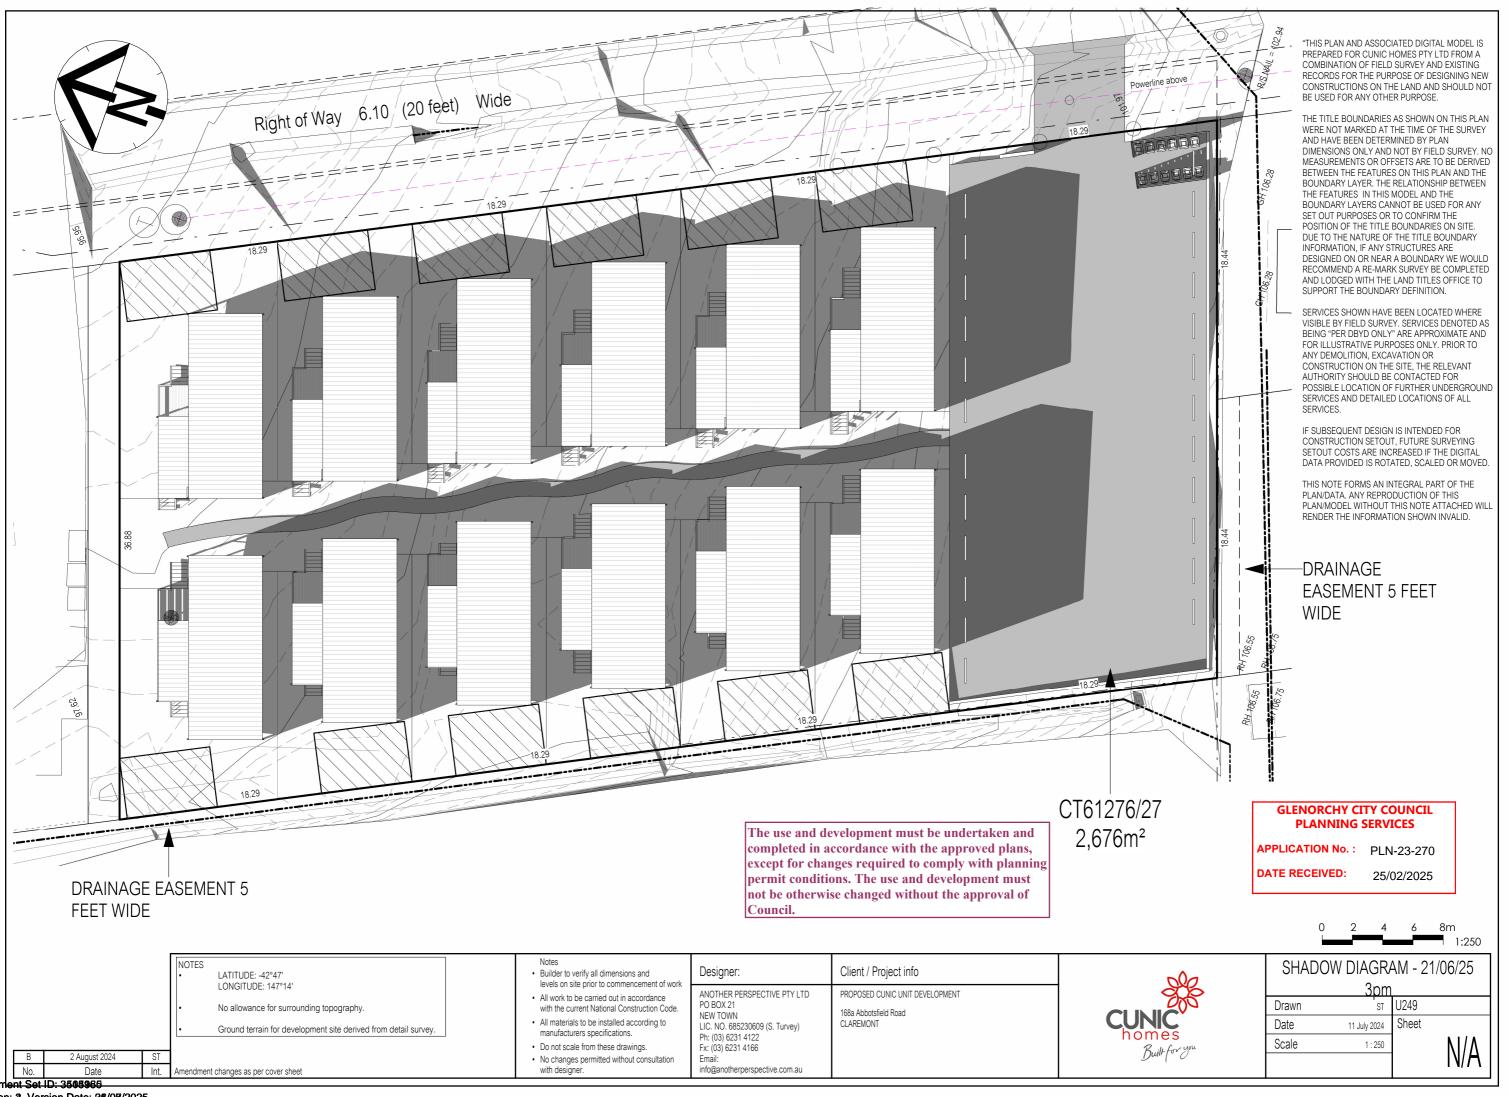




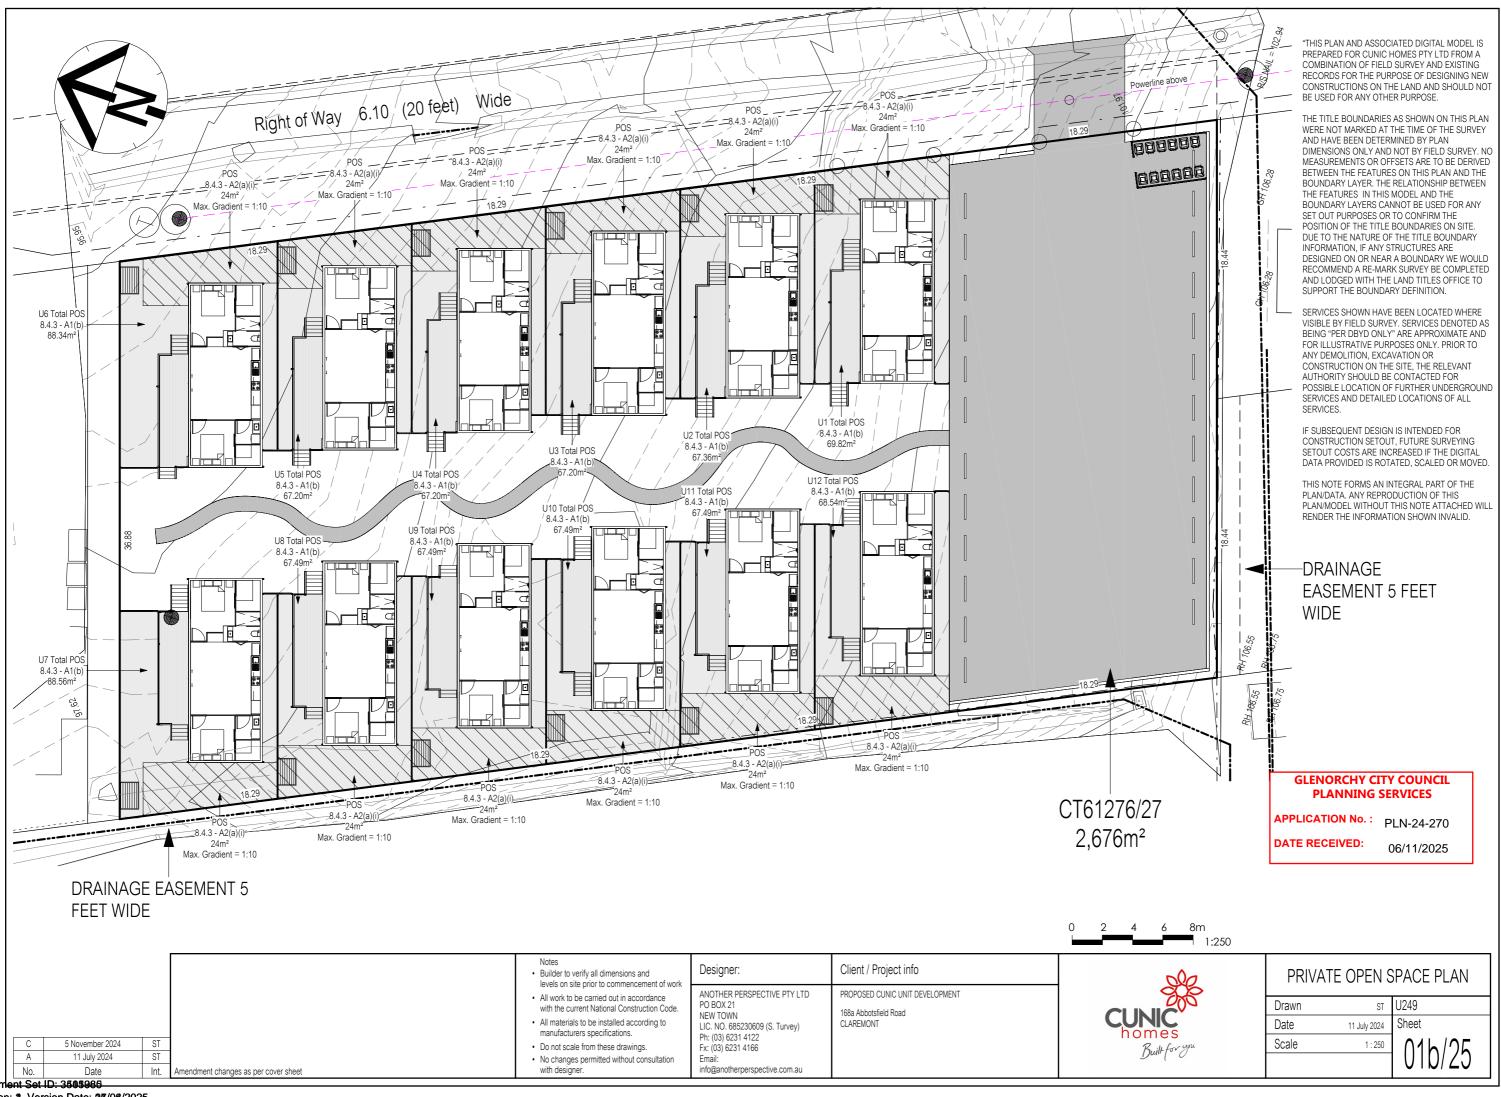

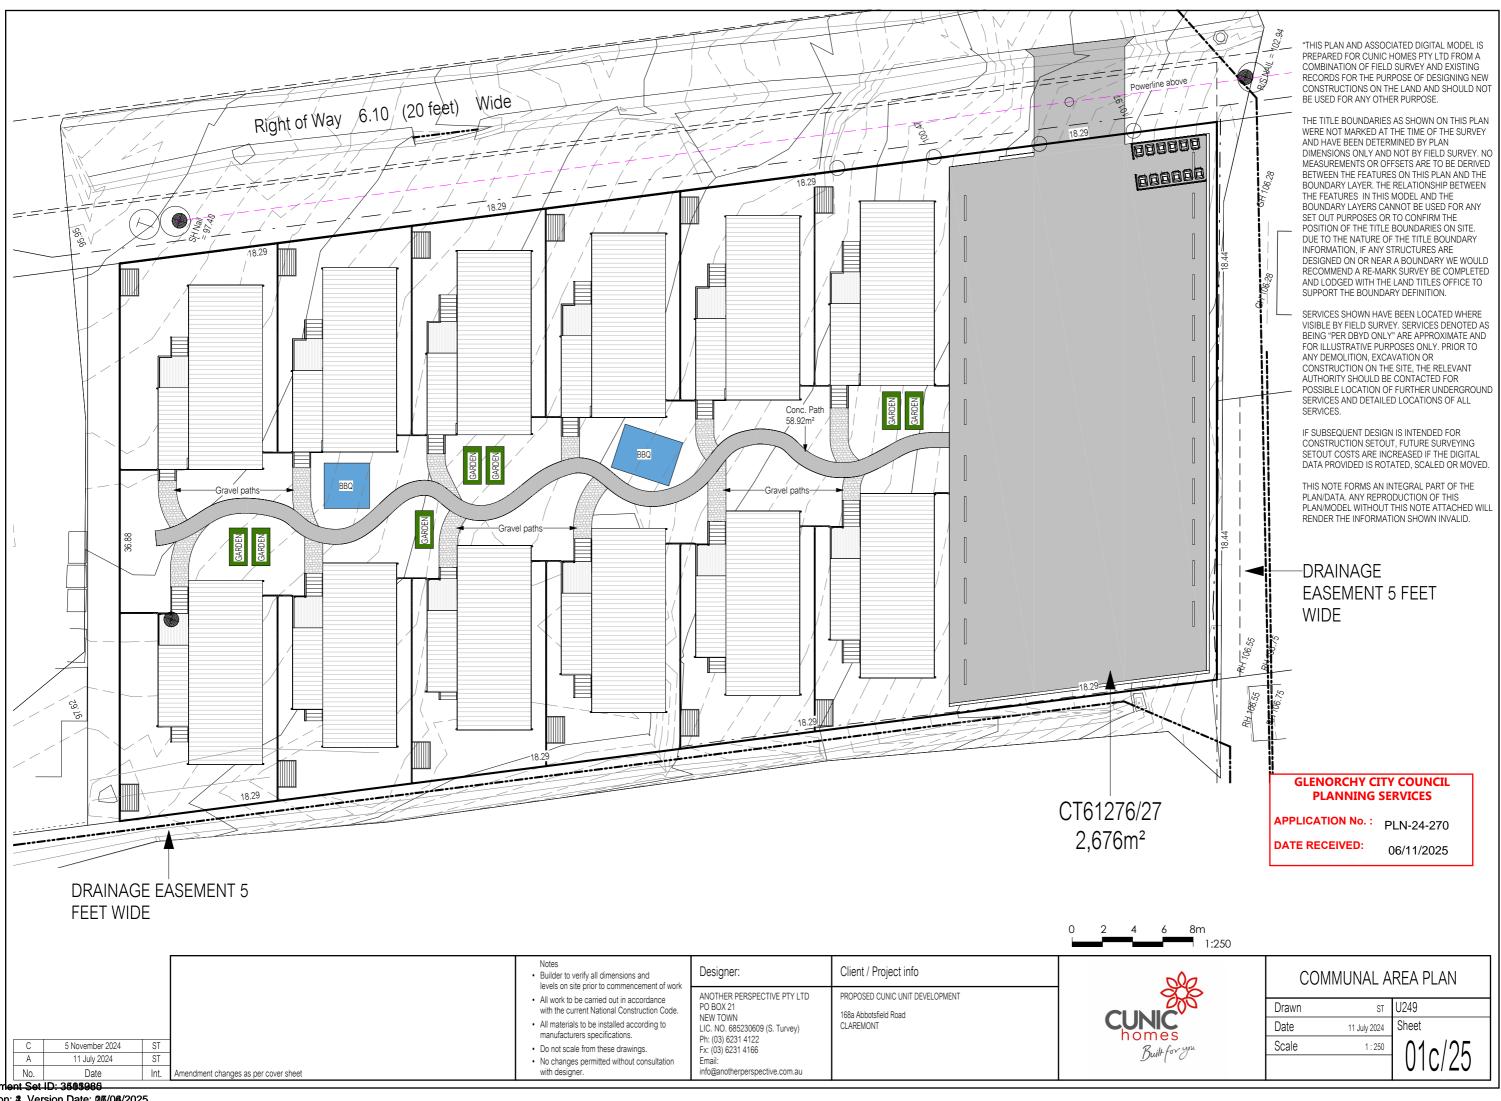

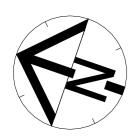




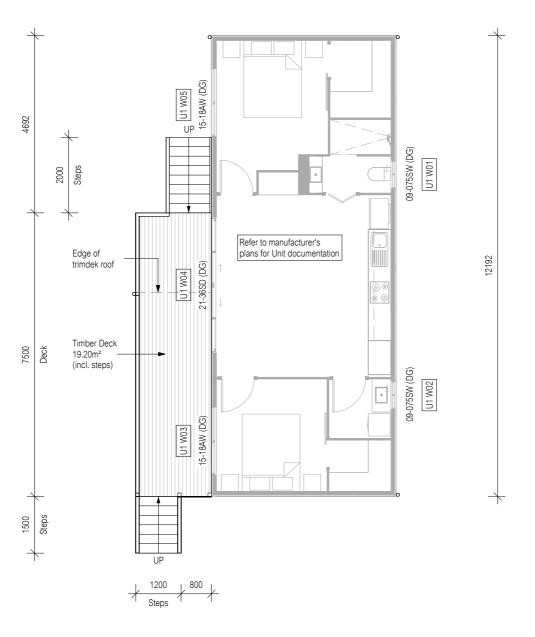

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GLENORCHY CITY COUNCIL PLANNING SERVICES

APPLICATION No.: PLN-24-270 6/11/2024 DATE RECEIVED:

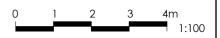

Floor Area = Refer to Manufacturer's Documentation

Int. Amendment changes as per cover sheet

Smoke Alarm (interconnected where more than 1)

All window sizes to be checked and/or confirmed

on site prior to ordering

glazing units

 Builder to verify all dimensions and levels on site prior to commencement of work All work to be carried out in accordance

with the current National Construction Code. All materials to be installed according to manufacturers specifications.

- Do not scale from these drawings.
- No changes permitted without consultation with designer.

| Designer: | Client / Project info |
|---|------------------------------------|
| ANOTHER PERSPECTIVE PTY LTD | PROPOSED CUNIC UNIT DEVELOPMENT |
| PO BOX 21 NEW TOWN LIC. NO. 685230609 (S. Turvey) Ph: (03) 6231 4122 Fx: (03) 6231 4166 Email: | 168a Abbotsfield Road CLAREMONT |

info@anotherperspective.com.au




| | UNIT 1 FLOOR PLAN | | | | |
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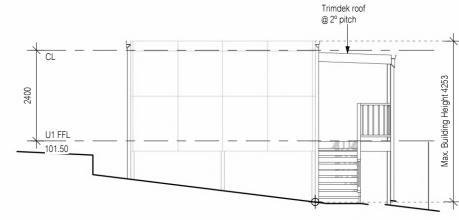
Date

Material Colour


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All lightweight cladding to be installed to manufacturer's guidelines. Refer to manufacturer's documentation.



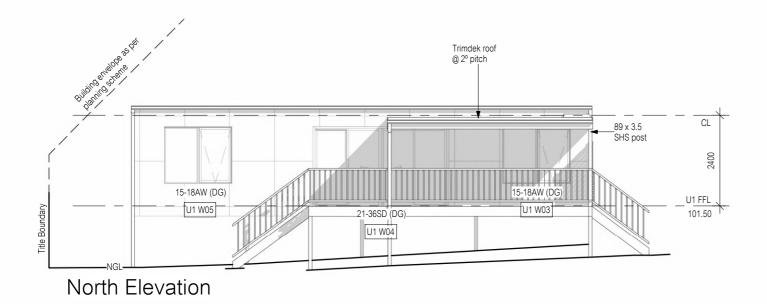


East Elevation

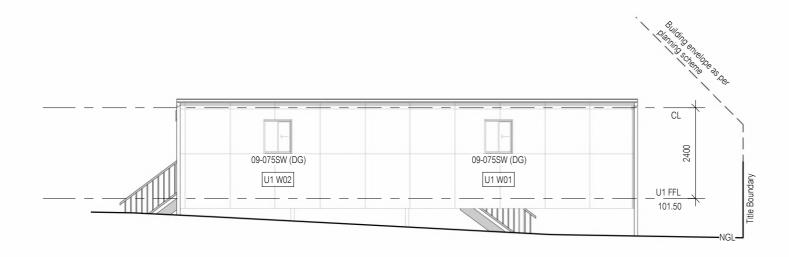

South Elevation

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| | | | | | All window sizes to be checked and/or confirmed on site prior to ordering glazing units | |
|----|---------------|------|--------------------------------------|----------|---|---|
| | | | | | culation Joint | |
| В | 2 August 2024 | ST | | BV - Bri | ck Vent | ı |
| Nο | Date | Int. | Amendment changes as per cover sheet | Shadow | s shown for stylisation purposes only | ı |
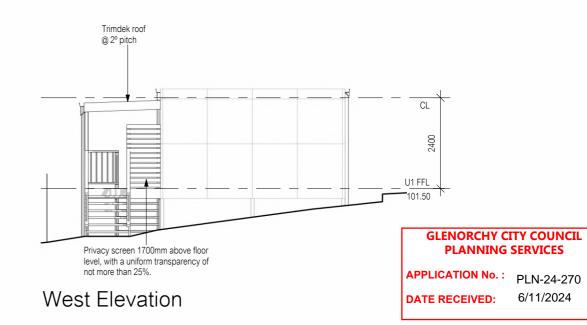
| | | Notes |
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| • | • | Builder to verify all dimensions and |
| | | levels on site prior to commencement |

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 All materials to be installed according to manufacturers specifications.


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| into@anotherperspective.com.au | |




| UNIT 1 ELEVATIONS | | | | |
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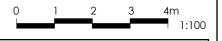


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> **GLENORCHY CITY COUNCIL PLANNING SERVICES**

APPLICATION No.: PLN-24-270

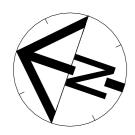DATE RECEIVED: 6/11/2024

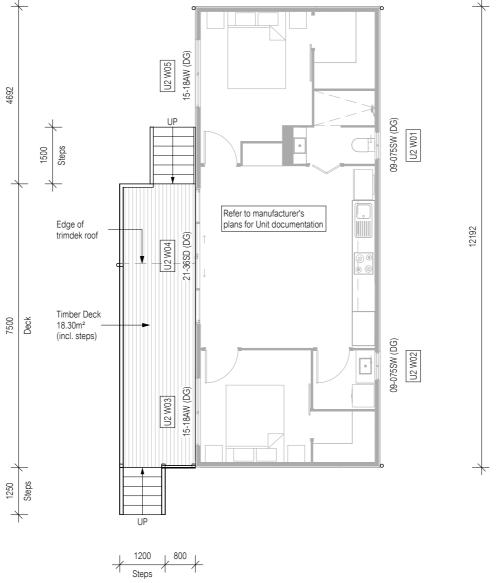

Floor Area = Refer to Manufacturer's Documentation

Int. Amendment changes as per cover sheet

Smoke Alarm (interconnected where more than 1)

All window sizes to be

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ANOTHER PERSPECTIVE PTY LTD PO BOX 21 NEW TOWN LIC. NO. 685230609 (S. Turvey) Ph: (03) 6231 4122 Fx: (03) 6231 4166

info@anotherperspective.com.au

Designer:

Client / Project info PROPOSED CUNIC UNIT DEVELOPMENT 168a Abbotsfield Road CLAREMONT




| | UNIT 2 FLOOR PLAN | | | |
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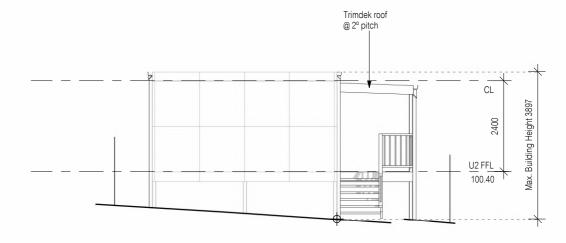
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Version: 3, Version Date: 36/06/2025

Material Colour
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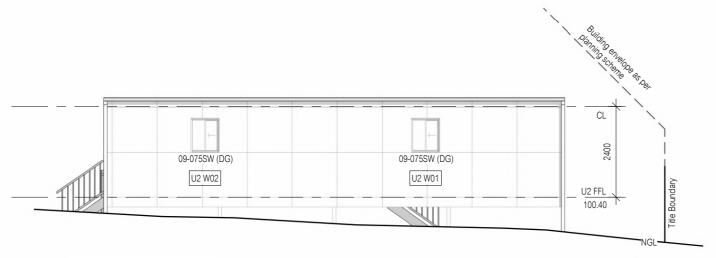
All lightweight cladding to be installed to manufacturer's guidelines. Refer to manufacturer's documentation.






North Elevation

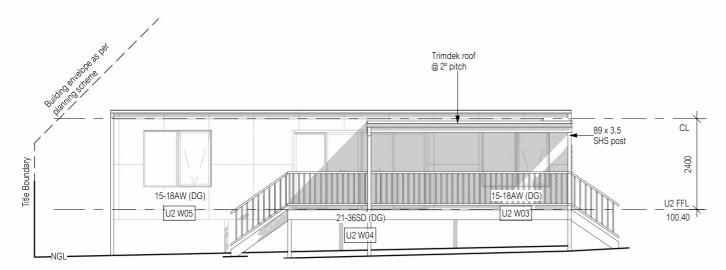East Elevation



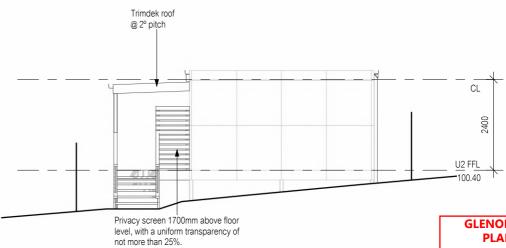

South Elevation

West Elevation

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GLENORCHY CITY COUNCIL PLANNING SERVICES

APPLICATION No.: PLN-24-270

DATE RECEIVED: 6/11/2024

| | | | | | All window sizes to be checked and/or confirmed on site prior to ordering glazing units | |
|----|---------------|-----|--------------------------------------|----------|---|-----|
| | | | | | iculation Joint | |
| В | 2 August 2024 | ST | | BV - Bri | CK Vent | |
| Nο | Date | Int | Amendment changes as per cover sheet | Shadow | s shown for stylisation purposes or | ılv |

| | Notes |
|---|--------------------------------------|
| • | Builder to verify all dimensions and |
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levels on site prior to commencement of work
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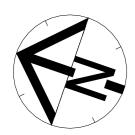
Do not scale from these drawings.
No changes permitted without consultation with designer.

| k | Designer: | Client / Project info |
|---|--|---|
| K | ANOTHER PERSPECTIVE PTY LTD PO BOX 21 NEW TOWN LIC. NO. 685230609 (S. Turvey) Ph: (03) 6231 4122 Fx: (03) 6231 4166 Email: | PROPOSED CUNIC UNIT DEVELOPMENT 168a Abbotsfield Road CLAREMONT |


info@anotherperspective.com.au



| UNIT 2 ELEVATIONS | | | | | |
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| Date | 13 June 2024 | Sheet | | | |
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GLENORCHY CITY COUNCIL PLANNING SERVICES

APPLICATION No.: PLN-24-270

DATE RECEIVED: 6/11/2024

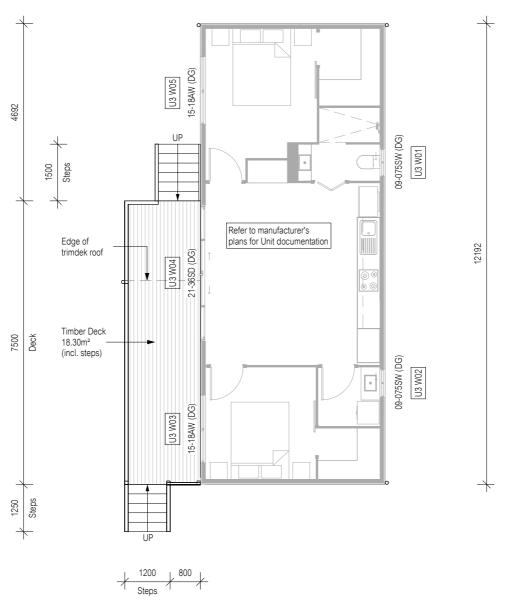

Floor Area = Refer to Manufacturer's Documentation

Int. Amendment changes as per cover sheet

Smoke Alarm (interconnected where more than 1)

All window sizes to be

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glazing units

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Client / Project info Designer: ANOTHER PERSPECTIVE PTY LTD PROPOSED CUNIC UNIT DEVELOPMENT PO BOX 21 NEW TOWN LIC. NO. 685230609 (S. Turvey) Ph: (03) 6231 4122 Fx: (03) 6231 4166 168a Abbotsfield Road CLAREMONT

info@anotherperspective.com.au





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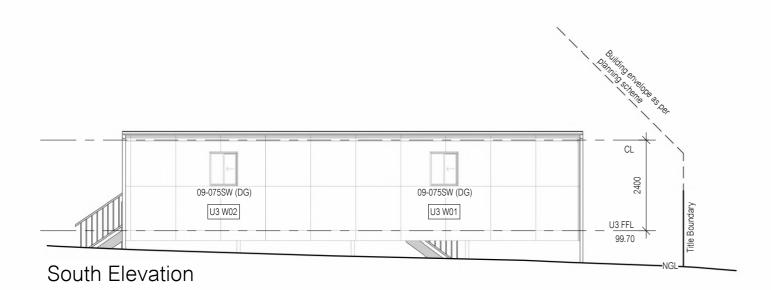
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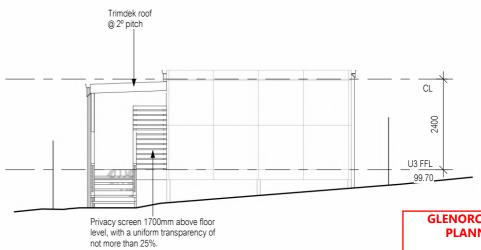
Trimdek Roof tbc

All lightweight cladding to be installed to manufacturer's guidelines. Refer to manufacturer's documentatior





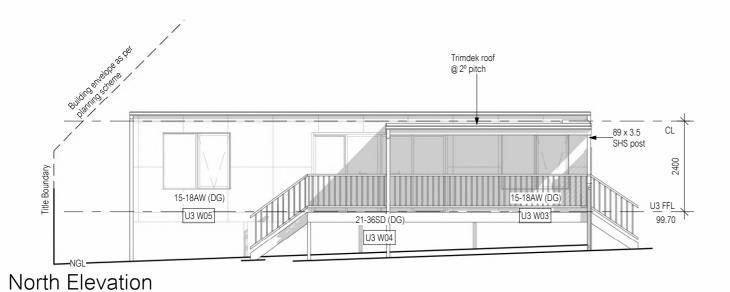

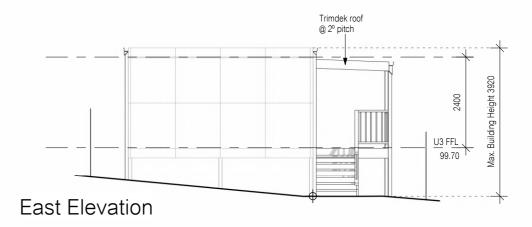

West Elevation

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GLENORCHY CITY COUNCIL PLANNING SERVICES

APPLICATION No.: PLN-24-270 DATE RECEIVED: 6/11/2024

Council. lient / Project info

| | | | | All window sizes to be checked and/or confirme on site prior to ordering glazing units | t |
|-----|---------------|------|--------------------------------------|---|-----------|
| | | | | LEGEND: AJ - Articulation Joint | |
| В | 2 August 2024 | ST | | BV - Brick Vent | |
| No. | Date | Int. | Amendment changes as per cover sheet | Shadows shown for stylisation purp | oses only |

| Notes Builder to verify all dimensions and levels on site prior to commencement of work | Designer: | Client / Project info |
|--|--|---|
| All work to be carried out in accordance with the current National Construction Code. All materials to be installed according to manufacturers specifications. Do not scale from these drawings. | ANOTHER PERSPECTIVE PTY LTD PO BOX 21 NEW TOWN LIC. NO. 685230609 (S. Turvey) Ph: (03) 6231 4122 Fx: (03) 6231 4166 | PROPOSED CUNIC UNIT DEVELOPMENT 168a Abbotsfield Road CLAREMONT |

info@anotherperspective.com.au


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| UNIT 3 ELEVATIONS | | | | |
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> **GLENORCHY CITY COUNCIL PLANNING SERVICES**

APPLICATION No.: PLN-24-270

DATE RECEIVED: 6/11/2024



Floor Area = Refer to Manufacturer's Documentation

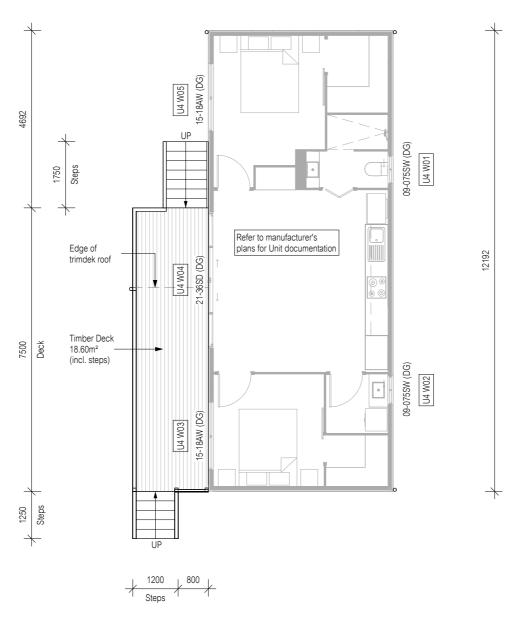Int. Amendment changes as per cover sheet

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levels on site prior to commencement of work

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Client / Project info Designer: ANOTHER PERSPECTIVE PTY LTD PROPOSED CUNIC UNIT DEVELOPMENT PO BOX 21 NEW TOWN LIC. NO. 685230609 (S. Turvey) Ph: (03) 6231 4122 Fx: (03) 6231 4166 168a Abbotsfield Road

info@anotherperspective.com.au

CLAREMONT

| | UNIT 4 FLOC | OR PLAN |
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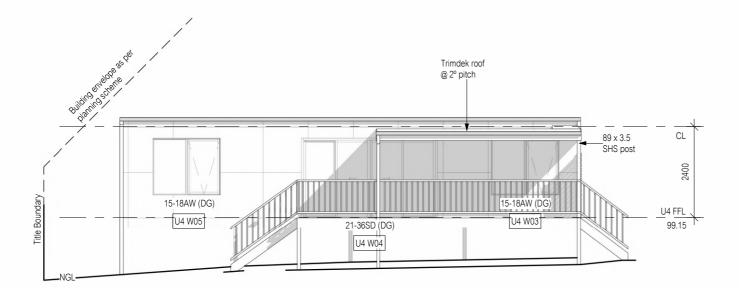
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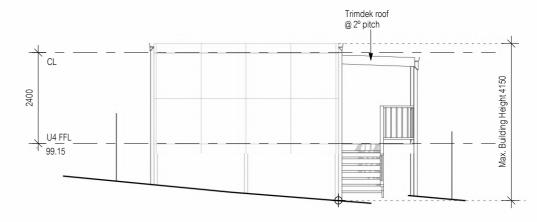
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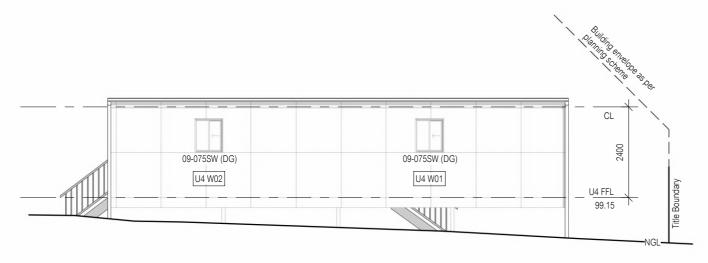
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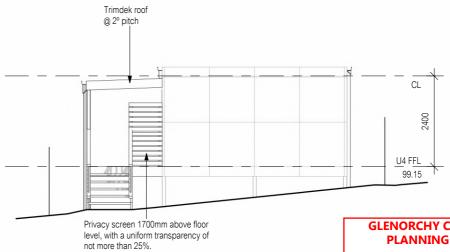
North Elevation



East Elevation



South Elevation



West Elevation

GLENORCHY CITY COUNCIL PLANNING SERVICES

APPLICATION No.: PLN-24-270 6/11/2024 DATE RECEIVED:

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|----|---------------|-----|--------------------------------------|----------|---|
| | | | | | culation Joint |
| В | 2 August 2024 | ST | | BV - Bri | ck vent |
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| | Notes |
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| • | Builder to verify all dimensions and |
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 All work to be carried out in accordance with the current National Construction Code.

All materials to be installed according to manufacturers specifications.


 Do not scale from these drawings. No changes permitted without consultation with designer.

| Designer: | Client / Project info |
|--|---|
| ANOTHER PERSPECTIVE PTY LTD PO BOX 21 NEW TOWN LIC. NO. 685230609 (S. Turvey) Ph: (03) 6231 4122 Fx: (03) 6231 4166 | PROPOSED CUNIC UNIT DEVELOPMENT 168a Abbotsfield Road CLAREMONT |


info@anotherperspective.com.au

| | UNIT 4 ELEV | 'ATIONS |
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| Date | 13 June 2024 | Sheet |
| Scale | 1:100 | 00/25 |

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The use and development must be undertaken and completed in accordance with the approved plans, except for changes required to comply with planning permit conditions. The use and development must not be otherwise changed without the approval of
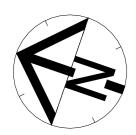
> **GLENORCHY CITY COUNCIL PLANNING SERVICES**

APPLICATION No.: PLN-24-270

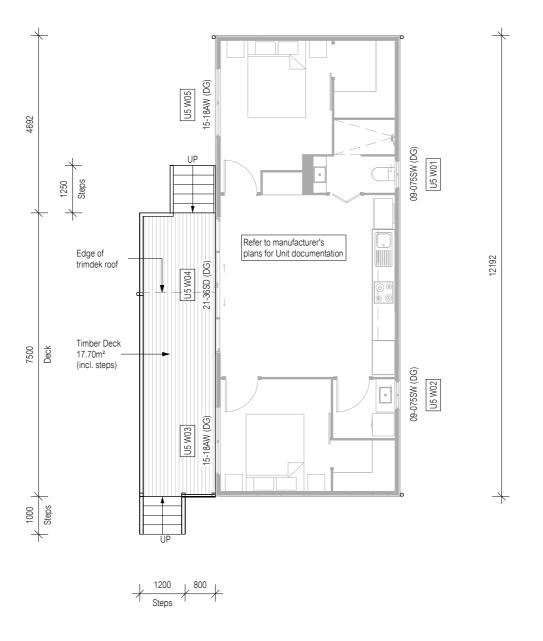6/11/2024 DATE RECEIVED:



Floor Area = Refer to Manufacturer's Documentation

Int. Amendment changes as per cover sheet

Smoke Alarm (interconnected where more than 1)

Builder to verify all dimensions and

All window sizes to be

checked and/or confirmed

on site prior to ordering

glazing units

levels on site prior to commencement of work

 All work to be carried out in accordance with the current National Construction Code.

All materials to be installed according to manufacturers specifications.

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Client / Project info Designer: ANOTHER PERSPECTIVE PTY LTD

PO BOX 21 NEW TOWN LIC. NO. 685230609 (S. Turvey) Ph: (03) 6231 4122 Fx: (03) 6231 4166

info@anotherperspective.com.au

PROPOSED CUNIC UNIT DEVELOPMENT 168a Abbotsfield Road CLAREMONT




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| | Copyright © | 10/20 |

No. Date


Material Colour

Trimdek Roof tbc


All lightweight cladding to be installed to manufacturer's guidelines. Refer to manufacturer's documentation.

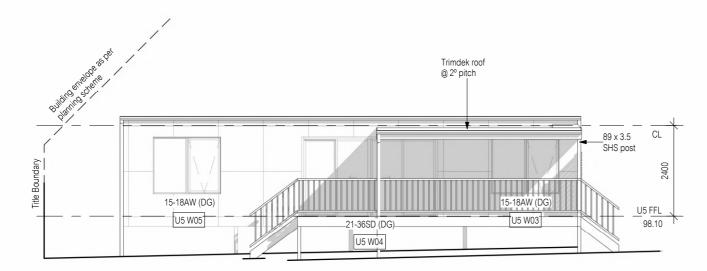

North Elevation

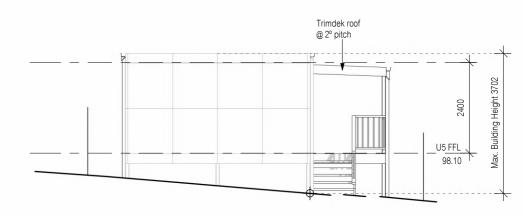



East Elevation

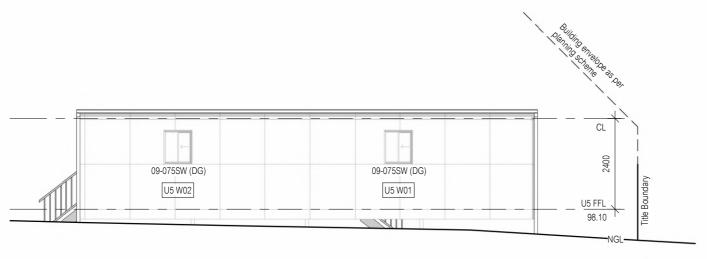

South Elevation

The use and development must be undertaken and completed in accordance with the approved plans, except for changes required to comply with planning permit conditions. The use and development must not be otherwise changed without the approval of Council.

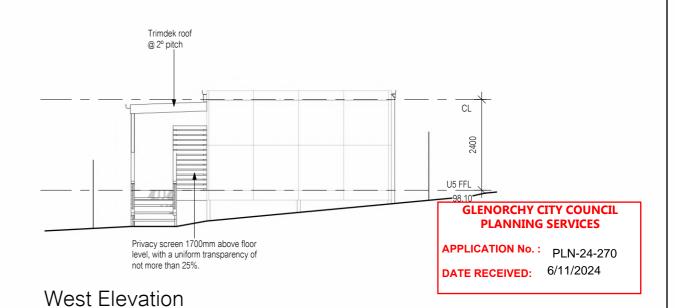

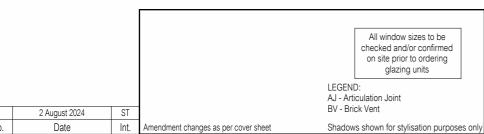

| | Notes |
|---|--------------------------------------|
| • | Builder to verify all dimensions and |
| | levels on site prior to commencement |

levels on site prior to commencement of work
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Designer:

ANOTHER PERSPECTIVE PTY LTD
PO BOX 21
NEW TOWN
LIC. NO. 685230609 (S. Turvey)
Ph: (03) 6231 4122
Fx: (03) 6231 4166


Client / Project info
PROPOSED CUNIC UNIT DEVELOPMENT
168a Abbotsfield Road
CLAREMONT
CLAREMONT

info@anotherperspective.com.au


CUNIC homes

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> **GLENORCHY CITY COUNCIL PLANNING SERVICES**

APPLICATION No.: PLN-24-270

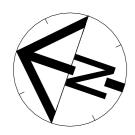DATE RECEIVED: 6/11/2024

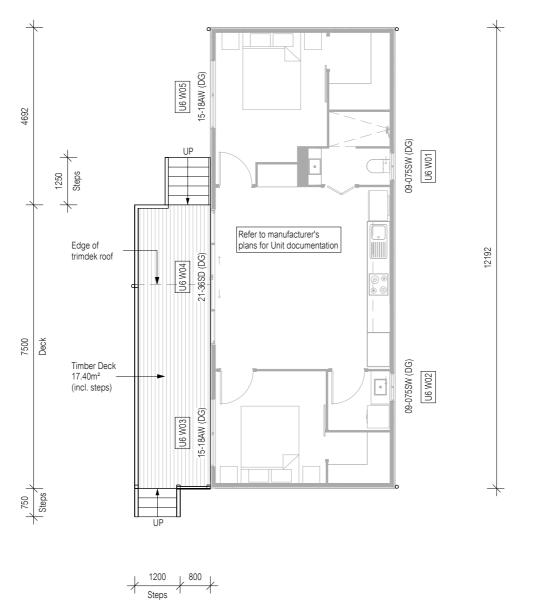

Floor Area = Refer to Manufacturer's Documentation

Int. Amendment changes as per cover sheet

Smoke Alarm (interconnected where more than 1)

Builder to verify all dimensions and levels on site prior to commencement of work

All window sizes to be

checked and/or confirmed

on site prior to ordering

glazing units

All work to be carried out in accordance

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| Designer: | Client / |
|-----------------------------|----------|
| ANOTHER PERSPECTIVE PTY LTD | PROPOSE |
| PO BOX 21 | 168a Abb |

NEW TOWN LIC. NO. 685230609 (S. Turvey) Ph: (03) 6231 4122 Fx: (03) 6231 4166

info@anotherperspective.com.au

t / Project info SED CUNIC UNIT DEVELOPMENT botsfield Road CLAREMONT




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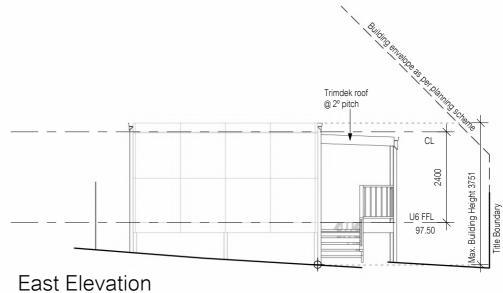
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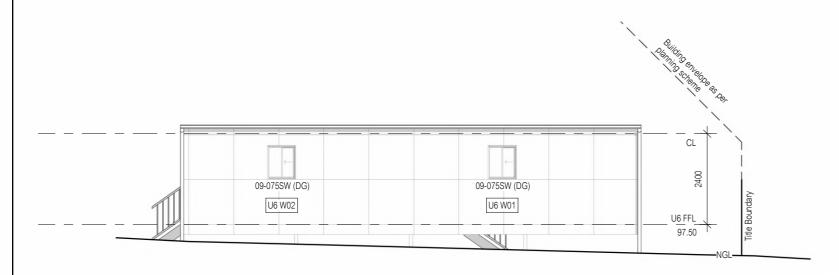
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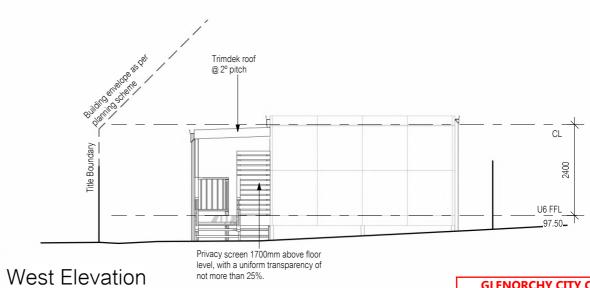
Trimdek Roof tbc

All lightweight cladding to be installed to manufacturer's guidelines. Refer to manufacturer's documentation







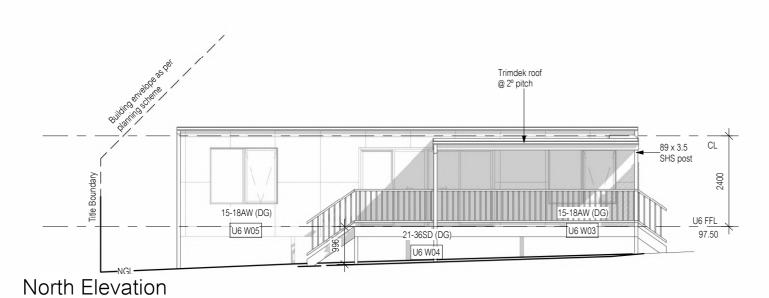

South Elevation

The use and development must be undertaken and completed in accordance with the approved plans, except for changes required to comply with planning permit conditions. The use and development must not be otherwise changed without the approval of Council.

not more than 25%.

GLENORCHY CITY COUNCIL PLANNING SERVICES

APPLICATION No.: PLN-24-270 DATE RECEIVED: 6/11/2024

| | | | | | All window sizes to be checked and/or confirmed on site prior to ordering glazing units |
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| | Notes |
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| • | Builder to verify all dimensions and |
| | levels on site prior to commencement of work |

 All work to be carried out in accordance with the current National Construction Code.

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· Do not scale from these drawings. No changes permitted without consultation with designer.

| PO BOX 21 |
|--------------------------------|
| NEW TOWN |
| LIC. NO. 685230609 (S. Turvey) |
| Ph: (03) 6231 4122 |
| Fx: (03) 6231 4166 |
| Email: |
| infn@anothernersnective.com.au |

ANOTHER PERSPECTIVE PTY LTD

Designer:

Client / Project info


168a Abbotsfield Road

CLAREMONT


PROPOSED CUNIC UNIT DEVELOPMENT



| | UNIT 6 ELEV | 'ATIONS |
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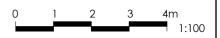


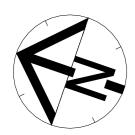The use and development must be undertaken and completed in accordance with the approved plans, except for changes required to comply with planning permit conditions. The use and development must not be otherwise changed without the approval of Council.

> **GLENORCHY CITY COUNCIL PLANNING SERVICES**

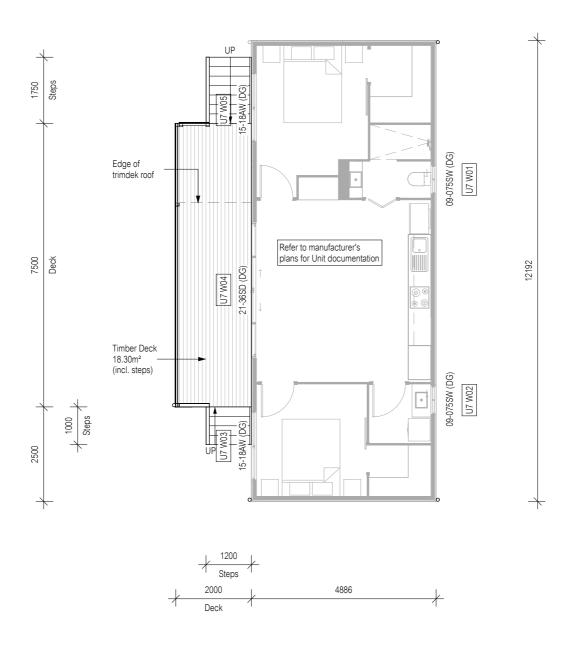APPLICATION No.: PLN-24-270

DATE RECEIVED: 6/11/2024



Floor Area = Refer to Manufacturer's Documentation

Int. Amendment changes as per cover sheet

Smoke Alarm (interconnected where more than 1)

All window sizes to be

checked and/or confirmed

on site prior to ordering

glazing units

- Builder to verify all dimensions and levels on site prior to commencement of work
- All work to be carried out in accordance with the current National Construction Code.
- All materials to be installed according to manufacturers specifications.
- Do not scale from these drawings.
- No changes permitted without consultation with designer.

| Designer: | Client / Project info |
|--|---|
| ANOTHER PERSPECTIVE PTY LTD PO BOX 21 NEW TOWN LIC. NO. 685230609 (S. Turvey) Ph: (03) 6231 4122 Fx: (03) 6231 4166 | PROPOSED CUNIC UNIT DEVELOPMENT 168a Abbotsfield Road CLAREMONT |

info@anotherperspective.com.au

| | UNIT 7 FLOC | R PLAN |
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Trimdek Roof All lightweight cladding to be installed to manufacturer's guidelines. Refer to anufacturer's documentation Trimdek roof @ 2º pitch Trimdek roof CL CL 89 x 3.5 SHS post 15-18AW (DG) U7 FFL U7 W03 1-36SD (DG)_ 98.50 98.50 U7 W04 Privacy screen 1700mm above floor level, with a uniform transparency of North Elevation East Elevation not more than 25%. Trimdek roof @ 2° pitch CL 09-075SW (DG) 09-075SW (DG) U7 W02 U7 W01 U7 FFL U7 FFL 98.50 West Elevation South Elevation **GLENORCHY CITY COUNCIL PLANNING SERVICES** The use and development must be undertaken and APPLICATION No.: PLN-24-270 completed in accordance with the approved plans, except for changes required to comply with planning DATE RECEIVED: 6/11/2024 permit conditions. The use and development must not be otherwise changed without the approval of Council. Client / Project info Designer: **UNIT 7 ELEVATIONS** Builder to verify all dimensions and All window sizes to be levels on site prior to commencement of work checked and/or confirmed ANOTHER PERSPECTIVE PTY LTD PROPOSED CUNIC UNIT DEVELOPMENT All work to be carried out in accordance on site prior to ordering PO BOX 21 Drawn with the current National Construction Code. NEW TOWN LIC. NO. 685230609 (S. Turvey) Ph: (03) 6231 4122 Fx: (03) 6231 4166 168a Abbotsfield Road glazing units All materials to be installed according to manufacturers specifications. Date 13 June 2024 Sheet CLAREMONT LEGEND: AJ - Articulation Joint

info@anotherperspective.com.au

· Do not scale from these drawings.

No changes permitted without consultation with designer.

BV - Brick Vent

Shadows shown for stylisation purposes only

Scale


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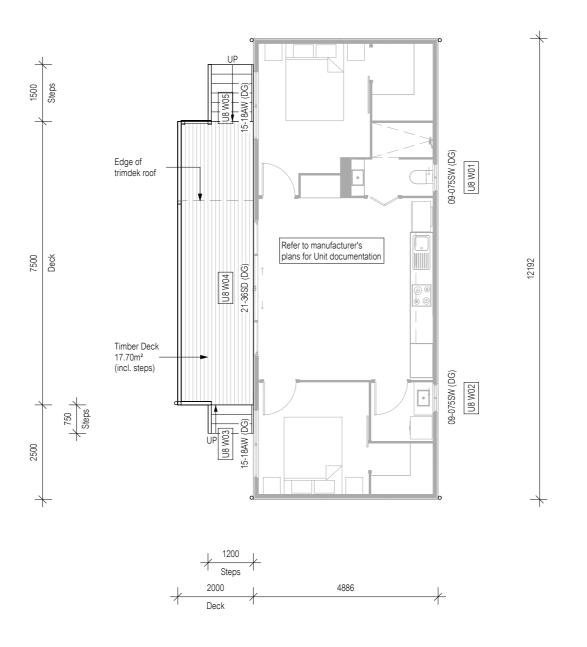
Version: 2, Version Date: 26/06/2025

2 August 2024

Amendment changes as per cover sheet





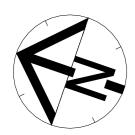


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APPLICATION No.: PLN-24-270

DATE RECEIVED: 6/11/2024



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Client / Project info Designer: ANOTHER PERSPECTIVE PTY LTD

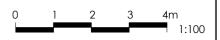PO BOX 21 NEW TOWN LIC. NO. 685230609 (S. Turvey) Ph: (03) 6231 4122 Fx: (03) 6231 4166

info@anotherperspective.com.au

PROPOSED CUNIC UNIT DEVELOPMENT 168a Abbotsfield Road CLAREMONT



| | UNIT 8 FLOC | R PLAN |
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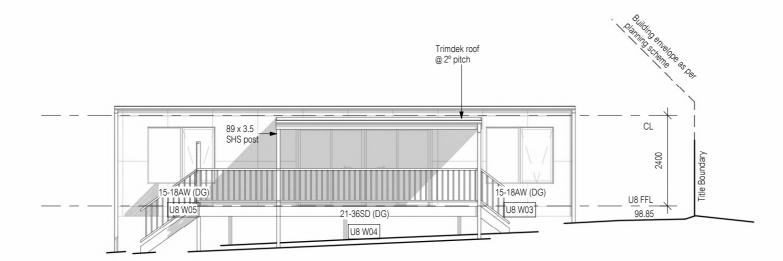
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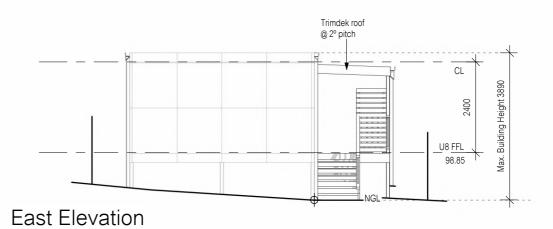
Material Colour


Trimdek Roof tbc

All lightweight cladding to be installed to manufacturer's guidelines. Refer to manufacturer's documentation.




North Elevation



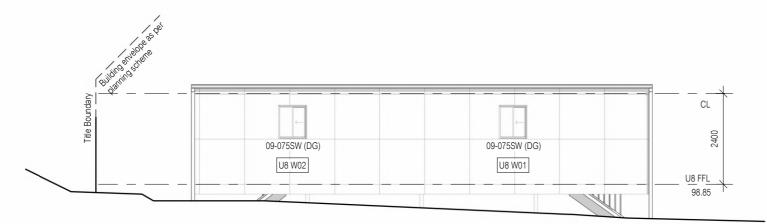

South Elevation

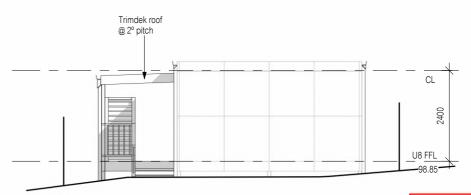

West Elevation

The use and development must be undertaken and completed in accordance with the approved plans, except for changes required to comply with planning permit conditions. The use and development must not be otherwise changed without the approval of Council.

GLENORCHY CITY COUNCIL PLANNING SERVICES

APPLICATION No.: PLN-24-270

DATE RECEIVED: 6/11/2024

| | | All window sizes to be checked and/or confirmed on site prior to ordering glazing units |
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| ST | | LEGEND: AJ - Articulation Joint BV - Brick Vent |
| Int. | Amendment changes as per cover sheet | Shadows shown for stylisation purposes only |

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| • | Builder to verify all dimensions and |
| | levels on site prior to commencement of work |


- All work to be carried out in accordance with the current National Construction Code.
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| | Designer: | Client / Project info |
|---|---|---|
| , | ANOTHER PERSPECTIVE PTY LTD PO BOX 21 NEW TOWN LIC. NO. 685230609 (S. Turvey) Ph: (03) 6231 4122 Fx: (03) 6231 4166 Email: info@anotherperspective.com.au | PROPOSED CUNIC UNIT DEVELOPMENT 168a Abbotsfield Road CLAREMONT |


CUNIC homes

Built for you

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| Date | 13 June 2024 | Sheet |
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| | Copyright © | 17720 |



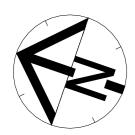

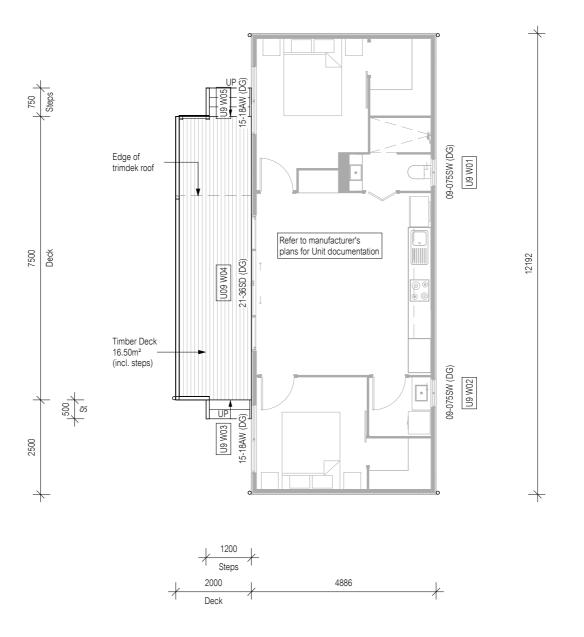

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GLENORCHY CITY COUNCIL PLANNING SERVICES

APPLICATION No.: PLN-24-270

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(6/11/2024



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| Designer: | Client / Project info |
|--|--|
| ANOTHER PERSPECTIVE PTY LTD PO BOX 21 NEW TOWN | PROPOSED CUNIC UNIT DEVELOPMENT 168a Abbotsfield Road |
| LIC. NO. 685230609 (S. Turvey) Ph: (03) 6231 4122 Fx: (03) 6231 4166 Fmail: | CLAREMONT |
| info@anotherperspective.com.au | |




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| | Copyright © | 10/20 |

Date Version: 2, Version Date: 25/05/2025


Material Colour

Trimdek Roof tbc


All lightweight cladding to be installed to manufacturer's guidelines. Refer to manufacturer's documentation.

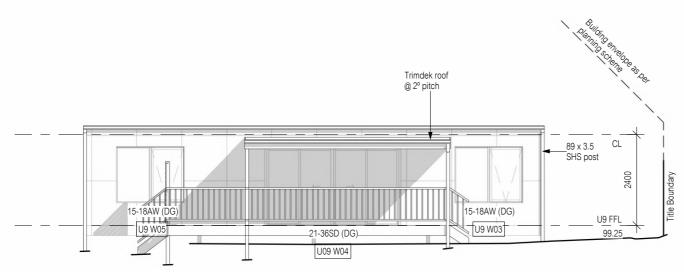



North Elevation

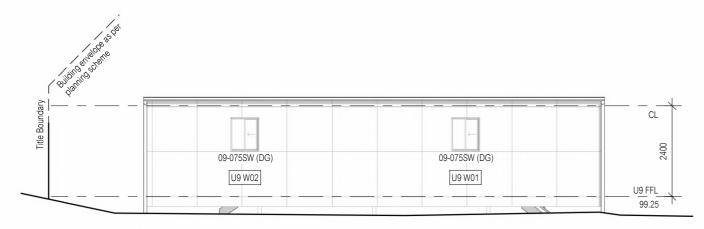

South Elevation

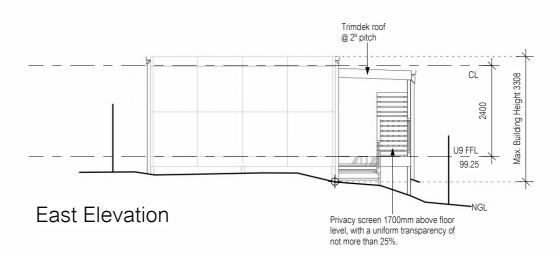

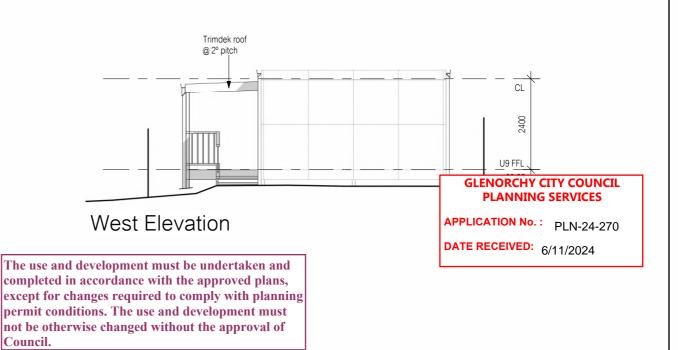

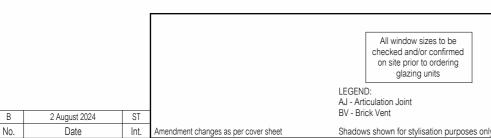

| | Notes |
|---|--|
| • | Builder to verify all dimensions and |
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Designer:

ANOTHER PERSPECTIVE PTY LTD
PO BOX 21
NEW TOWN
LIC. NO. 685230609 (S. Turvey)
Ph: (03) 6231 4122
Fx: (03) 6231 4166
Email:

Client / Project info


PROPOSED CUNIC UNIT DEVELOPMENT
168a Abbotsfield Road
CLAREMONT

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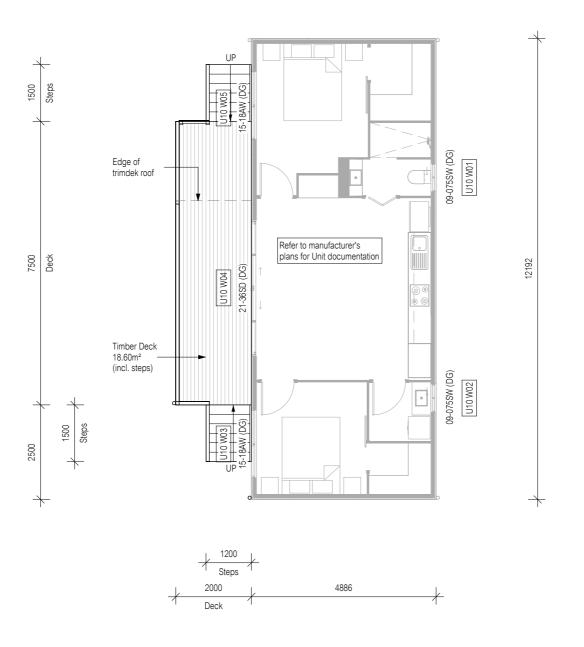
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| UNIT 9 ELEVATIONS | | | |
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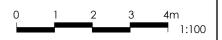


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GLENORCHY CITY COUNCIL PLANNING SERVICES

APPLICATION No.: PLN-24-270

DATE RECEIVED: 0 6/11/2024

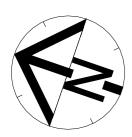

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Client / Project info Designer:

CLAREMONT

ANOTHER PERSPECTIVE PTY LTD PO BOX 21

NEW TOWN LIC. NO. 685230609 (S. Turvey) Ph: (03) 6231 4122 Fx: (03) 6231 4166

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PROPOSED CUNIC UNIT DEVELOPMENT 168a Abbotsfield Road

| CUNIC homes |
|---------------|
| Built for you |

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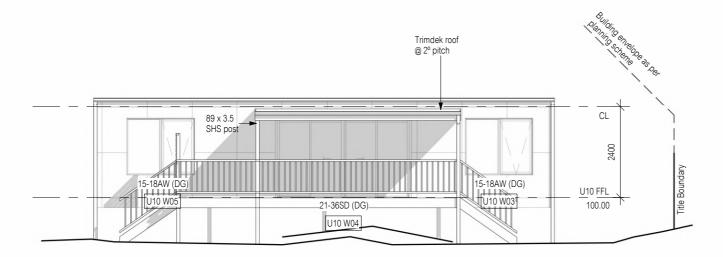
Copyright ©


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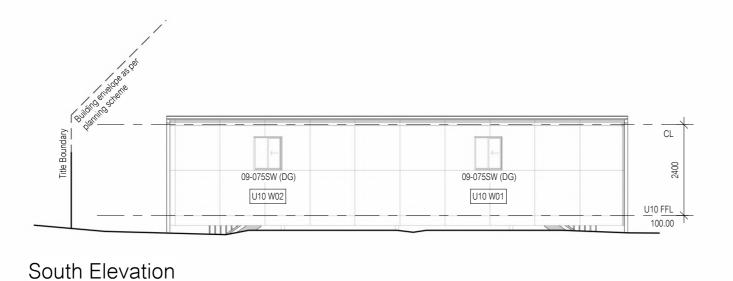
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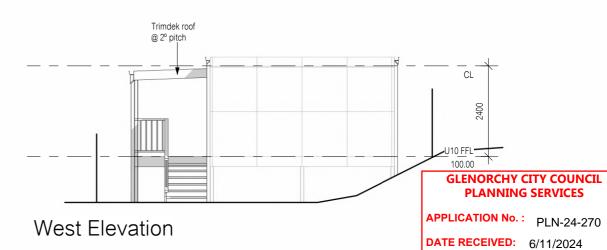
Trimdek Roof tbc

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| st 2024 ST | BV - Brick Vent |
| te Int. Amendment changes as per cover sheet | Shadows shown for stylisation purposes only |

North Elevation

| | | Notes |
|---|---|--------------------------------------|
| • | , | Builder to verify all dimensions and |
| | | 1 1 9 2 1 |


- levels on site prior to commencement of work All work to be carried out in accordance with the current National Construction Code.
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| Designer: | Client / Project info |
|--|---|
| ANOTHER PERSPECTIVE PTY LTD PO BOX 21 NEW TOWN LIC. NO. 685230609 (S. Turvey) Ph: (03) 6231 4122 Fx: (03) 6231 4166 | PROPOSED CUNIC UNIT DEVELOPMENT 168a Abbotsfield Road CLAREMONT |

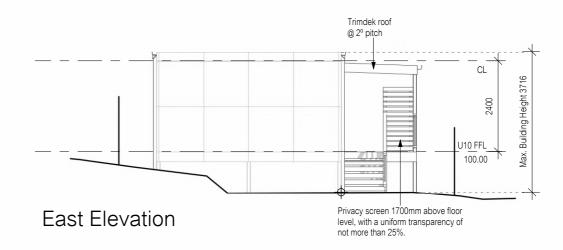
info@anotherperspective.com.au

| | UNIT | 10 ELE\ | /ATIONS |
|---|------|---------|---------|
| n | | ST | U249 |

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|-------|--------------|---|
| Date | 13 June 2024 | 0 |
| Scale | 1:100 | |
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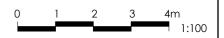


The use and development must be undertaken and completed in accordance with the approved plans, except for changes required to comply with planning permit conditions. The use and development must not be otherwise changed without the approval of Council.
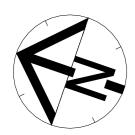
> **GLENORCHY CITY COUNCIL PLANNING SERVICES**

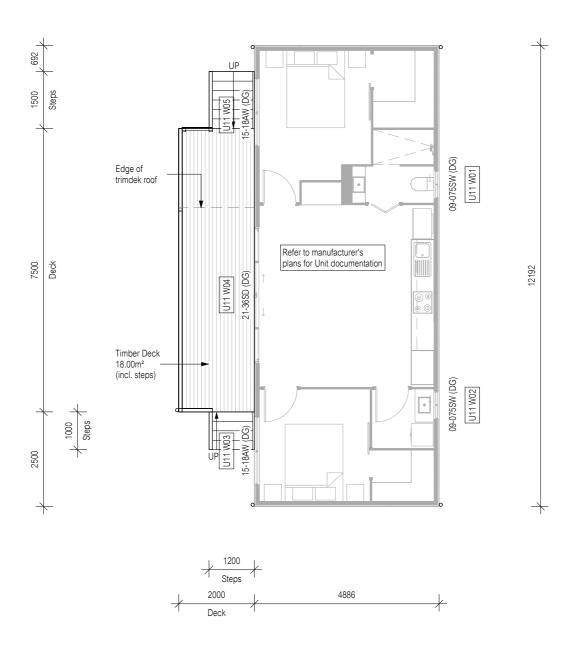APPLICATION No.: PLN-24-270

DATE RECEIVED: 6/11/2024



Floor Area = Refer to Manufacturer's Documentation

Int. Amendment changes as per cover sheet

Smoke Alarm (interconnected where more than 1)

All window sizes to be checked and/or confirmed

on site prior to ordering

glazing units

- Builder to verify all dimensions and levels on site prior to commencement of work
- All work to be carried out in accordance with the current National Construction Code.
- All materials to be installed according to manufacturers specifications.
- Do not scale from these drawings. No changes permitted without consultation with designer.

| l | Designer: | Client / Project info | | | | | |
|---|--|---|--|--|--|--|--|
| | ANOTHER PERSPECTIVE PTY LTD PO BOX 21 NEW TOWN LIC. NO. 685230609 (S. Turvey) Ph: (03) 6231 4122 Fx: (03) 6231 4166 | PROPOSED CUNIC UNIT DEVELOPMENT 168a Abbotsfield Road CLAREMONT | | | | | |

info@anotherperspective.com.au



| | UNIT 11 FLOOR PLAN | | | | | |
|----|--------------------|----|------|--|--|--|
| wn | | ST | U249 | | | |
| | | | Cl + | | | |

Draw Date 13 June 2024 Sheet Scale 1:100 Copyright @

Date Version: 2, Version Date: 25/05/2025

2 August 2024

Material | Colour Trimdek Roof tbc

All lightweight cladding to be installed to manufacturer's guidelines. Refer to manufacturer's documentation

CL


U11 FFL

101.10


Trimdek roof

Privacy screen 1700mm above floor level, with a uniform transparency of

not more than 25%.

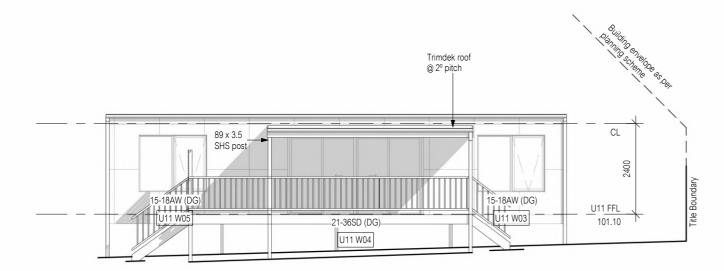

North Elevation

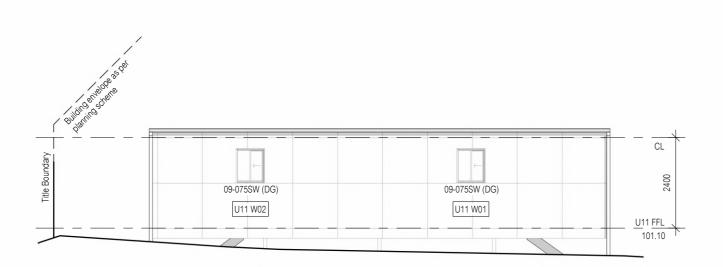

South Elevation

The use and development must be undertaken and completed in accordance with the approved plans, permit conditions. The use and development must not be otherwise changed without the approval of

except for changes required to comply with planning Council.

All window sizes to be checked and/or confirmed on site prior to ordering glazing units LEGEND: AJ - Articulation Joint BV - Brick Vent Amendment changes as per cover sheet Shadows shown for stylisation purposes only

Builder to verify all dimensions and levels on site prior to commencement of work

- All work to be carried out in accordance with the current National Construction Code.
- All materials to be installed according to manufacturers specifications.
- · Do not scale from these drawings. No changes permitted without consultation with designer.
- info@anotherperspective.com.au

Client / Project info Designer: ANOTHER PERSPECTIVE PTY LTD PROPOSED CUNIC UNIT DEVELOPMENT PO BOX 21 NEW TOWN LIC. NO. 685230609 (S. Turvey) Ph: (03) 6231 4122 Fx: (03) 6231 4166 168a Abbotsfield Road CLAREMONT

East Elevation

West Elevation

Trimdek roof @ 2º pitch

| | UNIT 11 ELEVATIONS | | | | | | | |
|-------|--------------------|-------|--|--|--|--|--|--|
| Drawn | ST | U249 | | | | | | |
| Date | 13 June 2024 | Sheet | | | | | | |
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GLENORCHY CITY COUNCIL

PLANNING SERVICES

PLN-24-270

6/11/2024

APPLICATION No.:


DATE RECEIVED:

Version: 2, Version Date: 26/06/2025

2 August 2024





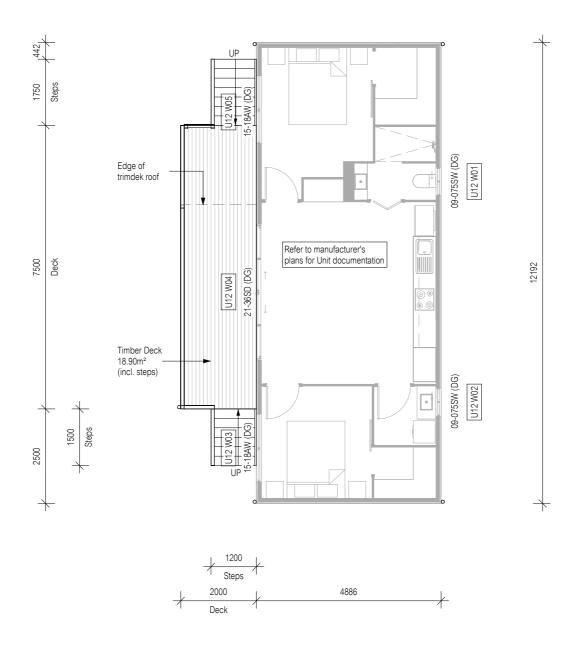

The use and development must be undertaken and completed in accordance with the approved plans, except for changes required to comply with planning permit conditions. The use and development must not be otherwise changed without the approval of Council.

> **GLENORCHY CITY COUNCIL PLANNING SERVICES**

APPLICATION No.: PLN-24-270 DATE RECEIVED: 6/11/2024



Floor Area = Refer to Manufacturer's Documentation

Int. Amendment changes as per cover sheet

Smoke Alarm (interconnected where more than 1)

· Builder to verify all dimensions and levels on site prior to commencement of work

All window sizes to be

checked and/or confirmed

on site prior to ordering

glazing units

 All work to be carried out in accordance with the current National Construction Code.

All materials to be installed according to manufacturers specifications.

 Do not scale from these drawings. No changes permitted without consultation with designer.

ANOTHER PERSPECTIVE PTY LTD PO BOX 21 NEW TOWN LIC. NO. 685230609 (S. Turvey) Ph: (03) 6231 4122 Fx: (03) 6231 4166

info@anotherperspective.com.au

Designer:

Client / Project info PROPOSED CUNIC UNIT DEVELOPMENT 168a Abbotsfield Road CLAREMONT



| | UNIT 12 FLOOR PLAN | | | | | | | |
|----|--------------------|-------|--|--|--|--|--|--|
| wn | ST | U249 | | | | | | |
| e | 13 June 2024 | Sheet | | | | | | |

Drav Date Scale 1:100 Copyright @

No. Date Version: 3, Version Date: 36/06/2025

2 August 2024


Material Colour

Trimdek Roof tbc


All lightweight cladding to be installed to manufacturer's guidelines. Refer to manufacturer's documentation.


U12 FFL 102.10

Trimdek roof @ 2º pitch

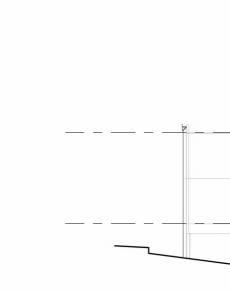


East Elevation

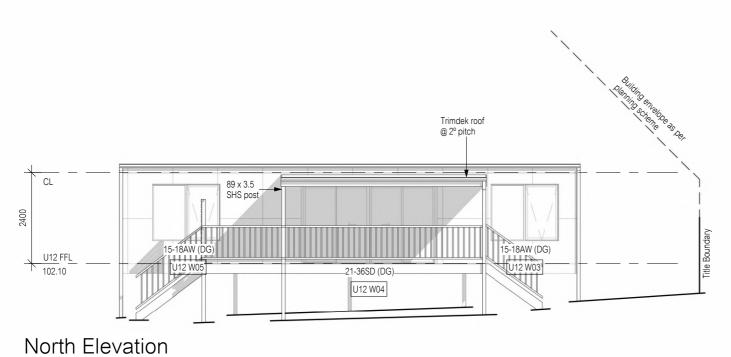

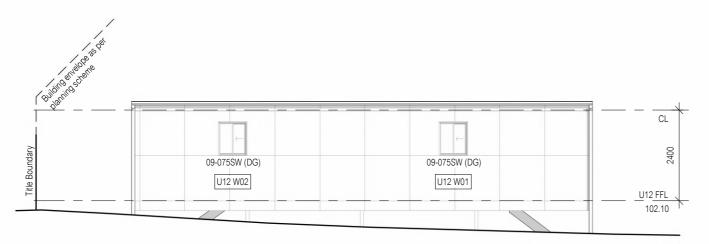

South Elevation

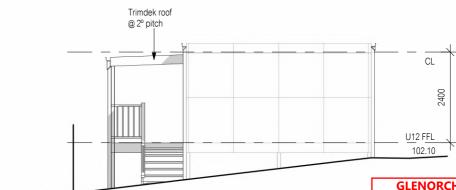

West Elevation

The use and development must be undertaken and completed in accordance with the approved plans, except for changes required to comply with planning permit conditions. The use and development must not be otherwise changed without the approval of Council.

GLENORCHY CITY COUNCIL PLANNING SERVICES

APPLICATION No.: PLN-24-270

DATE RECEIVED: 6/11/2024

| | | | | | _ |
|---------------|------|--------------------------------------|--------------------|---|---|
| | | | | All window sizes to be checked and/or confirmed on site prior to ordering glazing units | |
| | | | LEGENI AJ - Art | D: iculation Joint | |
| 2 August 2024 | ST | 1 | BV - Bri | ck Vent | |
| Date | Int. | Amendment changes as per cover sheet | Shadow | s shown for stylisation purposes onl | у |

| | Notes |
|---|--|
| • | Builder to verify all dimensions and |
| | levels on site prior to commencement of work |

 All work to be carried out in accordance with the current National Construction Code.

 All materials to be installed according to manufacturers specifications.

Do not scale from these drawings.
 No changes permitted without consultation with designer.

| Designer: | Client / Project info | | | | | |
|--|---|--|--|--|--|--|
| ANOTHER PERSPECTIVE PTY LTD PO BOX 21 NEW TOWN LIC. NO. 685230609 (S. Turvey) Ph: (03) 6231 4122 Fx: (03) 6231 4166 Email: | PROPOSED CUNIC UNIT DEVELOPMENT 168a Abbotsfield Road CLAREMONT | | | | | |
| info@anotherperspective.com.au | | | | | | |



| UNIT 12 ELEVATIONS | | | | | | | |
|--------------------|--------------|-------|--|--|--|--|--|
| Drawn | ST | U249 | | | | | |
| Date | 13 June 2024 | Sheet | | | | | |
| Scale | 1:100 | 75/75 | | | | | |
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CLIENT / ARCHITECT:

CUNIC HOMES

PROJECT DETAILS:

UNITS DEVELOPMENT 168A ABBOTSFIELD ROAD, CLAREMONT

PROJECT No:

241043

DISCIPLINE:

CIVIL

DRAWINGS:

COV - COVER SHEET C001 - CIVIL NOTES

C100 - OVERALL SITE PLAN

C101 - EXISTING SITE / DEMOLITION PLAN - PLAN A C102 - EXISTING SITE / DEMOLITION PLAN - PLAN B

C201 - EROSION CONTROL PLAN - PLAN A

C401 - INFRASTRUCTURE PLAN - PLAN A

C402 - INFRASTRUCTURE PLAN - PLAN B

C411 - SEWER LONGITUDINAL SECTION

C501 - CIVIL WORKS PLAN - PLAN A C502 - CIVIL WORKS PLAN - PLAN B

C511 - CIVIL LEVELS PLAN - PLAN A

C512 - CIVIL LEVELS PLAN - PLAN B

C521 - LONGITUDINAL & CROSS SECTIONS - SHEET 1

C522 - LONGITUDINAL & CROSS SECTIONS - SHEET 2

C523 - LONGITUDINAL & CROSS SECTIONS - SHEET 3

C524 - LONGITUDINAL & CROSS SECTIONS - SHEET 4

C701 - VEHICLE TURNING MOVEMENTS PLAN - SHEET 1

C801 - SECTIONS & DETAILS - SHEET 1

C802 - SECTIONS & DETAILS - SHEET 2

C803 - SECTIONS & DETAILS - SHEET 3

C804 - SECTIONS & DETAILS - SHEET 4

The use and development must be undertaken and completed in accordance with the approved plans, except for changes required to comply with planning permit conditions. The use and development must not be otherwise changed without the approval of

> **GLENORCHY CITY COUNCIL** PLANNING SERVICES

APPLICATION No.: PLN-24-270

DATE RECEIVED: 12/06/2025

| F | REVISED DEVELOPMENT APPLICATION | SCP | 29-05 |
|------|---------------------------------|-----|--------|
| Ε | REVISED DEVELOPMENT APPLICATION | OWM | 18-02- |
| D | REVIEW / INFORMATION | OWM | 07-02 |
| С | REVISED DEVELOPMENT APPLICATION | OWM | 07-11 |
| В | DEVELOPMENT APPLICATION | OWM | 27-09 |
| Α | REVIEW / INFORMATION | OWM | 26-09 |
| REV: | ISSUED FOR / DESCRIPTION: | BY: | DATE |

COLLECTIVE CONSULTING DISCLAIMER:

PROJECT DOCUMENTS.

THIS DRAWING HAS BEEN PRODUCED FOR THE NAMED CLIENT AND FOR USE OF THIS PROJECT ONLY, AND IS NOT TO BE USED FOR ANY OTHER PURPOSE. THESE DRAWINGS MUST BE APPROVED BY COUNCIL, TASWATER AND ANY OTHER REQUIRED AUTHORITIES PRIOR TO COMMENCING CONSTRUCTION. 3. THE RECIPIENT IS RESPONSIBLE FOR ENSURING THAT THEY REVIEW THE STATUS OF THIS DRAWING, AND IN RECEIPT OF THE CURRENT REVISION

4. INFORMATION PROVIDED WITHIN THIS DOCUMENT HAS BEEN PROVIDED UNDER COLLECTIVE CONSULTING'S TERMS OF ENGAGEMENT. BY ACCEPTING OR USING THE INFORMATION WITHIN THIS DOCUMENT YOU HAVE ACCEPTED THE TERMS OF ENGAGEMENT. TERMS CAN BE VIEWED AT 5. DO NOT SCALE DRAWINGS. COLLECTIVE CONSULTING IS NOT RESPONSIBLE FOR THE DIMENSIONING AND SETTING OUT OF COMPONENTS WITHIN THESE

COLLECTIVE

P (03) 6334 0834

| CLIENT / ARCHITECT: |
|---------------------|
| CUNIC HOMES |
| ale |
| 200 |
| CUNIC |
| Built for you |

DRAWING TITLE: PROJECT DETAILS: 168a ABBOTSFIELD ROAD, CLAREMONT **COVER SHEET** UNITS DEVELOPMENT PROJECT No: DRAWING No: REVISION: DESIGN CHECK: DRAWN BY: DRAFT CHECK: CERTIFIER: DESIGN BY: 241043 COV JTA JTA

GENERAL NOTES

- A. THESE DRAWINGS AND NOTES SHALL BE READ IN CONJUNCTION WITH ARCHITECTURAL, LANDSCAPE ARCHITECTS, STRUCTURAL, BUILDING SERVICES AND OTHER DISCIPLINES' DRAWINGS AND SPECIFICATIONS AND WITH ANY WRITTEN ENGINEER'S INSTRUCTIONS ISSUED DURING THE CONTRACT.
- B. THE CONTRACTOR SHALL ENSURE THAT ALL CIVIL WORKS, MATERIALS, INFRASTRUCTURE AND WORKMANSHIP COMPLY WITH PLANNING AND BUILDING PERMITS, THE NATIONAL CONSTRUCTION CODE OF AUSTRALIA (NCC), AUSTRALIAN STANDARDS (AS), DEPARTMENT OF STATE GROWTH (DSG), INSTITUTE OF PUBLIC WORKS ENGINEERING AUSTRALIA (IPWEA) - TAS DIVISION, LOCAL GOVERNMENT ASSOCIATION TASMANIA (LGAT), WATER SERVICES ASSOCIATION OF AUSTRALIA (WSAA) AND ANY OTHER STATE / TERRITORY / LOCAL GOVERNMENT REGULATIONS.
- C. ALL AUSTRALIAN STANDARDS REFERENCED IN THESE DRAWINGS ARE TO BE NOTED AS THE CURRENT VERSIONS D. ANY DISCREPANCIES ARE TO BE REPORTED TO THE SUPERINTENDENT BEFORE PROCEEDING WITH THE WORK.
- E. THESE GENERAL NOTES DO NOT HAVE PRECEDENCE OVER THE SPECIFICATION OR DRAWING NOTES. F. ALL SET OUT DIMENSIONS ON THE DRAWINGS ARE TO BE VERIFIED BY THE
- CONTRACTOR ON SITE BEFORE COMMENCING WORK. G. DO NOT SCALE FOR DIMENSIONS OFF THESE DRAWINGS H. UNLESS NOTED OTHERWISE, ALL DIMENSIONS SHOWN ARE IN MILLIMETRES WITH THE EXCEPTION OF SURVEY LEVELS. WHICH ARE IN METRES.
- I. THE CONTRACTOR IS TO ENSURE THAT ANY PROFESSIONALS, TRADESMEN OR SUPPLIERS ENGAGED THROUGHOUT THE DURATION OF THE CONTRACT ARE ACCREDITED AND QUALIFIED FOR THEIR DUTY OF WORK AND CARRY ALL NECESSARY
- PERMITS REQUIRED BY ANY STATUTORY AUTHORITY. J. INSTALL ANY AND ALL PROPRIETARY ITEMS IN ACCORDANCE WITH SPECIFIC MANUFACTURERS REQUIREMENTS, SPECIFICATIONS AND RECOMMENDATIONS. 2 // NOTICE TO CONTRACTOR / TENDERER
- A. THE CONTRACTOR / TENDERER IS TO MAKE THEMSELVES AWARE OF THE LOCAL COLINCII AND THE DEPARTMENT OF STATE GROWTH (DSG) STANDARDS FOR CIVIL WORKS, TENDERER IS TO ALLOW FOR THESE STANDARDS DURING PRICING.
- B. CONSTRUCTION IS TO BE CARRIED OUT IN ACCORDANCE WITH THESE STANDARDS THROUGHOUT THE DURATION OF THE CONTRACT C. COPIES OF THESE STANDARDS ARE AVAILABLE UPON REQUEST FROM THE LOCAL COUNCIL AND DSG'S WEBSITE.
- A. CONFIRM / DETERMINE FINISHED FLOOR LEVELS ON SITE TO ACHIEVE DESIGN INTENT. REFER ARCHITECT FOR ANY DISCREPANCIES, ISSUES OR CHANGES TO FLOOR LEVELS. GENERALLY, SURFACES ARE TO BE SLOPED AWAY FROM BUILDINGS.
- 4 // SCOPE OF WORKS A. THE SCOPE OF WORKS ARE SHOWN IN THESE DOCUMENTS AND THE SPECIFICATION. B. THE CONTRACTOR IS EXPECTED TO RESOLVE ALL ISSUES UNCOVERED ON SITE THAT
- ARE NOT DETAILED IN THESE DOCUMENTS, IN CONJUNCTION WITH THE SUPERINTENDENT / PRINCIPAL. 5 // DISPOSAL OF EXCAVATED MATERIAL A. DISPOSE OF EXCAVATED MATERIAL TO A LICENSED WASTE FACILITY OR APPROVED
- 6 // APPROVALS
- ALL WORKS ARE TO BE CARRIED OUT IN ACCORDANCE WITH THE FOLLOWING APPROVALS;

----- eCOM ----- EXISTING COMMUNICATIONS LINE - CONFIRM EXACT LOCATION eFM — EXISTING FIRE WATER LINE / MAIN - CONFIRM EXACT LOCATION

PROPOSED FIRE WATER LINE / MAIN ----- eGAS ----- EXISTING GAS LINE / MAIN - CONFIRM EXACT LOCATION —— GAS —— NEW GAS LINE / MAIN

----- ePWR ----- EXISTING POWER LINE - CONFIRM EXACT LOCATION PROPOSED POWER LINE EXISTING SEWER SERVICE LINE / MAIN - CONFIRM EXACT LOCATION

PROPOSED SEWER SERVICE LINE / MAIN es-rm existing sewer rising main - confirm exact location EXISTING STORMWATER LINE / MAIN - CONFIRM EXACT LOCATION PROPOSED STORMWATER LINE / MAIN

----- eSW-RM ----- EXISTING STORMWATER RISING MAIN - CONFIRM EXACT LOCATION ----- SW-RM ----- PROPOSED STORMWATER RISING MAIN ----- eag ----- Existing agricultural drain (ag drain) AG PROPOSED SLOTTED AGRICULTURAL DRAIN (AG DRAIN)

EXISTING SURFACE / STRUCTURE TO BE DEMOLISHED

eW — EXISTING WATER SERVICE LINE / MAIN - CONFIRM EXACT LOCATION PROPOSED WATER SERVICE LINE / MAIN — · - · - · - · EXISTING SERVICE LINE / MAIN TO BE DEMOLISHED

--- DRAINAGE EASEMENT / RIGHT OF WAY ----- EROSION CONTROL BARRIER

TITLE BOUNDARY

EXISTING INFRASTRUCTURE

1 // LOCATION OF EXISTING INFRASTRUCTURE A. LOCATE ALL EXISTING UNDERGROUND INFRASTRUCTURE PRIOR TO COMMENCING ANY SITE AND DEMOLITION WORKS WITH THE FOLLOWING METHODS: A.1. THE CONTRACTOR IS TO NOTIFY ALL RELEVANT STATUTORY AUTHORITIES PRIOR TO COMMENCING ANY WORK FOR THE POSSIBLE LOCATION OF ANY EXISTING

INFRASTRUCTURE NOT SHOWN ON THESE PLANS, AND IS TO NOTIFY THE SUPERINTENDENT OF THE SAME. A.2. THE CONTRACTOR IS TO COMPLETE A 'BEFORE YOU DIG'. A.3. THE CONTRACTOR IS TO REVIEW ALL SURVEY AND UNDERGROUND ASSET DATA.

A.4. THE CONTRACTOR IS TO ARRANGE AND PAY FOR THE ON SITE MARKING AND CONFIRMATION OF DEPTH OF SERVICES LOCATIONS FOR ALL UNDERGROUND INFRASTRUCTURE INCLUDING BUT NOT LIMITED TO; COMMUNICATIONS, TASNETWORKS, TASGAS, TASWATER AND COUNCIL INFRASTRUCTURE (IE SEWER, STORMWATER, WATER ETC.) IN THE AREA OF NEW WORKS. CONFIRM LOCATIONS UNDERGROUND CCTV CAMERA INSPECTIONS.

USING CABLE LOCATORS, POT HOLING, SUCTION TRUCK, HAND DIGGING AND A.5. THE CONTRACTOR IS TO WALK SITE AND IDENTIFY ANY ASSETS THAT MAY HAVE BEEN MISSED AND REPORT TO SUPERINTENDENT

2 // GENERAL A. ANY CLASHES WITH DESIGNED INFRASTRUCTURE ON THE FOLLOWING DESIGN DRAWINGS ARE TO BE REPORTED TO DESIGN ENGINEER FOR DIRECTION

B. ALL EXISTING INFRASTRUCURE IS TO BE PROTECTED DURING CONSTRUCTION. ANY DAMAGE TO EXISTING INFRASTRUCTURE IS TO BE MADE GOOD AT THE CONTRACTOR'S C. TRENCHES WHERE SERVICES ARE REMOVED ARE TO BE FILLED WITH AN APPROVED COMPACTED MATERIAL AND TO ENGINEERS COMPACTION SPECIFICATIONS. MATCH

AND MAKE GOOD SURFACES TO MATCH EXISTING SURROUNDINGS.

SAFETY IN DESIGN

1 // GENERAL A. THE 'SAFETY IN DESIGN' RISK MITIGATION MEASURES FOR THIS PROJECT DO NOT ACCOUNT FOR ALL DESIGN, CONSTRUCTION, OPERATION, MAINTENANCE AND

B. THEY DO NOT REDUCE OR LIMIT THE OBLIGATIONS OF THE CONTRACTOR, CONSTRUCTOR, USER, OPERATOR, MAINTAINER OR DEMOLISHER TO PERFORM THEIR OWN SAFETY IN DESIGN RISK ASSESSMENTS.

C. CONSTRUCTION AND INSTALLATION SAFE WORK METHOD STATEMENTS ARE TO BE REVIEWED BY A QUALIFIED PERSON TO ELIMINATE AND MINIMISE INSTALLATION RISKS.

DEMOLITION WORKS

A. DEMOLITION WORKS ARE TO BE READ IN CONJUNCTION WITH ARCHITECTS AND OTHER CONSULTANTS DEMOLITION PLANS. CONTRACTOR TO NOTIFY ARCHITECT AND CONFIRM ANY ISSUES / CONTRADICTIONS WITH ARCHITECT.

B. CONTRACTOR TO MAKE ALL NECESSARY ALLOWANCES FOR REQUIRED DEMOLITIONS REMOVALS AND RELOCATIONS TO SUIT NEW WORKS. C. ALL EXISTING INFRASTRUCTURE IS TO BE PROTECTED DURING CONSTRUCTION. ANY DAMAGE TO EXISTING INFRASTRUCTURE IS TO BE MADE GOOD AT THE CONTRACTOR'S

D. CAP, TERMINATE AND REMOVE REDUNDANT DISUSED DRAINAGE SERVICES TO SATISFACTION OF ENGINEER, LOCAL AUTHORITIES AND IN ACCORDANCE WITH AS3500 E. TRENCHES WHERE SERVICES ARE REMOVED ARE TO BE FILLED WITH AN APPROVED

COMPACTED MATERIAL AND TO ENGINEERS COMPACTION SPECIFICATIONS. MATCH AND MAKE GOOD SURFACES TO MATCH EXISTING SURROUNDINGS. F CONTRACTOR TO ALLOW TO MAKE GOOD ALL SUBFACES AFFECTED BY DEMOLITION WORKS TO SUPERINTENDENT / PRINCIPAL / LOCAL COUNCIL'S SATISFACTION.

EXISTING SURVEY

1 // EXISTING SURVEY DETAILS

| A. THE FOLLOWING ARE THE SURVEY DETAILS USED AS A BASIS FOR THE DESIGN: | | | | | | | | |
|---|--------------------------|----------------------------------|--|--|--|--|--|--|
| | SURVEYOR: | ROGERSON & BIRCH SURVEYORS | | | | | | |
| | SURVEY REFERENCE NUMBER: | 61276/27 | | | | | | |
| | SURVEY DATE: | 19/12/2023 | | | | | | |
| | SITE LOCATION: | 168A ABBOTSFIELD ROAD, CLAREMONT | | | | | | |
| | COORDINATION SYSTEM: | MGA2020 | | | | | | |
| | LEVEL DATUM: | AHD83 | | | | | | |
| | SERVICE MARKER: | SPM9546 | | | | | | |
| | | | | | | | | |

- 1 // GENERAL A. SETOUT IS THE RESPONSIBILITY OF THE CONTRACTOR AND SURVEYOR.
- B. THE CONTRACTOR IS TO ARRANGE AND PAY FOR A REGISTERED SURVEYOR TO SETOUT THE BUILDING/S, CIVIL WORKS AND ANY OTHER COMPONENT. . COLLECTIVE CONSULTING TAKE NO RESPONSIBILITY FOR THE SETOUT OF BUILDING/S, CIVIL WORKS AND ANY OTHER COMPONENT.
- D. REFER ARCH, FOR SETOUT OF ALL BUILDING/S AND RELATED COMPONENTS E. ALL SETOUT DIMENSIONS ON THESE DRAWINGS ARE TO BE VERIFIED BY THE
- F. DO NOT SCALE FOR DIMENSIONS OFF THESE DRAWINGS G. UNLESS NOTED OTHERWISE, ALL DIMENSIONS SHOWN ARE IN MILLIMETRES WITH THE

CONTRACTOR ON SITE BEFORE COMMENCING WORK.

EXCEPTION OF SURVEY LEVELS, WHICH ARE IN METRES.

1 // GENERAL

A. THE CONTRACTOR SHALL ENSURE THAT ALL CIVIL WORKS, MATERIALS AND A. GENERAL EARTHWORKS, MATERIAL AND WORKMANSHIP SHALL COMPLY WITH THE SPECIFICATION. THE CURRENT EDITION OF THE SAA CODE FOR EARTHWORKS. AS3798. THE NCC. SAFE WORK AUSTRALIA CODE OF PRACTICE FOR EXCAVATION WORK. TOGETHER WITH ANY CODES, STANDARDS OR REGULATIONS REFEREED TO THEREIN. B. THE CONTRACTOR SHALL KEEP A COPY OF THE CURRENT VERSION OF AS3798 AND

(LGAT) AND ANY OTHER STATE / TERRITORY / LOCAL GOVERNMENT REGULATIONS B. ANY DEPARTURE FROM THESE STANDARDS AND REGULATIONS REQUIRES THE PRIOR

POINTS, AS A MINIMUM, BEFORE COMMENCEMENT OF FURTHER WORKS:

WRITTEN APPROVAL FROM THE SUPERINTENDENT AND THE WORKS SUPERVISOR / 2 // INSPECTIONS A. THE CONTRACTOR IS TO BE RESPONSIBLE FOR ORGANISING INSPECTIONS WITH THE

B. THE FOLLOWING SITE INSPECTIONS ARE REQUIRED DURING CONSTRUCTION / HOLD

C. THE CONTRACTOR IS TO MAKE THEMSELVES AWARE OF ANY ADDITIONAL INSPECTIONS

D. COLLECTIVE CONSULTING REQUIRE MIN. 48 HOURS NOTICE PRIOR TO ALL REQUIRED

A. THE CONTRACTOR IS TO BE RESPONSIBLE FOR ENGAGING AND PAYING ALL COSTS FOR

AN APPROVED CONSTRUCTION MATERIALS TESTING COMPANY TO CARRY OUT TESTING

IN ACCORDANCE WITH DSG SPEC. SECTION 173 - EXAMINATION AND TESTING OF

A. ALL HOTMIX ASPHALT IS TO BE BLACK IN COLOUR (U.N.O.) AND IS TO BE PLACED IN

A. ALL KERBS AND CHANNELS AND ACCESS RAMPS SHOWN ON THE DRAWINGS ARE TO BE

A. CONSTRUCT FOOTPATHS (INCLUDING EXPANSION JOINTS, CONTROL JOINTS,

WEAKENED PLANE JOINTS, ETC.) IN ACCORDANCE WITH LGAT STANDARD DRAWING

A. ALL WORKS IN (OR REQUIRING OCCUPATION) IN THE ROAD RESERVE MUST BE

A. LINE MARKING AND SIGNAGE SHOWN ON THE DESIGN PLANS ARE FOR INFORMATION

B. CONTRACTOR TO INSTALL ALL SIGNAGE AND LINE MARKING AS PER THE

D. ACCESS CAR PARKING SPACE/S, SIGNAGE. SHARED AREA, BOLLARD AND LINE MARKING

. ALL SIGN WORKS AND INSTALLATION TO BE IN ACCORDANCE WITH CURRENT VERSION

OF 'MANUAL OF UNIFORM TRAFFIC CONTROL DEVICES' (MUTCD) & AUSTROADS FOR

C. CAR PARKING SPACE/S AND LINE MARKING TO BE IN ACCORDANCE WITH AS2890.

ALL LINE MARKING TO BE WITH DULUX ROADMASTER (OR EQUIVALENT) U.N.O.

UNDERTAKEN BY CONTRACTOR REGISTERED WITH COUNCIL'S REGISTERED

IN ACCORDANCE WITH LGAT STANDARD DRAWINGS TSD-R14-v3 TO TSD-R18-v3.

A. LANDSCAPE AND STREET FURNITURE DESIGN AND DETAILING BY OTHERS.

ACCORDANCE WITH AND MEET THE REQUIREMENTS OF DSG SPEC. SECTION 407 -

REQUIRED BY THE LOCAL COUNCIL TO ACHIEVE PRACTICAL COMPLETION AND NOTIFY

BACKFILLING OF SERVICE TRENCHES LEVEL 1 TESTING LEVEL 1 TESTING LEVEL 1 TESTING CERTIFICATION OF THESE ELEMENTS ARE TO BE PROVIDED PRIOR TO PRACTICAL

3 // AREAS OF CUT A. STRIP EXISTING TOP SOIL, VEGETATION, HARD SURFACES AND OTHER MATERIAL TO SUBGRADE LEVEL

B. PROOF ROLL SUBGRADE IN ACCORDANCE WITH AS1289 TO: - 98% STANDARD DRY DENSITY UNDER BUILDINGS 98% STANDARD DRY DENSITY UNDER ROADS AND CARPARKS REMOVE ANY SOFT SPOTS AND COMPACT WITH 2% OF OPTIMUM MOISTURE

ANY OTHER REQUIRED CODES, STANDARDS AND REGULATIONS ON SITE.

OF ALL EARTHWORKS INCLUDING, BUT NOT LIMITED TO:

A. THE CONTRACTOR IS TO BE RESPONSIBLE FOR ENGAGING AND PAYING ALL COSTS FOR

AN APPROVED CONSTRUCTION MATERIALS TESTING COMPANY TO CARRY OUT TESTING

CONTENT TO STANDARD DRY DENSITY AS STATED ABOVE 4 // AREAS OF FILL

A. STRIP EXISTING TOP SOIL, VEGETATION, HARD SURFACES AND OTHER MATERIAL TO SUBGRADE LEVEL. B. PROOF ROLL SUBGRADE IN ACCORDANCE WITH AS1289 TO: - 98% STANDARD DRY DENSITY UNDER BUILDINGS

98% STANDARD DRY DENSITY UNDER ROADS AND CARPARKS REMOVE ANY SOFT SPOTS AND COMPACT WITH 2% OF OPTIMUM MOISTURE CONTENT TO STANDARD DRY DENSITY AS STATED ABOVE C. PLACE FILL AS SPECIFIED AND COMPACT WITHIN 2% OF OPTIMUM MOISTURE CONTENT

5 // DISPOSAL OF EXCAVATED MATERIAL A. DISPOSE OF EXCAVATED MATERIAL TO A LICENSED WASTE FACILITY OR APPROVED LAND FILL SITE.

SOIL AND WATER MANAGEMENT

TO STANDARD DRY DENSITY AS STATED ABOVE.

EARTHWORKS

2 // TESTING & INSPECTIONS

1 // GENERAL

A. ALL WORKS ARE TO BE CARRIED OUT IN ACCORDANCE WITH 'SOIL & WATER MANAGEMENT ON BUILDING & CONSTRUCTION SITES' GUIDELINES AVAILABLE FROM NORTHERN RESOURCE MANAGEMENT (NRM) AND DETAILS SUPPLIED IN THESE DESIGN

B. COMPLY WITH ALL REQUIREMENTS TO LIMIT STORMWATER RUNOFF FROM THE SITE DURING CONSTRUCTION. C. IT IS STRONGLY RECOMMENDED THAT THE DEVELOPER RE-COVERS ANY DISTURBED AREAS WITH TOPSOIL AS QUICKLY AS POSSIBLE AFTER BULK EARTHWORKS ARE

COMPLETED, TO PREVENT SOIL DISPERSION. 2 // SOIL EROSION CONTROL A. CONTRACTOR TO ALLOW TO: A.1. LIMIT DISTURBANCE WHEN EXCAVATING BY PRESERVING VEGETATED AREAS AS

A.2. DIVERT UP-SLOPE WATER WHERE PRACTICAL A.3. INSTALL SEDIMENT FENCES DOWN SLOPE OF ALL DISTURBED LANDS TO FILTER LARGE PARTICLES PRIOR TO STORMWATER SYSTEM

A.4. WASH EQUIPMENT IN DESIGNATED AREA THAT DOES NOT DRAIN TO STORMWATER

SYSTEM OR NATURAL DRAINAGE LINES A.5. PLACE STOCK PILES AWAY FROM ON-SITE DRAINAGE & UP-SLOPE FROM SEDIMENT A.6. LEAVE AND MAINTAIN VEGETATED FOOTPATHS

A.7. STORE ALL HARD WASTE AND LITTER IN A DESIGNATED AREA THAT WILL PREVENT IT FROM BEING BLOWN AWAY AND WASHED INTO THE STORMWATER SYSTEMS A.8. RESTRICT VEHICLE MOVEMENT TO A STABILISED ACCESS 3 // NRM GUIDELINES

A. CONTRACTOR TO COMPLETE ALL WORKS IN ACCORDANCE WITH NRM SOIL & WATER MANAGEMENT ON BUILDING & CONSTRUCTION SITE USING THE FOLLOWING FACT SHEETS:

SOIL & WATER MANAGEMENT ON LARGE BUILDING & CONSTRUCTION SITES SOIL & WATER MANAGEMENT ON STANDARD BUILDING & CONSTRUCTION SITES FACT SHEET 3: SOIL & WATER MANAGEMENT PLANS FACT SHEET 4: DISPERSIVE SOILS - HIGH RISK OF TUNNEL EROSION

FACT SHEET 5: MINIMISE SOIL DISTURBANCE FACT SHEET 6: PRESERVE VEGETATION FACT SHEET 7: DIVERT UP-SLOPE WATER **FACT SHEET 8: EROSION CONTROL MATS & BLANKETS** FACT SHEET 9: PROTECT SERVICE TRENCHES & STOCKPILES

FACT SHEET 10: EARLY ROOF DRAINAGE CONNECTION FACT SHEET 11: SCOUR PROTECTION - STORMWATER PIPE OUTFALLS & CHECK DAMS FACT SHEET 12: STABILISED SITE ACCESS

FACT SHEET 13: WHEEL WASH FACT SHEET 14: SEDIMENT FENCES & FIBRE ROLLS FACT SHEET 15: PROTECTION OF STORMWATER PITS FACT SHEET 16: MANAGE CONCRETE, BRICK & TILE CUTTING

FACT SHEET 17: SEDIMENT BASINS

FACT SHEET 19: SITE RE-VEGETATION

FACT SHEET 18: DUST CONTROL

REQUIRED SITE INSPECTIONS

SUBBASE FOR ROADS, CARPARKS AND KERBS

FINAL TRIM PRIOR TO PLACING KERBS

FINAL TRIM PRIOR TO SEALING

MATERIALS AND WORK (ROADWORKS).

7 // LANDSCAPE / STREET FURNITURE

CONTRACTORS OR AS APPROVED BY COUNCIL.

SIGNAGE AND LINE MARKING

ONLY. REFER TO THE ARCHITECTURAL PLANS FOR DETAILS.

SUBGRADE PREPARATION

COLLECTIVE CONSULTING.

4 // HOTMIX ASPHALT

HOTMIX ASPHALT

6 // FOOTPATHS

TSD-R11-v3

5 // KERBS AND CHANNELS

8 // ROAD RESERVE WORKS

ARCHITECTURAL PLANS.

TO BE IN ACCORDANCE AS2890.6.

3 // TESTING

CIVIL WORKS

WORKMANSHIP COMPLY WITH PLANNING AND BUILDING PERMITS. THE NATIONAL CONSTRUCTION CODE OF AUSTRALIA (NCC), AUSTRALIAN STANDARDS (AS). DEPARTMENT OF STATE GROWTH (DSG), INSTITUTE OF PUBLIC WORKS ENGINEERING

AUSTRALIA (IPWEA) - TAS DIVISION, LOCAL GOVERNMENT ASSOCIATION TASMANIA

A. WHERE THE LOCATION OF SEWER OR STORMWATER INFRASTRUCTURE REQUIRING FILL DRAWINGS, PROCEED AS FOLLOWS:

EACH LAYER TO NOT LESS THAN 95% OF IT'S STANDARD MAXIMUM DRY DENSITY

A.4. BRING THE COMPACTED FILL LEVEL UP TO A HEIGHT OF AT LEAST 300MM ABOVE

THICKNESS AND COMPACT EACH LAYER TO NOT LESS THAN 95% OF IT'S

B. NOTE THAT ALL EARTHWORKS ARE TO BE CONSTRUCTED IN ACCORDANCE WITH

A DUE TO THE AGE OF BUILDING AND THE BEOLIBEMENTS FOR NEW BUILDING WORKS TO

COMPLY WITH THE NATIONAL CONSTRUCTION CODE OF AUSTRALIA (NCC), AUSTRALIAN

STANDARDS (AS) DEPARTMENT OF STATE GROWTH (DSG) INSTITUTE OF PUBLIC

WORKS ENGINEERING AUSTRALIA (IPWEA) - TAS DIVISION, LOCAL GOVERNMENT

ASSOCIATION TASMANIA (LGAT), WATER SERVICES ASSOCIATION OF AUSTRALIA

(WSAA) TASMANIA FIRE SERVICE REQUIREMENTS AND ANY OTHER STATE / TERRITORY

/ LOCAL GOVERNMENT REGULATIONS. CONTRACTORS ARE TO COMPLETE ALL

NECESSARY CHECKS AND ASSESSMENTS LISTED BELOW TO ENSURE THE BUILDING

COMMENCEMENT OF NEW WORKS. PROVIDE LATENT CONDITIONS REPORT TO

ENGINEER FOR PRICING. THIS REPORT IS TO IDENTIFY INFRASTRUCTURE UPGRADE

WORKS ARE READY FOR CERTIFICATE OF OCCUPANCY & CERTIFICATE OF COMPLETION.

B. ON-SITE TESTING IS TO BE CARRIED OUT DURING ESTABLISHMENT AND PRIOR TO

C. NO VARIATION WILL BE PAID FOR LATENT PLUMBING CONDITIONS THAT HAVE NOT

D. THESE WORKS ARE TO BE INCLUDED IN CONTRACTORS TENDER AS AGREED WITH

A.2. FLOW TEST ALL FIRE HOSE REELS FOR COMPLIANCE WITH AS1851.9. NOTIFY

A.3. UPGRADE FIRE HOSE REEL & HYDRANTS TO ACHIEVE COMPLIANCE WITH CURRENT

STANDARDS TO ALLOW ISSUE OF CERTIFICATE OF OCCUPANCY & COMPLETION.

WORKS & CHECK FOR LEAKS OR DEFECTS. MAKE GOOD DEFECTIVE AREAS &

CONDITIONS REPORT PREPARED AT FRONT END OF PROJECT. RE-TEST AFTER

PROVIDE CERTIFIED RESULTS TO ENGINEER FOR APPROVAL AS PART OF LATEN

A.4. PRESSURE TEST & DIE TEST EXISTING SEWER SYSTEM PRIOR TO COMMENCING

COMPLETION OF WORKS & PROVIDE RESULTS PRIOR TO HAND OVER.

BEEN IDENTIFIED DURING THE ON-SITE TESTING & LATENT CONDITIONS REPORT.

TRUCK, HAND DIGGING AND UNDERGROUND CCTV CAMERA INSPECTIONS.

A.5. PLACE THE REMAINDER OF THE FILL IN LAYERS NOT EXCEEDING 300MI

CONTRACTOR SPECIFIC WORKS - PLUMBING

INFRASTRUCTURE IN EMBANKMENT FILL

THE DESIGN LEVEL OF THE TOP OF THE PIPE.

STANDARD MAXIMUM DRY DENSITY (AS3798)

WORKS AT THE FRONT END OF THE PROJECT.

A. CONTRACTORS ARE TO COMPLETE THE FOLLOWING WORKS

RESULTS TO ENGINEER FOR APPROVAL

AS 2419.1. NOTIFY RESULTS TO ENGINEER FOR APPROVA

SUPERINTENDENT

2 // COMPLIANCE WORKS

A. ALL STORMWATER INFRASTRUCTURE WORKS TO BE IN ACCORDANCE WITH THE LOCAL COUNCIL AND DSG STANDARDS AND REGULATIONS. OR CONSTRUCTION IN AN EMBANKMENT. ALONG THE ROUTE SHOWN IN THE DESIGN B. ALL STORMWATER PLUMBING INFRASTRUCTURE AND DRAINAGE TO COMPLY WITH A.1. PREPARE THE FOUNDATION FOR THE FILL BY CLEANING AWAY ALL DEBRIS,

C. ANY DEPARTURE FROM THESE STANDARDS AND REGULATIONS REQUIRES THE PRIOR VEGETATION, ORGANIC MATERIAL AND TOPSOIL FOR THE FULL WIDTH OF THE A.2. COMPACT THE CLEARED SOIL SURFACE TO NOT LESS THAN 95% OF IT'S SUPERVISOR / INSPECTOR. STANDARD MAXIMUM DRY DENSITY (AS3798). 2 // TESTING A.3. PLACE THE FILL IN LAYERS NOT EXCEEDING 200MM THICKNESS AND COMPACT

WRITTEN APPROVAL FROM THE SUPERINTENDENT AND LOCAL COUNCIL'S WORKS A. ALL DRAINAGE WORKS SHALL BE SUBJECT TO THE TESTS PRESCRIBED BY THE

STORMWATER INFRASTRUCTURE

AUTHORITIES WHO HAVE JURISDICTION OVER THE VARIOUS SERVICES. B. ANY SECTION FAILING SUCH TESTS SHALL BE REMOVED AND REINSTALLED AT THE CONTRACTOR'S EXPENSE.

C. ONCE DRAINAGE INFRASTRUCTURE HAS BEEN INSTALLED, CONTRACTORS SHALL CCTV ALL PIPES AND SUBMIT FOOTAGE TO LOCAL COUNCIL FOR APPROVAL. 3 // MANHOLES (MH)

A. MANHOLES ARE TO BE Ø1050 ID (U.N.O.) PRECAST CONCRETE, INSTALLED IN ACCORDANCE WITH WSAA STANDARDS B. ALL MANHOLES IN TRAFFICABLE AREAS ARE TO BE FITTED WITH HEAVY DUTY CLASS D

GATIC COVERS AND SURROUNDS (U.N.O). C. ALL MANHOLES IN NON-TRAFFICABLE AREAS ARE TO BE FITTED WITH MEDIUM DUTY CLASS B GATIC COVERS AND SURROUNDS (U.N.O.). D. ALL MANHOLES ARE TO HAVE A 5m LENGTH OF Ø75mm MIN. AGRICULTURAL DRAIN

CONNECTED TO MANHOLE AND LAID IN THE UPSTREAM PIPE TRENCH IMMEDIATELY

4 // TRENCHING AND BACKFILLING A. ALL TRENCHES ARE TO BE EXCAVATED AND BACKFILLED IN ACCORDANCE WITH THESE DRAWINGS AND LOCAL COUNCIL STANDARDS, INCLUDING ELECTROMAGNETIC METAL IMPREGNATED TAPE IN ALL NON METALLIC PIPE TRENCHES.

ADJACENT TO AND AT THE INVERT OF THE LOWEST PIPEWORK.

6 // INSPECTIONS A. THE CONTRACTOR IS TO BE RESPONSIBLE FOR ORGANISING INSPECTIONS WITH THE SUPERINTENDENT - LIAISE WITH LOCAL COUNCIL. B. THE FOLLOWING SITE INSPECTIONS ARE REQUIRED DURING CONSTRUCTION / HOLD POINTS, AS A MINIMUM, BEFORE COMMENCEMENT OF FURTHER WORKS:

REQUIRED SITE INSPECTIONS PIPEWORK REDDING INSTALLED PIPE PRIOR TO BACKFILLING BACKFILLING

THE CONTRACTOR IS TO MAKE THEMSELVES AWARE OF ANY ADDITIONAL INSPECTIONS

E. LOCATE EXISTING INFRASTRUCTURE USING CABLE LOCATORS, POT HOLING, SUCTION REQUIRED BY THE LOCAL COUNCIL TO ACHIEVE PRACTICAL COMPLETION AND NOTIFY COLLECTIVE CONSULTING. D. COLLECTIVE CONSULTING REQUIRE MIN. 48 HOURS NOTICE PRIOR TO ALL REQUIRED INSPECTIONS. 7 // AS CONSTRUCTED DRAWINGS A.1. FLOW TEST ALL EXTERNAL & INTERNAL FIRE HYDRANTS FOR COMPLIANCE WITH

A. THE CONTRACTOR WILL BE RESPONSIBLE FOR PRODUCING 'AS INSTALLED' DRAWINGS TO THE STANDARD REQUIRED BY THE LOCAL COUNCIL THE DRAWINGS SHALL BE CERTIFIED AS BEING CORRECT BY EITHER A CHARTERED CIVIL ENGINEER OR A REGISTERED SURVEYOR. C. COLLECTIVE CONSULTING CAN PROVIDE THIS SERVICE AT AN ADDITIONAL FEE THIS

HAS NOT BEEN ALLOWED FOR AS PART OF THESE WORKS / CONTRACT. 8 // REDIINDANT PIPEWORK A. FILL ALL REDUNDANT SECTION OF PIPEWORK WITH 'LIQUIFILL' (GRADE PC.1 - 0.5-2.0

SEWER INFRASTRUCTURE 1 // GENERAL A. ALL SEWER INFRASTRUCTURE WORKS TO BE IN ACCORDANCE WITH THE WSAA

RETAIL WATER AGENCIES INTEGRATED (MRWA) VERSION 2.0 AND AS AMENDED BY THE TASWATER SUPPLEMENT B. TASWATER APPROVED PRODUCTS CAN BE FOUND AT THE FOLLOWING WEBSITE

SEWER CODE 02-2014-3.1 GRAVITY SEWERAGE CODE OF AUSTRALIA - MELBOURNE

https://mrwa.com.au/Pages/Products.aspx C. ANY DEPARTURE FROM THESE STANDARDS AND REGULATIONS REQUIRES THE PRIOR WRITTEN APPROVAL FROM THE SUPERINTENDENT AND TASWATER FIELD SERVICES OFFICER.

2 // TESTING A. ALL DRAINAGE WORKS SHALL BE SUBJECT TO THE TESTS PRESCRIBED BY THE AUTHORITIES WHO HAVE JURISDICTION OVER THE VARIOUS SERVICES. B. ANY SECTION FAILING SUCH TESTS SHALL BE REMOVED AND REINSTALLED AT THE CONTRACTOR'S EXPENSE

C. ONCE DRAINAGE INFRASTRUCTURE HAS BEEN INSTALLED, CONTRACTORS SHALL CCTV ALL PIPES AND SUBMIT FOOTAGE TO TASWATER FOR APPROVAL. 3 // SEWER MAIN CONNECTIONS A. ALL NEW 'LIVE' CONNECTIONS TO EXISTING TASWATER SEWER INFRASTRUCTURE INCLUDING, BUT NOT LIMITED TO SEWER MAINS AND MANHOLES, ARE TO BE COMPLETED BY TASWATER (UNLESS PRIOR WRITTEN APPROVAL) AT OWNERS COST.

B. INSTALL PROPERTY SEWER CONNECTIONS (STANDARD OR SLOPED) WITH A SURFACE INSPECTION OPENING (IO) NOM. 1.0m WITHIN EACH NEW LOT IN ACCORDANCE WITH SECTION 5 OF WSAA SEWER CODE 02-2014-3.1 GRAVITY SEWERAGE CODE OF AUSTRALIA (MRWA) VERSION 2.0. 4 // MANHOLES (MH) A. MANHOLES ARE TO BE Ø1050 ID (U.N.O.) PRECAST CONCRETE, INSTALLED IN

ACCORDANCE WITH WSAA STANDARDS B. CONSTRUCTION AND INSTALLATION OF ALL MANHOLES AND MANHOLE COVERS TO BE IN ACCORDANCE WITH THE WSAA SEWER CODE 02-2014-3.1 GRAVITY SEWERAGE CODE OF AUSTRALIA - MELBOURNE RETAIL WATER AGENCIES INTEGRATED (MRWA) VERSION 2.0 AND AS AMENDED BY THE TASWATER SUPPLEMENT. C. ALL MANHOLES IN TRAFFICABLE AREAS ARE TO BE FITTED WITH HEAVY DUTY CLASS D

GATIC COVERS AND SURROUNDS (U.N.O). D. ALL MANHOLES IN NON-TRAFFICABLE AREAS ARE TO BE FITTED WITH MEDIUM DUTY CLASS B GATIC COVERS AND SURROUNDS (U.N.O.). E. BENCHING TO BE FULL DEPTH OF PIPE DIA. AS PER DETAILS IN WSAA SEWER CODE

02-2014-3.1 GRAVITY SEWERAGE CODE OF AUSTRALIA - MELBOURNE RETAIL WATER AGENCIES INTEGRATED (MRWA) VERSION 2.0 AND AS AMENDED BY THE TASWATER 5 // TRENCHING AND BACKFILLING A. ALL TRENCHES ARE TO BE EXCAVATED AND BACKFILLED IN ACCORDANCE WITH THESE

DRAWINGS AND TASWATER STANDARDS, INCLUDING ELECTROMAGNETIC METAL IMPREGNATED TAPE IN ALL NON METALLIC PIPE TRENCHES. B. CEMENT STABILISED EMBEDMENT: FOR SEWER MAINS, INA CCORDANCE WITH MRWA SEWERAGE STANDARDS DRAWING RWA-S AND AS AMENDED BY THE TASWATER SUPPLEMENT.

6 // INSPECTIONS A. THE CONTRACTOR IS TO BE RESPONSIBLE FOR ORGANISING INSPECTIONS WITH THE SUPERINTENDENT - LIAISE WITH TASWATER. B. THE FOLLOWING SITE INSPECTIONS ARE REQUIRED DURING CONSTRUCTION / HOLD POINTS, AS A MINIMUM, BEFORE COMMENCEMENT OF FURTHER WORKS: REQUIRED SITE INSPECTIONS: PIPEWORK REDDING INSTALLED PIPE PRIOR TO BACKFILLING BACKFILLING C. THE CONTRACTOR IS TO MAKE THEMSELVES AWARE OF ANY ADDITIONAL INSPECTIONS REQUIRED BY TASWATER TO ACHIEVE PRACTICAL COMPLETION AND NOTIFY

COLLECTIVE CONSULTING.

CIVIL ENGINEER OR A REGISTERED SURVEYOR.

D. COLLECTIVE CONSULTING REQUIRE MIN. 48 HOURS NOTICE PRIOR TO ALL REQUIRED 7 // AS CONSTRUCTED DRAWINGS A. THE CONTRACTOR WILL BE RESPONSIBLE FOR PRODUCING 'AS INSTALLED' DRAWINGS TO THE STANDARD REQUIRED BY TASWATER. B. THE DRAWINGS SHALL BE CERTIFIED AS BEING CORRECT BY EITHER A CHARTERED

C. COLLECTIVE CONSULTING CAN PROVIDE THIS SERVICE, AT AN ADDITIONAL FEE. THIS HAS NOT BEEN ALLOWED FOR AS PART OF THESE WORKS / CONTRACT. 8 // REDUNDANT PIPEWORK A. FILL ALL REDUNDANT SECTION OF PIPEWORK WITH 'LIQUIFILL' (GRADE PC.1 - 0.5-2.0 MPa), U.N.O.

WATER RETICULATION INFRASTRUCTURE

A. ALL WATER INFRASTRUCTURE WORKS TO BE IN ACCORDANCE WITH THE FOLLOWING: A.1. WSAA WATER SUPPLY CODE 03-2011-3.1 WATER SUPPLY CODE OF AUSTRALIA MELBOURNE RETAIL WATER AGENCIES INTEGRATED (MRWA) VERSION 2.0 AND AS AMENDED BY THE TASWATER SUPPLEMENT

A.2. TASWATER'S STANDARD DRAWINGS TWS-W-0002 SERIES.

A.3. WATER METERING POLICY / METERING GUIDELINES. A.4. TASWATER'S STANDARD DRAWINGS TWS-W-0003 SERIES - FOR PROPERTY SERVICE CONNECTIONS - CAGE FOR WATER METER ASSEMBLY. A.5. BOUNDARY BACKFLOW CONTAINMENT REQUIREMENTS AND AS3500.1.

B. ANY DEPARTURE FROM THESE STANDARDS AND REGULATIONS REQUIRES THE PRIOR WRITTEN APPROVAL FROM THE SUPERINTENDENT AND TASWATER'S FIELD SERVICES 2 // TESTING A. ALL DRAINAGE WORKS SHALL BE SUBJECT TO THE TESTS PRESCRIBED BY THE

AUTHORITIES WHO HAVE JURISDICTION OVER THE VARIOUS SERVICES. B. ANY SECTION FAILING SUCH TESTS SHALL BE REMOVED AND REINSTALLED AT THE CONTRACTOR'S EXPENSE. 3 // FIRE HYDRANTS (FH)

A. INSTALLATION, COMMISSIONING AND TESTING OF FIRE HYDRANTS TO BE IN ACCRORDANCE WITH AS2419.

B. FIRE HYDRANTS ARE TO BE AS SHOWN ON THE DRAWINGS. THE CONTRACTOR IS TO ALLOW TO PLACE STANDARD MARKERS AS REQUIRED BY THE LOCAL AUTHORITY. 4 // THRUST AND ANCHOR BLOCKS A. THRUST AND ANCHOR BLOCKS ARE TO BE PROVIDED AT BENDS, VALVES, HYDRANTS

AND LINE ENDS IN ACCORDANCE WITH TASWATER STANDARD

5 // TRENCHING AND BACKFILLING A. ALL TRENCHES ARE TO BE EXCAVATED AND BACKFILLED IN ACCORDANCE WITH THESE DRAWINGS AND TASWATER STANDARDS, INCLUDING ELECTROMAGNETIC METAL IMPREGNATED TAPE IN ALL NON METALLIC PIPE TRENCHES. B. CEMENT STABILISED EMBEDMENT

B.1. THE LATEST VERSION OF DRAWING MRWA-W-208 (REV 3) INCLUDES TABLE 208_A WITH NOTE G INDICATING THAT WHEN TRENCHSTOPS OR BULKHEADS ARE USED (GRADES GREATER THAN 5%) CEMENT STABILISED EMBEDMENT MUST BE USED. THIS IS NOT TASWATER'S PREFERRED STANDARD. B.2. FOR PIPES UP TO 10% GRADE TASWATER WILL ACCEPT THE PREVIOUS REVISION OF MRWA (REV 2). IE PIPES UP TO 10% GRADE DO NOT REQUIRE CEMENT STABILISED

MAINS ARE LAID AT >5% SLOPE IN AREAS THAT ARE LIKELY TO HAVE HIGH GROUND WATER, CEMENT STABILISED EMBEDMENT SHALL BE USED... B.3. FOR PIPES AT GRADE GREATER THAN 10% MRWA-W-208 REV 3 REMAINS VALID. B.4. THE LATEST VERSION OF MRWA-W-203 (REV 2) EMBEDMENT SHALL BE ADOPTED NOTING THAT THE REQUIREMENT IDENTIFIED IN THE THIRD DOT POINT FOR TYPE B

EMBEDMENT LINESS THE CONDITIONS OF NOTE H APPLY - WHEN SOCKETED

IN THE NOTES REGARDING TABLE 203-A SHALL BE AMENDED TO READ 'WHERE WATER MAIN GRADE >10%'. B.5. FURTHER TO THIS IT SHOULD BE NOTED THAT MOST WATER MAINS ARE LIKELY TO REQUIRE A TYPE A EMBEDMENT SYSTEM. THE VARIOUS MATERIALS AVAILABLE FOR THIS SYSTEM ARE IDENTIFIED IN TABLE 203-B.

6 // INSPECTIONS A. THE CONTRACTOR IS TO BE RESPONSIBLE FOR ORGANISING INSPECTIONS WITH THE SUPERINTENDENT - LIAISE WITH LOCAL COUNCIL.

B. THE FOLLOWING SITE INSPECTIONS ARE REQUIRED DURING CONSTRUCTION / HOLD POINTS, AS A MINIMUM, BEFORE COMMENCEMENT OF FURTHER WORKS: REQUIRED SITE INSPECTIONS: PIPEWORK REDDING INSTALLED PIPE PRIOR TO BACKFILLING

C. THE CONTRACTOR IS TO MAKE THEMSELVES AWARE OF ANY ADDITIONAL INSPECTIONS REQUIRED BY TASWATER TO ACHIEVE PRACTICAL COMPLETION AND NOTIFY COLLECTIVE CONSULTING. D. COLLECTIVE CONSULTING REQUIRE $\underline{\text{MIN. }48\ \text{HOURS}}$ $\underline{\text{NOTICE}}$ PRIOR TO ALL REQUIRED

7 // PIPE CLEANING - 'DISINFECTION' A. THE CONTRACTOR IS TO ALLOW TO CLEANSE WATER MAINS BY FLUSHING WITH SODIUM HYPOCHLORITE (OR SIMILAR), AS DIRECTED BY THE LOCAL AUTHORITY. 8 // AS CONSTRUCTED DRAWINGS

A. THE CONTRACTOR WILL BE RESPONSIBLE FOR PRODUCING 'AS INSTALLED' DRAWINGS TO THE STANDARD REQUIRED BY TASWATER. B. THE DRAWINGS SHALL BE CERTIFIED AS BEING CORRECT BY EITHER A CHARTERED CIVIL ENGINEER OR A REGISTERED SURVEYOR.

C. COLLECTIVE CONSULTING CAN PROVIDE THIS SERVICE, AT AN ADDITIONAL FEE. THIS

HAS NOT BEEN ALLOWED FOR AS PART OF THESE WORKS / CONTRACT. 9 // PROPERTY WATER CONNECTIONS A. ALL PROPERTY CONNECTIONS SHALL BE CONSTRUCTED IN ACCORDANCE WITH MRWA-W-110, MRWA-W-111 AND TASWATER TW-W-0002 SERIES STANDARD

DRAWINGS. A. UNLESS NOTED OTHERWISE, PROPERTY WATER CONNECTIONS SHALL BE DN25 (Ø20 ID) HDPE (PE100) SDR 11 PN16 PIPES, WHERE INSTALLED UNDER ROADS, PIPES SHALL BE SLEEVED IN DN100 SN4 PIPES, FITTED WITH TRACE AND TIGHT FITTING RUBBER WRAPS AT 2M MAX. CENTRES TO PREVENT WATER HAMMER.

10 // WATER MAINS CONNECTIONS A. ALL NEW 'LIVE' CONNECTIONS TO EXISTING TASWATER WATER INFRASTRUCTURE ARE TO BE COMPLETED BY TASWATER (UNLESS PRIOR WRITTEN APPROVAL) AT OWNERS

A. MINIMUM COVER FOR WATER LINES ARE TO BE CONDITIONS / POSITION: UNDER ROADWAYS AND VEHICLE CROSSOVERS

11 // MINIMUM COVER

CONNECTIONS, ETC.

(EXCLUDING MAJOR ROADWAYS) RESIDENTIAL LAND NON-RESIDENTIAL LAND 12 // TASWATER APPLICATIONS AND SIGN-OFF A. THE CONTRACTOR IS RESPONSIBLE FOR LODGING ALL FURTHER APPLICATIONS FOR

B. THE CONTRACTOR IS RESPONSIBLE FOR ENSURING ALL FINAL SIGN OFF BY TASWATER

The use and development must be undertaken and completed in accordance with the approved plans, except for changes required to comply with planning permit conditions. The use and development must not be otherwise changed without the approval of Council.

GLENORCHY CITY COUNCIL PLANNING SERVICES APPLICATION No.: PLN-24-270

DATE RECEIVED: 12/06/2025

THESE DRAWINGS ARE TO BE PRINTED AND READ IN COLOUR. A FULL SIZED PRINTED COLOUR COPY SHOULD BE RETAINED ON SITE AT ALL TIMES FOR CONTRACTORS AND SUB-CONSULTANTS COMPLETING THE WORKS.



Level 1, 10-14 Paterson Street Launceston TAS 7250 P (03) 6334 0834



PROJECT DETAILS: DRAWING TITLE: 168a ABBOTSFIELD ROAD. CLAREMONT **CIVIL NOTES** UNITS DEVELOPMENT SCALE: PROJECT No: DRAWING No: REVISION: DESIGN CHECK: DRAWN BY: DRAFT CHECK: CERTIFIER: DESIGN BY: 241043 C001 JTA JTA

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PROJECT DOCUMENTS.

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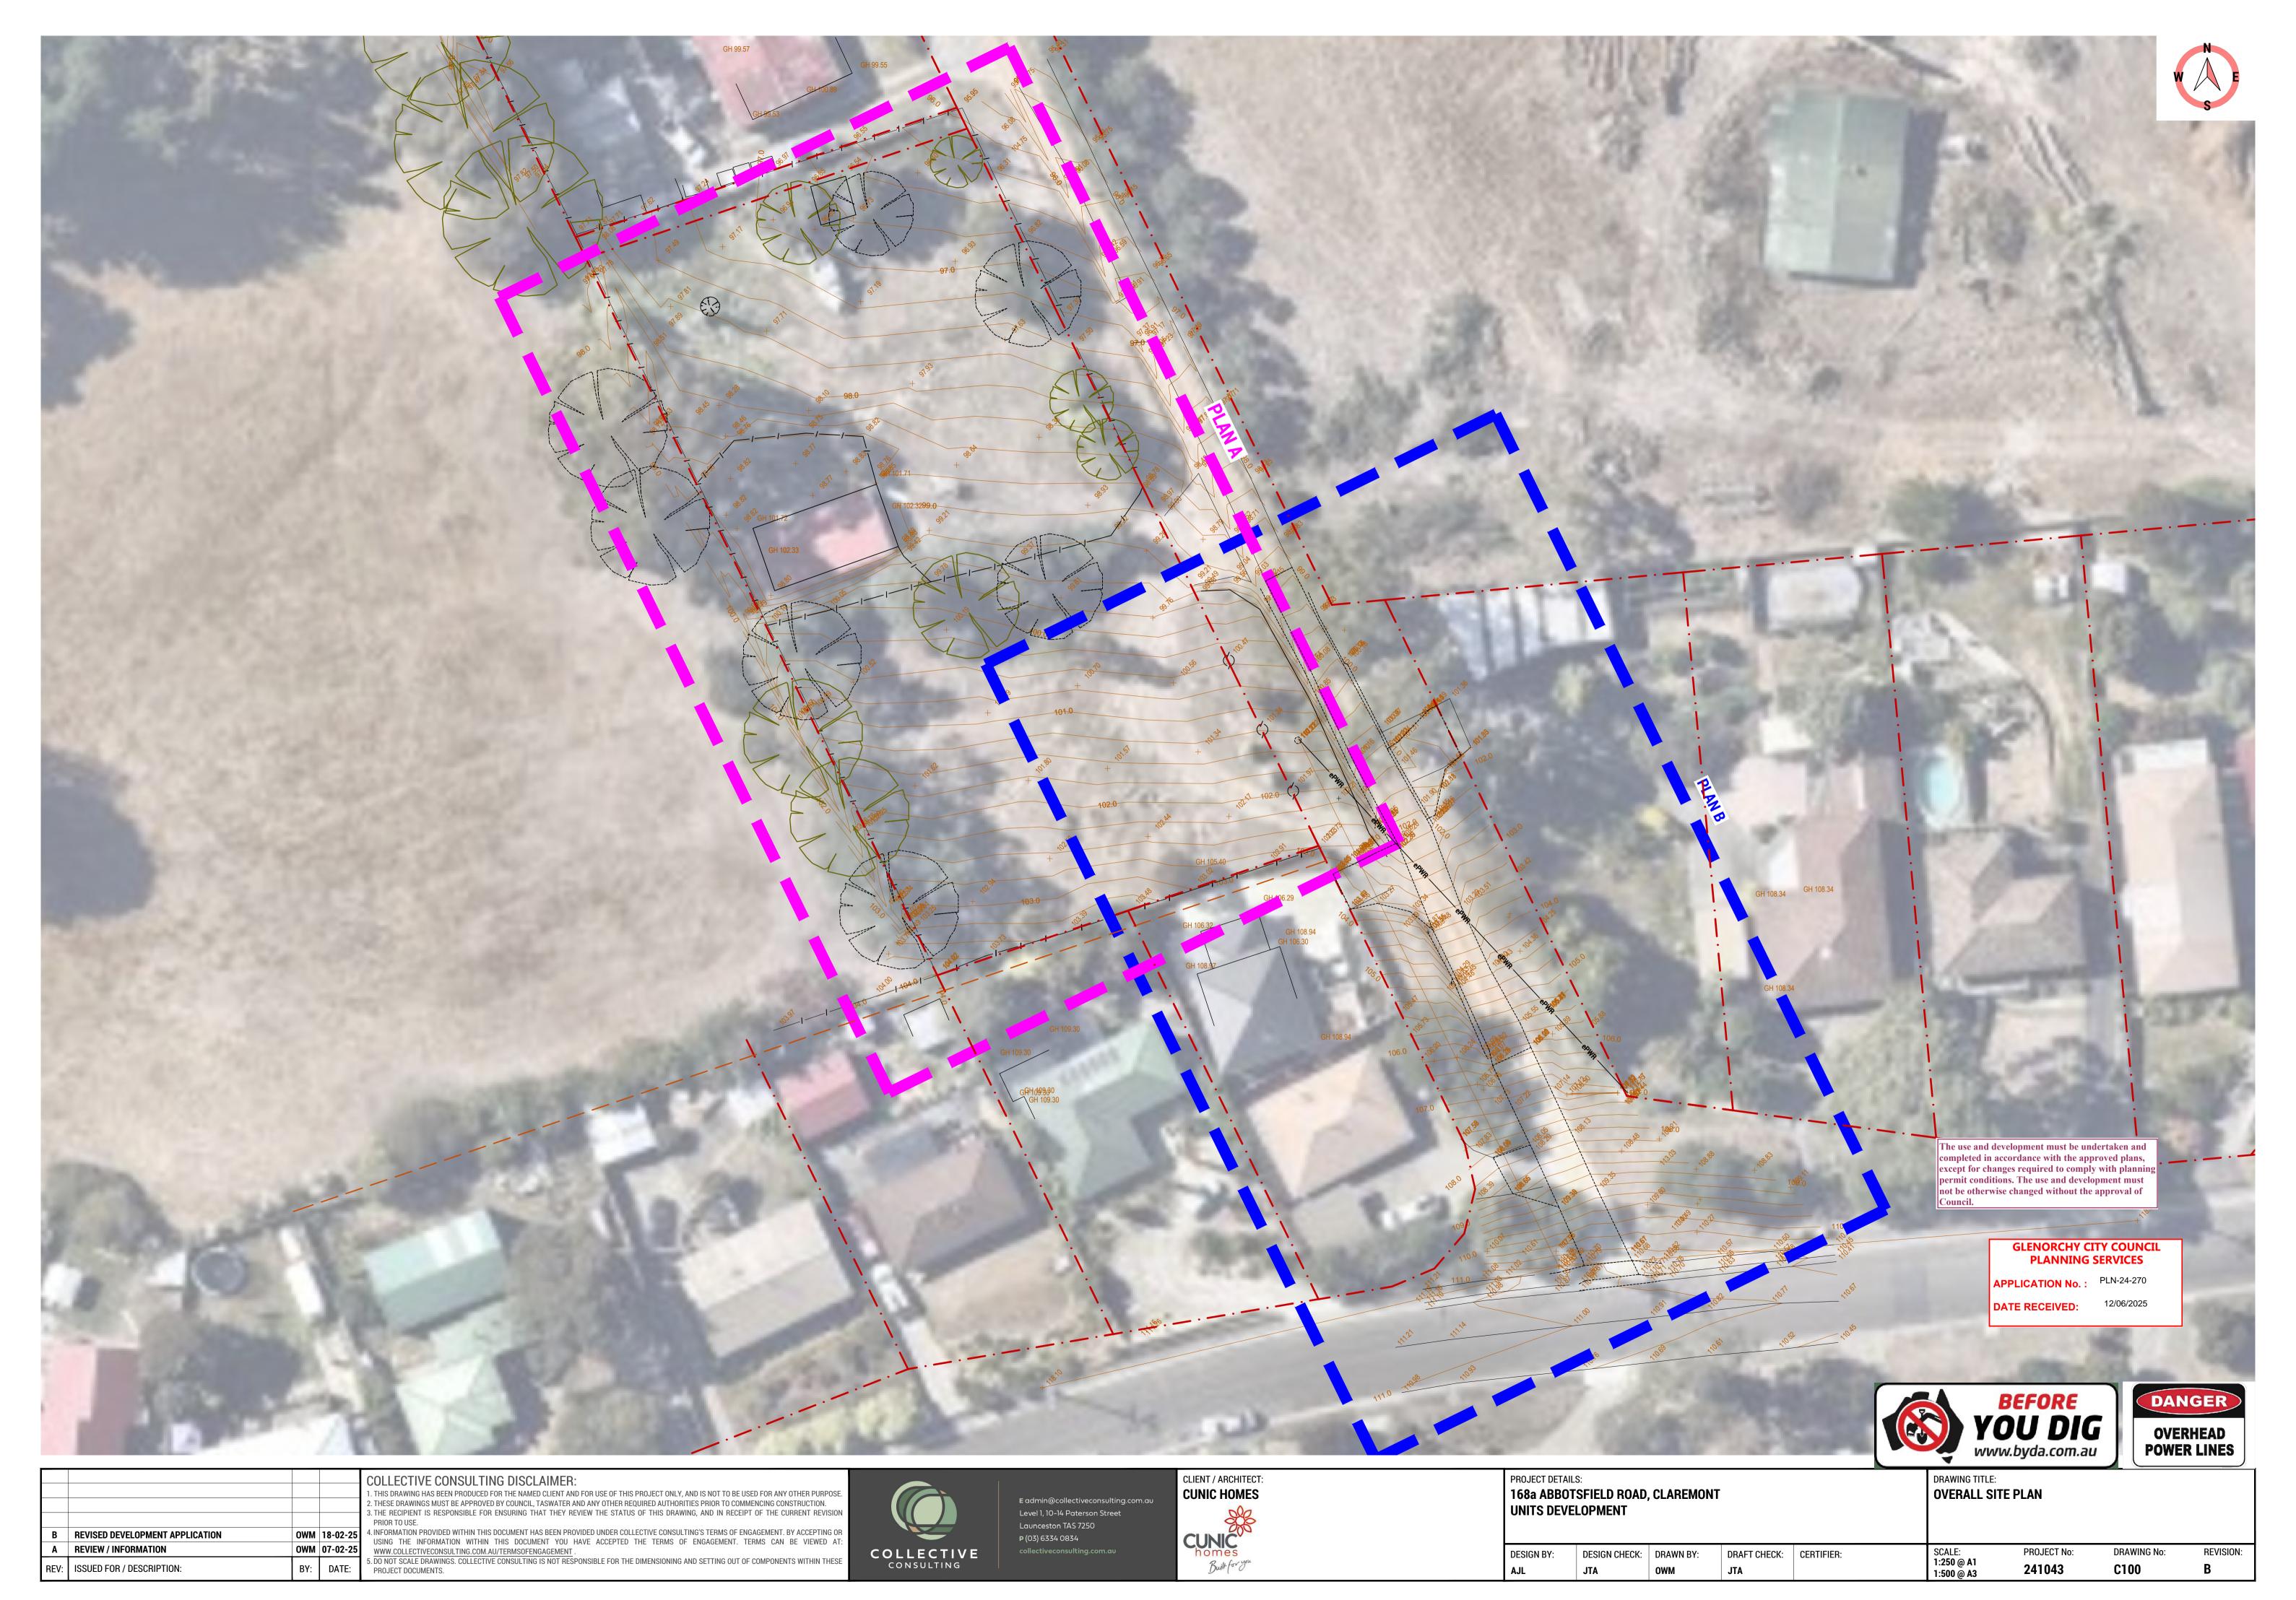
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DEVELOPMENT APPLICATION


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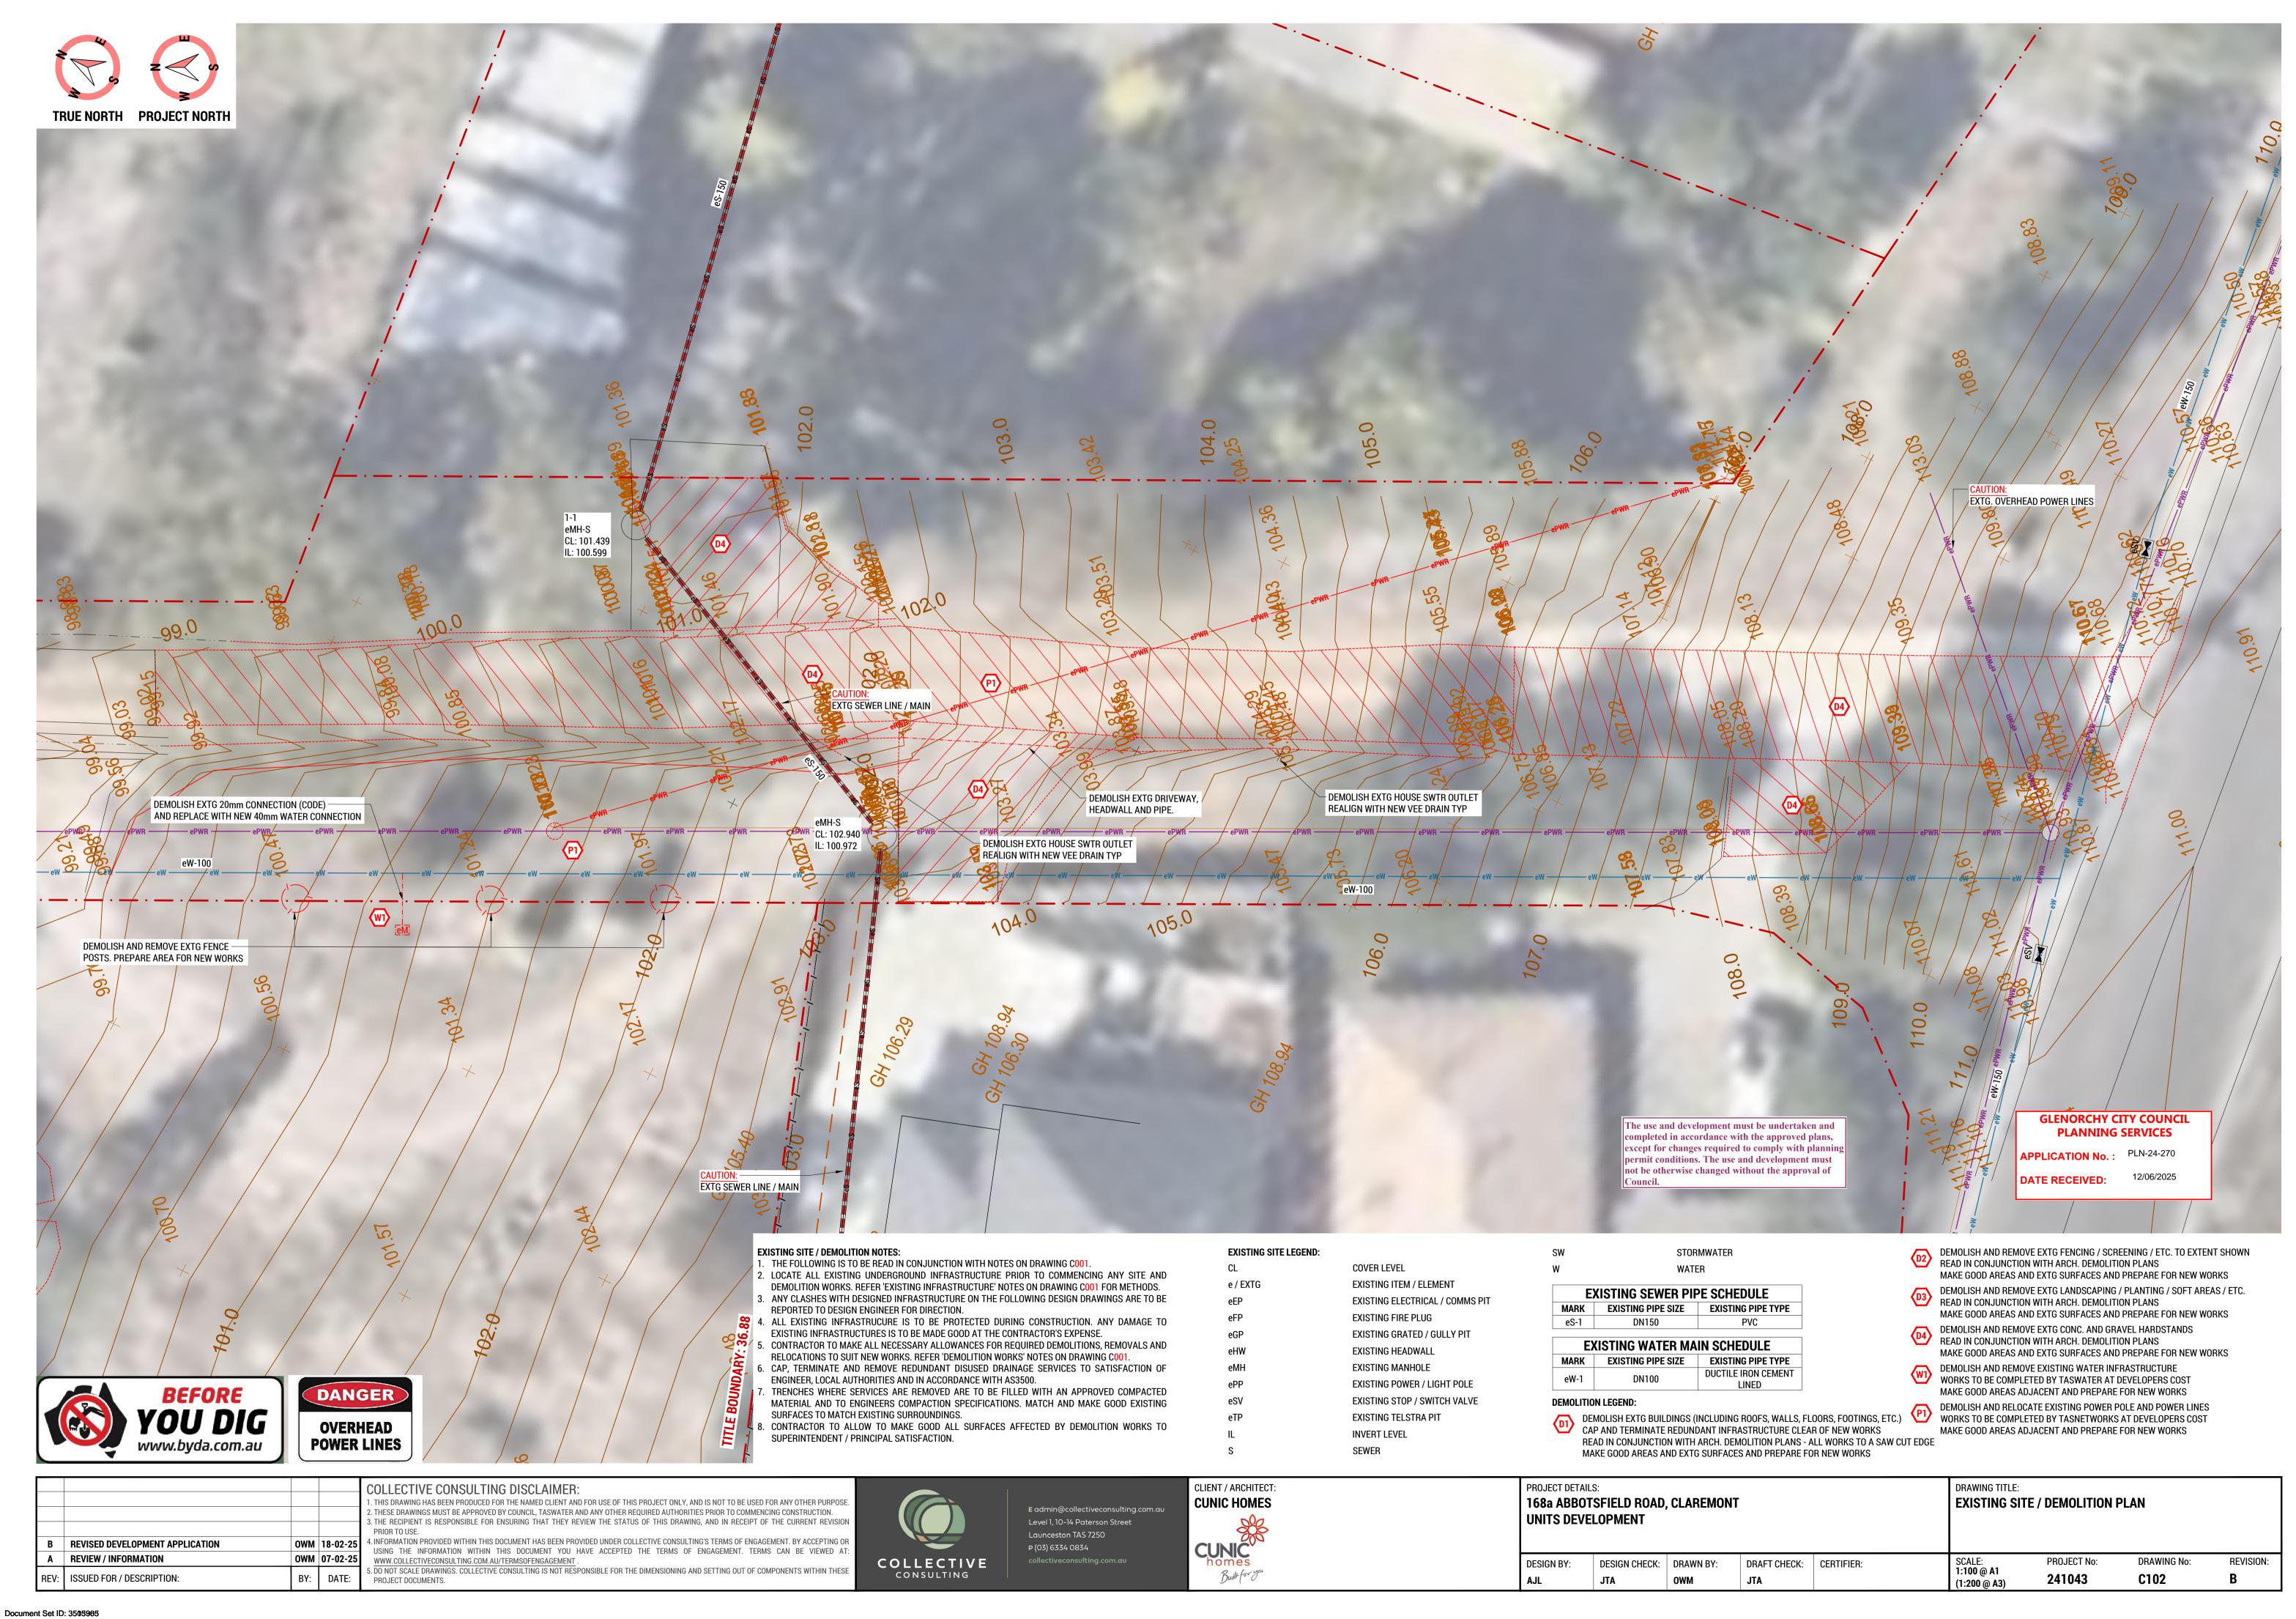
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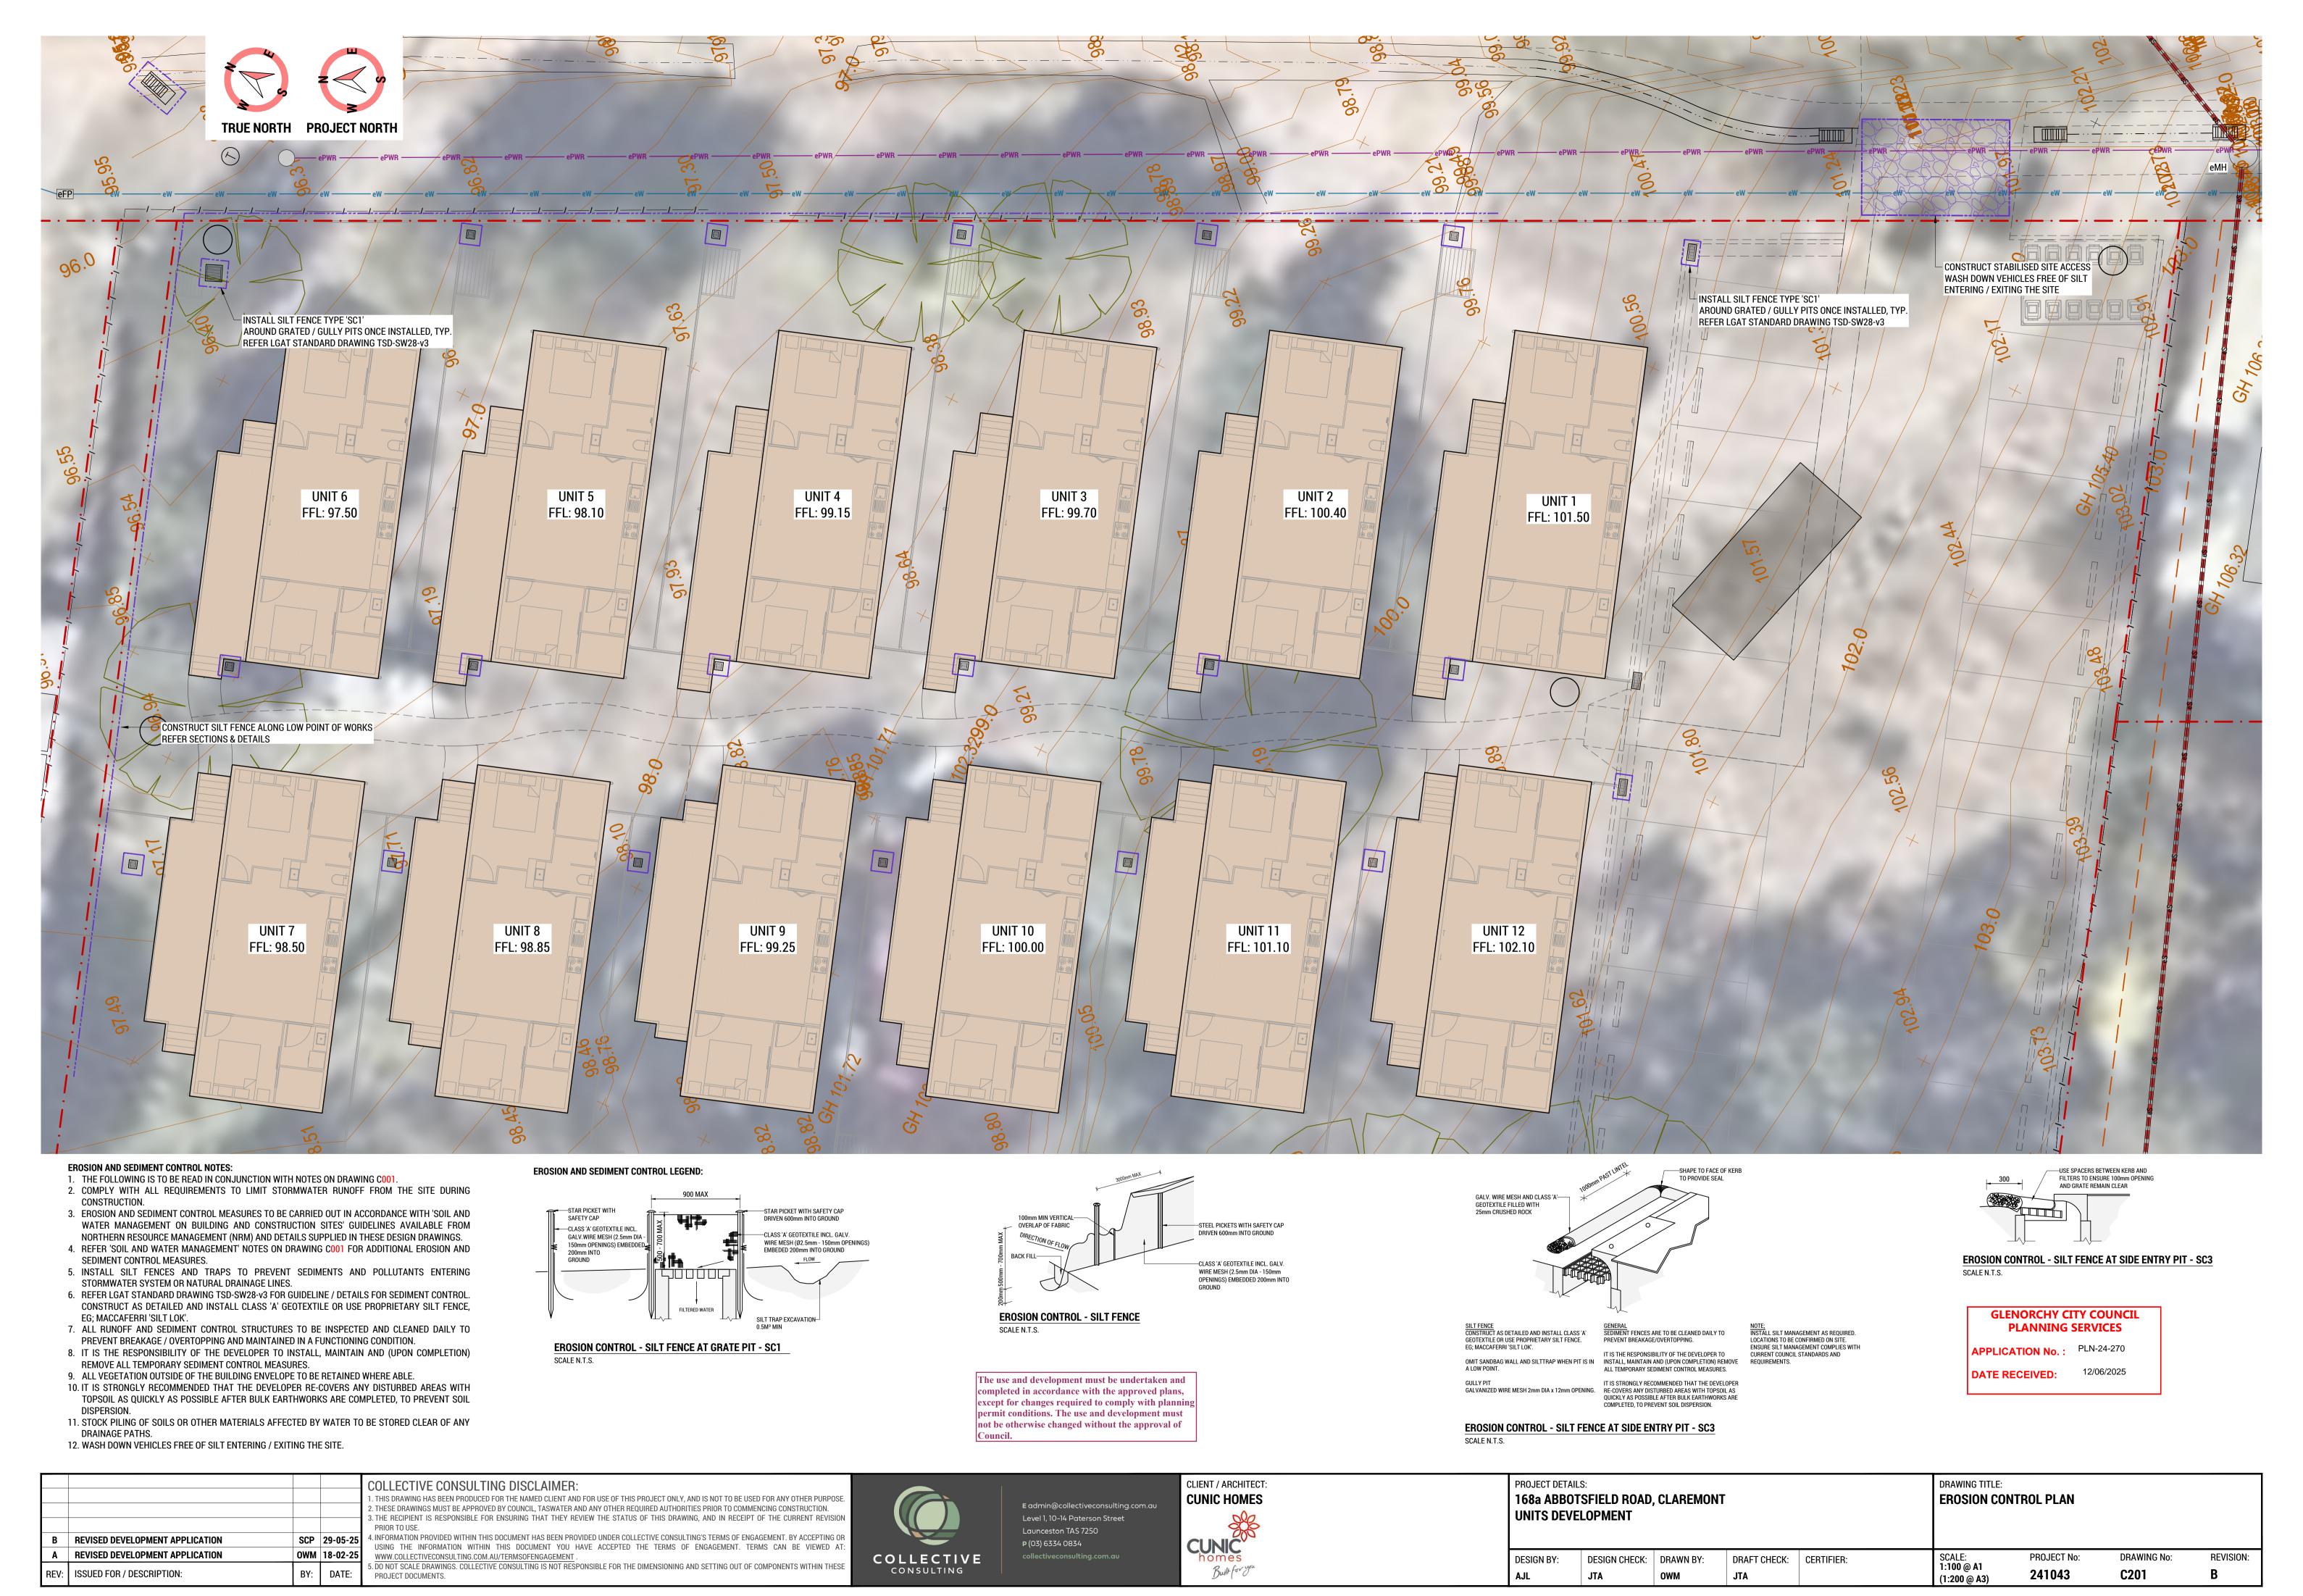
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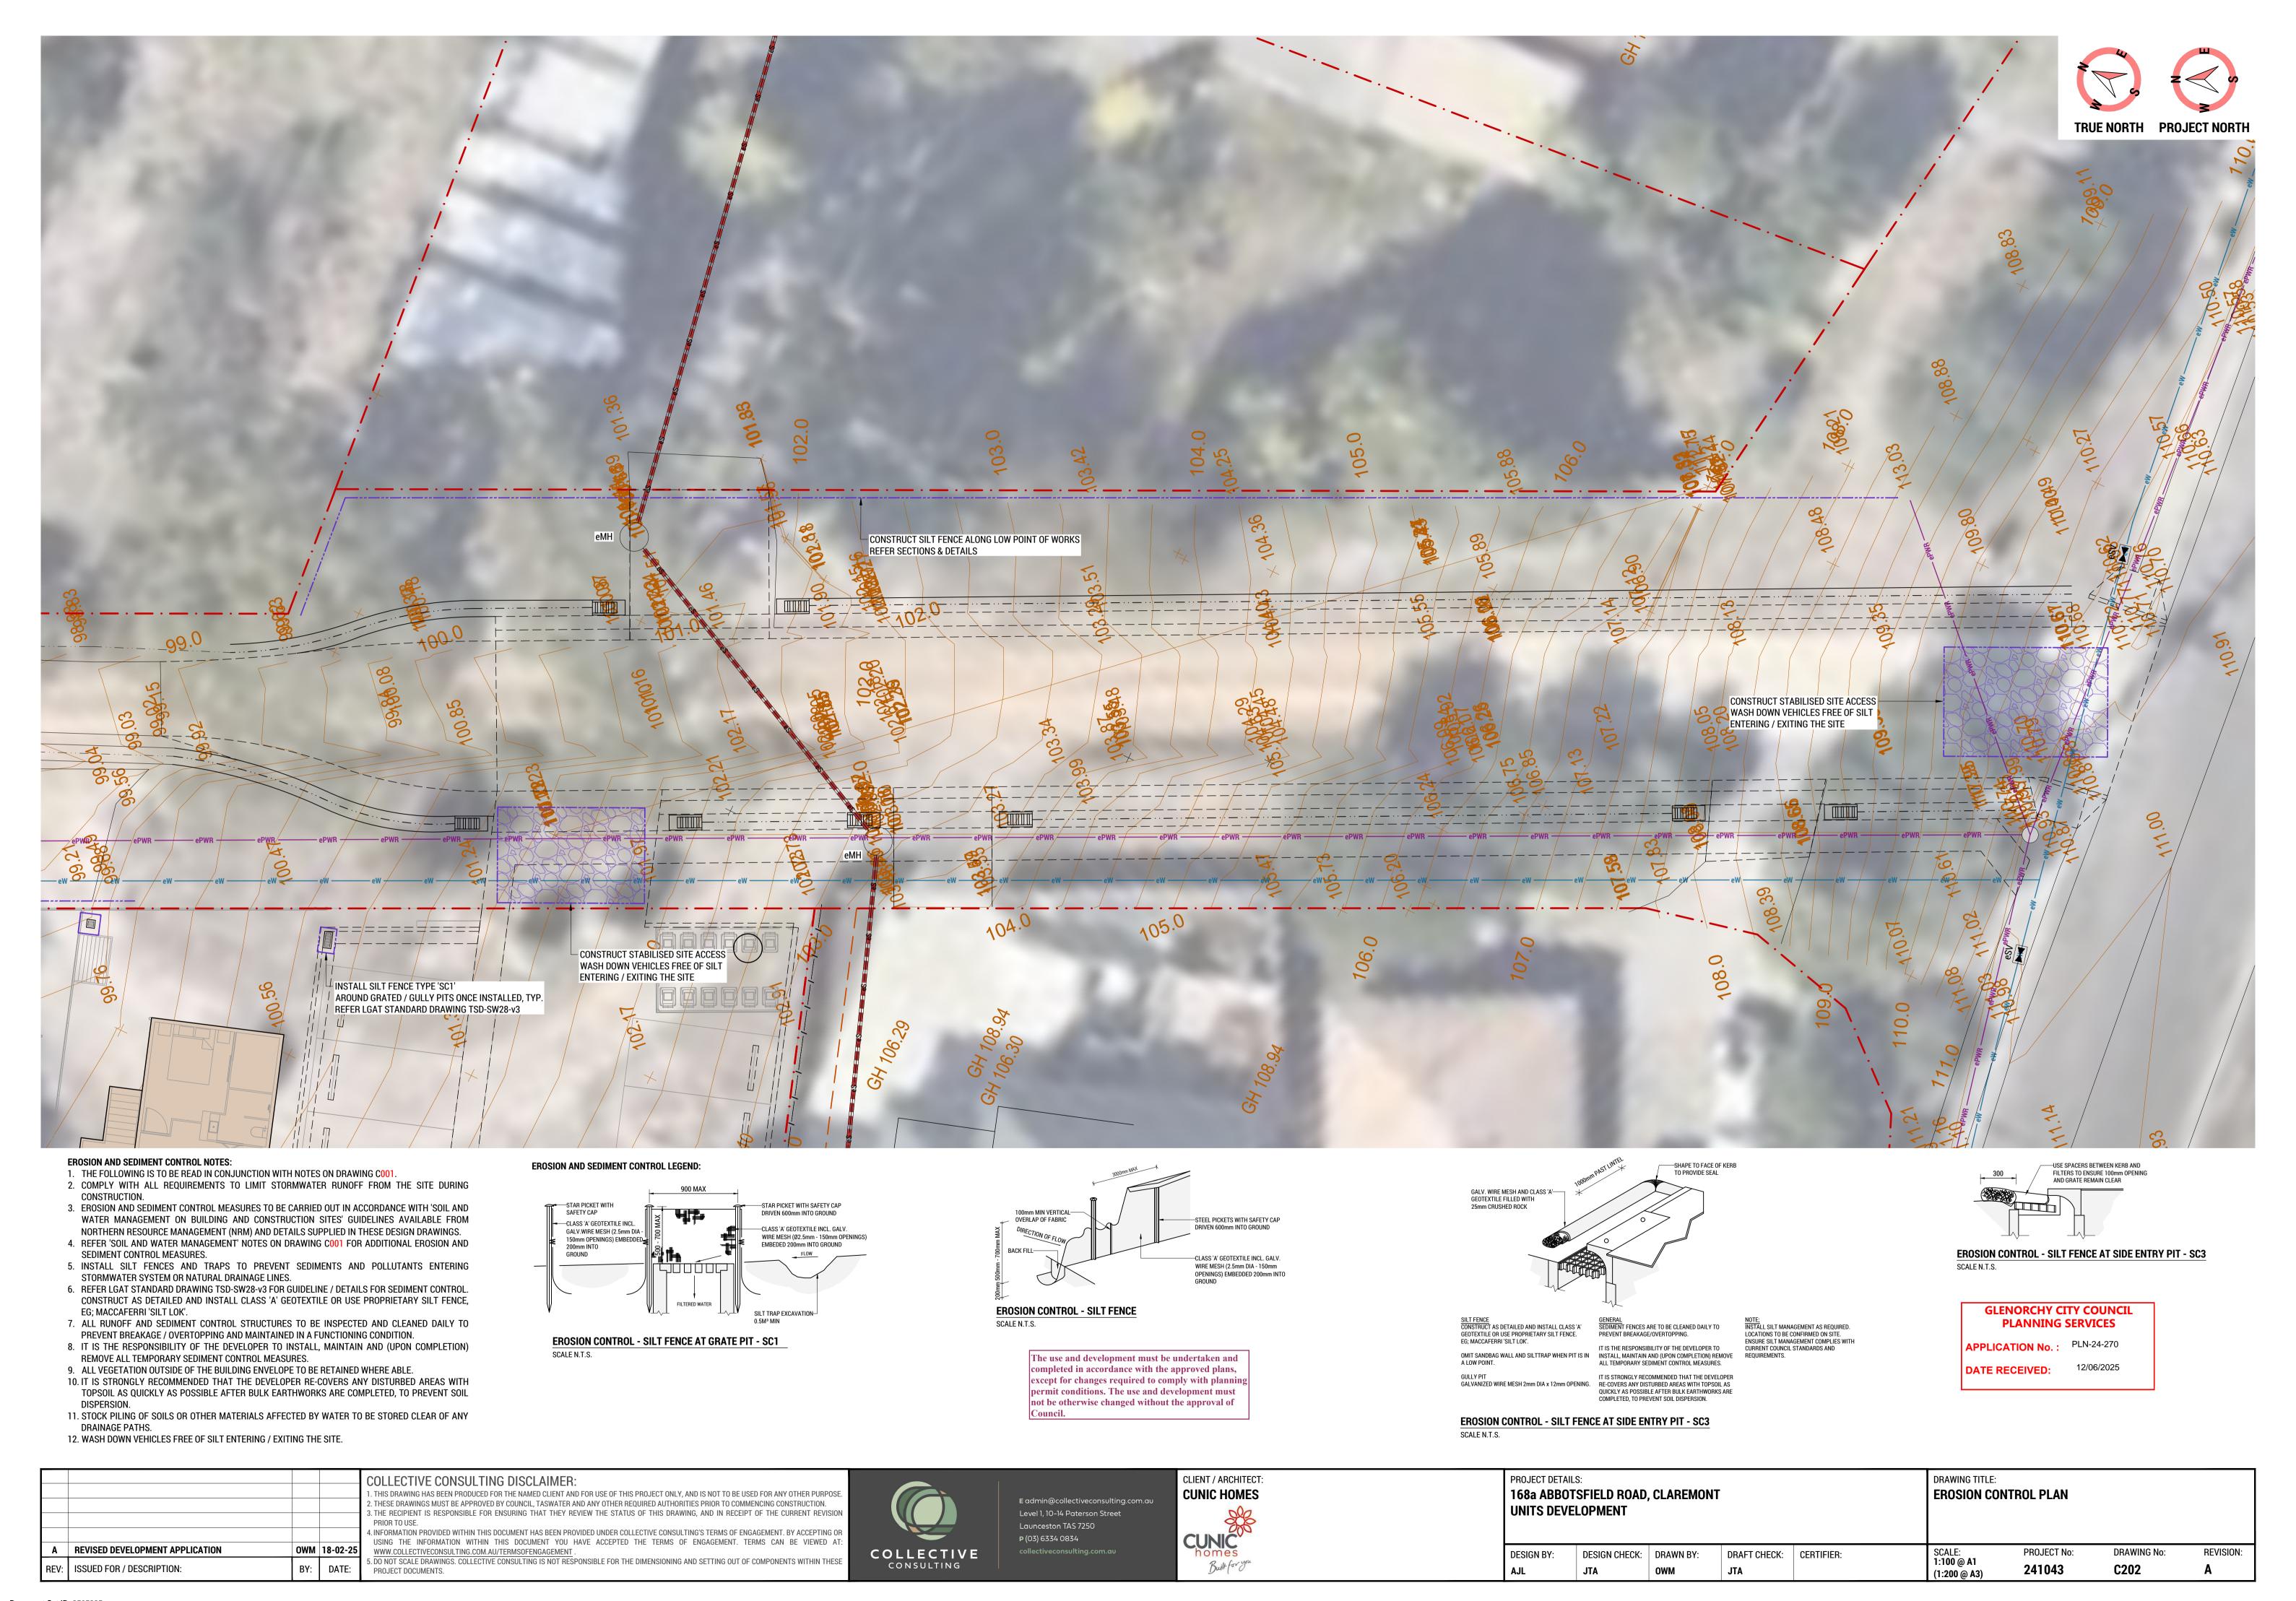



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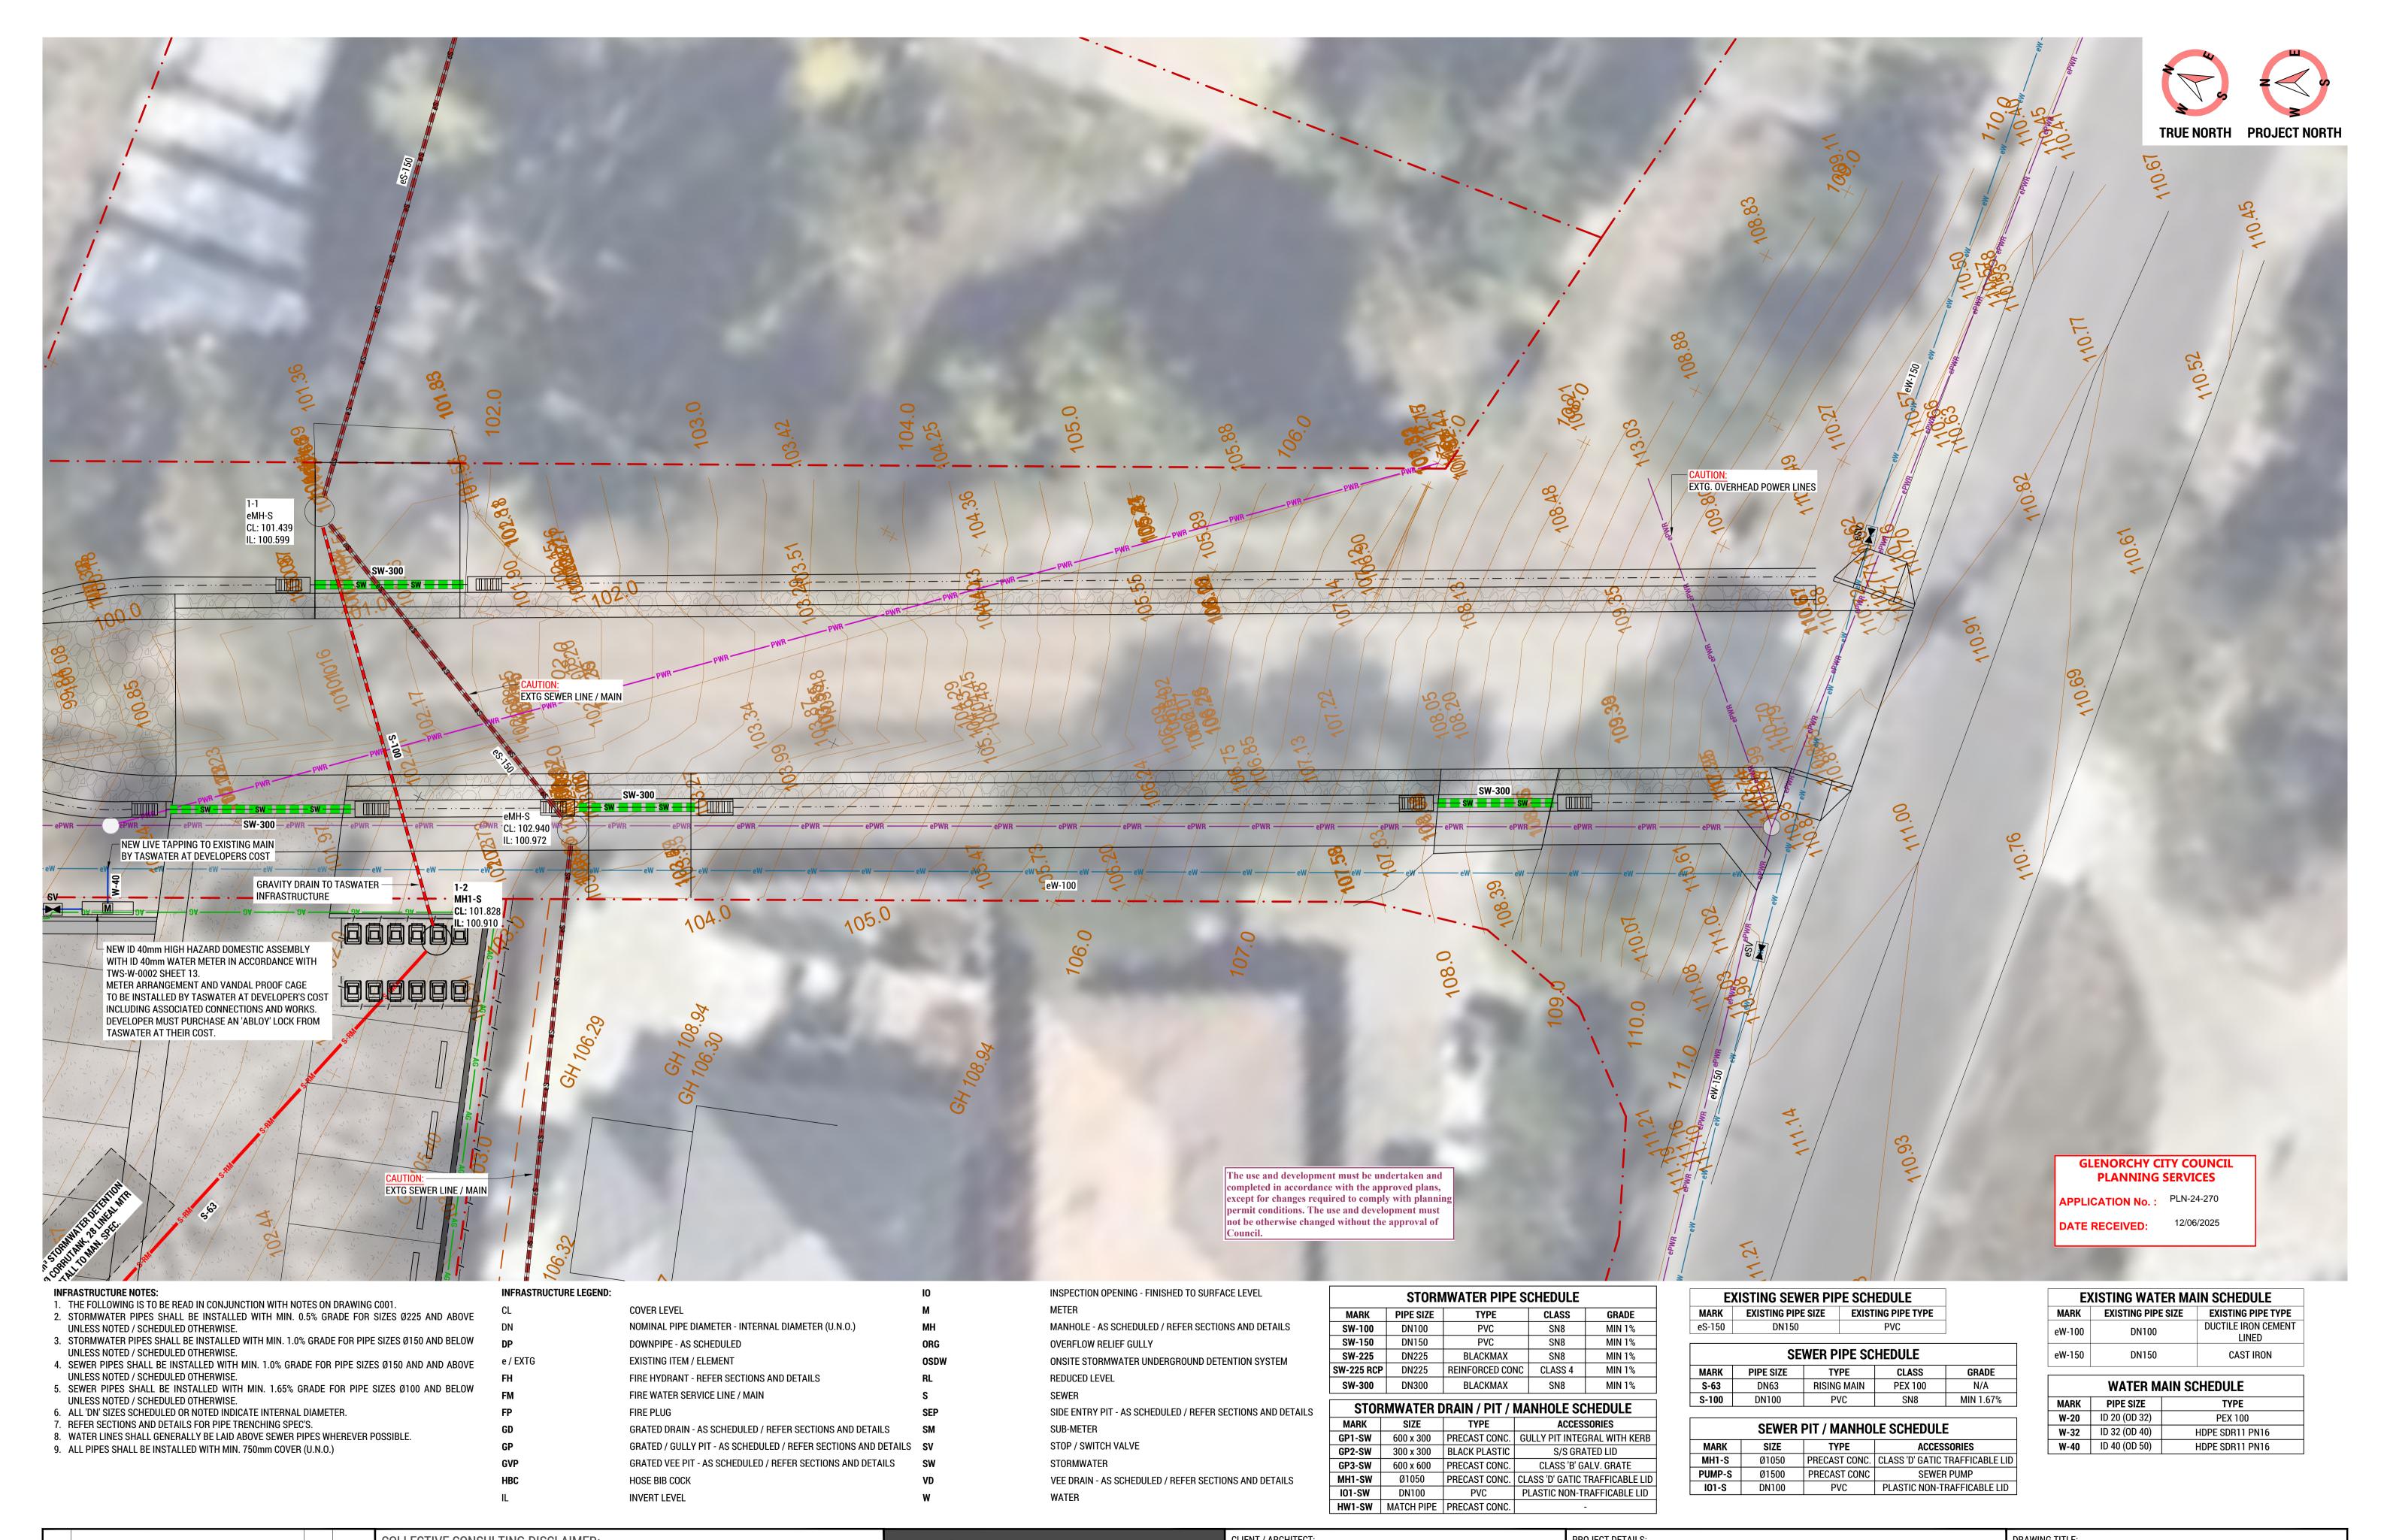







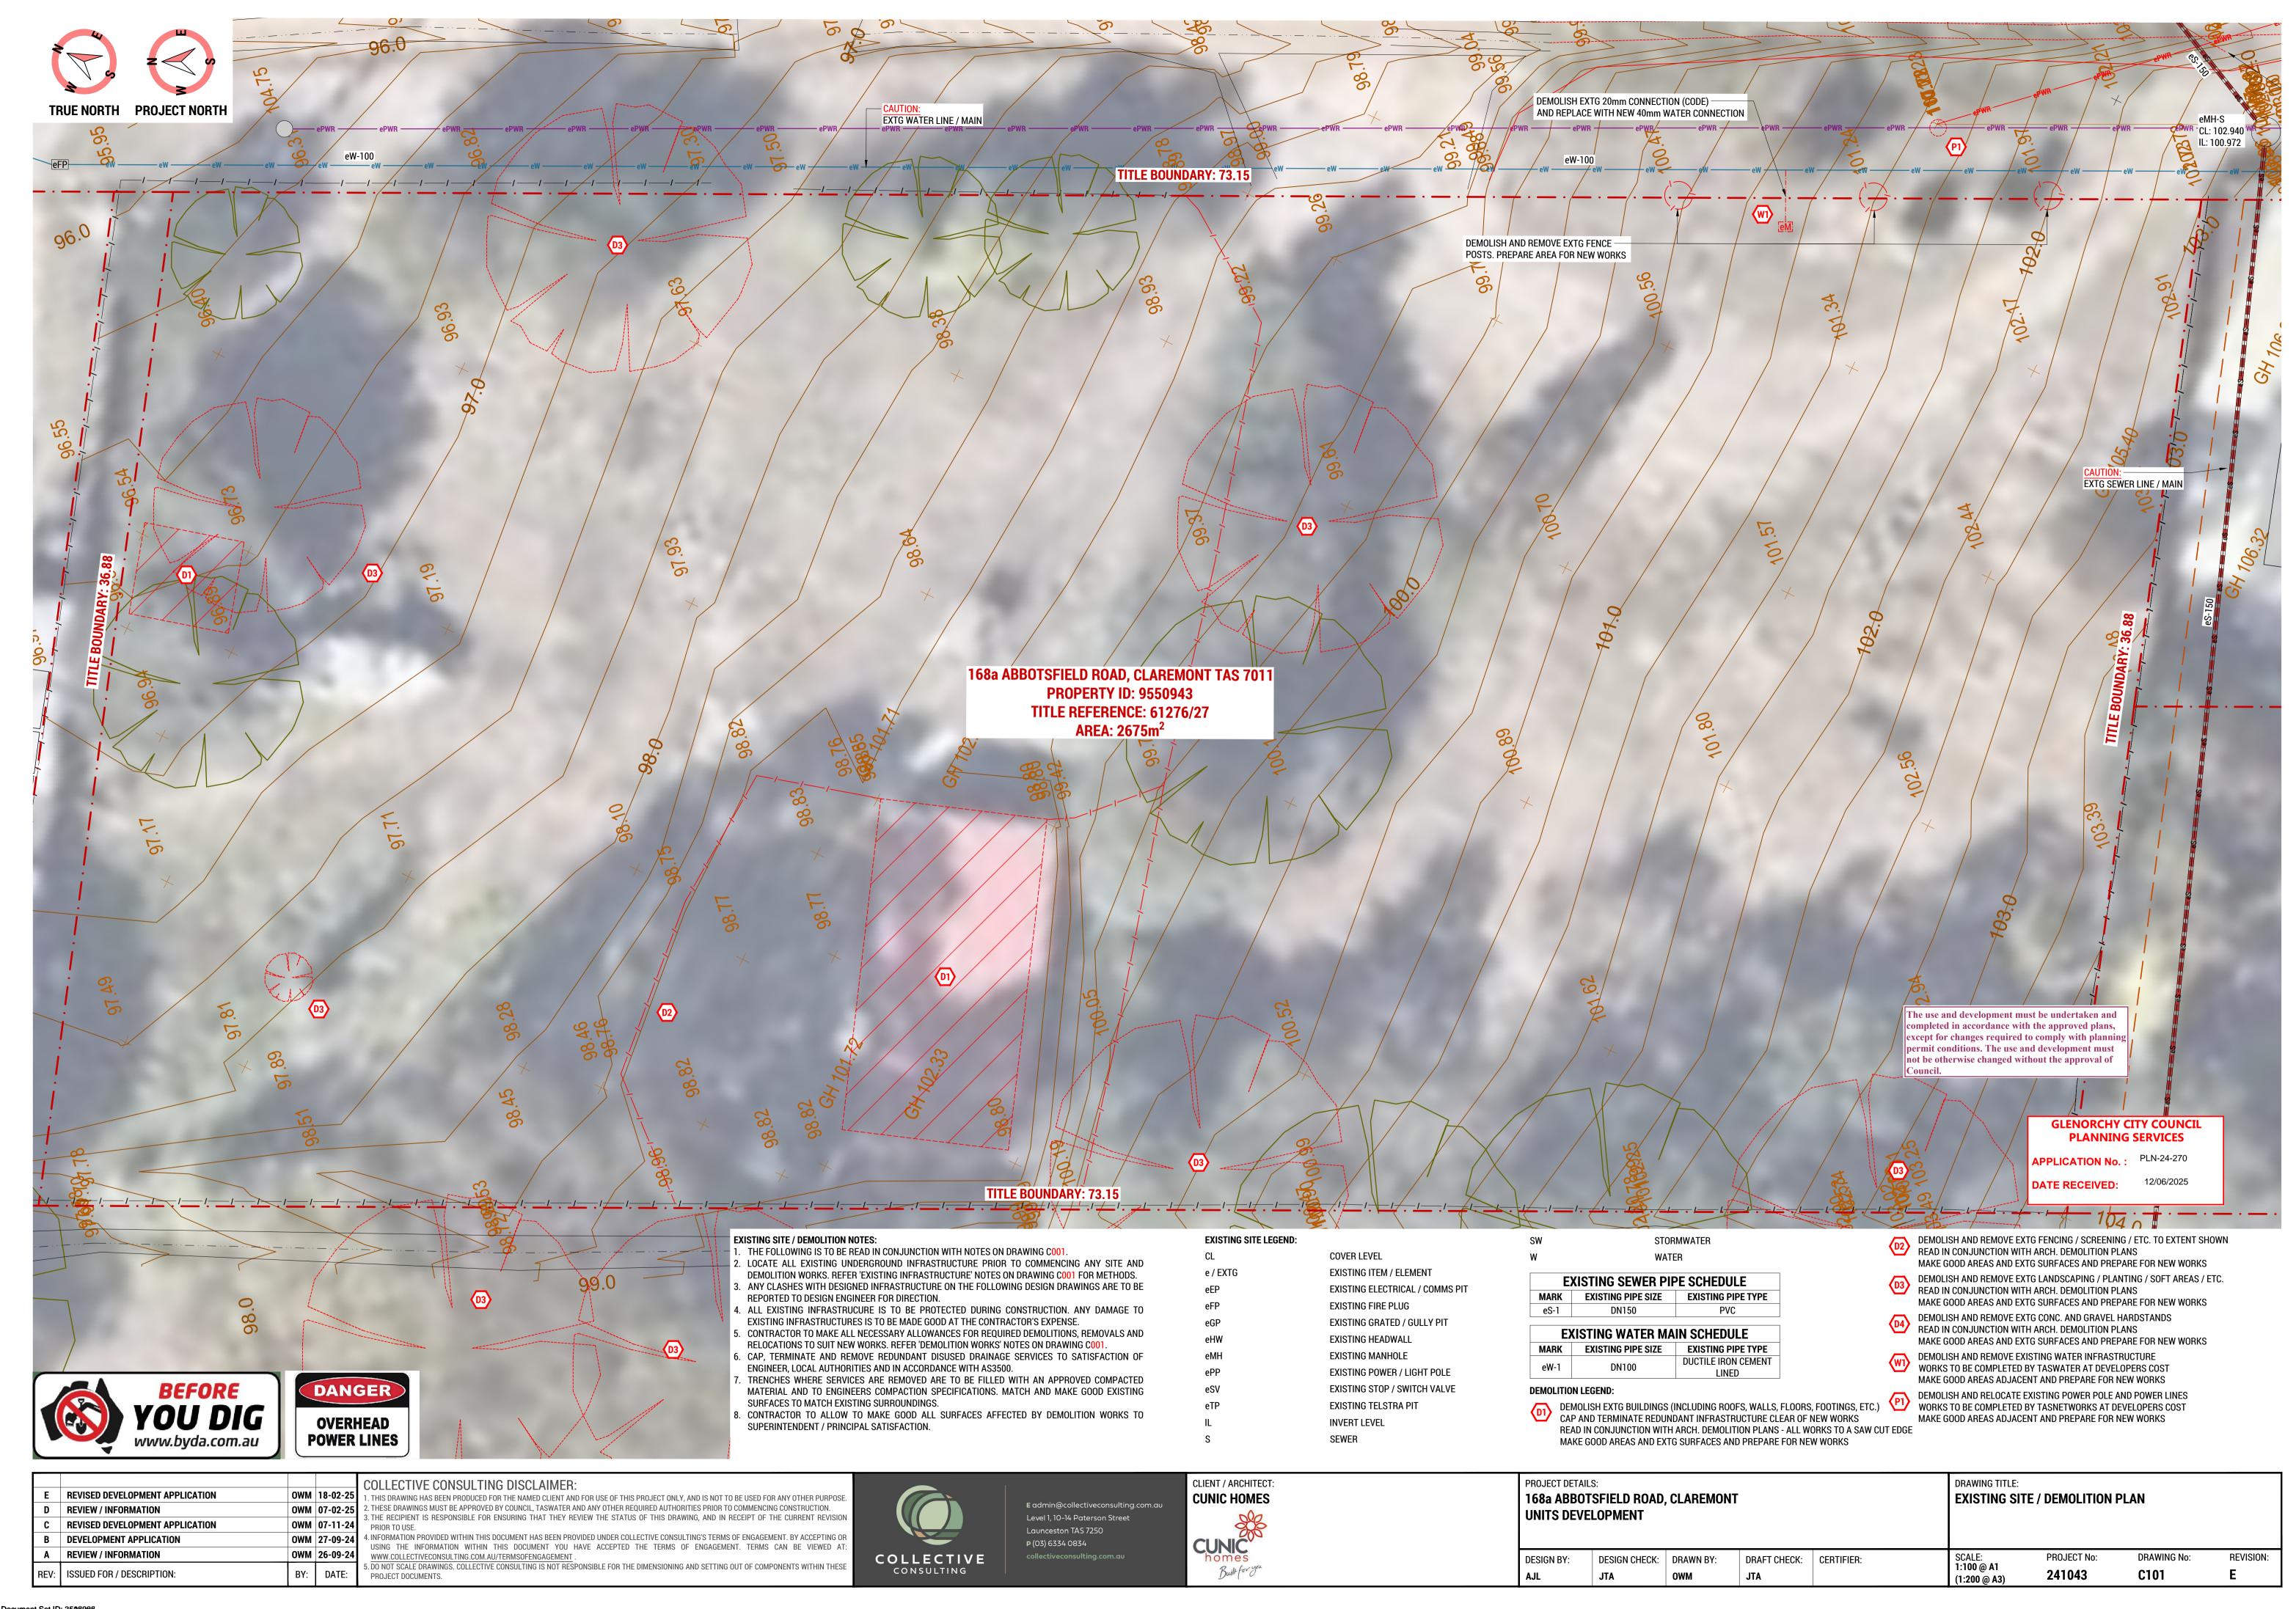


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SCALES: HORIZONTAL 1:200 VERTICAL 1:100

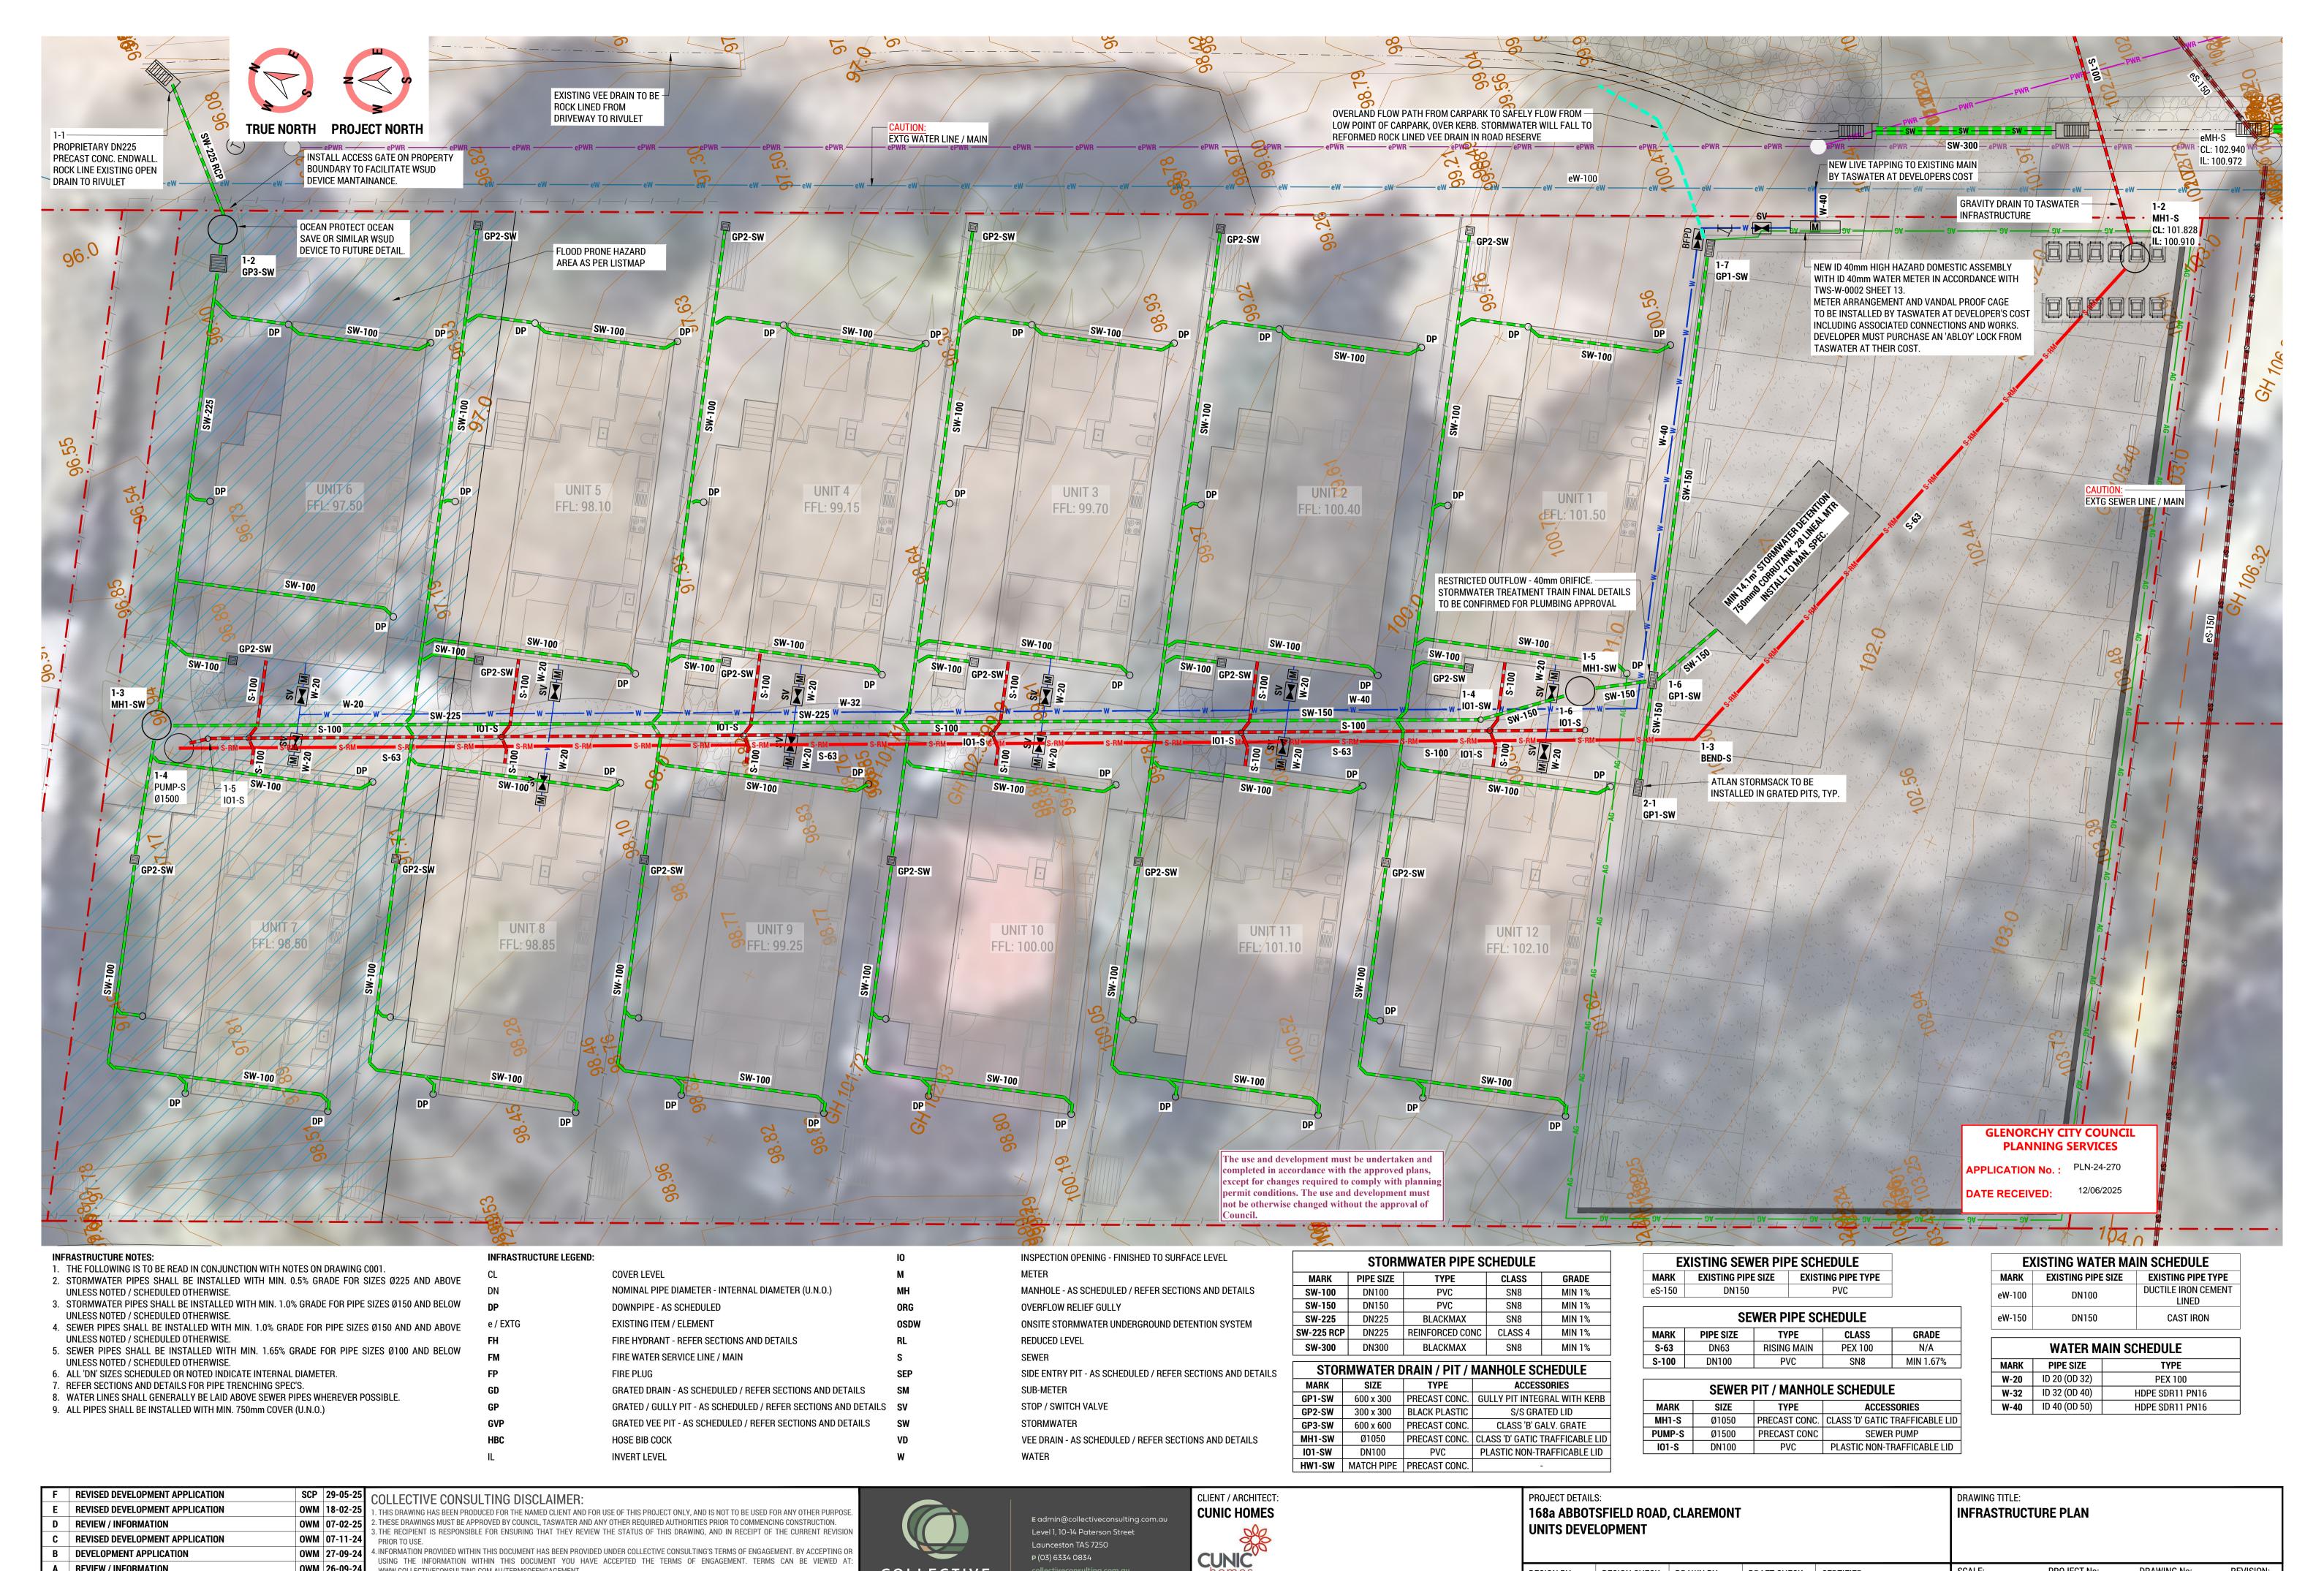

LONGITUNDINAL SECTION FOR LINE 1 SCALES: HORIZONTAL 1:200 VERTICAL 1:100
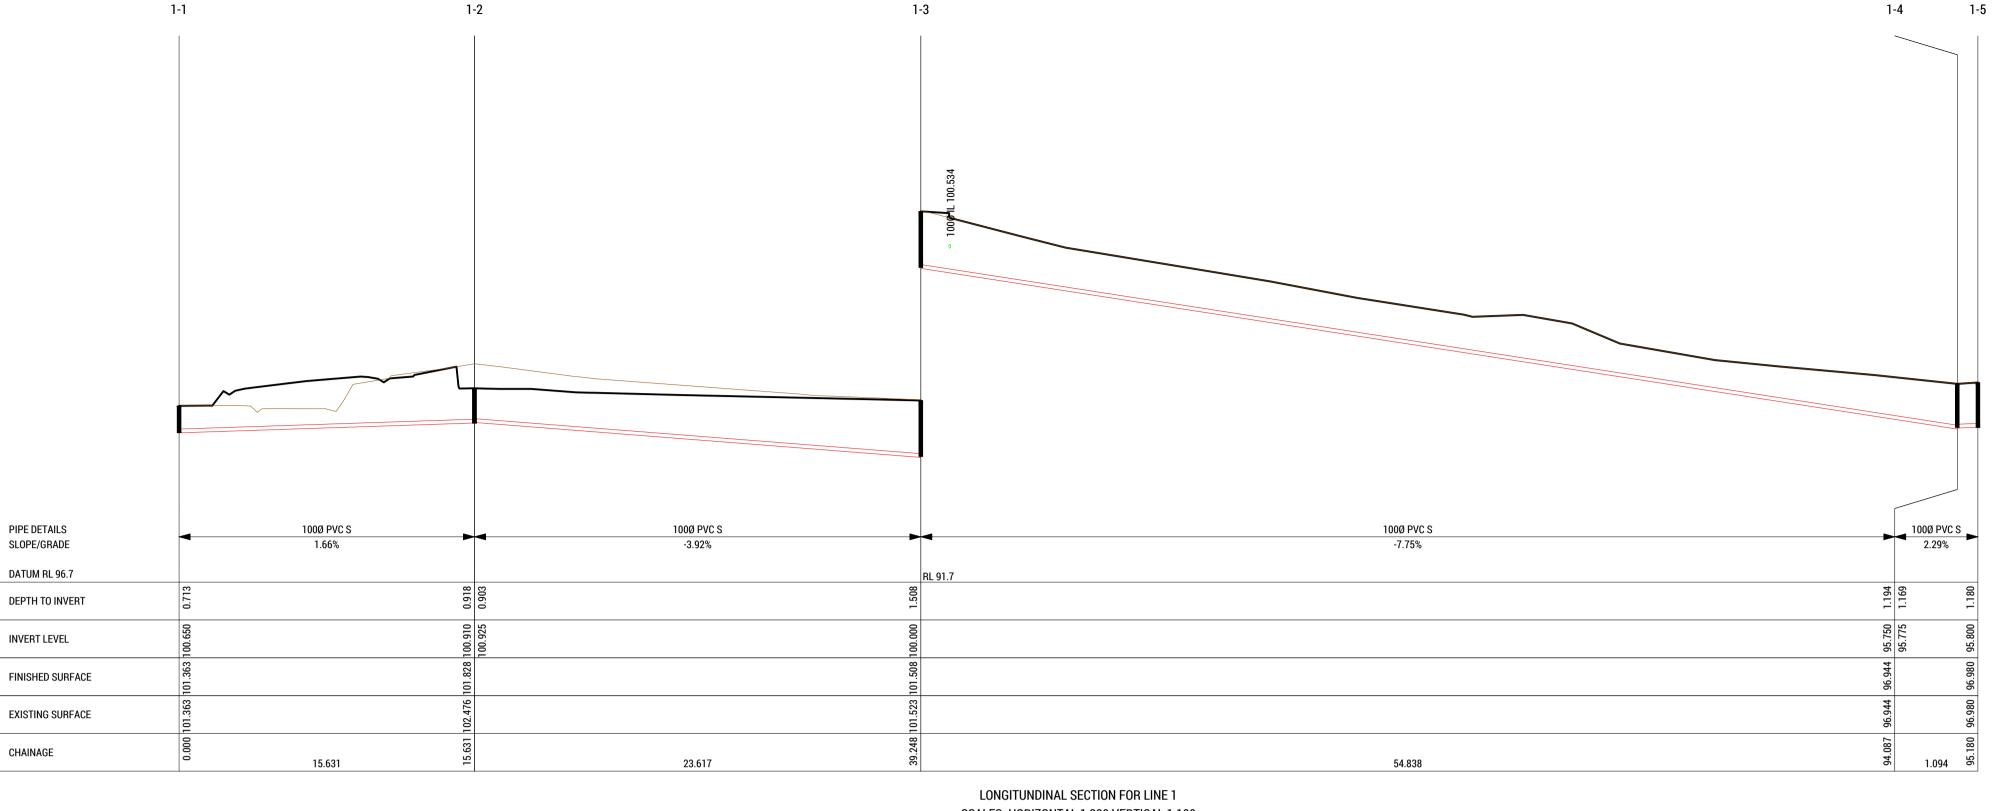
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GLENORCHY CITY COUNCIL PLANNING SERVICES APPLICATION No.: PLN-24-270 **DATE RECEIVED:** 12/06/2025

VARIES

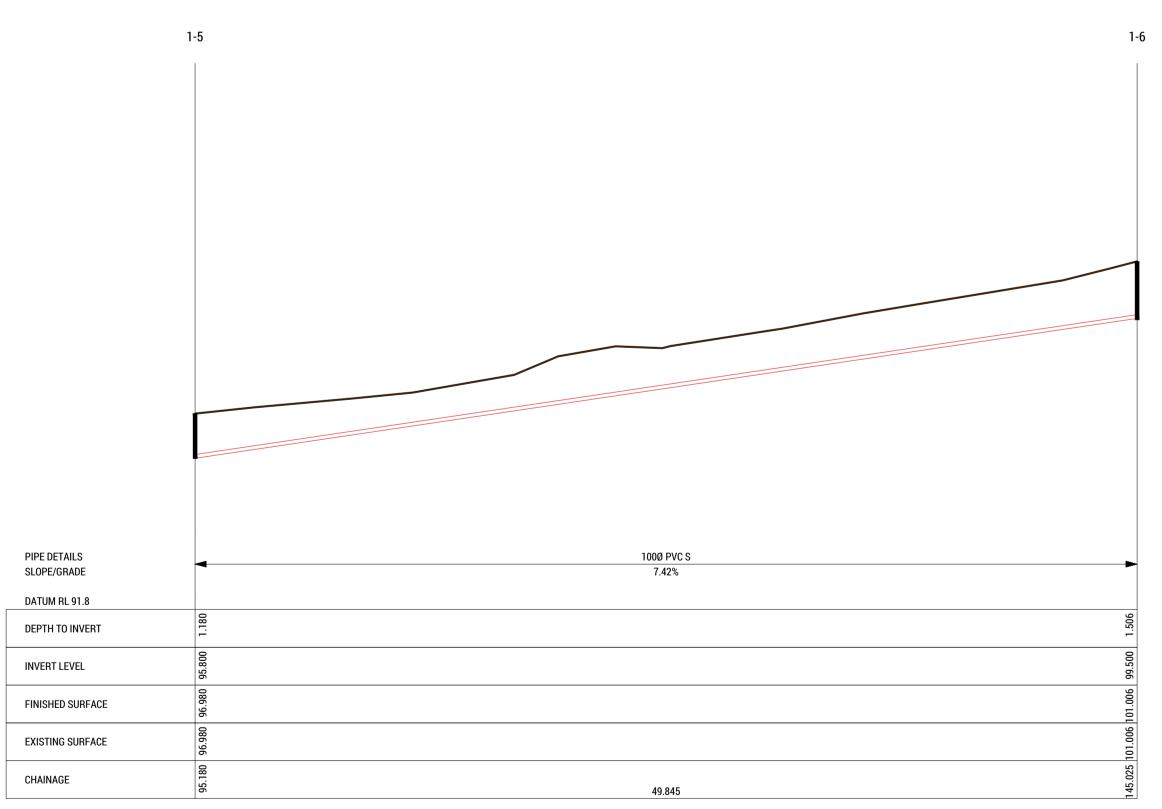DRAWING No:

C411

REVISION:

| В | REVISED DEVELOPMENT APPLICATION | OWM | 18-02-25 |
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| A | REVIEW / INFORMATION | OWM | 07-02-25 |
| REV: | ISSUED FOR / DESCRIPTION: | BY: | DATE: |

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COLLECTIVE CONSULTING

Launceston TAS 7250 **P** (03) 6334 0834

| CLIENT / ARCHITECT: CUNIC HOMES |
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| CUNIC |
| homes Built for you |

DRAWING TITLE: PROJECT DETAILS: 168a ABBOTSFIELD ROAD, CLAREMONT SEWER LONGITUDINAL SECTIONS UNITS DEVELOPMENT SCALE: PROJECT No: DESIGN CHECK: DRAWN BY: DRAFT CHECK: CERTIFIER: DESIGN BY: 241043


| B REVISED DEVELOPMENT APPLICATION OWM | 29-05-25 18-02-25 | COLLECTIVE CONSULTING DISCLAIMER: 1. THIS DRAWING HAS BEEN PRODUCED FOR THE NAMED CLIENT AND FOR USE OF THIS PROJECT ONLY, AND IS NOT TO BE USED FOR ANY OTHER PURPOSE. 2. THESE DRAWINGS MUST BE APPROVED BY COUNCIL, TASWATER AND ANY OTHER REQUIRED AUTHORITIES PRIOR TO COMMENCING CONSTRUCTION. 3. THE RECIPIENT IS RESPONSIBLE FOR ENSURING THAT THEY REVIEW THE STATUS OF THIS DRAWING, AND IN RECEIPT OF THE CURRENT REVISION PRIOR TO USE. 4. INFORMATION PROVIDED WITHIN THIS DOCUMENT HAS BEEN PROVIDED UNDER COLLECTIVE CONSULTING'S TERMS OF ENGAGEMENT. BY ACCEPTING OR USING THE INFORMATION WITHIN THIS DOCUMENT YOU HAVE ACCEPTED THE TERMS OF ENGAGEMENT. TERMS CAN BE VIEWED AT: | | E admin@collectiveconsulting.com.au Level 1, 10-14 Paterson Street Launceston TAS 7250 P (03) 6334 0834 | CUNIC HOMES | PROJECT DETA 168a ABBO UNITS DEV | OTSFIELD | - | CLAREMONT | | DRAWING TITLE: STORMWATER | LONGITUDINAL S | SECTIONS | |
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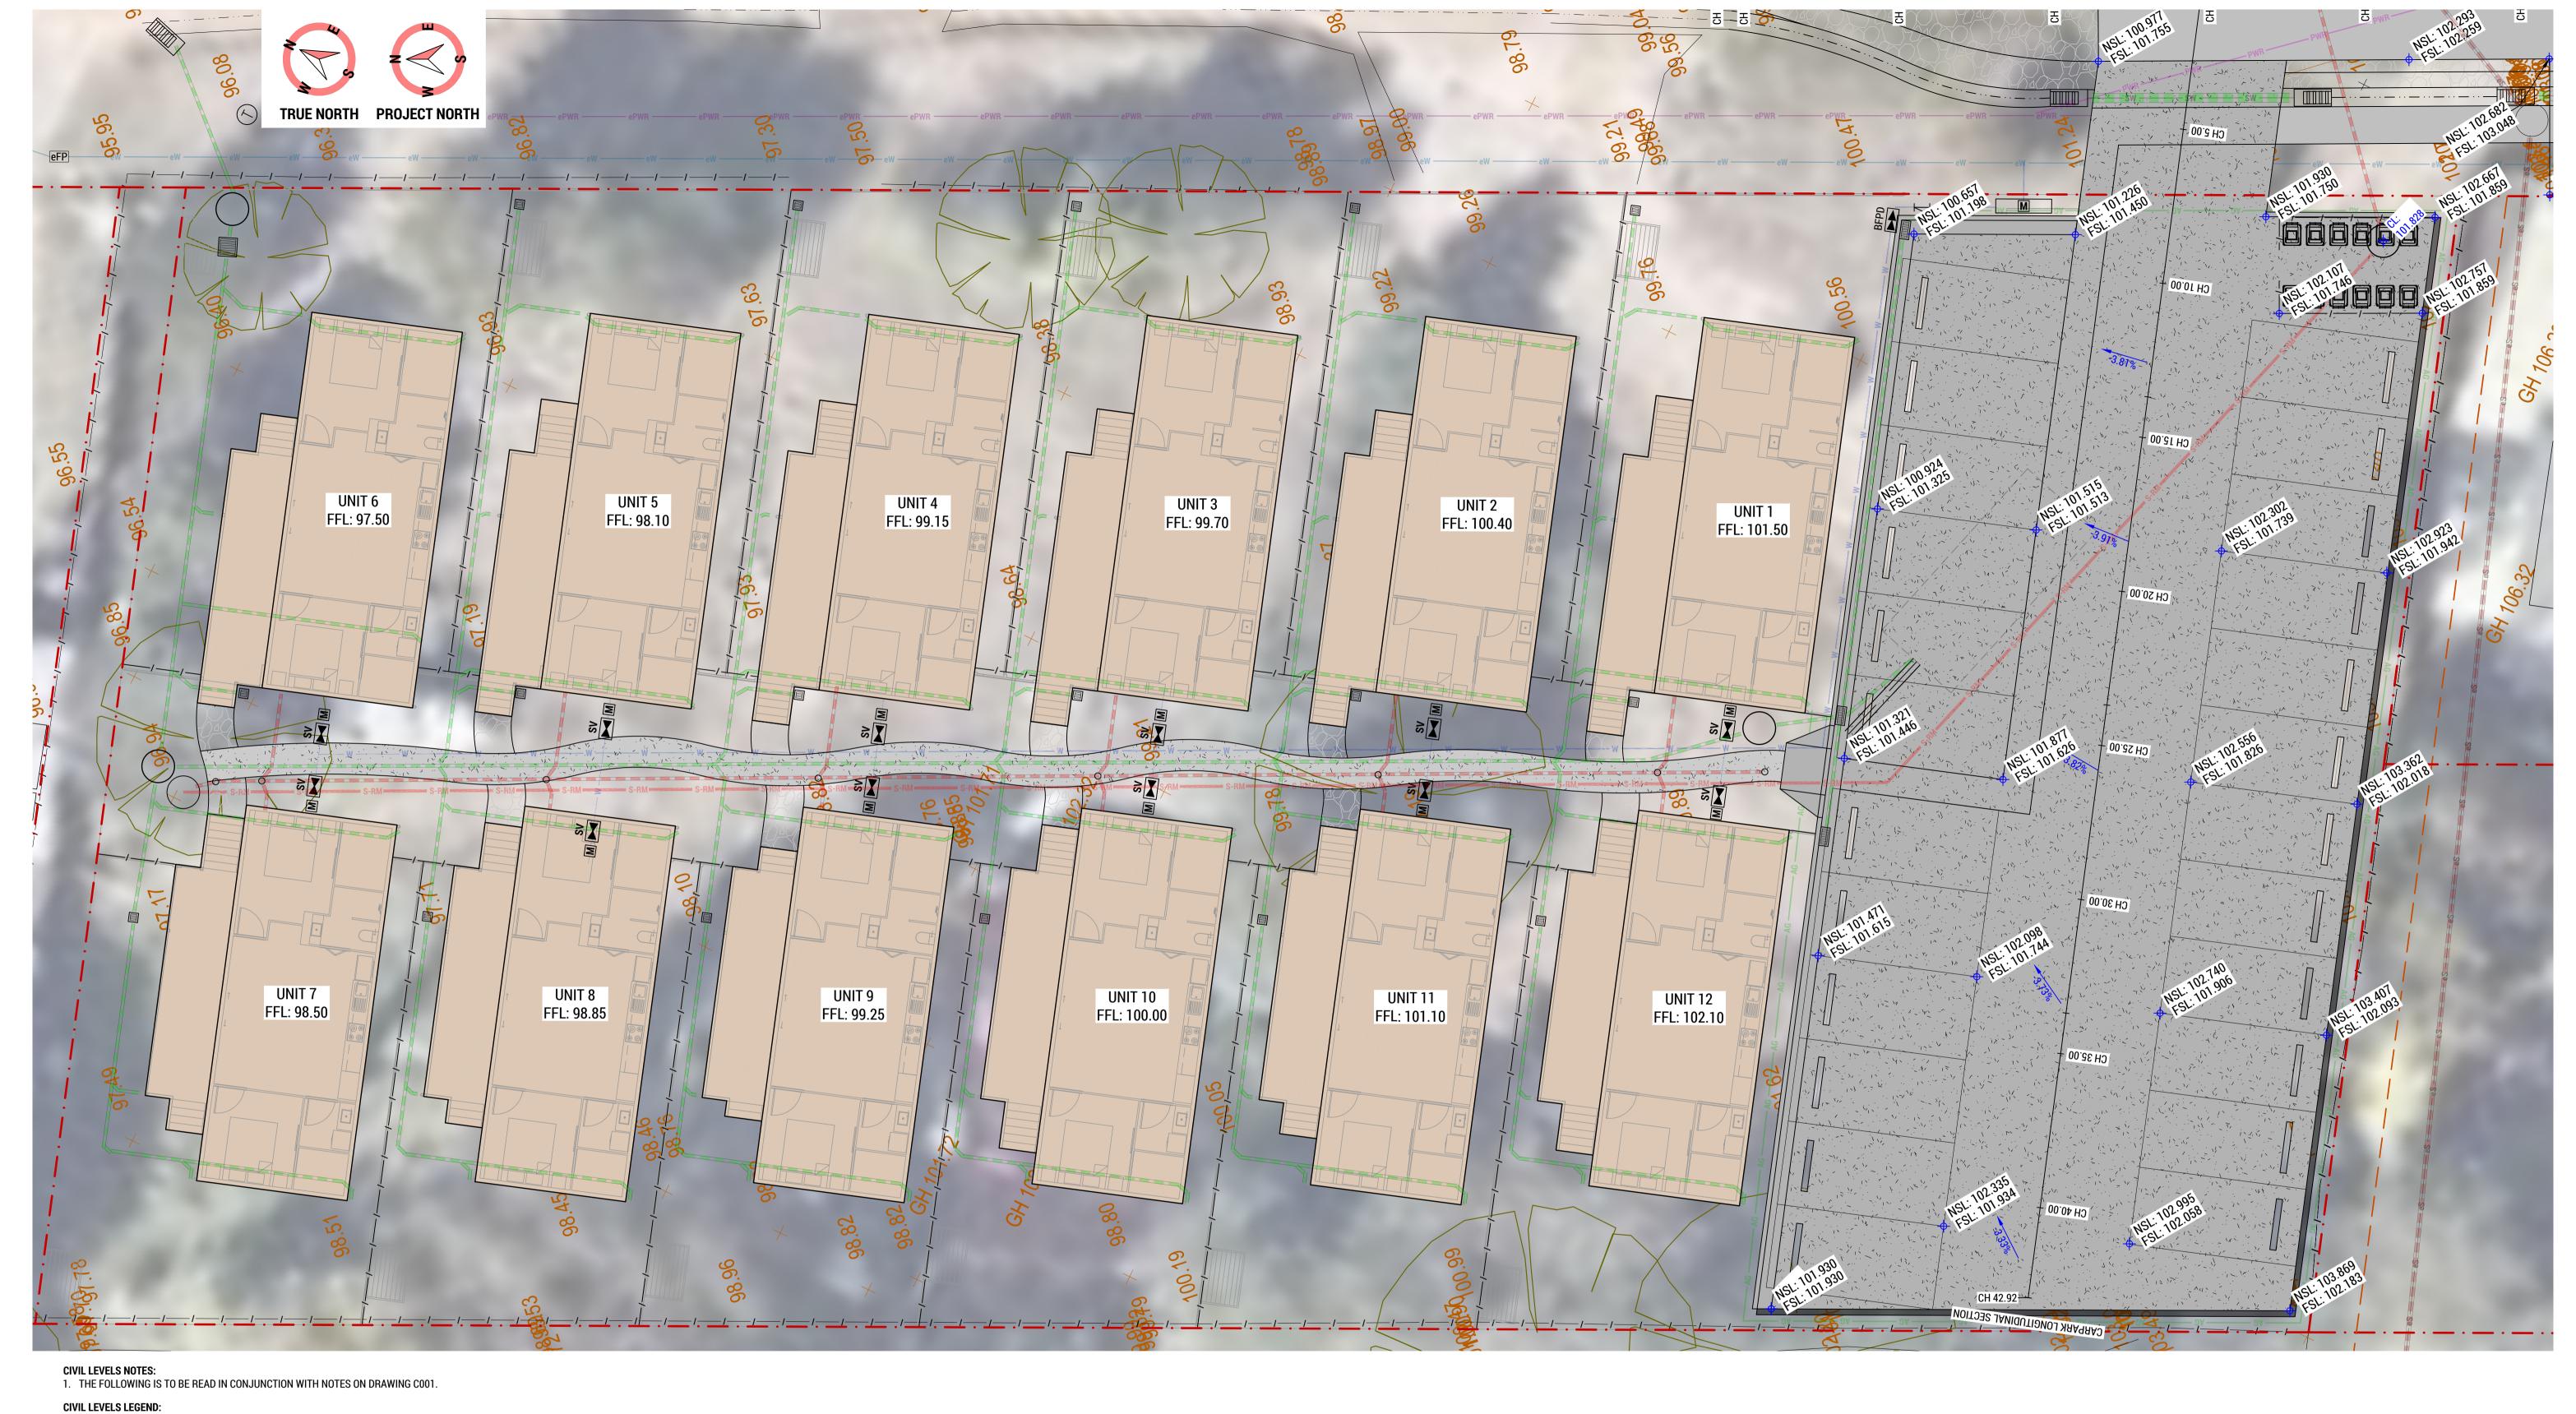
GLENORCHY CITY COUNCIL PLANNING SERVICES APPLICATION No.: PLN-24-270 **DATE RECEIVED:** 12/06/2025

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COVER LEVEL

e / EXTG

EXISTING ITEM / ELEMENT FINISHED FLOOR LEVEL FINISHED SURFACE LEVEL INVERT LEVEL NATURAL SURFACE LEVEL

SURFACE LEVEL TOP OF KERB TOP OF WALL

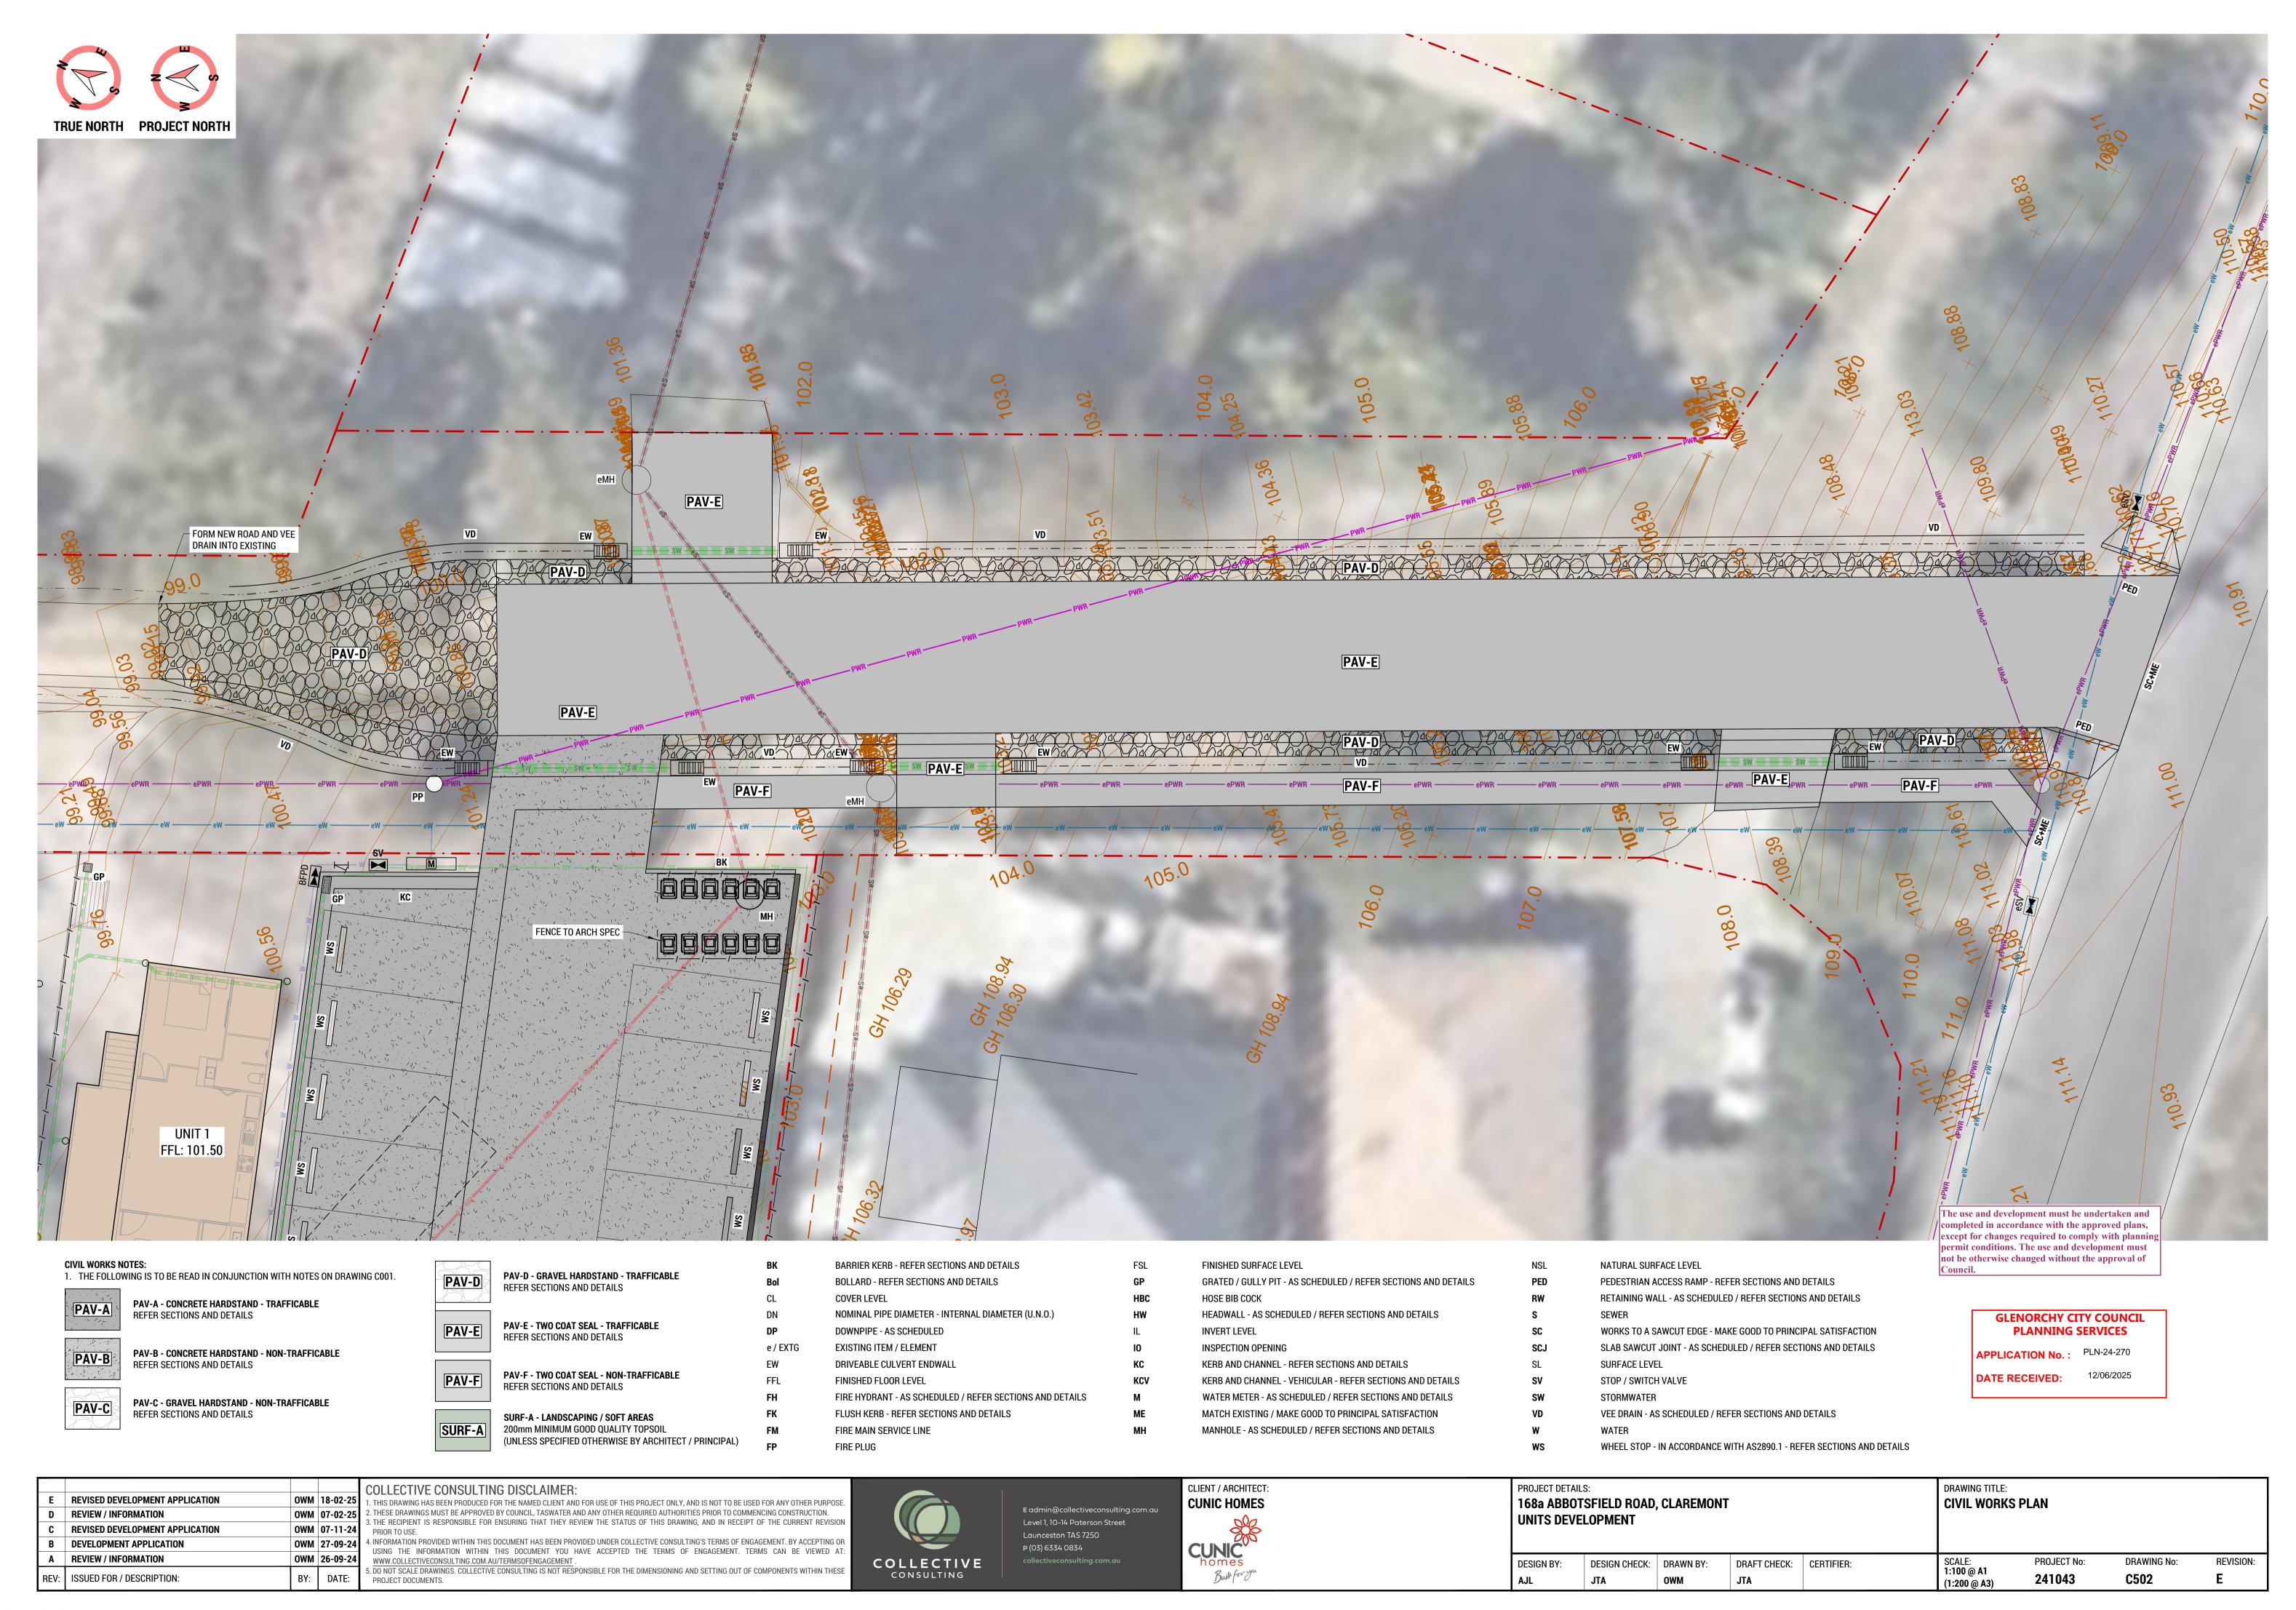EXISTING SURFACE LEVEL MARKER AND HEIGHT / RL PROPOSED SURFACE LEVEL MARKER AND HEIGHT / RL

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GLENORCHY CITY COUNCIL PLANNING SERVICES APPLICATION No.: PLN-24-270 **DATE RECEIVED:** 12/06/2025

| С | REVISED DEVELOPMENT APPLICATION | SCP | 29-05-2 |
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| В | REVISED DEVELOPMENT APPLICATION | OWM | 18-02-2 |
| Α | REVIEW / INFORMATION | OWM | 07-02-2 |
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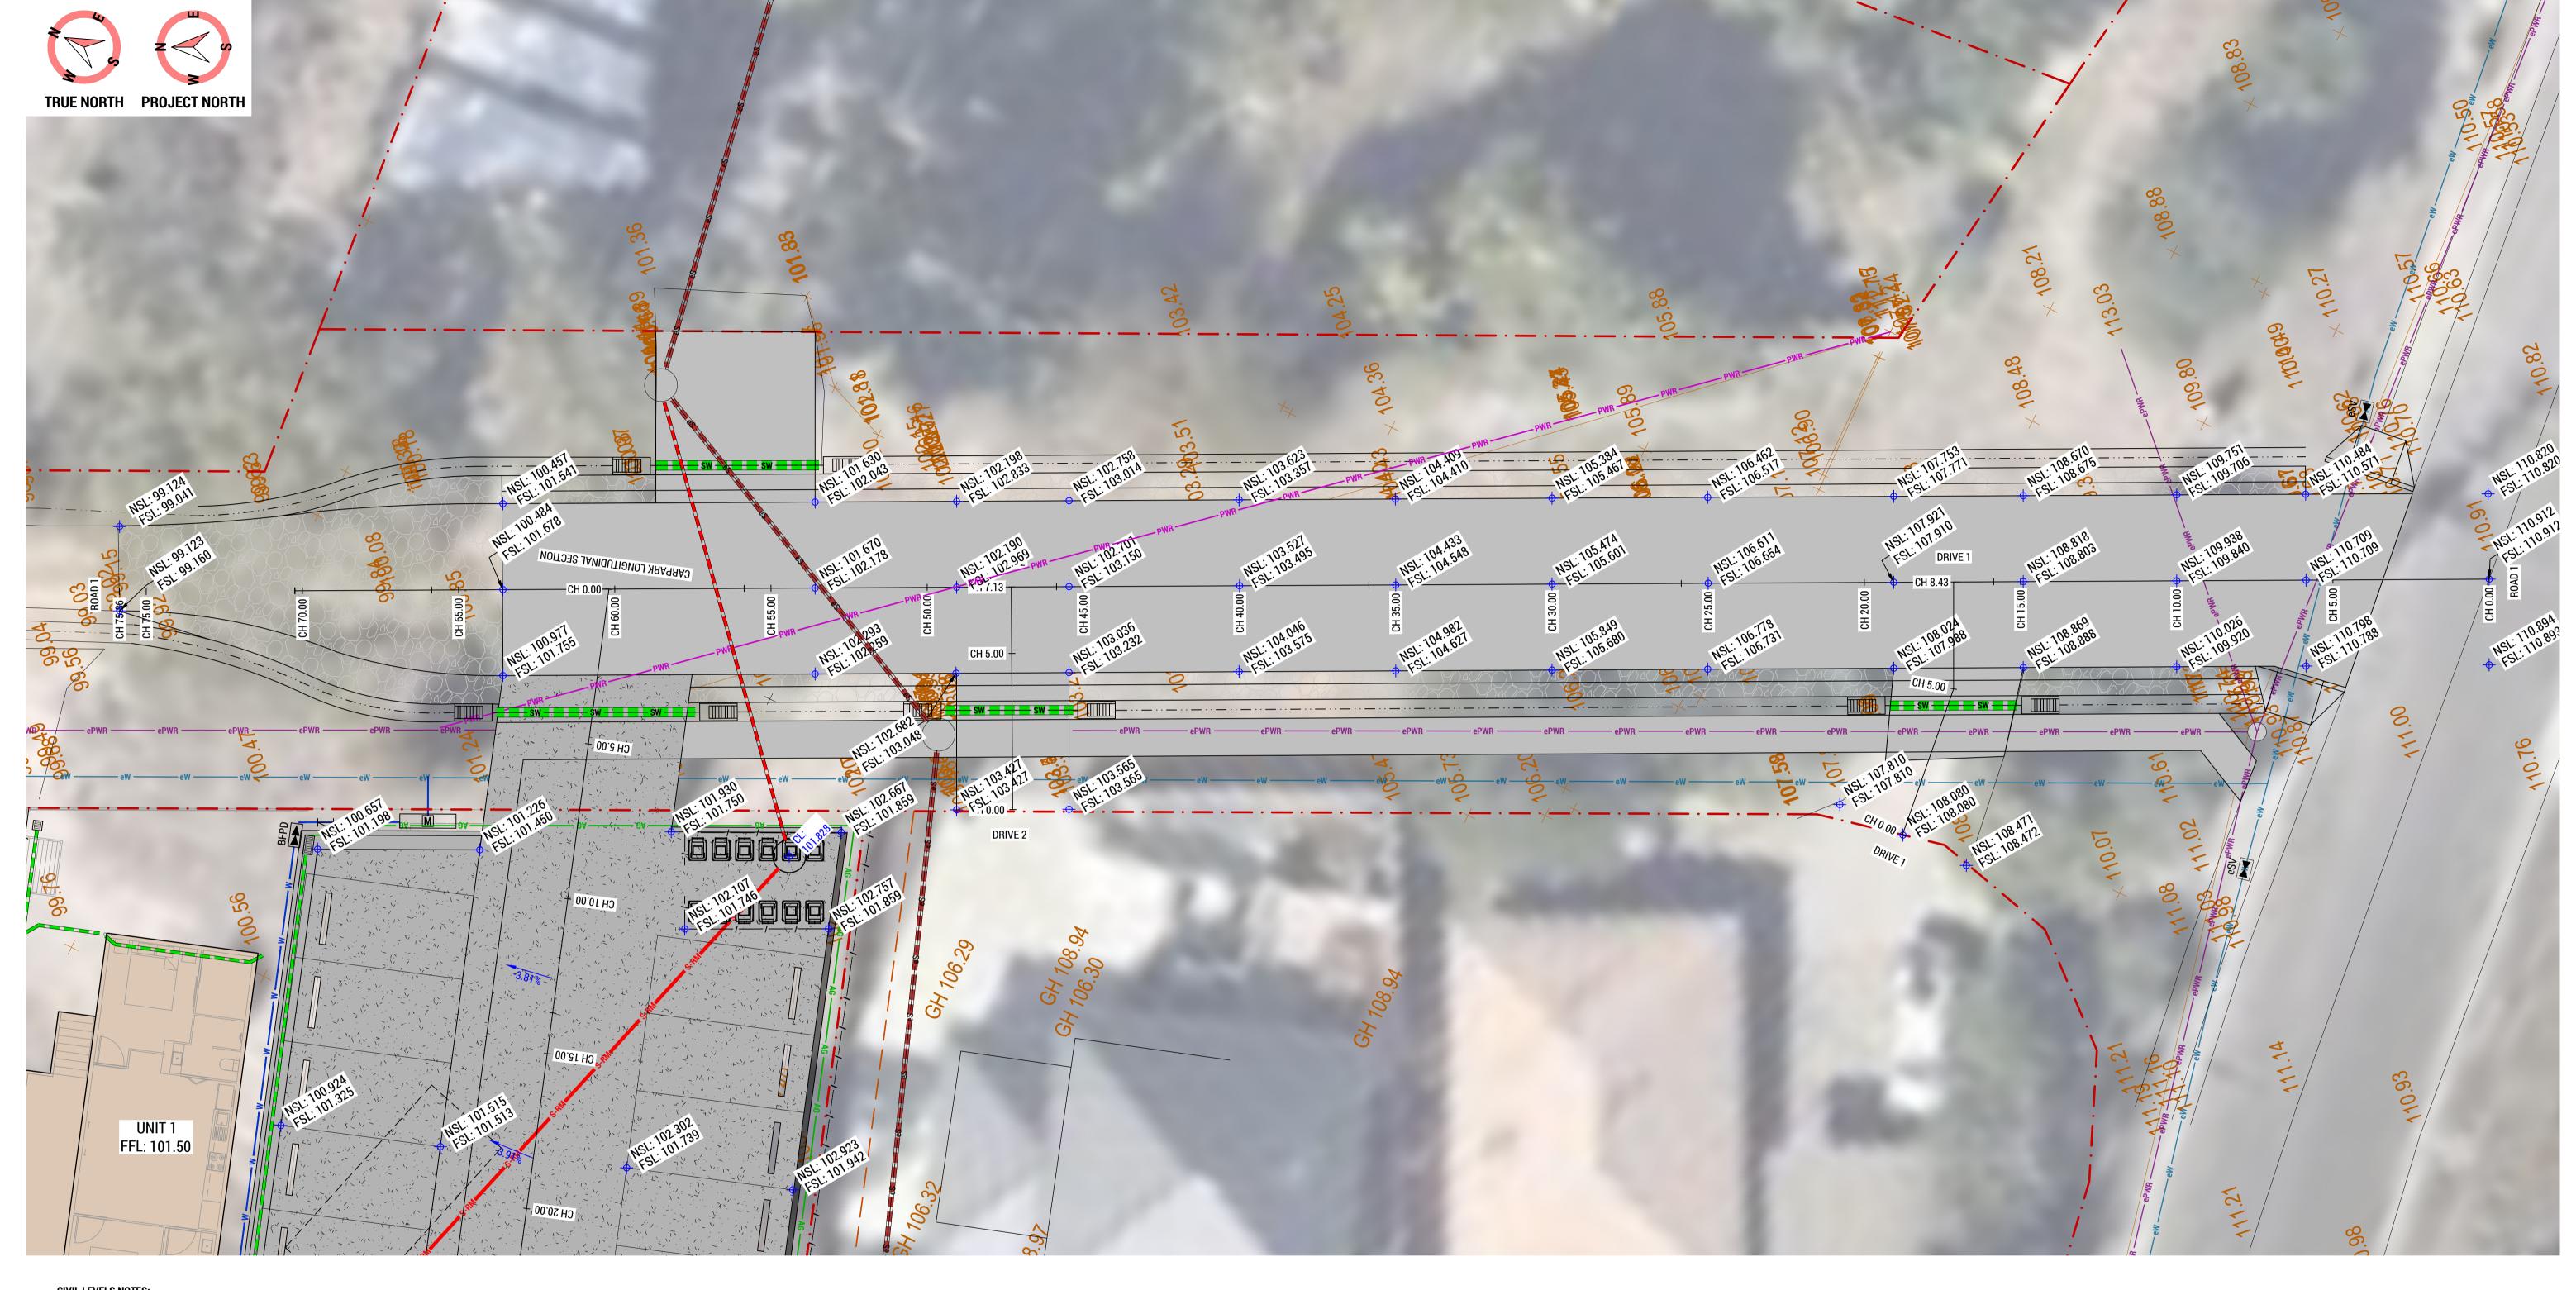
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Launceston TAS 7250 **P** (03) 6334 0834

| CLIENT / ARCHITECT: |
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| CUNIC HOMES |
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| 26 |
| CUNIC |
| homes |
| Built for you |

| PROJECT DETAIL 168a ABBOT UNITS DEVE | SFIELD ROAD, | , CLAREMON | Γ | | DRAWING TITLE: CIVIL LEVELS | S PLAN | | |
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| DESIGN BY: | DESIGN CHECK: | DRAWN BY: | DRAFT CHECK: | CERTIFIER: | SCALE: | PROJECT No: | DRAWING No: | REVISION: |
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CIVIL LEVELS NOTES:

1. THE FOLLOWING IS TO BE READ IN CONJUNCTION WITH NOTES ON DRAWING COO1.

CIVIL LEVELS LEGEND: COVER LEVEL EXISTING ITEM / ELEMENT e / EXTG FINISHED FLOOR LEVEL FINISHED SURFACE LEVEL INVERT LEVEL NATURAL SURFACE LEVEL SURFACE LEVEL TOP OF KERB

TOW TOP OF WALL EXISTING SURFACE LEVEL MARKER AND HEIGHT / RL PROPOSED SURFACE LEVEL MARKER AND HEIGHT / RL

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GLENORCHY CITY COUNCIL PLANNING SERVICES APPLICATION No.: PLN-24-270 **DATE RECEIVED:** 12/06/2025

| С | REVISED DEVELOPMENT APPLICATION | SCP | 29-05 |
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| В | REVISED DEVELOPMENT APPLICATION | OWM | 18-02- |
| Α | REVIEW / INFORMATION | OWM | 07-02 |
| REV: | ISSUED FOR / DESCRIPTION: | BY: | DATE |

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CLIENT / ARCHITECT: **CUNIC HOMES** Level 1, 10-14 Paterson Street Launceston TAS 7250 **P** (03) 6334 0834

| PROJECT DETAILS 168a ABBOT UNITS DEVE | SFIELD ROAD, | CLAREMONT | | | DRAWING TITLE: CIVIL LEVELS F | PLAN | | |
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| Existing 9/28 001 00/25: Levels 101 | 101.446 | 101.582 | 101.752 | 101 985 | 102.143 | 102.339 | | 102.474 | 102.636 | 102.767 | Existing 80.80. | 108.355 | 108.367 | 108.363 | | Existing Levels | 103.186 | 102.803 | 102.433 |
| Chainage 0000 2.776 | 5.000 | 8.128 | 15.000 | 00 | 25.000 | 30.000 | | 35.000 | 40.000 | 42.921 | Chainage 0000 | 2.931 | 4.151 | 8.430 | | Chainage | 0.000 | 4.376 | 7.126 |
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LONGITUDINAL SECTION Scales: H 1:100 V 1:100


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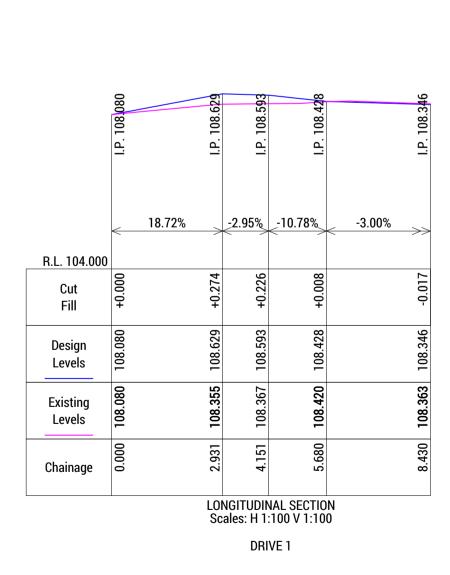
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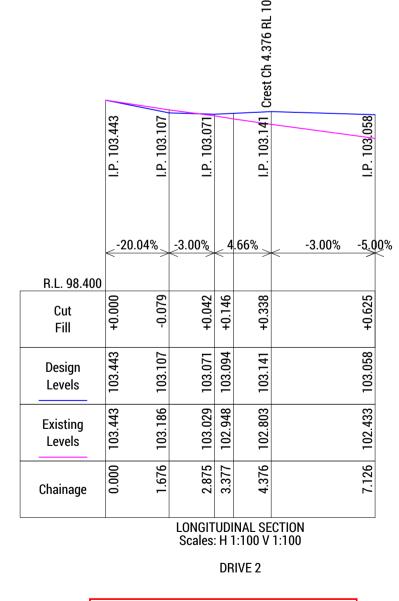
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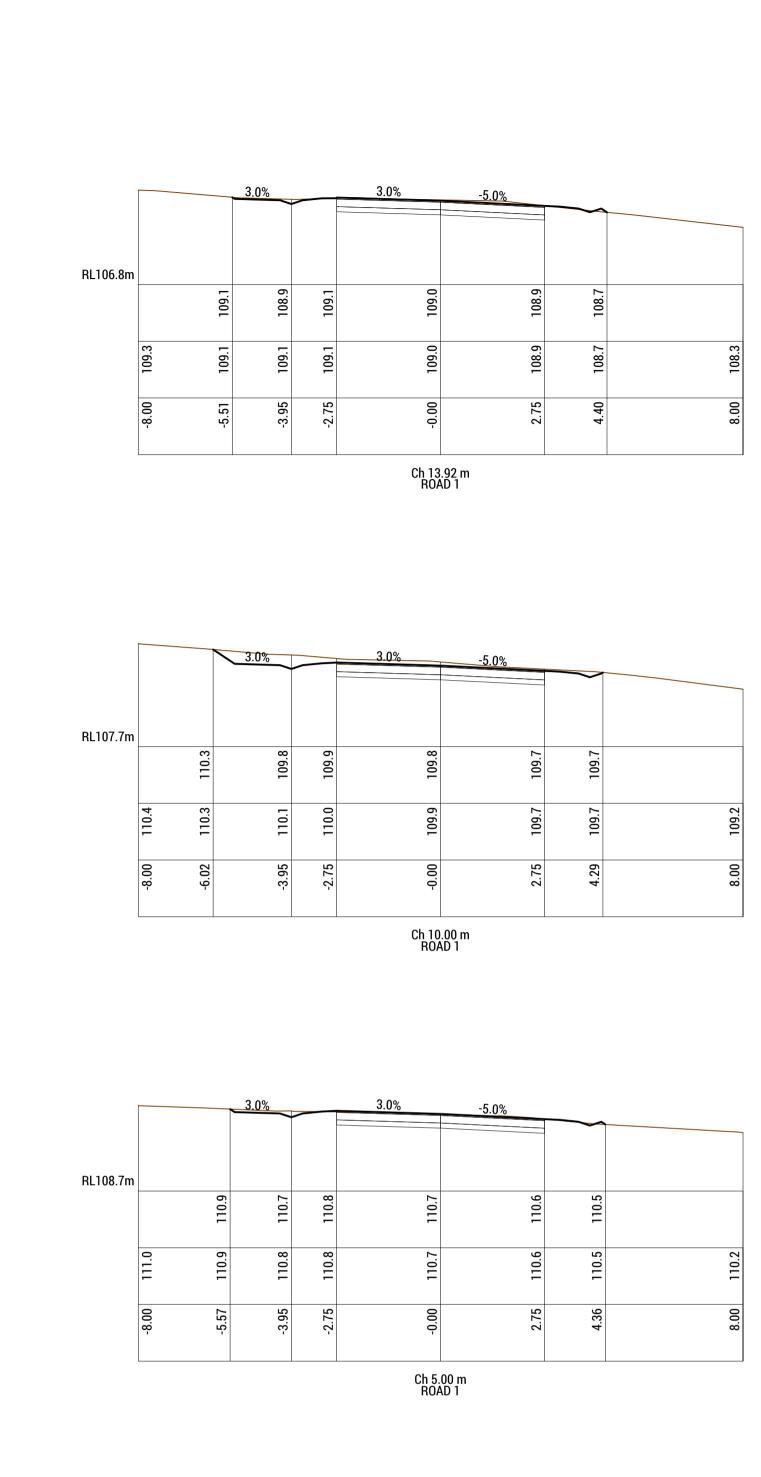
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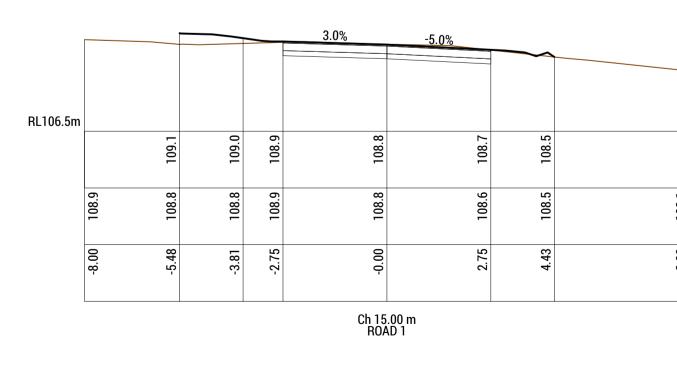
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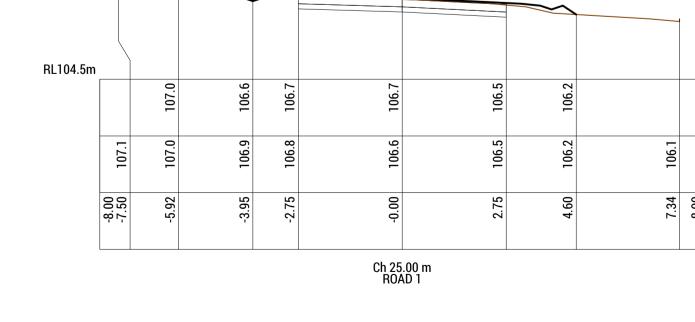
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GLENORCHY CITY COUNCIL PLANNING SERVICES APPLICATION No.: PLN-24-270

DATE RECEIVED: 12/06/2025

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| | | | | RU <i>P</i> | ועו | | |

| | | | | RL106.5m | |
|-------|----|--|-------|----------|-------|
| 110.9 | | | 110.6 | | 108.9 |
| -0.00 | | | 8.00 | | -8.00 |
| 01-0 | 00 | | | | |

| | | | | 3.0% | -5.0% | | |
|----------|----------|----------|-------|--------------|-------|-------|-------|
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| | | | | | | | |
| RL106.5m | | | | | | | |
| | 109.1 | 109.0 | 108.9 | 108.8 | 108.7 | 108.5 | |
| | _ = | _ | _ | = | 1 | | |
| | <u>ව</u> | <u>∞</u> | 6: | ∞ . | 9. | rci | - |
| | 108.9 | 108.8 | 108.9 | 108.8 | 108.6 | 108.5 | 108.1 |
| | | | | | | | |
| | -8.00 | -3.81 | -2.75 | -0.00 | 2.75 | 4.43 | 8.00 |
| | ထု ငှ | ကု | -2 | P | 2 | 4 | 8 |
| | | | | | | | |
| | | | | Ch 15 ROA | .00 m | | |
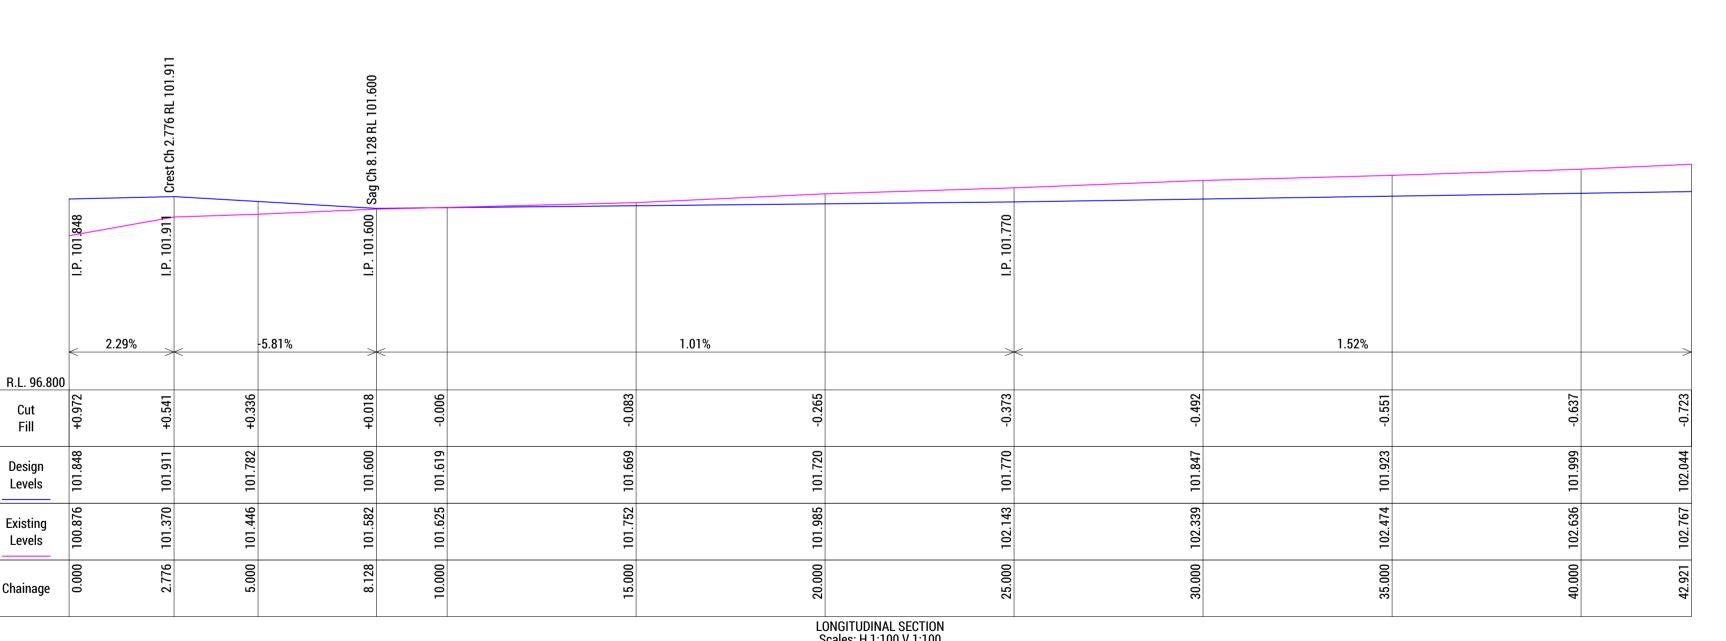
| | | | 3.0% | | 3.0% | -5.0% | | | |
|----------|----------------|-------|-------|-------|----------------------|---------------|--------|-------|------|
| | | | | | | | \sim | | 4 |
| RL104.5m | | | | | | | | | |
| | | 107.0 | 106.6 | 106.7 | 106.7 | 106.5 | 106.2 | | |
| | 107.1 | 107.0 | 106.9 | 106.8 | 106.6 | 106.5 | 106.2 | 106.1 | |
| | -8.00 -7.50 | -5.92 | -3.95 | -2.75 | -0.00 | 2.75 | 4.60 | 7.34 | 8.00 |
| | | | 1 | | Ch 25 RO <i>A</i> | .00 m AD 1 | I | | 1 |

| С | REVISED DEVELOPMENT APPLICATION | SCP | 29-05- |
|------|---------------------------------|-----|--------|
| В | REVISED DEVELOPMENT APPLICATION | OWM | 18-02- |
| Α | REVIEW / INFORMATION | OWM | 07-02- |
| REV: | ISSUED FOR / DESCRIPTION: | BY: | DATE |

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| PRIOR TO USE. |


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| | E admin@collectiveconsulting.com.o Level 1, 10-14 Paterson Street Launceston TAS 7250 P (03) 6334 0834 |
|--------------------------|---|
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| | |

| CLIENT / ARCHITE |
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| CUNIC HOME |
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| CUNIC |
| Built for you |
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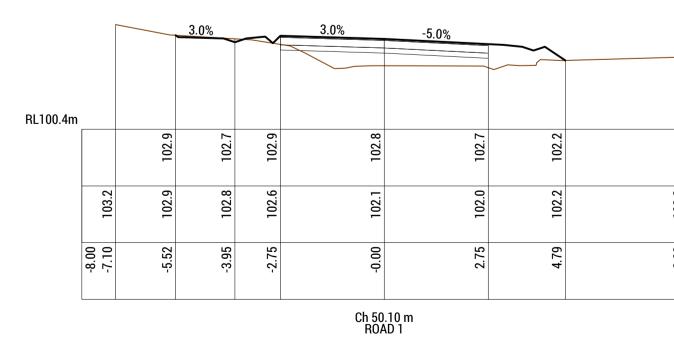
| PROJECT DETAILS 168a ABBOT UNITS DEVE | SFIELD ROAD, | , CLAREMONT | • | | DRAWING TITLE LONGITUDI | : NAL & CROSS SECT | TIONS - SHEET 2 | |
|---------------------------------------|---------------|-------------|--------------|------------|-------------------------|-----------------------|-----------------|-----------|
| DESIGN BY: | DESIGN CHECK: | DRAWN BY: | DRAFT CHECK: | CERTIFIER: | SCALE: | PROJECT No: | DRAWING No: | REVISION: |
| AJL | JTA | OWM | JTA | | VARIES | 241043 | C522 | C |





CLIENT / ARCHITECT: **COLLECTIVE CONSULTING DISCLAIMER:** PROJECT DETAILS: DRAWING TITLE: **CUNIC HOMES** 168a ABBOTSFIELD ROAD, CLAREMONT LONGITUDINAL & CROSS SECTIONS - SHEET 3 1. THIS DRAWING HAS BEEN PRODUCED FOR THE NAMED CLIENT AND FOR USE OF THIS PROJECT ONLY, AND IS NOT TO BE USED FOR ANY OTHER PURPOSE. 2. THESE DRAWINGS MUST BE APPROVED BY COUNCIL, TASWATER AND ANY OTHER REQUIRED AUTHORITIES PRIOR TO COMMENCING CONSTRUCTION.


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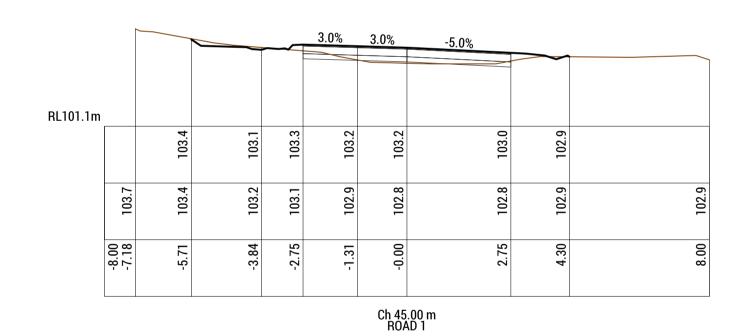
RL101.1m DESIGN **EXISTING** OFFSET

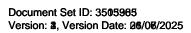





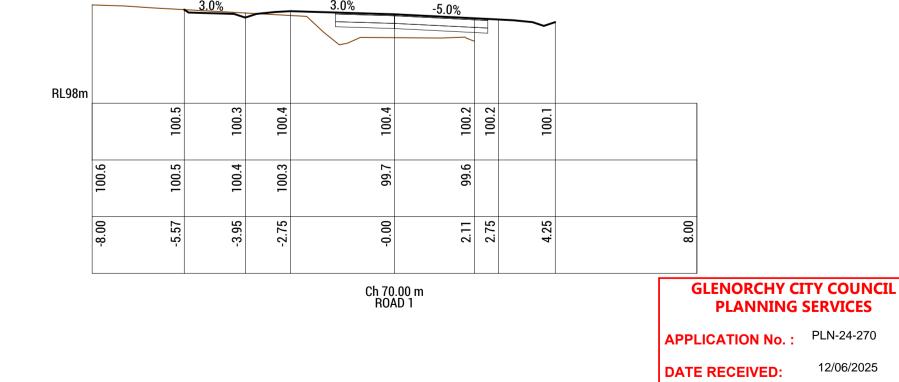

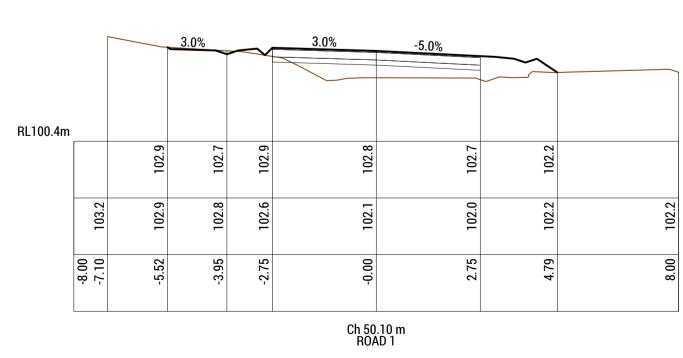

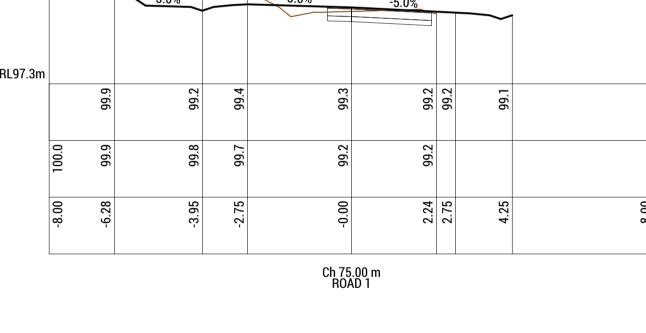


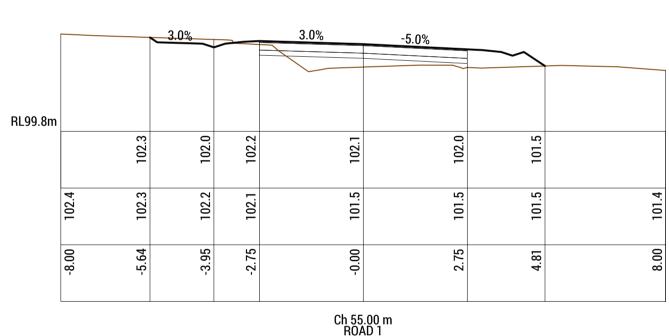


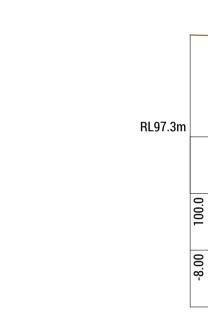






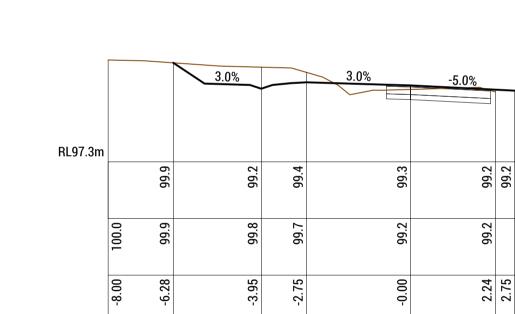


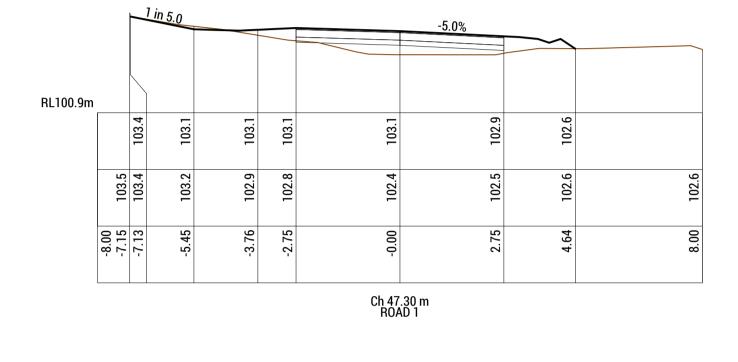


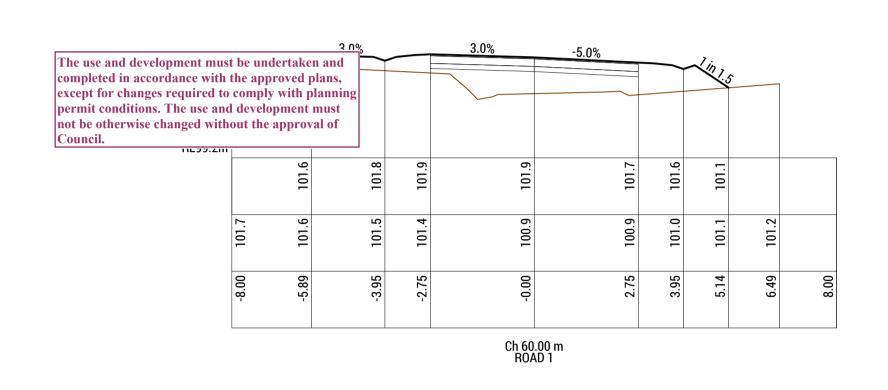



| | | 1/1.5 3.0 | 0% | | 3.0% | | |
|---------|-------|-----------|-------|-------|--------------|---------------|--------|
| RL97.1m | | 8. | 1.66 | 99.2 | 99.1 | | |
| | 6.99 | 8.66 | 99.7 | 99.4 | 99.1 | 99.1 | |
| | -8.00 | -6.40 | -3.95 | -2.75 | -0.00 | 2.28 | C « |
| | | | | · | Ch 75 ROA | .86 m AD 1 | |


| | | | | ~ | 3.0% | -5.0% | | |
|----------|-------|-------|-------|-------|----------------------|---------------|-------|-------|
| RL100.4m | | | | | | | | |
| | | 102.9 | 102.7 | 102.9 | 102.8 | 102.7 | 102.2 | |
| | 103.2 | 102.9 | 102.8 | 102.6 | 102.1 | 102.0 | 102.2 | 102.2 |
| | -8.00 | -5.51 | -3.91 | -2.75 | -0.00 | 2.75 | 4.80 | 8.00 |
| | | | | | Ch 50 RO <i>l</i> | .00 m AD 1 | | |

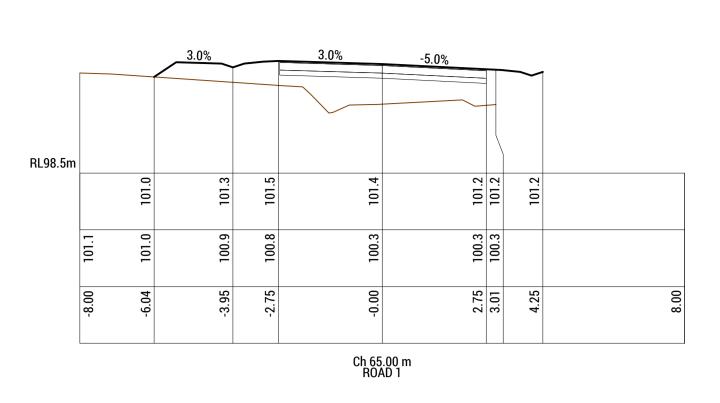


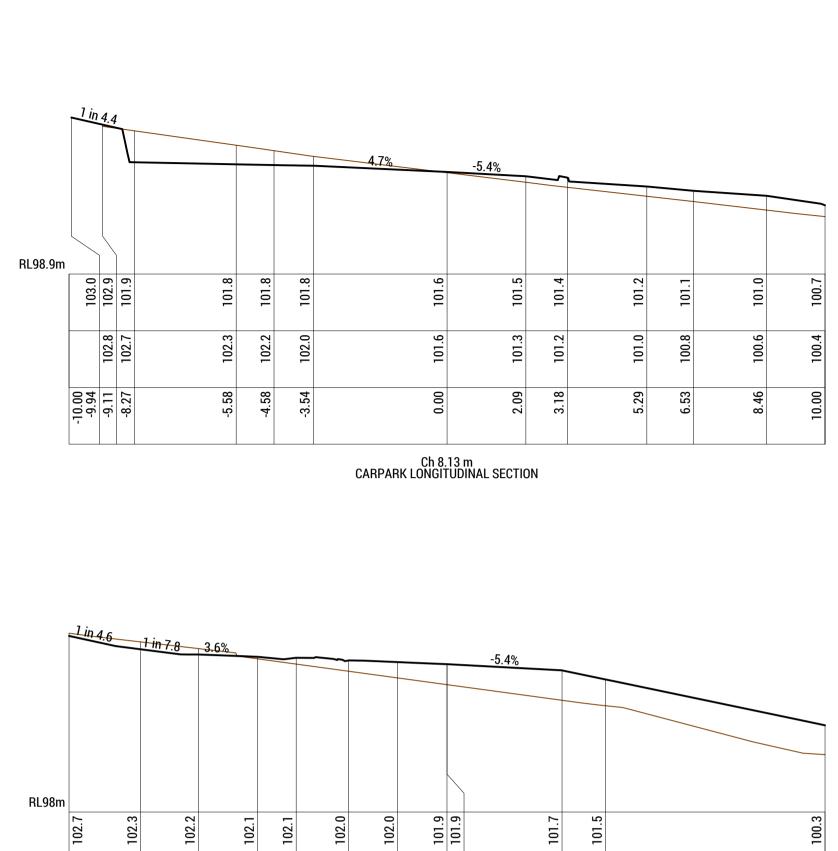


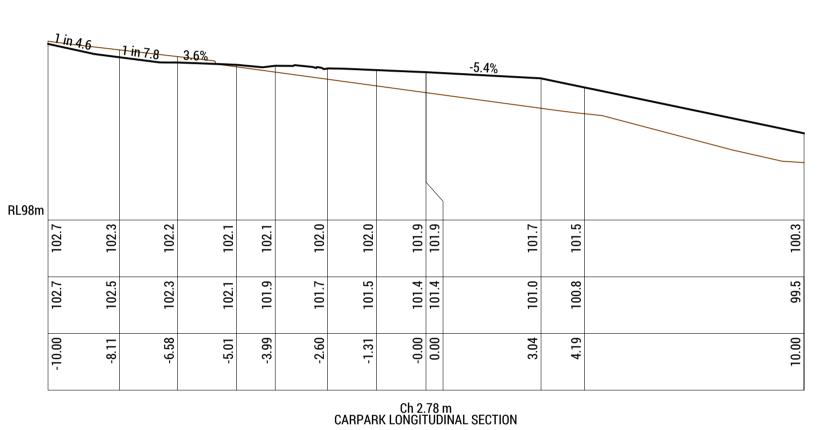


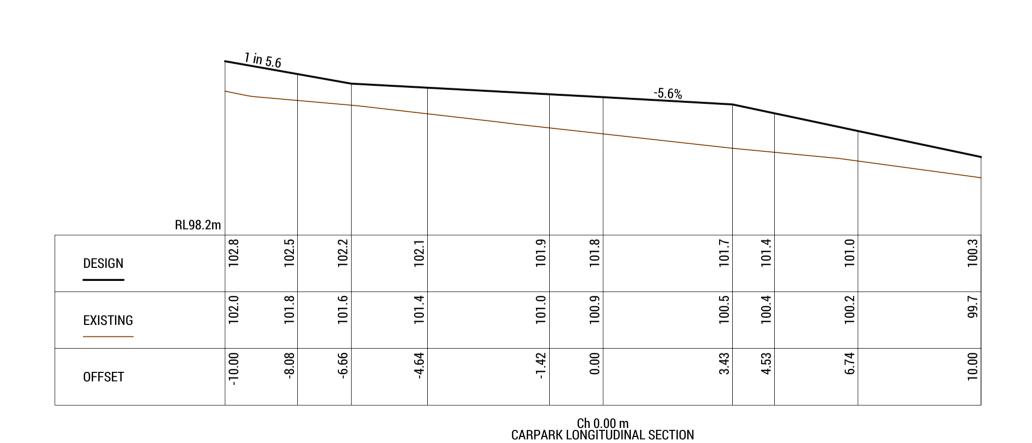


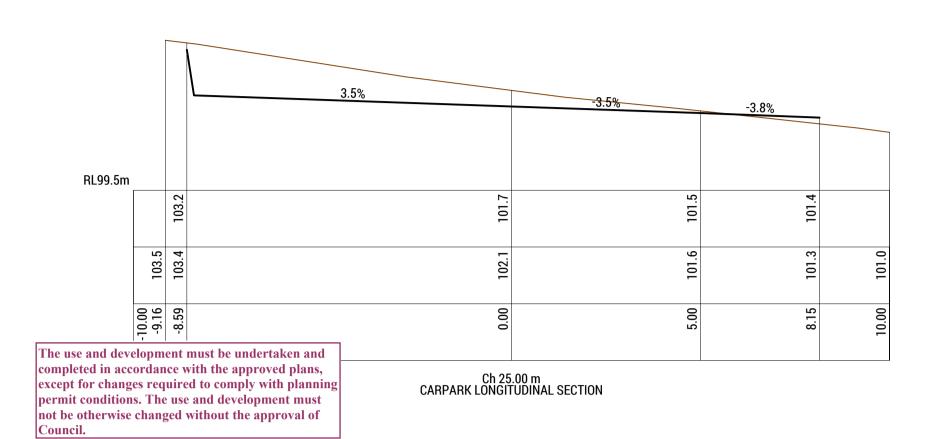


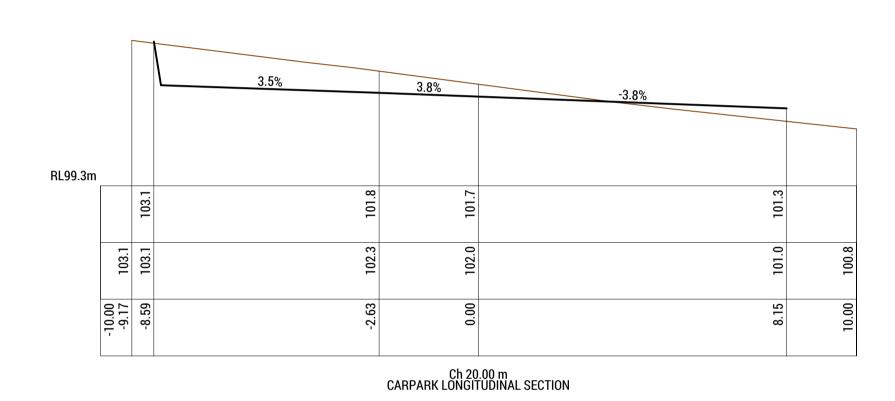

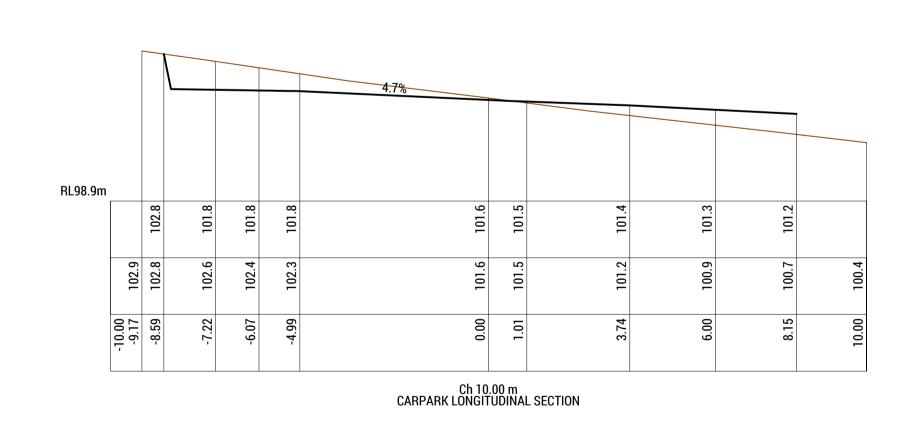

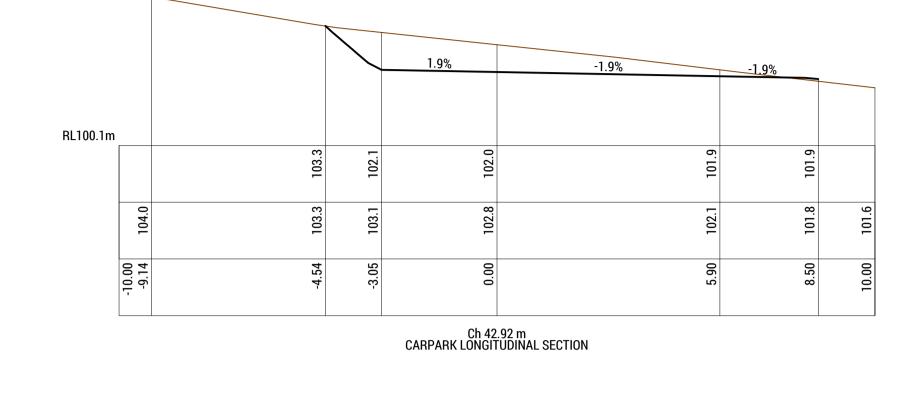

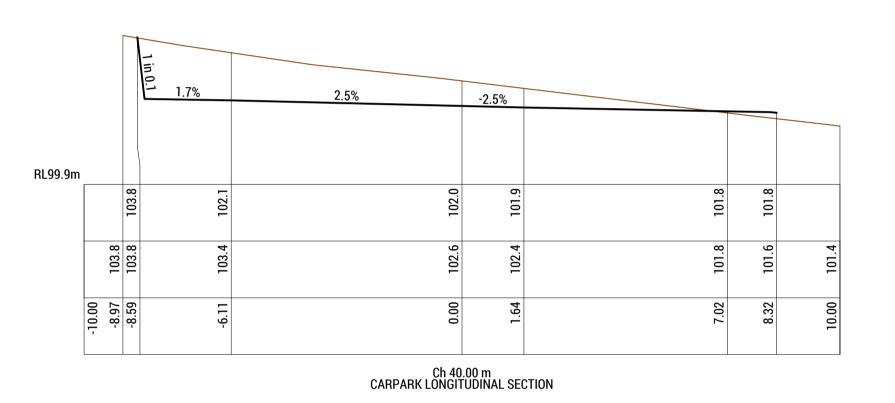

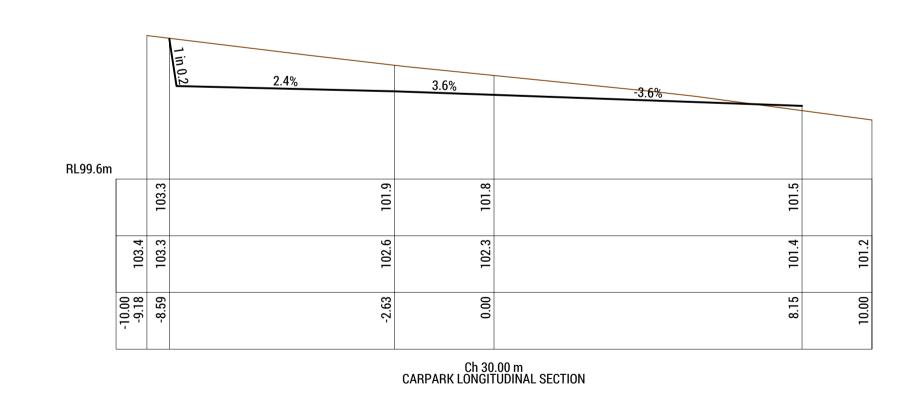

GLENORCHY CITY COUNCIL PLANNING SERVICES APPLICATION No.: PLN-24-270 **DATE RECEIVED:** 12/06/2025

| С | REVISED DEVELOPMENT APPLICATION | SCP | 29-05 |
|------|---------------------------------|-----|--------|
| В | REVISED DEVELOPMENT APPLICATION | OWM | 18-02- |
| Α | REVIEW / INFORMATION | OWM | 07-02 |
| REV: | ISSUED FOR / DESCRIPTION: | BY: | DATE |

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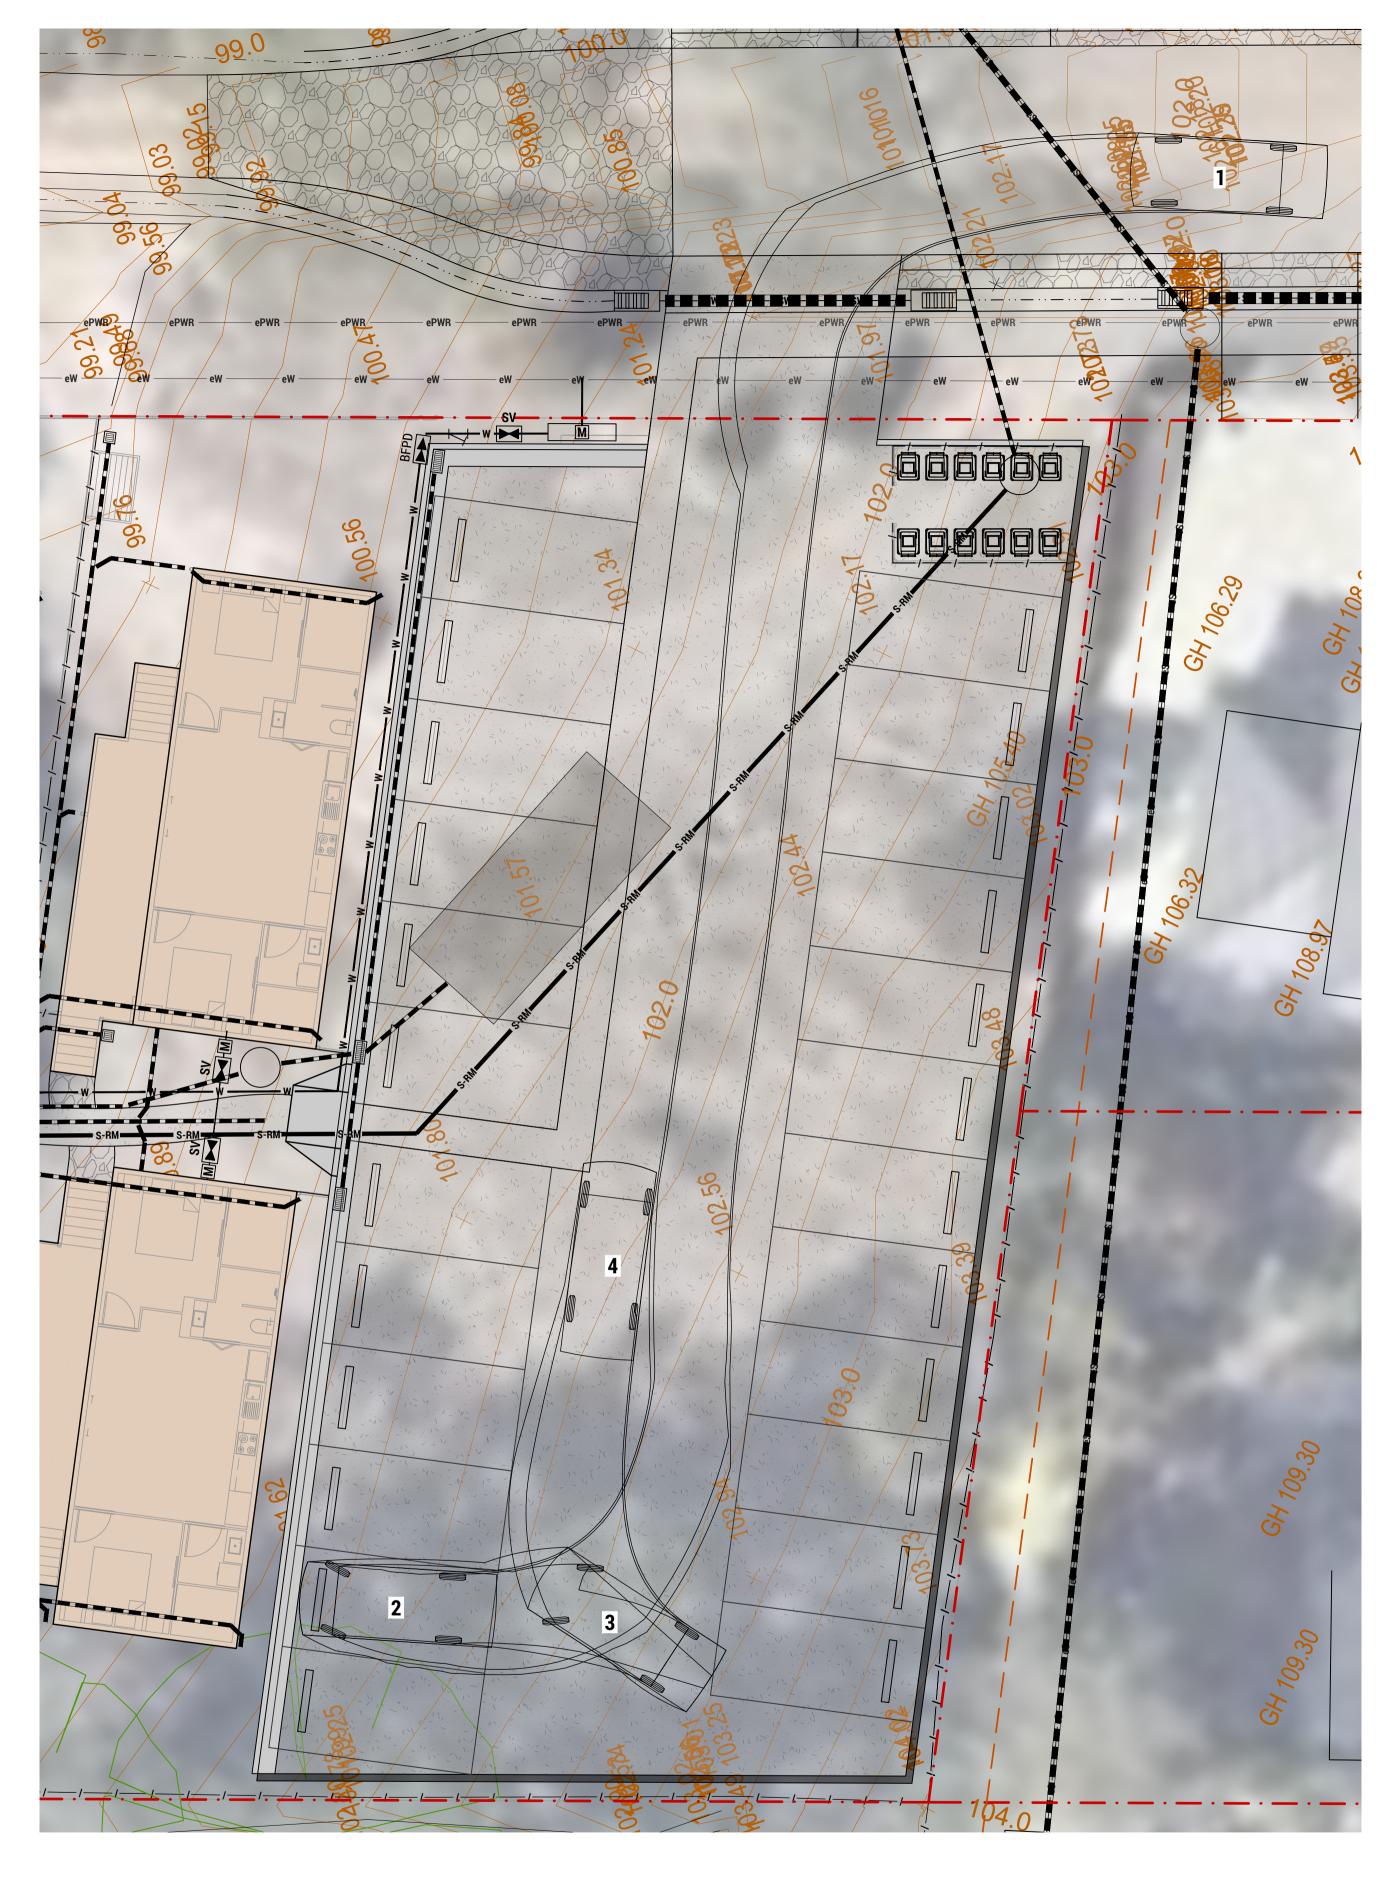


CUNIC HOMES Level 1, 10-14 Paterson Street Launceston TAS 7250

P (03) 6334 0834

CLIENT / ARCHITECT:

| PROJECT DETAILS: 168a ABBOTSFIELD ROAD, CLAREMONT UNITS DEVELOPMENT | | | | DRAWING TITLE LONGITUDII | : NAL & CROSS SECT | IONS - SHEET 4 | | |
|---|---------------|-----------|--------------|--------------------------|-----------------------|----------------|-------------|-----------|
| DESIGN BY: | DESIGN CHECK: | DRAWN BY: | DRAFT CHECK: | CERTIFIER: | SCALE: | PROJECT No: | DRAWING No: | REVISION: |
| AJL | JTA | OWM | JTA | | VARIES | 241043 | C524 | C |



TURNING PATHS - B99 VEHICLE SCALE 1:100

BY: DATE:

E REVISED DEVELOPMENT APPLICATION OWM 07-02-25 D REVIEW / INFORMATION C REVISED DEVELOPMENT APPLICATION OWM 07-11-24 PRIOR TO USE. B DEVELOPMENT APPLICATION

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Launceston TAS 7250 **P** (03) 6334 0834




| | coi exc pei no | mpleted in accor cept for changes rmit conditions. | ppment must be und dance with the app required to comply The use and develon nanged without the | DA | TE RECEIVED: | 12/06/2025 | | |
|--|-------------------------|--|---|------------|----------------------------|---------------|-----------------|-----------|
| PROJECT DETAI 168a ABBO UNITS DEVI | TSFIELD ROAD | , CLAREMON | IT | | DRAWING TITLE: VEHICLE TUF | RNING MOVEMEN | TS PLAN - SHEET | 1 |
| DESIGN BY: | DESIGN CHECK: | DRAWN BY: | DRAFT CHECK: | CERTIFIER: | SCALE: | PROJECT No: | DRAWING No: | REVISION: |
| AJL | JTA | OWM | JTA | | 1:100 @ A1 (1:200 @ A3) | 241043 | C701 | E |
| - | | | | | | | | |

| | eW eW eW eW | 68 Septiment of the sep |
|---|---|--|
| TURNING PATHS - B99 VEHICLE SCALE 1:100 | The use and development must be undertaken and completed in accordance with the approved plans, except for changes required to comply with planning permit conditions. The use and development must not be otherwise changed without the approval of Council. | GLENORCHY CITY COUNCIL PLANNING SERVICES APPLICATION No.: PLN-24-270 DATE RECEIVED: 12/06/2025 |


A REVIEW / INFORMATION

REV: | ISSUED FOR / DESCRIPTION:

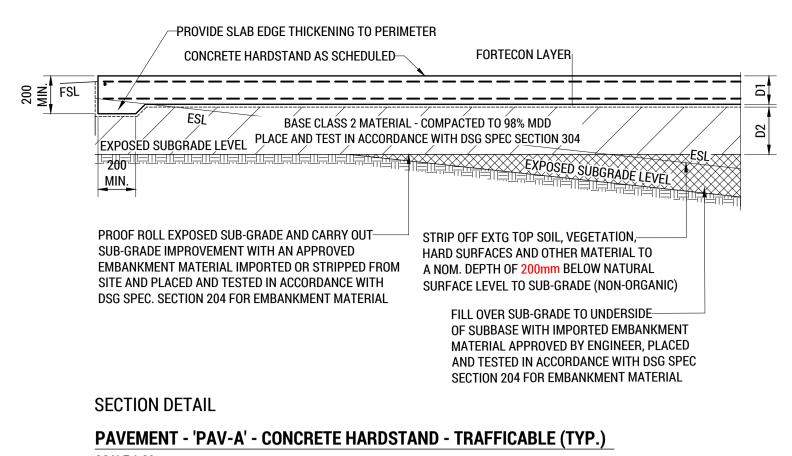




NOTE: REFER CIVIL WORKS PAVEMENT / SURFACE SCHEDULE FOR DEPTHS REFER LGAT STANDARD DRAWING TSD-R09-v3 FOR ADDITIONAL DRIVEWAY DETAILS

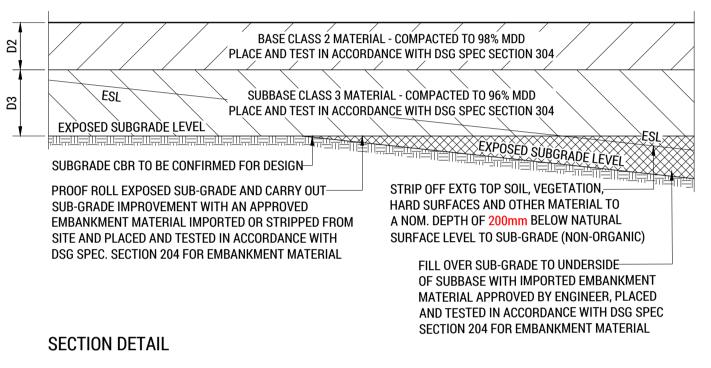


PAVEMENT - 'PAV-D' - COMPACTED GRAVEL - TRAFFICABLE (TYP.)


NOTE: REFER CIVIL WORKS PAVEMENT / SURFACE SCHEDULE FOR DEPTHS

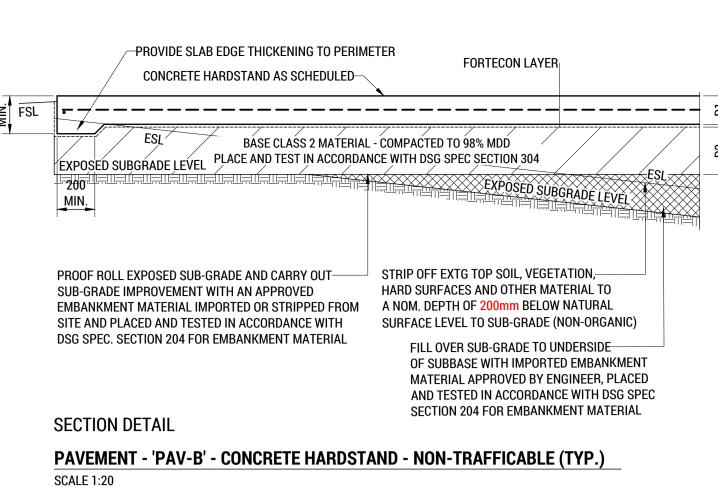


NOTE: REFER CIVIL WORKS PAVEMENT / SURFACE SCHEDULE FOR DEPTHS

REFER LGAT STANDARD DRAWING TSD-R09-v3 FOR ADDITIONAL DRIVEWAY DETAILS

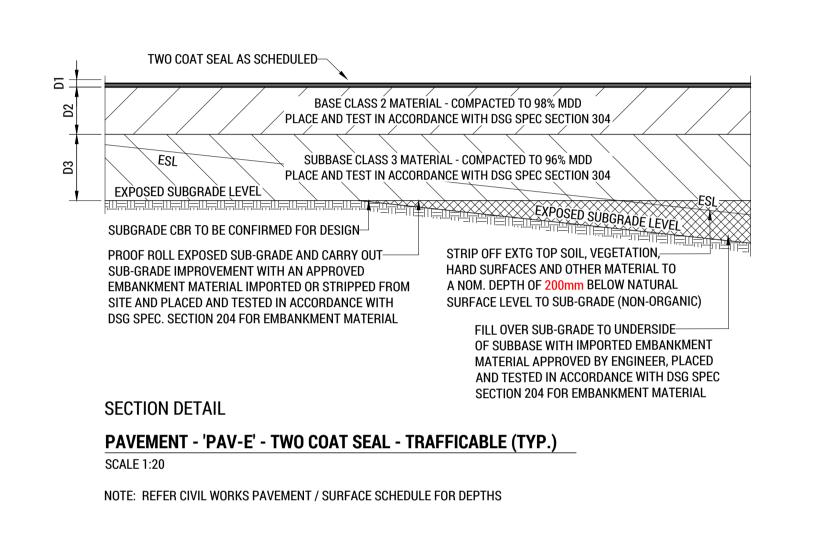

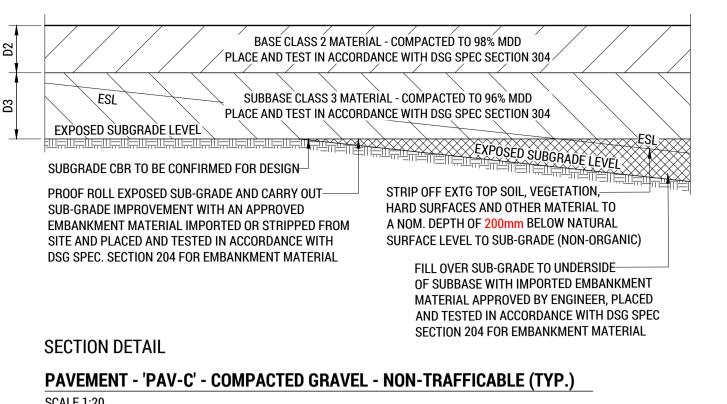


NOTE: REFER CIVIL WORKS PAVEMENT / SURFACE SCHEDULE FOR DEPTHS

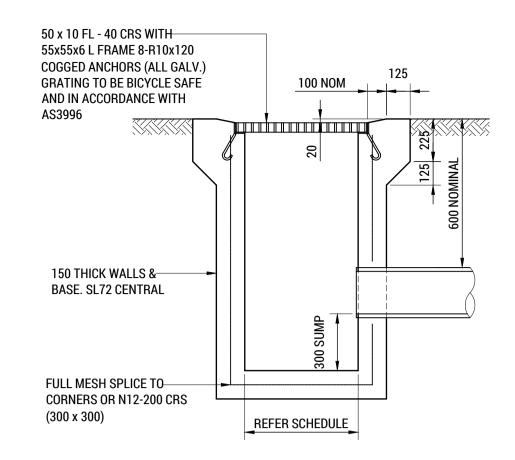

GRATED PIT - TRAFFICABLE

REFER IPWEA STANDARD DRAWINGS FOR ALTERNATE PIT CONSTRUCTION DETAILS. APPROVED PRECAST UNIT MAYBE SUBSTITUTED.

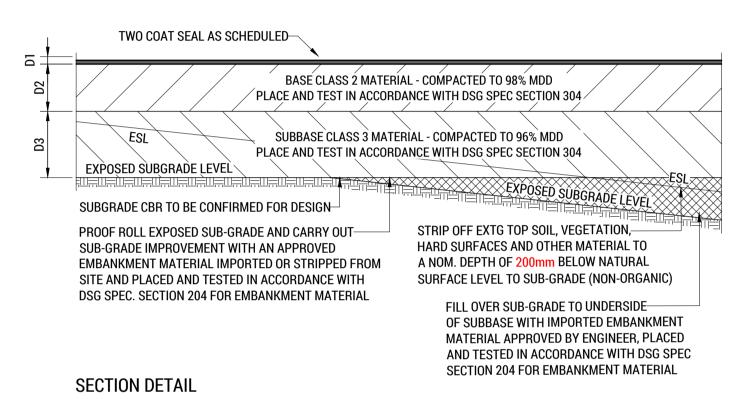


PAVEMENT - 'PAV-F' - TWO COAT SEAL - TRAFFICABLE (TYP.)

BEDDING, HAUNCHING AND OVERLAY MATERIAL

BEDDING, HAUNCHING AND PIPE OVERLAY MATERIAL SHALL

NOTE: REFER CIVIL WORKS PAVEMENT / SURFACE SCHEDULE FOR DEPTHS

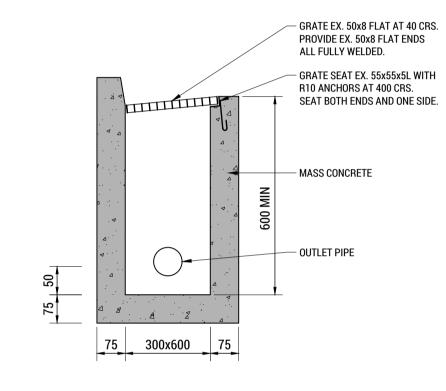


GRATED GULLY PIT - TRAFFICABLE - GP1


40mm ASPHALT (AC7) OR MATCH EXISTING WHICH EVER IS THE GREATER 100mm TOP SOIL-AND SOW BASE 'CLASS 2' **EXCAVATED** PAVEMENT MATERIAL SUB-BASE - CLASS 3 –INDICATOR TAPE (TYP) (WATER MAINS ONLY) PIPE OVERLAY PIPE OVERLAY 150 MIN. 150 MIN. HAUNCHING HAUNCHING D ≤ 450 - 100 D > 450 - 150 } BEDDING D ≤ 450 - 100 D > 450 - 150 } BEDDING TRENCH WIDTH TRENCH WIDTH CLASS 1, 2 AND 3 ROADS

TRENCHES - NON-TRAFFICABLE SCALE 1:20


TRENCHES - EXISTING ROADS SCALE 1:20

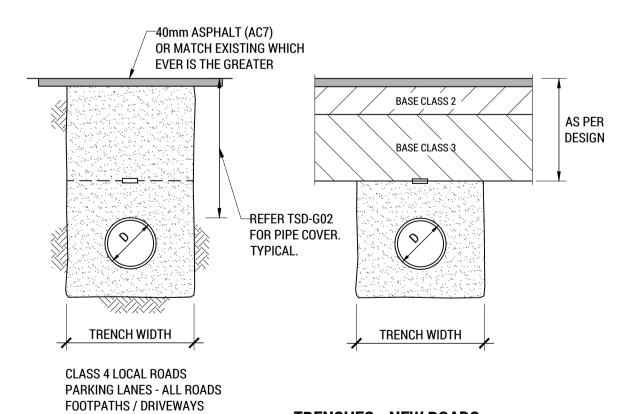


TRENCHES - NEW ROADS SCALE 1:20

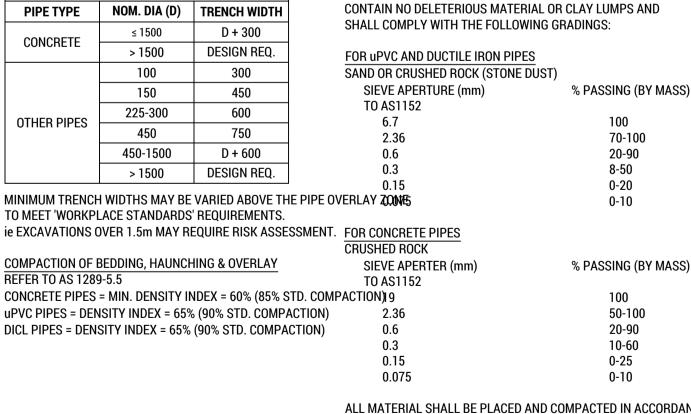

The use and development must be undertaken and completed in accordance with the approved plans, except for changes required to comply with planning permit conditions. The use and development must not be otherwise changed without the approval of

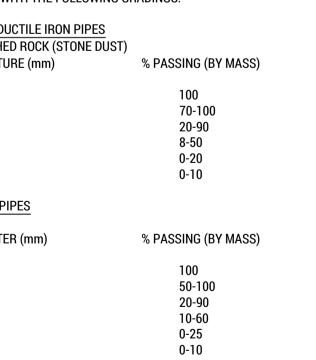

ALL MATERIAL SHALL BE PLACED AND COMPACTED IN ACCORDANCE WITH AS3725 AND TO THE SATISFACTION OF THE SUPERINTENDENT

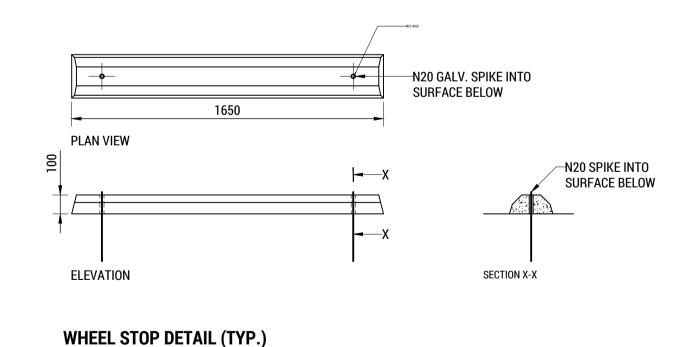

SCALE 1:20 HUDSON CIVIL PRODUCT WHEEL STOP (1650 LONG x 100 HIGH) INSTALLED TO MANUFACTURERS SPECIFICATION

GLENORCHY CITY COUNCIL PLANNING SERVICES APPLICATION No.: PLN-24-270 **DATE RECEIVED:** 12/06/2025

| E | REVISED DEVELOPMENT APPLICATION | OWM | 18-02-25 |
|------|---------------------------------|-----|----------|
| D | REVIEW / INFORMATION | OWM | 07-02-25 |
| С | REVISED DEVELOPMENT APPLICATION | OWM | 07-11-24 |
| В | DEVELOPMENT APPLICATION | OWM | 27-09-24 |
| A | REVIEW / INFORMATION | OWM | 26-09-24 |
| REV: | ISSUED FOR / DESCRIPTION: | BY: | DATE: |

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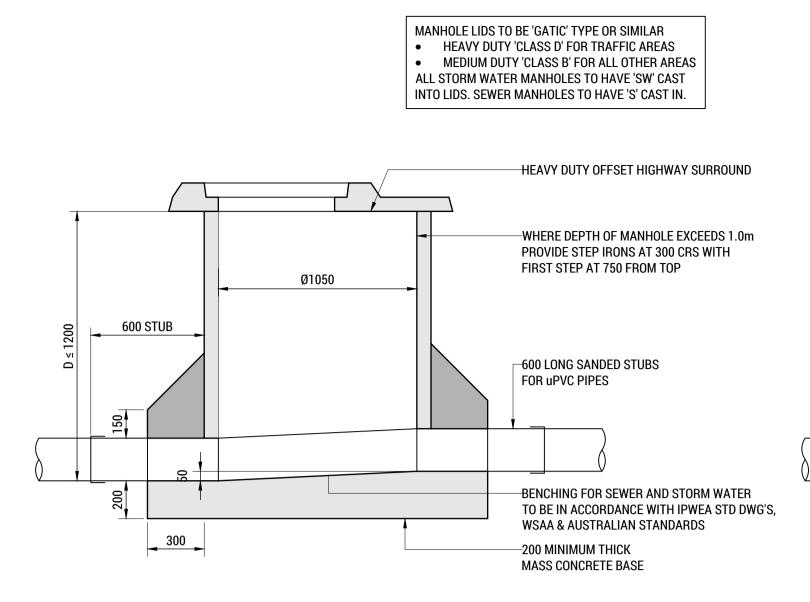



Launceston TAS 7250

| CLIENT / ARCHITECT |
|--------------------|
| CUNIC HOMES |
| De |
| 200 |
| CUNIC |
| Built for you |

TRENCH WIDTH

| PROJECT DETAILS: 168a ABBOTSFIELD ROAD, CLAREMONT UNITS DEVELOPMENT | | | | | DRAWING TITLE: SECTIONS & D | ETAILS - SHEET | 1 | |
|--|---------------|-----------|--------------|------------|--|---------------------------|---------------------|-----------|
| DESIGN BY: | DESIGN CHECK: | DRAWN BY: | DRAFT CHECK: | CERTIFIER: | SCALE: 1:20, 1:10 @ A1 1:40, 1:20 @ A3 | PROJECT No: 241043 | DRAWING No: C801 | REVISION: |



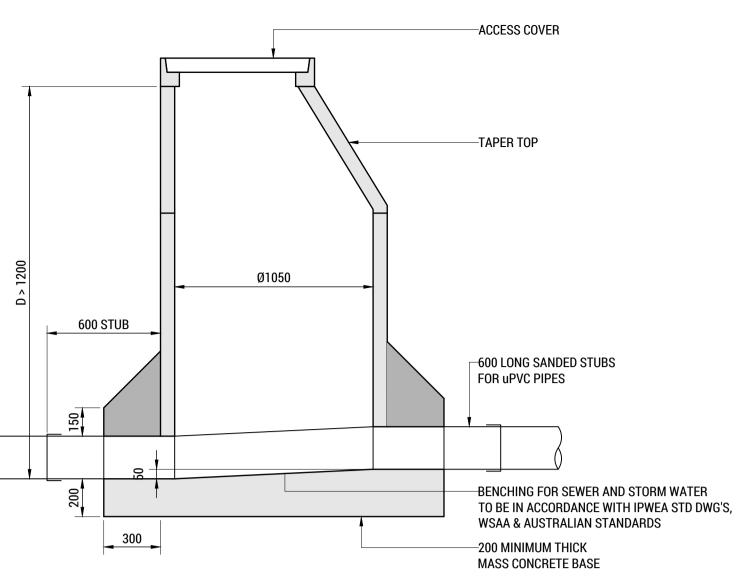

-SURFACE TREATMENT MATERIAL -DETECTABLE PROPOSED FINAL SURFACE— MARKER STRIPS DETECTABLE MARKER STRIPS -PVC MECHANICAL EARTHWORKS TO PROTECTION SUBGRADE LEVEL FINAL BACKFILL - REFER TO TABLE FOR DETAILS BEDDING MATERIAL - REFER TO 100 8 150 TABLE FOR DETAILS - ELECTRICAL CONDUITS - LOCATION WITH COMMON TRENCH IS CONTROLLED BY 300mm SEWER MAIN - FOR SETOUT-OFFSET TO WATER / FIRE MAIN (FOR DETAILS DETAILS REFER TO PLAN OF ELECTRICAL & COMMUNICATION CONDUITS STORM WATER MAIN - FOR-REFER ELECTRICAL & COMMUNICATION DRG'S) SETOUT DETAILS REFER TO PLAN —COMMUNICATION CONDUITS - LOCATION WITH COMMON TRENCH IS CONTROLLED BY WATER MAIN - FOR SETOUT-FIRE MAIN - FOR SETOUT 150m OFFSET TO WATER / FIRE MAIN DETAILS REFER TO PLAN **DETAILS REFER TO PLAN** FLOOR OF TRENCH TRIMMED TO SUPPORT PIPE

| COMPACTION DETAILS | | | | | | | |
|--|-----|-----|--|--|--|--|------------------|
| EXPRESSED AS MMDD MATERIAL GENERAL UNDER ROADS* | | | | | | | |
| | | | | | | | BEDDING MATERIAL |
| INITIAL BACKFILL | 90% | 95% | | | | | |
| FINAL BACKFILL SAME AS SURROUNDING SOIL 95% | | | | | | | |
| * OR AS DIRECTED BY SUPERINTENDENT | | | | | | | |

TYPICAL COMBINED TRENCH DETAIL


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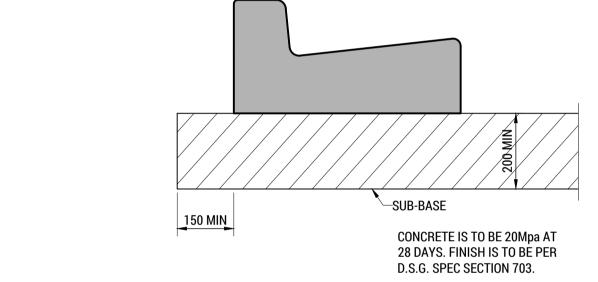



REFER IPWEA STD DWG TSD-SW02-v3 FOR STORMWATER MANHOLE DETAILS REFER WSAA STD DWG'S FOR SEWER MANHOLE DETAILS

-SUB-BASE CONCRETE IS TO BE 20Mpa AT 28 DAYS. FINISH IS TO BE PER

D.S.G. SPEC SECTION 703.



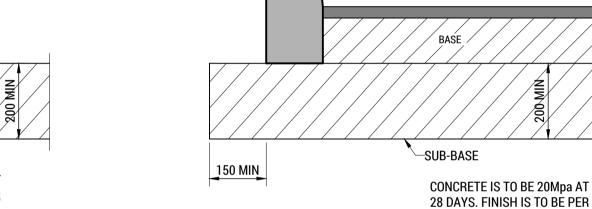

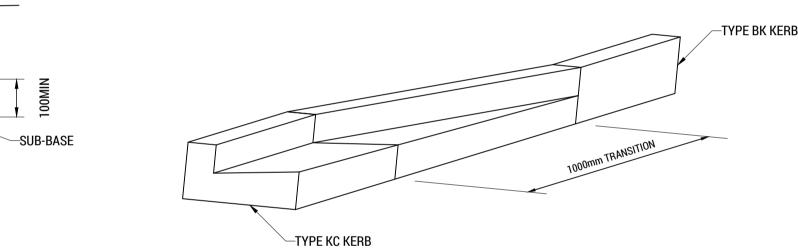

KERB AND CHANNEL VEHICULAR CROSSING 'KCV' (TYP.)

REFER IPWEA STD DWG TSD-R14-v3 FOR APPROVED KERB & CHANNEL

PROFILES & DIMENSIONS

SCALE 1:10

BARRIER KERB 'BK' (TYP.) SCALE 1:10

MANHOLE DETAIL - D > 1200

D.S.G. SPEC SECTION 703.

SCALE 1:20

REFER IPWEA STD DWG TSD-R14-v3 FOR APPROVED KERB & CHANNEL PROFILES & DIMENSIONS



REFER IPWEA STD DWG TSD-R14-v3 FOR APPROVED KERB & CHANNEL PROFILES & DIMENSIONS




PROFILES & DIMENSIONS


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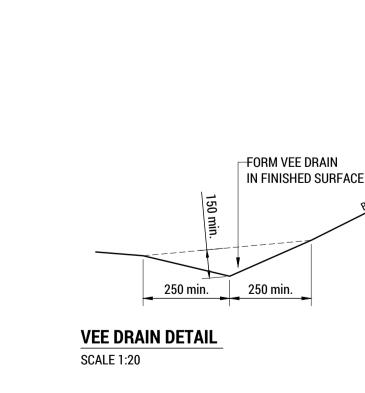
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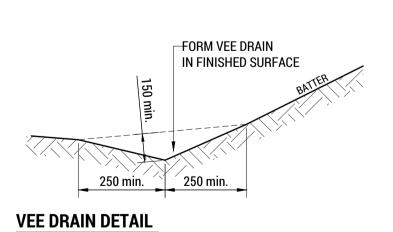
150 MIN

KC TO BK KERB TRANSITION (TYP.) **SCALE 1:20**





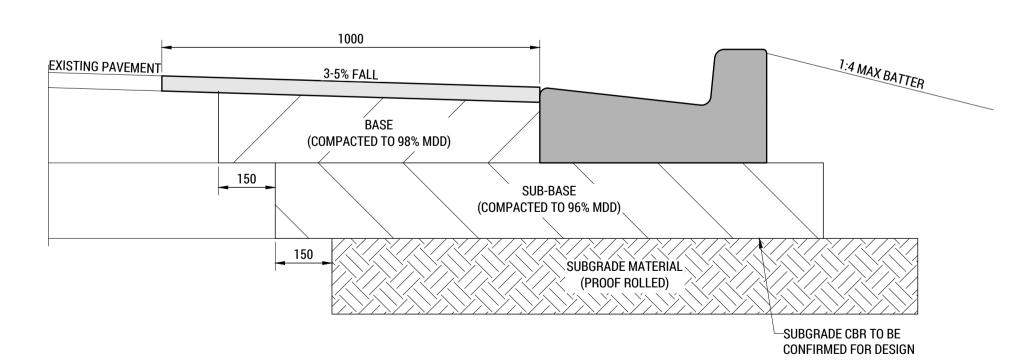

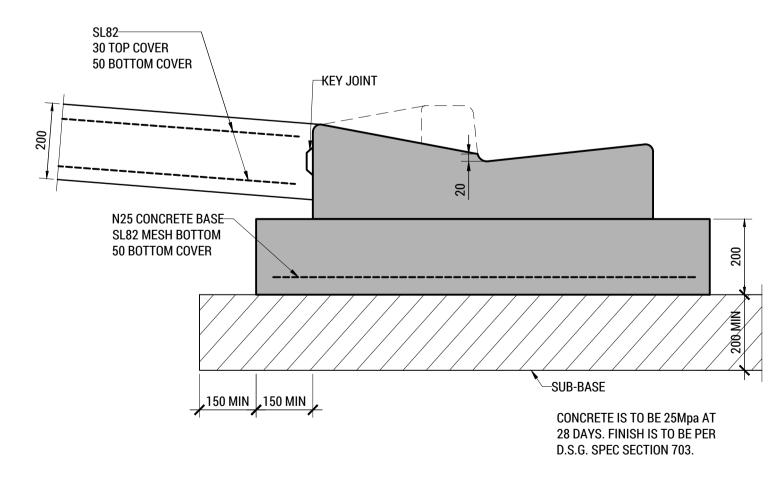

Council.

KERB CUT IN DETAIL (TYP.)

NOTE - HOTMIX PAVEMENT - ROADWAYS FOR BASE MATERIAL TYPES & DEPTHS

REFER IPWEA STD DWG TSD-R16-v3

VEHICULAR CROSSING HEAVY DUTY BASE 'KCRB' (TYP.)

FOR APPROVED KERB & CHANNEL PROFILES & DIMENSIONS

GLENORCHY CITY COUNCIL PLANNING SERVICES **APPLICATION No.**: PLN-24-270 12/06/2025 DATE RECEIVED:

The use and development must be undertaken and completed in accordance with the approved plans, except for changes required to comply with planning

permit conditions. The use and development must not be otherwise changed without the approval of

| Ε | REVISED DEVELOPMENT APPLICATION | OWM | 18-02-25 |
|------|---------------------------------|-----|----------|
| D | REVIEW / INFORMATION | OWM | 07-02-25 |
| С | REVISED DEVELOPMENT APPLICATION | OWM | 07-11-24 |
| В | DEVELOPMENT APPLICATION | OWM | 27-09-24 |
| Α | REVIEW / INFORMATION | OWM | 26-09-24 |
| REV: | ISSUED FOR / DESCRIPTION: | BY: | DATE: |

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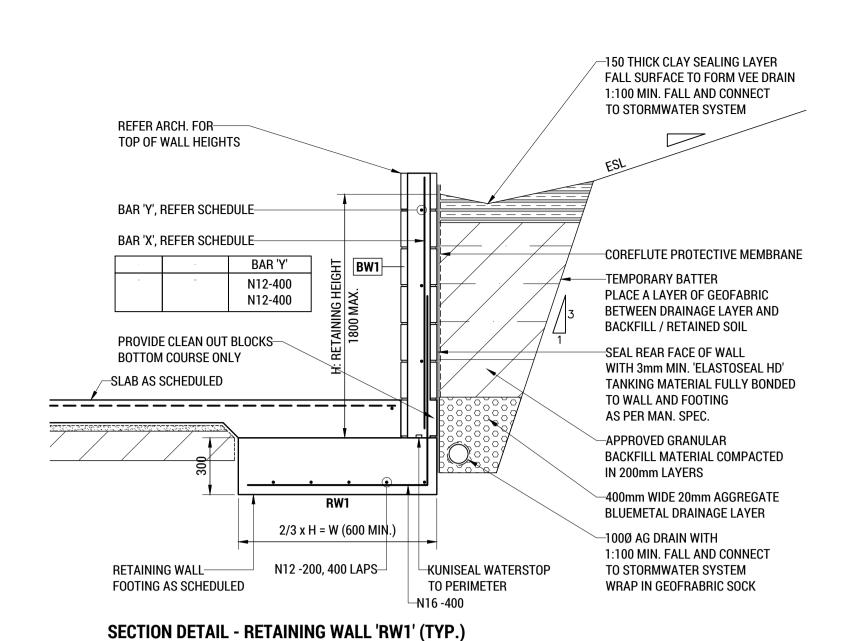



Level 1, 10-14 Paterson Street Launceston TAS 7250 **P** (03) 6334 0834

| CLIENT / ARCHITEC |
|-------------------|
| CUNIC HOMES |
| 000 |
| 300 |
| CUNIC |
| Rull for you |
| Dun |

| PROJECT DETAIL 168a ABBOT UNITS DEVE | SFIELD ROAD | , CLAREMON | Γ | | DRAWING TITLE SECTIONS | : & Details - Sheet | · 2 | |
|--|---------------|------------|--------------|------------|--|------------------------|---------------------|-----------------------|
| DESIGN BY: | DESIGN CHECK: | DRAWN BY: | DRAFT CHECK: | CERTIFIER: | SCALE: 1:20, 1:10 @ A1 1:40, 1:20 @ A3 | 27/11/1/2 | DRAWING No: C802 | REVISION: E |


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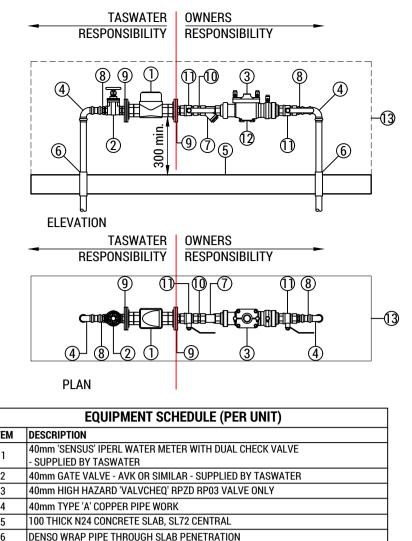


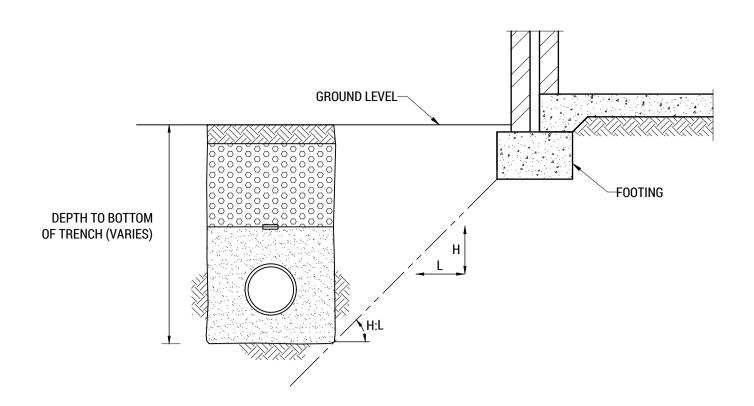

| SOIL TYPE | SLOP | E H:L | | | |
|--|----------------|--------------------|--|--|--|
| SUIL TIPE | COMPACTED FILL | UNDISTURBED GROUND | | | |
| STABLE ROCK | 2:3 | 8:1 | | | |
| SAND | 1:2 | 1:2 | | | |
| SILT | 1:4 | 1:4 | | | |
| FIRM CLAY | 1:2 | 1:1 | | | |
| SOFT CLAY | NOT SUITABLE | 2:3 | | | |
| SOFT SOILS | NOT SUITABLE | NOT SUITABLE | | | |
| (TABLE ADAPTED FROM NCC 2016 BCA - VOLUME TWO) | | | | | |

TYPICAL 'ZONE OF INFLUENCE' DETAIL **SCALE 1:20**



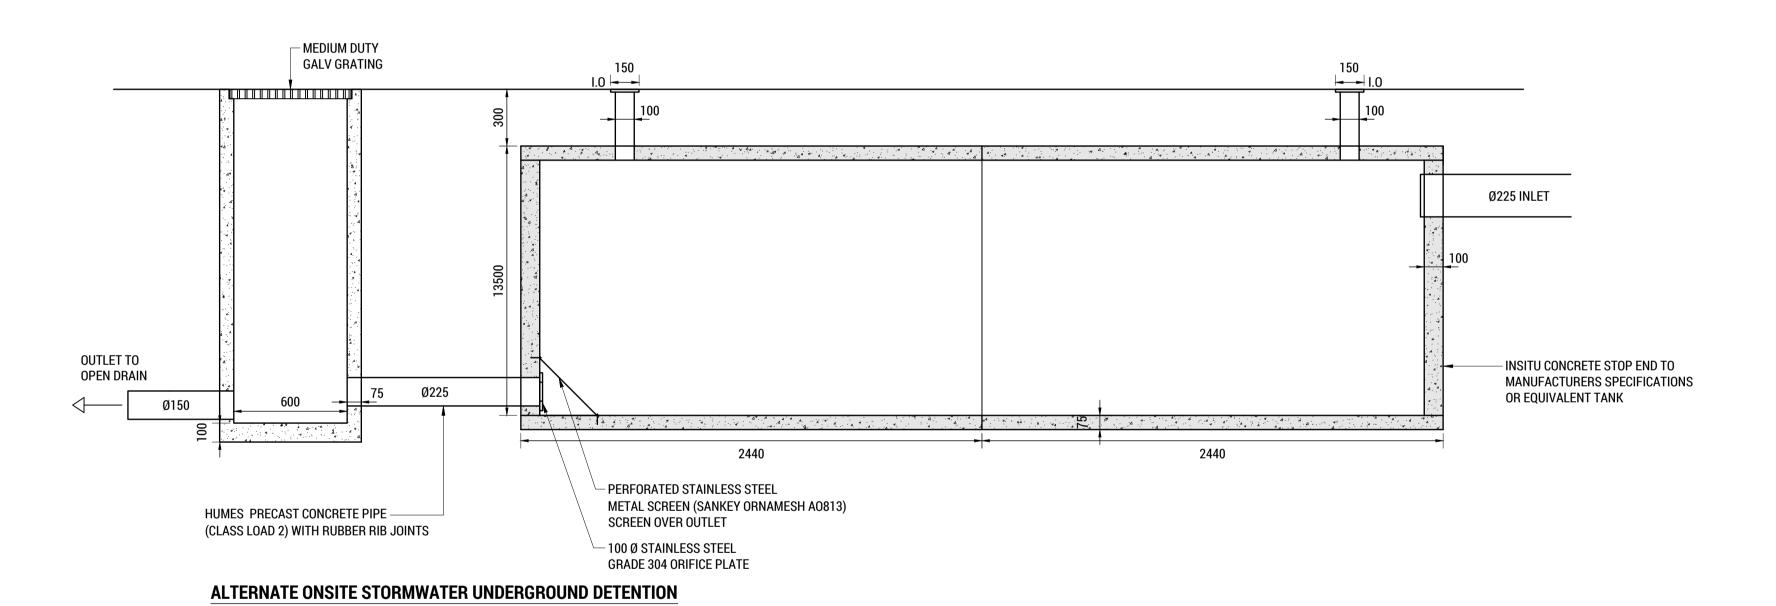

ITEM DESCRIPTION 2 40mm GATE VALVE - AVK OR SIMILAR - SUPPLIED BY TASWATER 3 40mm HIGH HAZARD 'VALVCHEQ' RPZD RP03 VALVE ONLY 4 40mm TYPE 'A' COPPER PIPE WORK 5 100 THICK N24 CONCRETE SLAB, SL72 CENTRAL 6 DENSO WRAP PIPE THROUGH SLAB PENETRATION 7 40mm STRAINER 8 B PRESS FITTINGS OR SIMILAR 9 40mm BSP TO TABLE E FLANGE ADAPTOR 10 40mm NIPPLE 40mm BALL VALVE - LOCKABLE QUARTER TURN BRASS DZR WITH BRASS HANDLE, 11 RESILIENT SEATED 13 GALV. METAL CAGE - REFER TWS-W-0003 SERIES DRAWINGS FOR DETAILS

D01 40mm HIGH HAZARD METER DETAIL SCALE 1:20

> The use and development must be undertaken and completed in accordance with the approved plans, except for changes required to comply with planning permit conditions. The use and development must not be otherwise changed without the approval of

> > **GLENORCHY CITY COUNCIL** PLANNING SERVICES APPLICATION No.: PLN-24-270 **DATE RECEIVED:** 12/06/2025

| Ε | REVISED DEVELOPMENT APPLICATION | OWM | 18-02-25 |
|------|---------------------------------|-----|----------|
| D | REVIEW / INFORMATION | OWM | 07-02-25 |
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| Α | REVIEW / INFORMATION | OWM | 26-09-24 |
| REV: | ISSUED FOR / DESCRIPTION: | BY: | DATE: |

SCALE 1:20

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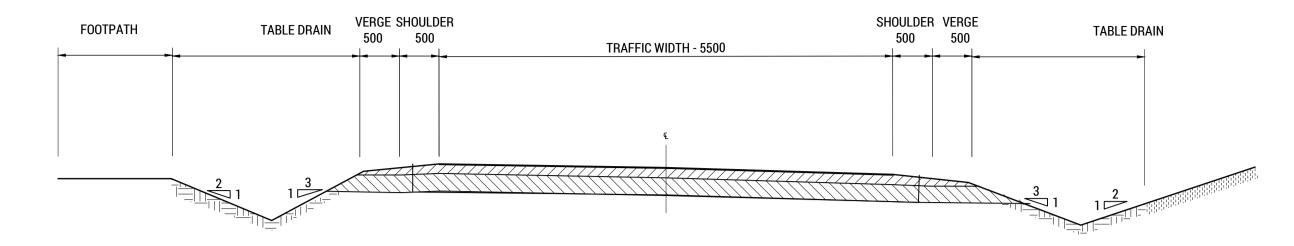
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CLIENT / ARCHITECT: **CUNIC HOMES** Launceston TAS 7250 **P** (03) 6334 0834

| | PROJECT DETAILS: 168a ABBOTSFIELD ROAD, CLAREMONT UNITS DEVELOPMENT DESIGN BY: DESIGN CHECK: DRAWN BY: DRAFT CHECK: CERTIFIER: | | | | | DRAWING TITLE: SECTIONS & DE | ETAILS - SHEET | 3 | |
|---|--|----------------------|------------------|---------------------|------------|--|---------------------------|---------------------|-----------------------|
| · | DESIGN BY: AJL | DESIGN CHECK: JTA | DRAWN BY: OWM | DRAFT CHECK: JTA | CERTIFIER: | SCALE: 1:20, 1:10 @ A1 1:40, 1:20 @ A3 | PROJECT No: 241043 | DRAWING No: C803 | REVISION: E |



TYPICAL ROAD CROSS SECTION - ROAD 1 SCALE 1:50

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> > **GLENORCHY CITY COUNCIL PLANNING SERVICES** APPLICATION No.: PLN-24-270

DATE RECEIVED: 12/06/2025

| В | REVISED DEVELOPMENT APPLICATION | OWM | 18-02-25 |
|------|---------------------------------|-----|----------|
| Α | REVIEW / INFORMATION | OWM | 07-02-25 |
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| | E admin@collectiveconsultin Level 1, 10-14 Paterson Street Launceston TAS 7250 P (03) 6334 0834 |
|--------------------------|--|
| COLLECTIVE CONSULTING | collectiveconsulting.com.au |

| CLIENT / ARCHITECT: | |
|---------------------------|--|
| CUNIC HOMES | |
| CUNIC homes Built for you | |

| PROJECT DETAILS: 168a ABBOTSFIELD ROAD, CLAREMONT UNITS DEVELOPMENT | | | | DRAWING TITLE: SECTIONS & DETAILS - SHEET 4 | | | | |
|---|---------------|-----------|--------------|---|---------------------|-------------|-------------|-----------|
| DESIGN BY: | DESIGN CHECK: | DRAWN BY: | DRAFT CHECK: | CERTIFIER: | SCALE: 1:50 @ A1 | PROJECT No: | DRAWING No: | REVISION: |
| AJL | JTA | OWM | JTA | | 1:100 @ A3 | 241043 | C804 | В |



Submission to Planning Authority Notice

Application details

Council Planning Permit No. PLN-24-270

Council notice date 15/11/2024

TasWater Reference No. TWDA 2024/01331-GCC

Date of response 05/03/2025

TasWater Contact Huong Pham

Phone No. 0427 471 748

Response issued to

Council name GLENORCHY CITY COUNCIL

Contact details gccmail@gcc.tas.gov.au

Development details

Address 168A ABBOTSFIELD RD, CLAREMONT

Property ID (PID) 9550943

Description of development Multiple Dwellings x 12

Schedule of drawings/documents

| Prepared by | Drawing/document No. | Revision No. | Issue date |
|-----------------------|----------------------|--------------|------------|
| Collective Consulting | 241043 sheet C201 | Α | 18/02/2025 |
| Collective Consulting | 241043 sheets C401 | Е | 18/02/2025 |
| Cunic homes | U249 sheets 01 | D | 19/12/2024 |

Conditions

Pursuant to the *Water and Sewerage Industry Act* 2008 (TAS) Section 56P(1) TasWater imposes the following conditions on the permit for this application:

CONNECTIONS, METERING & BACKFLOW

 A suitably sized water supply with metered connections and sewerage system and connections to development must be designed and constructed to TasWater's satisfaction and be in accordance with any other conditions in this permit.

Advice: The sewer property connection servicing 12 units will need to be DN150mm.

Tasmanian Water & Sewerage Corporation Pty Ltd GPO Box 1393 Hobart, TAS 7001 development@taswater.com,.au ABN: 47 162 220 653

Page 1 of 3



- 2. Any removal/supply and installation of water meters and/or the removal of redundant and/or installation of new and modified property service connections must be carried out by TasWater at the developer's cost.
- 3. Prior to commencing construction of the subdivision/use of the development, any water connection utilised for construction/the development must have a backflow prevention device and water meter installed, to the satisfaction of TasWater.

DEVELOPER CHARGES

- 4. Prior to TasWater issuing a Certificate(s) for Certifiable Work (Building) and/or (Plumbing), the applicant or landowner as the case may be, must pay a developer charge totalling \$10,893.40 to TasWater for water infrastructure for 6.20 additional Equivalent Tenements, indexed by the Consumer Price Index All groups (Hobart) from the date of this Submission to Planning Authority Notice until the date it is paid to TasWater.
- 5. Prior to TasWater issuing a Certificate(s) for Certifiable Work (Building) and/or (Plumbing), the applicant or landowner as the case may be, must pay a developer charge totalling \$14,056.00 to TasWater for sewerage infrastructure for 8.00 additional Equivalent Tenements, indexed by the Consumer Price Index All groups (Hobart) from the date of this Submission to Planning Authority Notice until the date it is paid to TasWater.

DEVELOPMENT ASSESSMENT FEES

6. The applicant or landowner as the case may be, must pay a development assessment fee of \$775.39 to TasWater, as approved by the Economic Regulator and the fee will be indexed, until the date paid to TasWater.

The payment is required within 30 days of the issue of an invoice by TasWater.

Advice

General

For information on TasWater development standards, please visit https://www.taswater.com.au/building-and-development/technical-standards
For application forms please visit https://www.taswater.com.au/building-and-development/development-application-form

Developer Charges

For information on Developer Charges please visit the following webpage – https://www.taswater.com.au/building-and-development/developer-charges

Water Submetering

As of July 1 2022, TasWater's Sub-Metering Policy no longer permits TasWater sub-meters to be installed for new developments. Please ensure plans submitted with the application for Certificate(s) for Certifiable Work (Building and/or Plumbing) reflect this. For clarity, TasWater does not object to private sub-metering arrangements. Further information is available on our website (www.taswater.com.au) within our Sub-Metering Policy and Water Metering Guidelines.

Service Locations

Please note that the developer is responsible for arranging to locate the existing TasWater infrastructure and clearly showing it on the drawings. Existing TasWater infrastructure may be

Page 2 of 3



located by a surveyor and/or a private contractor engaged at the developers cost to locate the infrastructure.

- (a) A permit is required to work within TasWater's easements or in the vicinity of its infrastructure. Further information can be obtained from TasWater.
- (b) TasWater has listed a number of service providers who can provide asset detection and location services should you require it. Visit https://www.taswater.com.au/building-and-development/service-locations for a list of companies.
- (c) Sewer drainage plans or Inspection Openings (IO) for residential properties are available from your local council.

 $\underline{\text{NOTE:}}$ In accordance with the WATER AND SEWERAGE INDUSTRY ACT 2008 - SECT 56ZB A regulated entity may charge a person for the reasonable cost of -

- (a) a meter; and
- (b) installing a meter.

Declaration

The drawings/documents and conditions stated above constitute TasWater's Submission to Planning Authority Notice.

GPA - Attachment 2 168A Abbotsfield Road Claremont

Referral Officer Reports

DEVELOPMENT ENGINEER REFERRAL

| DA No. | PLN-24-270 | Date Referred | 15/11/2024 | |
|-------------------------|---------------------------|---|---------------|--|
| Planner | Sylvia Jeffreys | To Be Returned By | 22/11/2024 | |
| Development Engineer | Arete Engineering | Date Returned | Select | |
| Property File No. | 9550943 | Discretionary Permitted | Discretionary | |
| Details of Application: | Applicant's Name: | me: Cunic Homes | | |
| | Business Contact Name: | Domonee Van Heerden | | |
| | Contact Email: | dom@cunic.com.au | | |
| | Address of Development: | 168A Abbotsfield Road Claremont | | |
| | | Twelve Multiple Dwellings and works in the road reserve (Residential) | | |

The applicant proposes the construction of 12 standalone two-bedroom dwellings, the provision of 24 car parking spaces, and upgrades to existing roads and accessways. The proposal exceeds the recommended density for the site by four dwellings, with eight being the preferable maximum for appropriate site function and livability.

While the proposal has been supported in principle, it has raised serious concerns regarding design quality, regulatory compliance, and applicant cooperation, which necessitate significant conditions on approval.

Key Issues Identified:

1. Design Standards:

The proposed car parking layout fails to meet AS 2890.1 standards and only marginally satisfies performance criteria relating to design layout. There is no consideration for accessible parking or pathways, and no disability access has been included from parking areas to dwelling entrances. While not strictly required under the current planning scheme, this is a critical oversight given the proportion of people with disabilities in social housing.

 Access and Infrastructure Upgrades:
 The proposed upgrading of accessways and the existing road must be carefully designed to prevent adverse impacts on adjacent property entrances. To date, the

applicant has not adequately addressed concerns raised by neighboring properties or demonstrated a commitment to mitigating these impacts.

3. Public Representations:

Council has received four formal representations from neighboring property owners, expressing valid concerns regarding:

- Changes to their property access arrangements. (Conditions have been recommended to preserve existing access design functionality);
- Impacts of road upgrades. (The TIA did not address the increase in capacity of the parking and access due to the increase in density and hence car parking by 50%)
- o Incomplete or absent responses from the applicant.
- Inadequate stormwater management design. (stormwater management has been heavily condition and will be to the satisfaction of the development engineer).

4. Applicant Conduct:

The applicant has demonstrated a reluctance to respond fully to requests for additional information. Unauthorized **site disturbance** has already occurred, labeled as "land clearing," raising concerns over **non-compliance** with the planning process.

Conclusion and Recommendation

The application is supported conceptually only, contingent upon full compliance with stringent design and construction conditions. No construction work is to commence until all relevant conditions have been met and certified by council.

Council holds significant concerns regarding the quality and durability of the proposed development, which appears to prioritize cost minimization over long-term livability and sustainability. Without strict oversight and adherence to conditions, the development is likely to fall short of the expected 50-year design life and impose ongoing maintenance and amenity burdens on both future residents and adjacent property owners.

Should the applicant fail to meet the imposed conditions, they will be required to submit amendments to the application for further assessment.

From a design standpoint, the site is currently overdeveloped, placing undue pressure on its infrastructure, functionality, and the surrounding properties. A reduction in the number of dwellings would alleviate this strain, enhancing the overall performance, sustainability, and integration of the development within its context.

Note: While not a requirement of the planning scheme, Council notes there is no disability parking or access. Disability access to the dwellings from the car park to the front door of the dwelling is not provided. Easily accessible evidence points to a large proportion of people in Australia in social housing have a disability of some form. It is unclear how suitable

residents will be selected based on their physical and mental condition to be suitable for one of these dwellings.

David Morley

Development Engineer

TRANSPORT ENGINEER REFERRAL

| DA No:. | PLN-24-270 | Date Referred: | 15/11/2024 | | |
|--------------------------|-------------------------------------|----------------------------|---|--|--|
| Development Engineer: | Arete Engineering – David Morley | Date Returned: | 22/11/2024 | | |
| Traffic Engineer: | Emily Burch | Property File No: | 9550943 | | |
| Standard: | | Discretionary Permitted | Discretionary | | |
| Details of | Applicant's Name: | Cunic Ho | Cunic Homes | | |
| Application: | Business Contact Name | e: Domone | Domonee Van Heerden | | |
| | Contact Email: | ontact Email: dom@cu | | | |
| | Address of Developmer | | 168A Abbotsfield Road Claremont | | |
| | Proposal in Detail: | | e Multiple Dwellings and in the road reserve lential) | | |

Introduction

The developer proposes to construct 12 two-bedroom units with 24 car parking spaces at an internal lot off Abbotsfield Road.

The assessment below is based on the Traffic Impact Assessment (TIA) undertaken by Midson Traffic dated January 2025 and plans by Collective Consulting. The TIA addresses the performance criteria C2.5.1 P1.2 car parking numbers for dwellings; C2.6.5 P1 pedestrian access and C3.5.1 P1 traffic generation at a vehicle crossing, level crossing or new junction.

Parking Supply

The planning scheme requires 28 car parking spaces. The development is proposing 24 spaces for the 12 two-bedroom units. This means that the performance criteria is addressed in the TIA under C2.5.1 P1.2.

The TIA has calculated the parking required under the NSW Guide to Traffic Generation Development for medium density housing to be 17 parking spaces. However, I have calculated this to be 23 parking spaces. The difference might be due to assessing the application for social and affordable housing. Regardless, the development is providing

24 parking spaces which is adequate parking for the development. Thus, the

performance criteria C2.5.1 P1.2 is met.

Pedestrians Access

Within the car park area there is not a dedicated pedestrian path, thus the performance criteria is addressed in the TIA under C2.6.5 P1. The TIA outlines that the site is a small residential unit development with low vehicle speeds and volumes, via a single

entrance/exit point to the 90-degree parking spaces.

The low speeds and volumes, results in an acceptable safety environment for shared use between pedestrians and vehicles. Additionally, there is a path from the centre of the car

park to each unit. Thus, the performance criteria C2.6.5 P1 is met.

Traffic Generation

The traffic generated by the development is expected to be 60 daily trips with 6 trips in peak hour as per the NSW Guide to Traffic Generation Development. As the development is creating a new junction with Abbotsfield Road, the performance criteria C3.5.1 is

required to be addressed.

The increase in traffic by the development onto Abbotsfield Road is not expected to have a significate impact on the safety or efficiently of the road network. Additionally, sight line onto Abbotsfield Road were assessed in the TIA and met the requirements under

AS2890.1 and the Austroads Guides.

The design of the access road from the new junction with Abbotsfield Road to the site's

car park, is considered under the performance criteria C3.5.1 and is detailed below.

Access Road Design

The access road is within the road reserve and extends from Abbotsfield Road to site's car park. The access road is proposed to be designed to the satisfaction of the Road

car park. The access road to proposed to be accepted to the catter

Authority being Council.

undertaken in accordance with Road to Rural Road Sealed TSD-R20-V3 with a minimum sealed traffic width of 5.5m and a footpath to urban roads footpath TSD-R11-V3 with no

The Road Authority has required that within the road reserve that the access road is

kerb but separation to the road. This information is shown on the plans, and a condition

will be placed on the permit for further detailed engineering plans by the development

engineer.

Conclusion

Based on the TIA, the proposed development is not expected to have any significant detrimental impacts on the surrounding road network in terms of traffic efficiency, parking or road safety, I have no objection to the development on traffic engineering or road safety grounds.

HYDRAULICS DEPARTMENT REFERRAL

| DA No:. | PLN-24-270 | Date Referred: | 21/11/2024 | |
|--------------------------|-------------------------------------|--|---------------|--|
| Development Engineer: | Arete Engineering – David Morley | Date Returned: | 28/11/2024 | |
| Hydraulics Engineer: | Dan Egodawatte | Property File No: | 9550943 | |
| Standard: | | Discretionary Permitted | Discretionary | |
| Details of | Applicant's Name: | Cunic Homes | | |
| Application: | Business Contact Name: | Domonee Van Heerden | | |
| | Contact Email: | dom@cunic.com.au | | |
| | Address of Development: | 168A Abbotsfield Road Claremont | | |
| | Proposal in Detail: | Twelve Multiple Dwellings and worl in the road reserve (Residential) | | |

Comments

This development includes construction of 12×2 bedroom multi dwellings, fully impervious carpark and associated infrastructure. Site is subjected to the Flood Prone Area Code overlay and this assessment includes a flood hazard assessment to address the C12.0 Flood Prone Areas Hazard Code.

Referred documents

- Flood Hazard Report by Flussig Engineers Reference FE24055 Revision 00 dated
 12/08/2024 (referred to as 'Flood Hazard Report' in the assessment)
- 2. Infrastructure Services Reports by Collective Consulting, issue 02 dated F18/02/2025 (referred to as 'Services Report' in the assessment)
- 3. Concept Civil Engineering plans by Collective Consulting, reference 241043, revision E, dated 18/02/2025 (referred to as 'Concept Engineering Plans' in the assessment)

C12.0 Flood-Prone Areas Hazard Code

Flood Hazard Report has been prepared by Flussig Engineers to address the performance criteria under C12.5.1 Uses within a flood prone area and C12.6.1. Building and works within a flood prone area. Objectives of the above two criteria is to demonstrate whether the proposed development and the use can achieve and maintain a tolerable risk during a 1% AEP flood event with provision for the climate change scenario.

Flood hazard is generally categorised based on the combined impacts of expected flood depths and velocities as per Australian Disaster and Resilient Handbook. Below graphical representation indicates the 6 categories from H1 to H6.

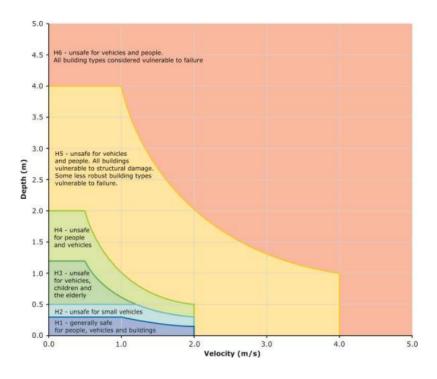


Figure 1: General flood hazard vulnerability curves

Flussig report has identified that a portion of proposed multi dwellings to the north-western side at the site is exposed to H1- low hazard risk during a 1 % AEP + climate change event. This is mostly due to existing minor overland flow paths down the hill. Also, the report concludes that the flood hazard impacts to the neighbouring properties are not increased post development, provided the recommendations made in the report are complied with. A pre and post flood hazard comparison maps listed below for comparison.

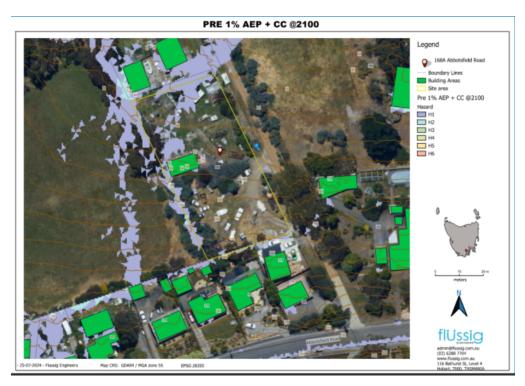


Figure 8: Pre-development Flood Hazard Extents

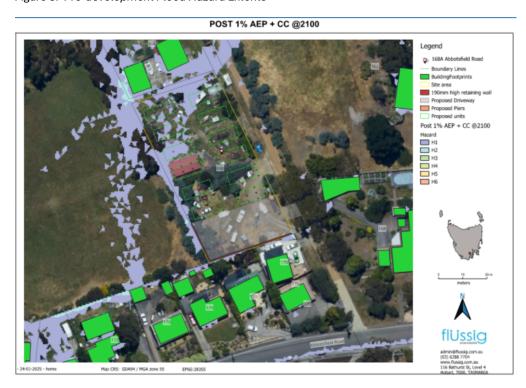


Figure 9: Post Development Flood Hazard Extents

Flood Hazard Report by Flussig has provided a range of recommendations to ensure achieve and maintain a tolerable risk including:

1. The proposed unit dwellings must be constructed on piers to prevent direct contact with floodwaters and to allow for the unobstructed passage of overland

flow beneath the structure. This design reduces the risk of water damage and maintains the natural flow path.

- 2. Pailing fences on the western lot boundary to have a minimum clearance of 150 mm to allow the natural overland flow path through.
- 3. Proposed structures, located in the inundation area, are to be designed to resist flood forces including debris.
- 4. No additional solid structures be constructed around the property without further flood assessment.
- 5. Future use of lot areas to be limited to areas deemed safe under the ARR Disaster manual categories.
- 6. All future proposed structures within the flood extent not shown within this report will require a separate report addressing their impacts.

Stormwater infrastructure design under Section 14 of Urban Drainage Act and Council's Stormwater Management Policy

a. Stormwater Disposal Method Requirements:

All stormwater generated from the development will drain to stormwater systems by gravity. Therefore, 4 (a) is met.

b. Stormwater Quality Management Requirements:

The stormwater system will incorporate water sensitive urban design principles for the treatment and disposal of stormwater given the new impervious area is greater than 500m2. This will include four proprietary treatment device installed as an 'end of line' treatment, subjected to requirements stipulated by Council.

Therefore, 5 (b) is met.

c. Stormwater Quantity Management Requirements:

The development includes an underground on-site detention tank to manage post developed runoff to pre-developed levels for 5% AEP (1 in 20-year event)

Therefore, 6(a) is met.

d. Stormwater System Design Requirements:

The major stormwater system and the minor stormwater system have been demonstrated in Services report by Collective Consulting and flood report by Flussig Engineers.

Therefore 3 (a) and (b) are met.

Conclusion

In summary, I have no objections with the proposal from a hydraulics perspective, provided the recommended conditions are met.

WASTE MANAGEMENT REFERRAL

| DA No:. | PLN-24-270 | Date Referred: | 15/11/2024 |
|-----------------------------|-----------------|----------------------------|---------------|
| Planner: | Sylvia Jeffreys | To Be Returned By: | 22/11/2024 |
| Waste Management Rep: | Gaye Hunt | Date Returned: | 28/11/2024 |
| Property File No: | 9550943 | Discretionary Permitted | Discretionary |

| Details of | Applicant's Name: | Cunic Homes |
|---------------------------------------|-------------------------|---|
| Application: Business Contact Name: | | Domonee Van Heerden |
| | Contact Email: | dom@cunic.com.au |
| | Address of Development: | 168A Abbotsfield Road Claremont |
| | Proposal In Detail: | Twelve Multiple Dwellings and works in the road reserve (Residential) |

Waste Management Officer

Waste Services to the proposed twelve (12) multiple dwelling development at 168A Abbotsfield Rd Claremont would be Councils shared bin service, collected weekly. There will be a total number of twelve (12) \times 240L Shared Wheelie Bins.


The wheelie bins should be stored in a bin enclosure within the property boundary and are not to be taken to individual units. All shared wheelie bins should be placed on the kerbside for collection. This will be on Abbotsfield Road.


GPA - Attachment 1 15 Karambi Street Chigwell


Site Plan, Advertised Plans and TasWater Referral

Subject site: 15 Karambi Street, Chigwell
(Plan indicates portion of the subject site within a General Residential Zone)



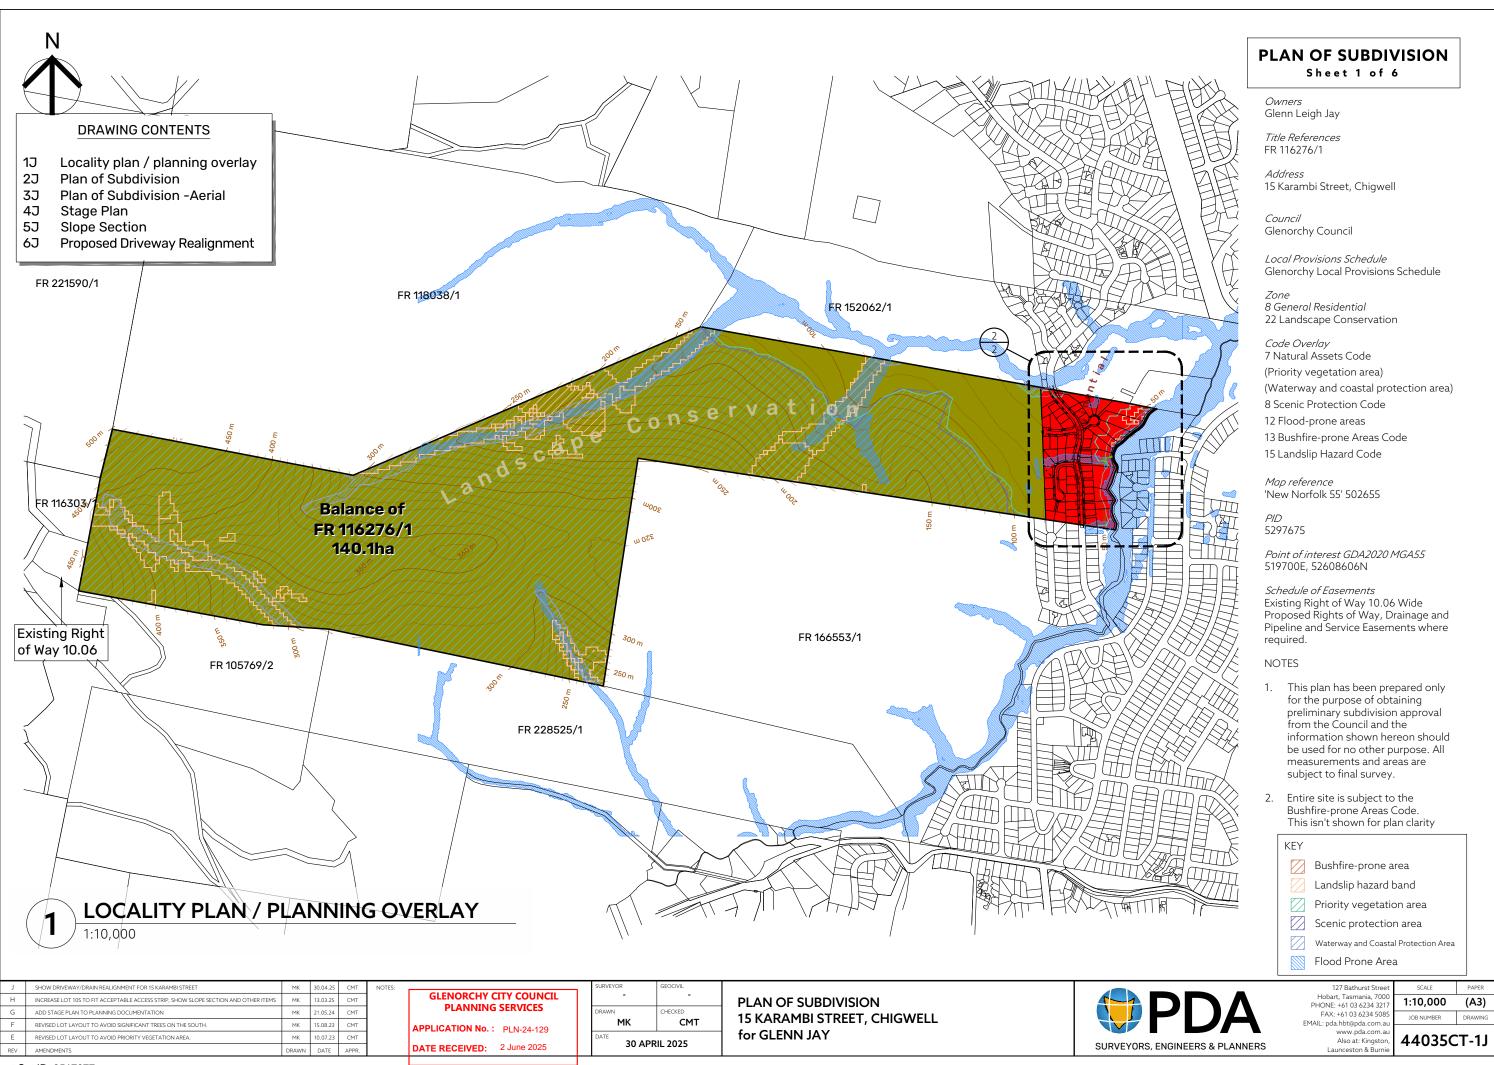

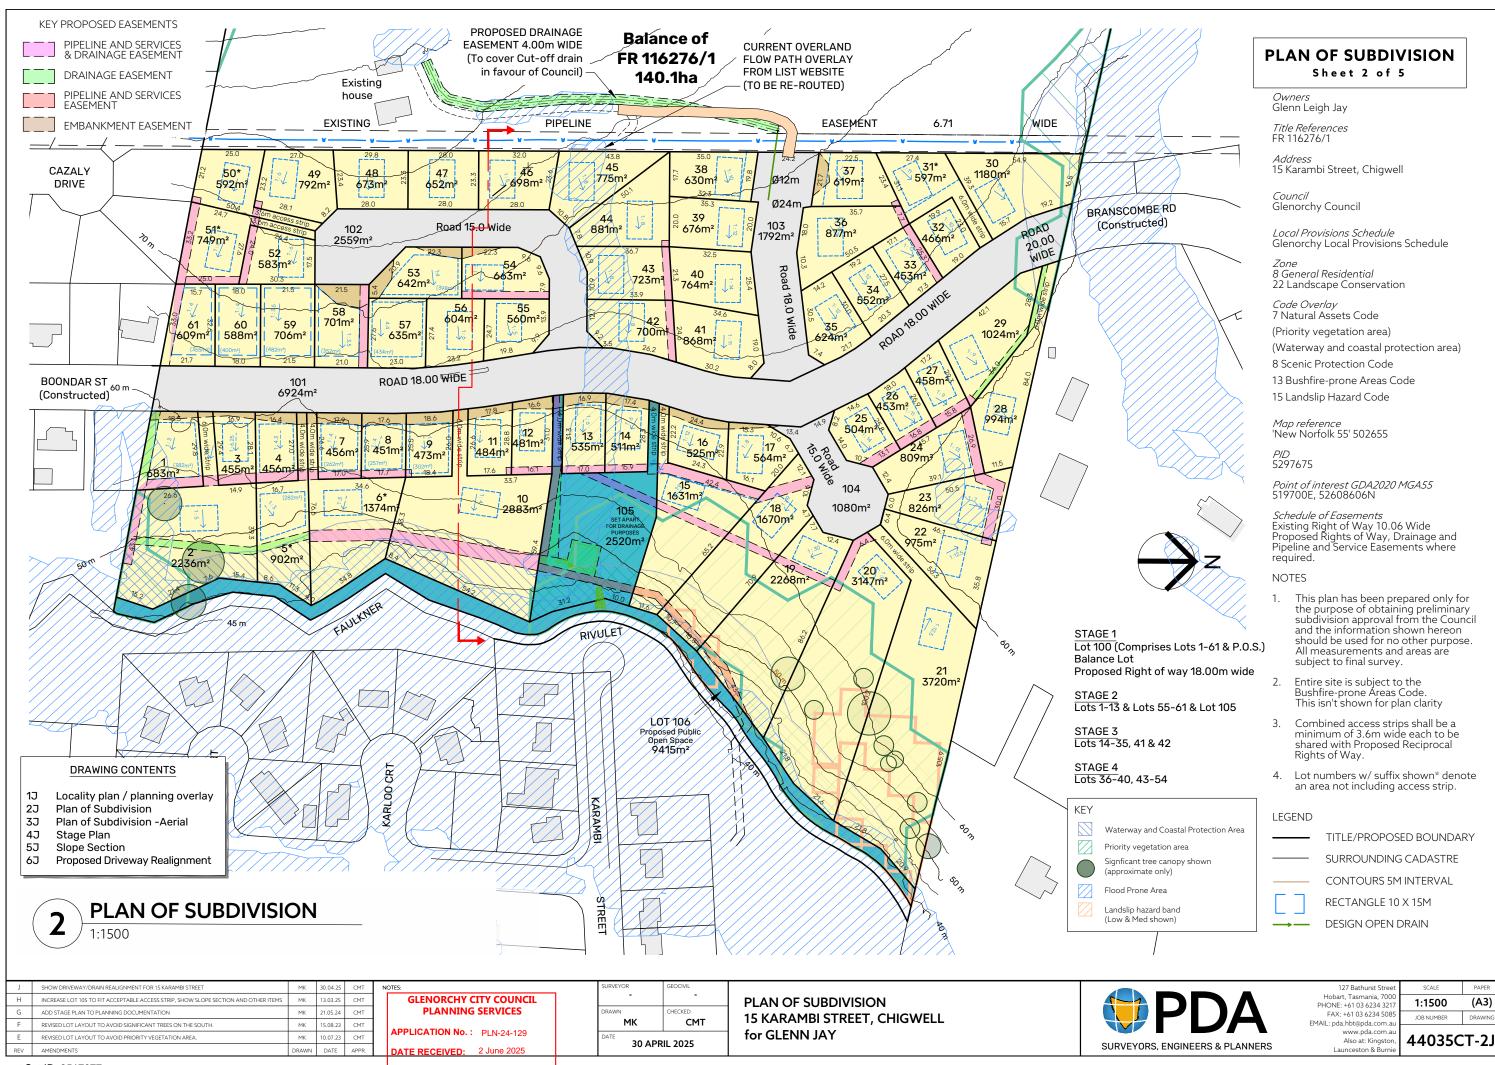

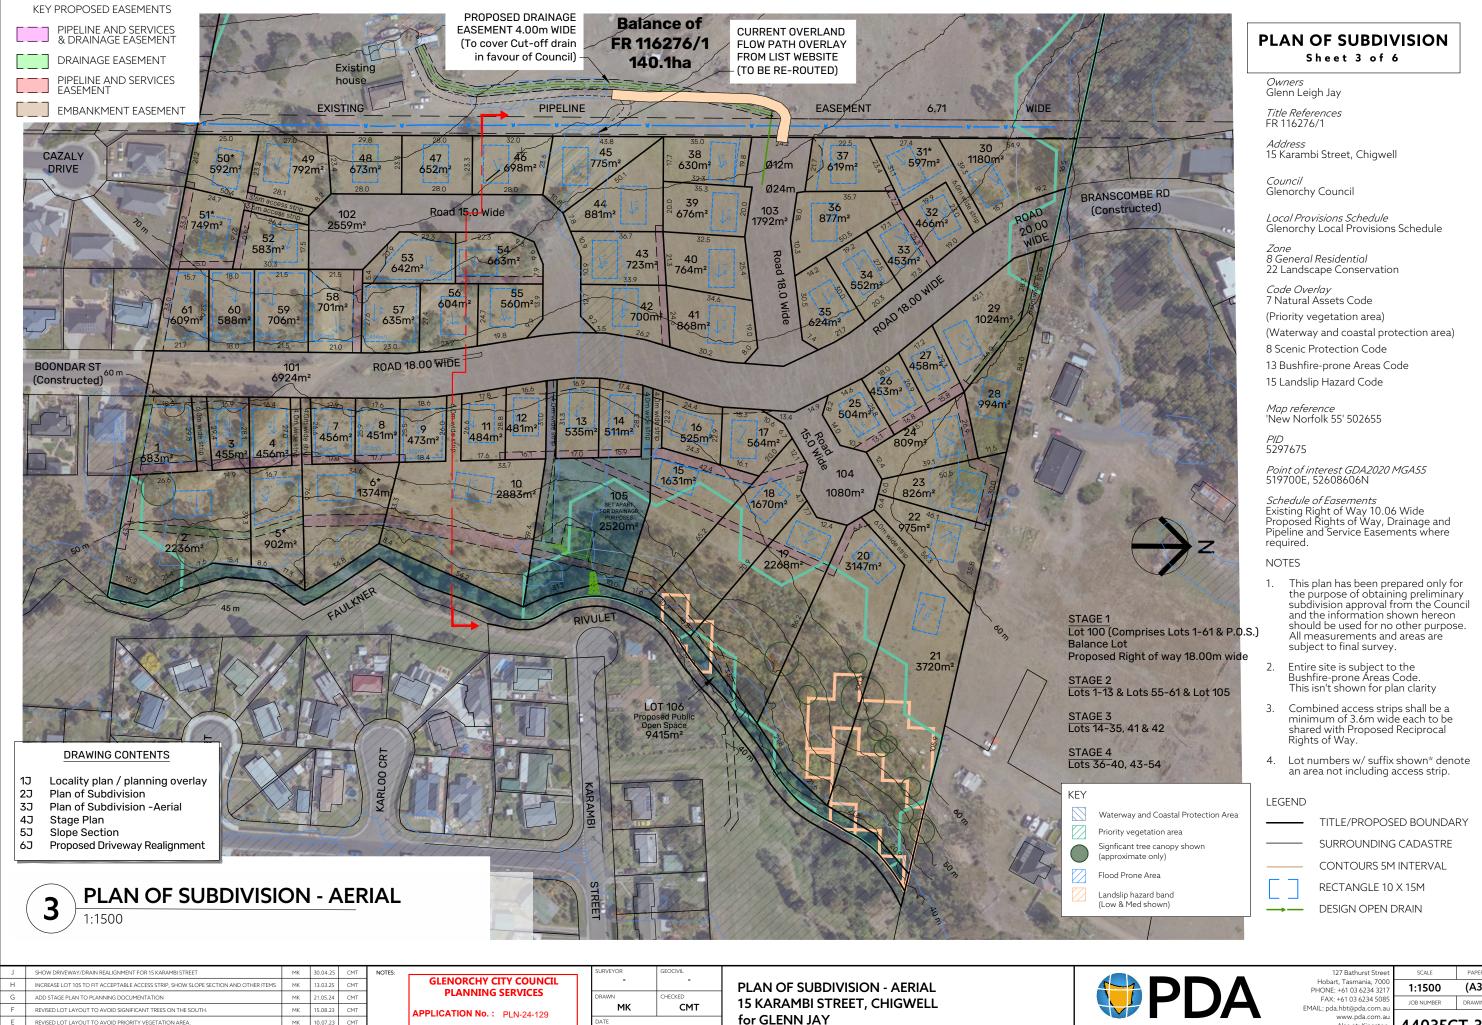


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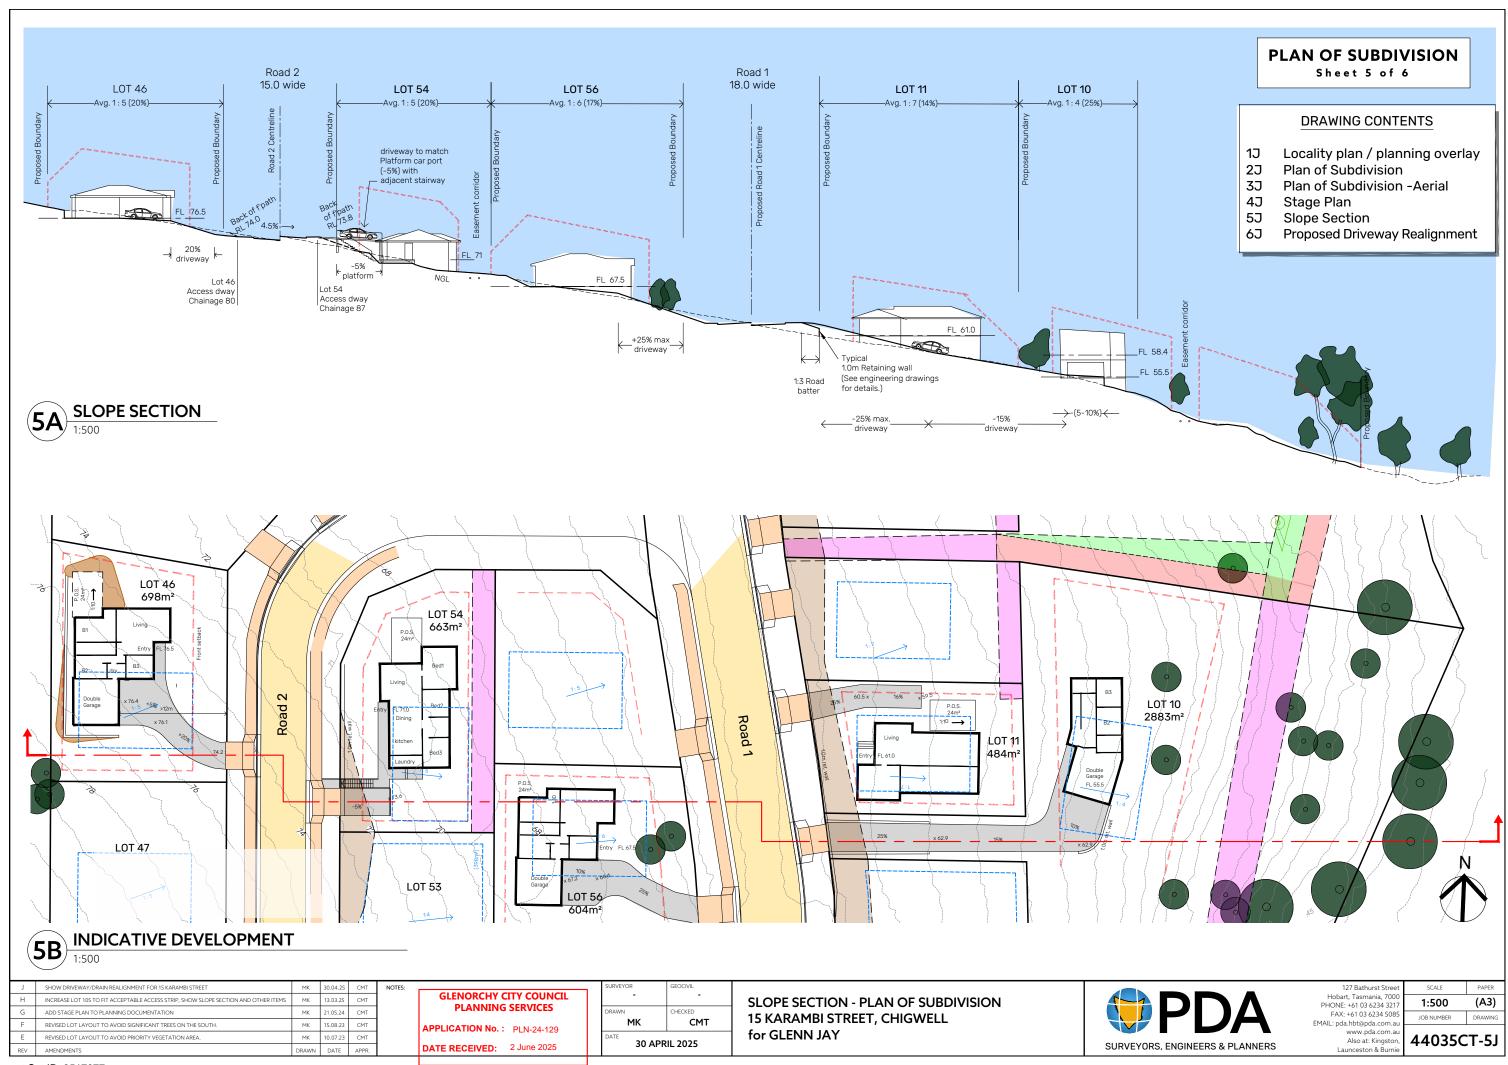
DATE RECEIVED: 2 June 2025


Document Set ID: 3517077 Version: 1, Version Date: 30/07/2025 SURVEYORS, ENGINEERS & PLANNERS

www.pda.com Also at: Kingst Launceston & Bu

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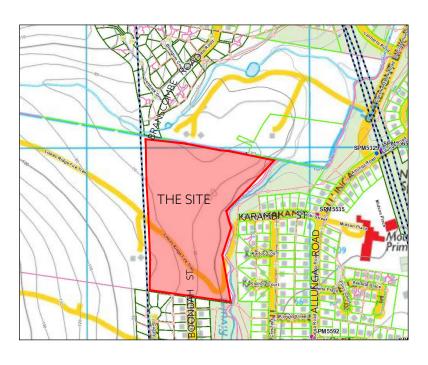


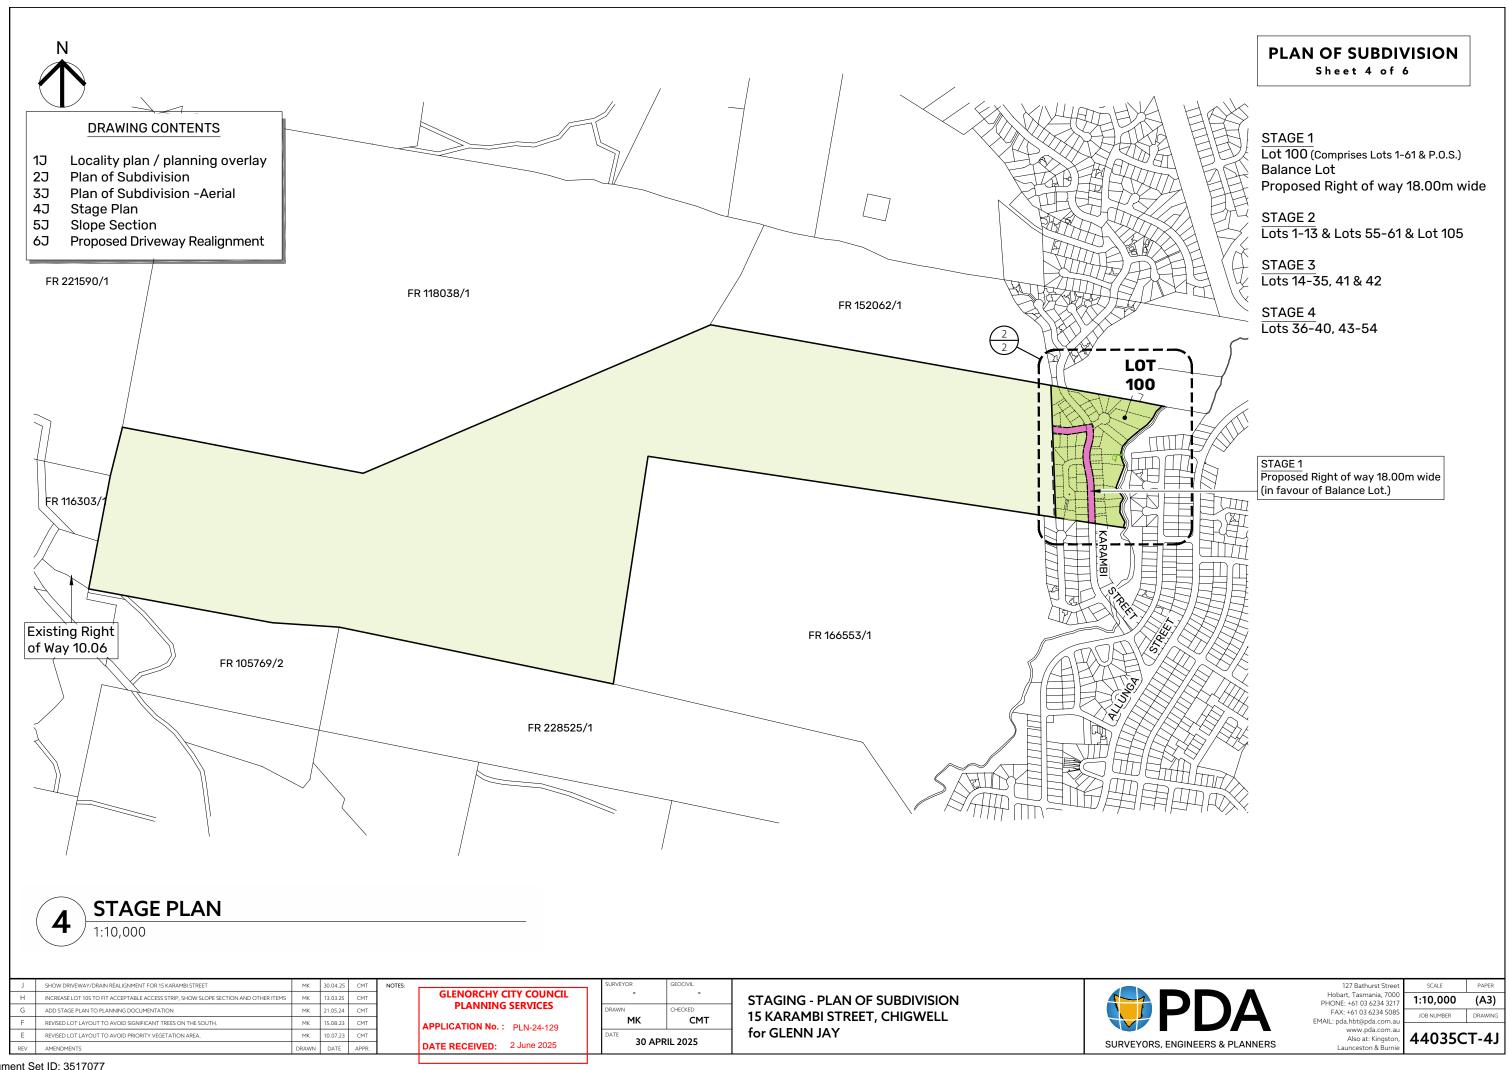

| DRAWING LIST | | | | | |
|----------------|--------------------------|--|--|--|--|
| DRAWING NUMBER | DRAWING TITLE | | | | |
| 001 | COVER SHEET | | | | |
| 002 | GENERAL NOTES | | | | |
| 005 | STAGING PLAN | | | | |
| 010 | OVERALL SITE PLAN | | | | |
| 020 | TYPICAL CROSS SECTIONS | | | | |
| 100-107 | ROAD & SERVICES PLANS | | | | |
| 200-205 | LONG SECTIONS ROADS 1-4 | | | | |
| 300-303 | CROSS SECTIONS ROAD 1 | | | | |
| 310-312 | CROSS SECTIONS ROAD 2 | | | | |
| 320-322 | CROSS SECTIONS ROAD 4 | | | | |
| 410-425 | STORMWATER LONG SECTIONS | | | | |
| 510-524 | SEWER LONG SECTIONS | | | | |
| 600-603 | WATER LONG SECTIONS | | | | |
| 700 | DETAILS | | | | |
| 800-803 | LIST WEBSITE OVERLAYS | | | | |
| 1000 | VEHICLE PATHS | | | | |

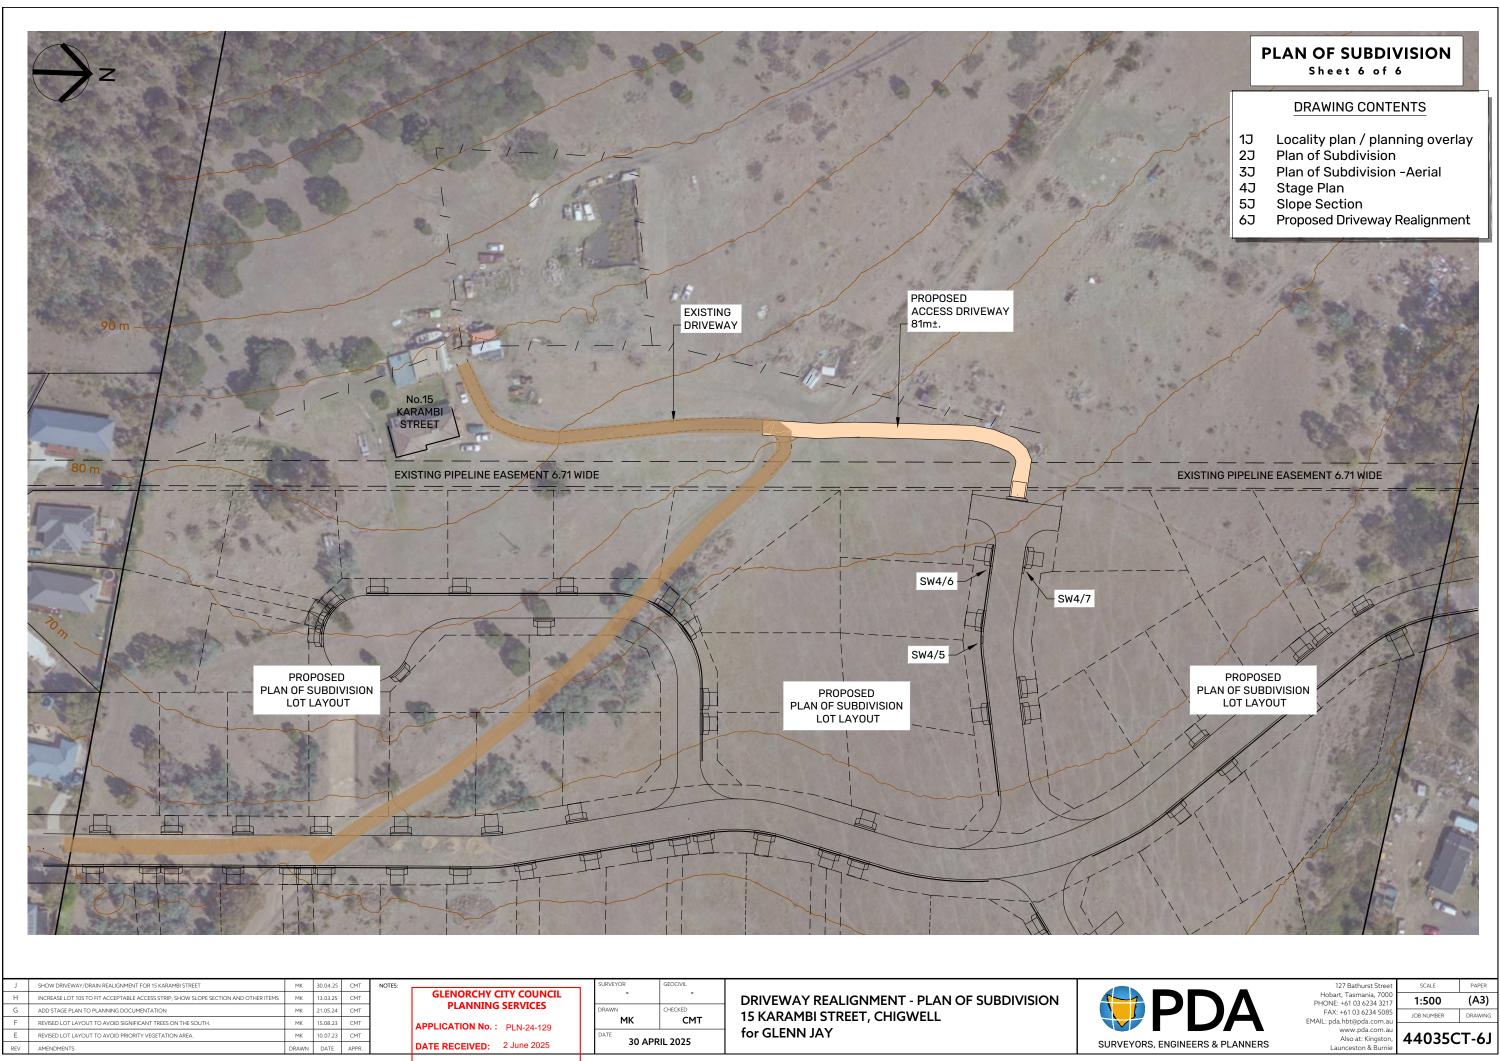GLENN JAY 61 LOT SUBDIVISION 15 KARAMBI STREET CHIGWELL, TAS, 7011





| GLENORCHY CITY COUNCIL | | | | | | |
|------------------------|--|-----------------------------|--|--|--|--|
| REV | DATE ISSUED | DESCRIPTION | | | | |
| P1 | 24/01/2024 | FOR DEVELOPMENT APPLICATION | | | | |
| P2 | 24/05/2024 | FOR DEVELOPMENT APPLICATION | | | | |
| P3 | 07/03/2024 FOR DEVELOPMENT APPLICATION | | | | | |
| P4 | 30/05/2025 | FOR DEVELOPMENT APPLICATION | | | | |
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| | TASWATER SUBMISSIONS | | | | | | | |
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| REV | DATE ISSUED DESCRIPTION | | | | | | | |
| P1 | - | FOR DEVELOPMENT APPLICATION | | | | | | |
| P3 | 07/03/2025 | FOR DEVELOPMENT APPLICATION | | | | | | |
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GLENORCHY CITY COUNCIL PLANNING SERVICES

APPLICATION No.: PLN-24-129

DATE RECEIVED: 2 June 2025

LOCALITY PLAN

| | PROJECT STATUS | | | | | | |
|-----|----------------|----------|---------------|---------------|----------------------|-----------------------|------------------------|
| REV | DATE ISSUED | DRAWN BY | AMENDED BY | CHECKED BY | CLIENT SUBMISSION | COUNCIL SUBMISSION | TASWATER SUBMISSION |
| P1 | 24-01-2024 | S.C. | - | M.S. | 24-01-2024 | 24-01-2024 | - |
| P2 | 24-05-2024 | S.C. | - | C.T. | 24-05-2024 | 24-05-2024 | |
| P3 | 07-03-2025 | SC | - | C.T. | - | 07-03-2025 | |
| P4 | 30-05-2025 | SC | - | C.T. | | 30-05-2025 | |
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| SC | MS | PROJECT DES |
| WN: | REVIEWED: | ADDRESS: |
| SC | MS | DRAWING TI |
| MANAGER: CRAIG | | |

GLENN JAY
61 LOT RESIDENTIAL SUBDIVISION
15 KARAMBI STREET, CHIGWELL, TAS
TITLE: COVER SHEET

| PDA | 12; Hobart, PHONE: + FAX: + EMAIL: pda.h w |
|---------------------------------|---|
| SURVEYORS, ENGINEERS & PLANNERS | A Laur |
| | |

| 127 Bathurst Street Hobart, Tasmania, 7000 | CONTRACT NO. | SCA | PAPER | |
|--|--------------|------------|-------|----------------|
| PHONE: +61 03 6234 3217 FAX: +61 03 6234 5085 | | 1: - | (A3) | |
| MAIL: pda.hbt@pda.com.au www.pda.com.au | JOB NUMBER | DISCIPLINE | SHEET | REVISION |
| Also at: Kingston, Launceston & Burnie | 44025CT | | 1 | DΛ |
| | 4403361 | | UUI | Г ' |

GENERAL NOTES:

- NO ATTEMPT HAS BEEN MADE TO LOCATE ALL SERVICES. ONLY THOSE SERVICES CONSPICUOUS DURING FIELD SURVEYS ARE SHOWN. PRIOR TO ANY DEMOLITION, EXCAVATION OR CONSTRUCTION ON THE SITE, THE RELEVANT AUTHORITY(S) SHOULD BE CONTACTED FOR POSSIBLE LOCATION OF FURTHER UNDERGROUND SERVICE AND DETAILED LOCATIONS OF ALL
- 2. ALL DIMENSIONS AND LOT SIZES SUBJECT TO FINAL SURVEY.
- 3. REFER IPWEA LGAT SPECIFICATIONS, TASMANIAN STANDARD DRAWINGS ISSUED - 03 DECEMBER 2020

TSD-G01.v3 - TRENCH REINSTATEMENT FLEXIBLE PAVEMENTS

TSD-G02.v3 - URBAN ROADS - TYPICAL SERVICE LOCATIONS

TSD-R01.v3 - RURAL ROADS UNSEALED

TSD-R02.v3 - RURAL ROADS SEALED

TSD-R03.v3 - RURAL ROADS - TYPICAL DRIVEWAY ACCESS

TSD-R04.v3 - RURAL ROADS - TYPICAL DRIVEWAY PROFILE

TSD-R05.v3 - TRUCK ACCESS TO RURAL PROPERTIES 'TYPE A' TSD-R06.v3 - URBAN ROADS - TYPICAL SECTIONS & PAVEMENT WIDTHS

TSD-R09.v3 - URBAN ROADS - DRIVEWAYS

TSD-R11.v3 - URBAN ROADS - FOOTPATHS

TSD-R12.v3 - SUB SOIL DRAINS - CONSTRUCTION DETAILS TSD-R13.v3 - SUBSOIL DRAINS PIT CONNECTION - TYPE FD

TSD-R14.v3 - CONCRETE KERBS & CHANNELS DIMENSIONS

TSD-R15.v3 - CONCRETE KERBS & CHANNELS CONSTRUCTION DETAILS

TSD-R16.v3 - CONCRETE KERBS & CHANNELS VEHICULAR CROSSINGS

TSD-R18.v3 - CONCRETE KERBS & CHANNELS ACCESS RAMPS

TSD-R26 v3 - DELINEATORS

TSD-R28.v3 - W-BEAM - INSTALLATION DETAILS

TSD-SW01.v3 - PIPE INSTALLATION ANCHOR BLOCKS

TSD-SW02.v3 - MANHOLES - 100-600 DIA. PIPES - GENERAL ARRANGEMENTS

TSD-SW03.v3 - MANHOLES - 100-600 DIA. PIPES - BENCHING DETAILS

TSD-SW09.v3 - SIDE ENTRY PITS - 'TYPE 3'

TSD-SW11.v3 - SIDE ENTRY PITS - KERB TRANSITIONS

TSD-SW15.v3 - STORMWATER - 'GP

TSD-SW17.v3 - OUTLET HEADWALLS 300 - 600 DIA PIPES

TSD-SW25.v3 - STORMWATER PROPERTY CONNECTIONS TO MAINS

TSD-SW26.v3 - SADDLE CONNECTION TO STORMWATER DRAIN TSD-SW27.v3 - REPAIRS/ NEW CONNECTION TO STORMWATER DRAIN

TSD-SW28.v3 - GUIDELINES FOR SEDIMENT CONTROL

TSD-RF04.v3 - NATURE STRIP DETAILS

- 4. CONSTRUCTION TO COMPLY WITH WSAA SEWERAGE CODE OF AUSTRALIA (MELBOURNE RETAIL WATER AGENCIES EDITION) - WSA 02-2014-3.1 v3 AND TASWATER SUPPLEMENT TO THE CODE
- 5. ALL WORKS TO BE CONSTRUCTED IN ACCORDANCE WITH THE TASMANIAN SUBDIVISION GUIDELINES (VERSION 1.0, DATED OCTOBER 2013) UNLESS
- 6. ALL CONNECTIONS TO EXISTING SEWER AND WATER MAINS TO BE CARRIED OUT BY TASWATER OR APPROVED CONTRACTOR AT DEVELOPER'S COST UNLESS APPROVED OTHERWISE.

SURVEY NOTES:

- CONCEPT PROJECT FOR DEVELOPMENT APPLICATION HAS BEEN DESIGNED WITH A COMBINATION OF LIDAR SURVEY AND DETAILED SURVEY
- DETAILED SURVEY DATUM: AHD PLANAR OR GRID: PLANAR SITE CONTROL: **GPS** SURVEYED BY: PDA ACCURACY OF SURVEY: 0.02m ACCURACY/STATUS OF EXISTING & FUTURE PROPERTY BOUNDARIES: 1.0m

GLENORCHY CITY COUNCIL PLANNING SERVICES

APPLICATION No.: PLN-24-129 DATE RECEIVED: 2 June 2025

ROADS & STORMWATER NOTES:

- ALL STORMWATER LOT CONNECTIONS TO BE DN150 UNLESS OTHERWISE NOTED.
- ALL STORMWATER LINES DN300 PVC-U SN8 OR EQUIVALENT UNLESS NOTED OTHERWISE
- ALL FOOTPATHS TO BE N25 CONCRETE 100mm THICK, SL72 CENTRAL, 100 x 20 FCR BASE.
- 4. 2 x 65 DIA WEEPHOLES TO BE PLACED IN ALL STORMWATER SIDE ENTRY PITS AND MANHOLES WITH NO SUBSOIL DRAIN CONNECTIONS
- ALL STORMWATER BRANCHES TO TERMINATE AT PROPERTY BOUNDARIES WITH AN INSPECTION OPENING RAISED TO SURFACE WITH AN APPROVED COVER 1m INSIDE PROPERTY BOUNDARY.
- 6. ALL LOT CONNECTIONS TO BE CONSTRUCTED IN THE POSITION SHOWN UNLESS APPROVED BY THE SUPERINTENDENT.
- FINAL POSITION AND WIDTH OF ALL DRAINAGE EASEMENTS IS TO BE DETERMINED FOLLOWING CONSTRUCTION.
- 8. EXTENT OF ROADWORKS SHOWN SHADED.
- 9. ALL FILL AREAS TO BE PLACED AND COMPACTED PRIOR TO TRENCH EXCAVATION.
- 10.PROVIDE TRAFFICABLE LIDS TO CONNECTIONS IN TRAFFICABLE AREAS INCLUDING DRIVEWAYS.
- 11. ALL DRIVEWAYS TO HAVE MAXIMUM GRADE 20% OUTSIDE LOT BOUNDARIES AND 25% INSIDE LOT BOUNDARIES AND CONSTRUCTED AS PER TSD-R09 V3.
- 12. PROVIDE MINIMUM 150mm CLEARANCE FROM TOP OF ROD EYES TO SURFACE COVER LID.

STORMWATER LONG SECTION NOTES:

THE INTEGRITY OF THE PIPE IS MAINTAINED.

- 1. ALL EXCAVATION OVER 1.5m IN DEPTH MUST BE CARRIED OUT IN ACCORDANCE WITH WORKPLACE SAFETY STANDARDS CODE OF PRACTICE FOR EXCAVATION WORK.
- 2. COMPACTED FCR BACKFILL UNDER ROADS & DRIVEWAYS ALL ANCHOR BLOCKS (CONCRETE BULKHEADS) ARE TO BE KEYED INTO UNDISTURBED, COMPETENT MATERIAL TO ENSURE THE MIGRATION OF BEDDING AND BACKFILL MATERIAL IS REDUCED AND
- 4. TRENCHES >10% ARE TO HAVE CONTINUOUS DRAINAGE PATH INSTALLED TO ENSURE WATER THAT HAS MIGRATED INTO THE TRENCH IS CARRIED TO THE RETICULATED SYSTEM. REFER TSD-SW01.
- 5. ALL FILL TO BE PLACED & COMPACTED PRIOR TO TRENCH **FXCAVATION**
- 6. FILL IN EXCESS OF 300mm DEPTH TO BE COMPACTED TO 95% STANDARD DENSITY (AS 1289E4.01) IN 150mm MAX LAYERS.
- PROVIDE MINIMUM 150mm CLEARANCE FROM TOP OF ROD EYES TO SURFACE COVER LID.

NATURE STRIP NOTES:

- 1. APPLY 100mm THICK 20mm SCREENED LOAM TO NATURE STRIP & APPLY GRASS SEED AS PER TSD-RF04-v3.
- 2. NATURE STRIPS TO BE WATERED & MAINTAINED INCLUDING WEED REMOVAL & MOWING THROUGHOUT THE MAINTENANCE PERIOD.
- FOR FILL BATTERS, BENCH AS SHOWN AND PLACE APPROVED FILL IN 300mm LAYERS COMPACTED TO 95% MAX DRY DENSITY. FILL TO BE PLACED & COMPACTED PRIOR TO TRENCH EXCAVATION.
- 4. MATERIAL TO BE PLACED AND COMPACTED UNIFORMLY IN LAYERS ACROSS THE EMBANKMENT NO GREATER THAN 300mm TO ACHIEVE 95% MDD. FOR FILL BATTERS, BENCH AS

ENGINEERED FILL NOTES:

- FILL MATERIAL FOR NEW ROAD AND FILL EMBANKMENTS MUST NOT CONTAIN ORGANIC OR OTHER MATERIALS THAT DECOMPOSE OR OTHERWISE LEAD TO LONG TERM SETTLEMENT AND TO BE APPROVED BY SUPERINTENDENT BEFORE USE.
- MATERIAL TO BE PLACED AND COMPACTED UNIFORMLY IN LAYERS UNDER NEW ROAD NO GREATER THAN 150mm TO ACHIEVE 98% MDD AND ACROSS ROAD EMBANKMENT NO GREATER THAN 300mm TO ACHIEVE 95% MDD. FOR FILL BATTERS, BENCH AS SHOWN.
- ROAD EMBANKMENT TO BE FULLY CONSTRUCTED PRIOR TO TRENCHING FOR WATER AND SEWER SERVICES.
- 4. FILL TO BE PLACED & COMPACTED PRIOR TO TRENCH EXCAVATION.

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SITE FILLING THAT EXCEEDS A DEPTH OF 300mm MUST BE PLACED IN ACCORDANCE WITH THE AS3798 GUIDELINES FOR COMMERCIAL AND RESIDENTIAL DEVELOPMENTS 1996, UPON COMPLETION OF THE WORKS THE CONTRACTORS GEOTECHNICAL ENGINEER MUST CONFIRM IN WRITING THAT THE WORKS HAVE BEEN CARRIED OUT IN ACCORDANCE WITH AS3798.

SEWER NOTES:

- ALL SEWER MAINS TO BE DN150 PVC-U 'SN8' (SWJ) U.N.O.
- CONNECTION TO EXISTING SEWER MAIN BY TASWATER AT DEVELOPER'S
- ALL SEWER WORKS MUST BE PRESSURE TESTED AND INSPECTED BY TASWATER PRIOR TO BACKFILL OR CONSTRUCTION OF MANHOLE BASES.
- ALL SEWER LOT CONNECTIONS TO BE DN100 WITH SEWER INSPECTION OPENINGS (PROPERTY SEWER CONNECTION POINTS) TO SURFACE LEVEL AS PER STANDARD DRAWING MRWA-S-301 OF SEWERAGE CODE OF AUSTRALIA, PER TASWATER'S SUPPLEMENT TO THE CODE.
- CONCRETE BULKHEADS MUST BE IN ACCORDANCE WITH MRWA-S-206. INTERNAL DROP MANHOLE IN ACCORDANCE WITH MRWA-S-311.
- ALL FILL AREAS TO BE PLACED AND COMPACTED PRIOR TO TRENCH
- **EXCAVATION** ALL FILLED AREAS OVER EXISTING SEWER MAINS TO BE DISCUSSED AND
- DETAIL APPROVED BY TASWATER PRIOR TO CONSTRUCTION. THE CONTRACTOR SHALL NOT VARY THE POSITION OF ANY LOT
- CONNECTION WITHOUT PRIOR APPROVAL FROM THE SUPERINTENDENT.
- 10. PROVIDE MINIMUM 150mm CLEARANCE FROM TOP OF INSPECTION SHAFTS TO SURFACE COVER LID.
- 11. SEWER LOT CONNECTIONS TO BE A MAXIMUM OF 1.5m BELOW THE FINISHED SURFACE LEVEL OF THE LOT WHERE POSSIBLE.
- 12. PIPES TO BE SURVEYED PRIOR TO BACKFILLING.

SEWER LONG SECTION NOTES:

- ALL EXCAVATION OVER 1.5m IN DEPTH MUST BE CARRIED OUT IN ACCORDANCE WITH WORKPLACE STANDARDS CODE OF PRACTICE FOR **EXCAVATION WORK**
- ALL ANCHOR BLOCKS (CONCRETE BULKHEADS) ARE TO BE KEYED INTO UNDISTURBED, COMPETENT MATERIAL TO ENSURE THE MIGRATION OF BEDDING AND BACKFILL MATERIAL IS REDUCED AND THE INTEGRITY OF THE
- TRENCHES >15% ARE TO HAVE CONTINUOUS DRAINAGE PATH INSTALLED TO ENSURE WATER THAT HAS MIGRATED INTO THE TRENCH IS CARRIED TO THE RETICULATED SYSTEM. REFER SEW-1206, SEW-1207.
- ALL FILL TO BE PLACED & COMPACTED PRIOR TO TRENCH EXCAVATION.
- FILL IN EXCESS OF 300mm DEPTH TO BE COMPACTED TO 95% STANDARD DENSITY (AS 1289E4.01) IN 150mm MAX LAYERS.
- PROVIDE MINIMUM 150mm CLEARANCE FROM TOP OF INSPECTION SHAFTS TO SURFACE COVER LID.
- SEWER LOT CONNECTIONS TO BE A MAXIMUM OF 1.5m BELOW THE FINISHED SURFACE LEVEL OF THE LOT WHERE POSSIBLE.
- TRENCHES STEEPER THAN 10% TO HAVE CEMENT STABILIZED FCR EMBEDMENT - REFER TO SEWER LONG SECTIONS.

WATER NOTES:

- 1. ALL WATER LOT CONNECTIONS TO BE DN25 PE100 PN16 PIPE (UNO) WITH AN INDIVIDUAL 20mm NOMINAL DIAMETER METER WITH INTEGRAL DUAL CHECK VALVE AND GATE VALVE WITHIN A PVC BOX AS PER TWS-W-0002 SERIES.
- ALL DICL MUST HAVE A POLYETHELENE SLEEVE AS PER CITY WEST WATER APPROVED PRODUCTS CATALOGUE AND TO HAVE POLYETHYLENE WRAP PFR AS3680
- THRUST BLOCK TO BE PROVIDED AT ALL BENDS, TEES & DEAD END AS PER MRWA-W-204.
- ALL WATER WORKS MUST BE PRESSURE TESTED AND INSPECTED BY TASWATER PRIOR TO BACKFILL.
- SUPPLY & INSTALL ROAD HYDRANT MARKERS IN ACCORDANCE WITH SECTION 8 OF THE INSTITUTE OF MUNICIPAL ENGINEERING AUSTRALIA'S TASMANIA DIVISION DOCUMENT TITLED "FIRE HYDRANT GUIDELINES". MINIMUM COVER TO BE 600mm AND MAXIMUM 900mm UNDER TRAFFICABLE
- MAXIMUM ALLOWABLE JOINT DEFLECTION IS $\frac{3}{4}$ OF MANUFACTURERS MAXIMUM ALLOWABLE JOINT DEFLECTION HORIZONTALLY & VERTICALLY.
- ALL FITTINGS TO BE COMPATIBLE WITH OPVC PN16 PIPEWORK, MINIMUM CLASS 16.
- ALL FILL AREAS TO BE PLACED AND COMPACTED PRIOR TO TRENCH EXCAVATION.
- 10. FILL MATERIAL FOR NEW ROAD AND FILL EMBANKMENTS MUST NOT CONTAIN ORGANIC OR OTHER MATERIALS THAT DECOMPOSE OR OTHERWISE LEAD TO LONG TERM SETTLEMENT AND TO BE APPROVED BY SUPERINTENDENT BEFORE USE MATERIAL TO BE PLACED AND COMPACTED UNIFORMLY IN LAYERS ACROSS THE EMBANKMENT NO GREATER THAN 300mm TO ACHIEVE 95% MDD. FOR FILL BATTERS, BENCH AS SHOWN. ROAD EMBANKMENT TO BE FULLY CONSTRUCTED PRIOR TO TRENCHING FOR WATER AND SEWER SERVICES
- 11. METALLIC WARNING TAPE TO BE INSTALLED ABOVE WATER PIPES.
- 12. PIPES TO BE SURVEYED PRIOR TO BACKFILLING.

SWMP NOTES:

- 1. REFER BEST PRACTICE EROSION & SEDIMENT CONTROL BOOKLET 2022 -"EROSION AND SEDIMENT CONTROL". AVAILABLE AT www.derwentestuary.org.au/publications
- AREAS OF GROUND DISTURBANCE ARE SHOWN. WORKS TO BE CONFINED TO WITHIN THESE AREAS. CLEARING FOR WORKS TO BE LIMITED TO WITHIN 5 METRES FROM THE EDGE OF ANY ESSENTIAL CONSTRUCTION ACTIVITY. (REFER PAGES 34 & 35: MINIMISE SOIL DISTURBANCE).
- ALL EXCAVATION IS TO COMPLY WITH "BEST PRACTICE EROSION & SEDIMENT CONTROL BOOKLET 2022 - "EROSION AND SEDIMENT CONTROL'." $AVAILABLE\ AT\ www.derwentestuary.org.au/publications$
- EXCAVATION TO BE CARRIED OUT OVER A MINIMUM TIME PERIOD. TOP SOIL TO BE STOCKPILED SEPARATELY AND SPREAD OVER BACKFILLED AREAS. SOIL TO BE STOCKPILED IN A NARROW CORRIDOR ON THE UPSTREAM SIDE OF ALL EXCAVATION. TEMPORARY CATCH DRAINS TO BE CONSTRUCTED ON THE UPSTREAM SIDE OF STOCKPILES AND EXCAVATED AREAS, DIRECTING RUNOFF TO EXISTING STORMWATER SYSTEM. (REFER PAGE 47: PROTECT STOCKPILES AND SERVICE TRENCHES)
- SEDIMENT FENCES & FIBRE ROLLS TO BE USED ON THE DOWNSTREAM SIDE OF ALL STOCKPILES AND TO EXTENTS SHOWN ON THIS DRAWING. PREVENT ENTRY OF SILT TO EXISTING STORMWATER INLETS AND WATER COURSES DURING CONSTRUCTION. (REFER PAGE 67: SEDIMENT FENCES).
- EVERY EFFORT TO BE MADE TO MINIMIZE SPREADING SEDIMENT ON TO SEALED AREAS WHEN VEHICLES LEAVE THE SITE, INCLUDING THE WASHING DOWN OF TYRES, (REFER PAGE 59: WHEEL WASH OR RUMBLE GRID).
- NO TOPSOIL SHALL BE REMOVED FROM LAND OUTSIDE THE AREAS OF GROUND DISTURBANCE SHOWN.
- ALL AREAS OF GROUND DISTURBANCE TO BE RE-VEGETATED
- ALL STOCKPILES TO BE POSITIONED CLEAR OF WATER COURSES AND TO ENSURE THAT NO SILT RUNOFF CAN ENTER WATER COURSES.
- 10. DURING WINDY CONDITIONS AND/OR HOT WEATHER, WET DOWN EXPOSED SOIL SLIGHTLY & REGULARLY TO PREVENT DUST NUISANCE. (REFER PAGE 53: CONTROL DUST AND LITTER) PRIOR TO PRACTICAL COMPLETION OF EACH APPROVED CONSTRUCTION
- STAGE, ALL DISTRIBUTED SURFACES ON THE SITE, EXCEPT THE AREAS SET ASIDE FOR ROADWAYS & FOOTPATHS, MUST BE DRESSED TO A MINIMUM OF 50mm WITH:
- APPROVED LOCAL STOCKPILED TOPSOIL
- APPROVED WEED FREE IMPORTED TOPSOIL
- RE-VEGETATED WITH LOCAL PLANTS & GRASSES AND STABILISED.

WEED MANAGEMENT NOTES:

- ALL AREAS WITHIN COMPLETED STAGES WHERE TOPSOIL HAS BEEN SPREAD SHOULD BE MONITORED FOR SERRATED TUSSOCK AND TREATED AS REQUIRED
- EQUIPMENT MOVEMENT SHOULD BE RESTRICTED TO THE DEVELOPMENT FOOTPRINT. NOTE: TRACKED EQUIPMENT MOVING ACROSS WEED INFESTED COUNCIL LAND HAS HIGH RISK OF PICKING UP WEED SEED AND/OR SPREADING TO COUNCIL LAND.
- CONTINUE TO ENSURE WASH DOWN LEDGER IS SUBMITTED TO COUNCIL TO DEMONSTRATE WHEN EQUIPMENT IS CLEANED PRIOR TO MOVING OFF SITE.
- SEDIMENT TRAP SHOULD BE MONITORED FOR EMERGING WEEDS AND SEDIMENT DEEP BURIED AT END OF EACH STAGE PARTICULARLY IF EQUIPMENT HAS BEEN MOVED OFF SITE AND WASH DOWN WILL NOT BE USED IN MID TO LONG TERM.
- TRUCKS AND EQUIPMENT SHOULD BE CLEAN PRIOR TO COMING TO SITE IF THEY ARE TO LEAVE THE HARDENED SURFACE WHILE ON SITE. ANY VEHICLES/EQUIPMENT THAT LEAVE FORMED ROADS MUST BE CLEANED PRIOR TO LEAVING THE SITE AND A RECORD KEPT IN THE WASH DOWN LEDGER. HYGIENE MEASURES PRIOR TO LEAVING & ENTERING THE SITE TO COMPLY WITH THE TASMANIAN WASHDOWN GUIDELINES FOR WEED & DISEASE CONTROL.
- THE WASH DOWN LEDGER DOCUMENTING LICENCE PLATE NUMBERS OF ALL VEHICLES, TRUCKS AND EQUIPMENT SHOULD BE SUBMITTED TO COUNCIL TWICE PER YEAR (AS A MINIMUM) TO DEMONSTRATE WHEN EQUIPMENT IS CLEANED/LEAVING THE SITE. WASH DOWN LEDGER MUST BE REGULARLY SUBMITTED TO COUNCIL
- CONFINE DISTURBANCE OF TOPSOIL AND EARTHWORK TO A MINIMUM CORRIDOR STRIP ROAD CORRIDORS FIRST, THEN CONFINE MOVEMENTS OF WORKS
- VEHICLES TO THE FUTURE ROAD CORRIDORS, WHERE POSSIBLE ESTABLISH A STABILISED ENTRANCE AND WASHDOWN AREA JUST INSIDE THE
- WORKS BOUNDARY, IN ACCORDANCE WITH DRAWING. 10. ALL VEHICLES LEAVING THE SITE TO BE CLEANED AND WASHED DOWN PRIOR
- TO EXIT. 11. PRIVATE VEHICLES SHOULD NOT BE PARKED WITHIN THE SITE.
- 12. STOCKPILE AREAS TO BE PLACED CLOSE TO THE SITE ENTRANCE WHERE POSSIBLE
- 13. WARNING SIGNAGE IS TO BE PLACED AT THE VEHICLE WASHDOWN BAY STATING THE NEED FOR ALL VEHICLES TO WASHDOWN PRIOR TO LEAVING THE SITE
- 14 ANY IMPORTED FILL MATERIALS MUST BE SOURCED FROM OUARRIES ARI F TO PROVIDE DOCUMENTATION AS TO THE WEEDS PRESENT ON THE SOURCE SITE IN ORDER TO MINIMISE THE INTRODUCTION OF NEW WEEDS AND PATHOGENS TO THE AREA



SSUED DATE: 30/05/2025





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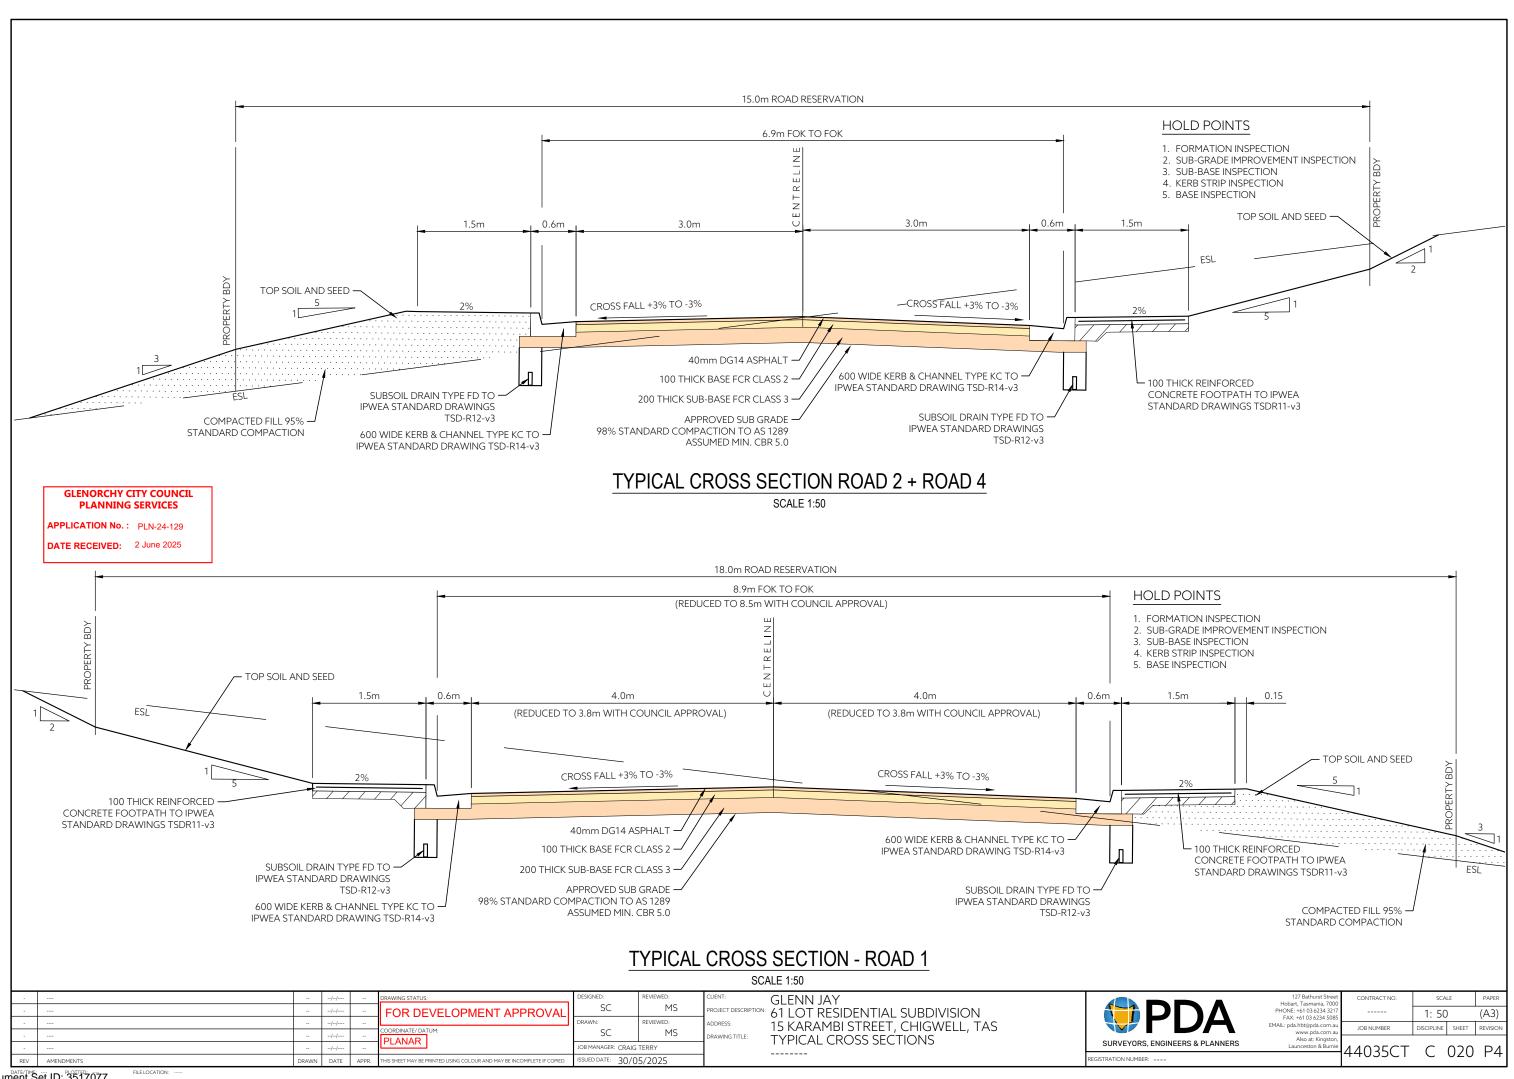
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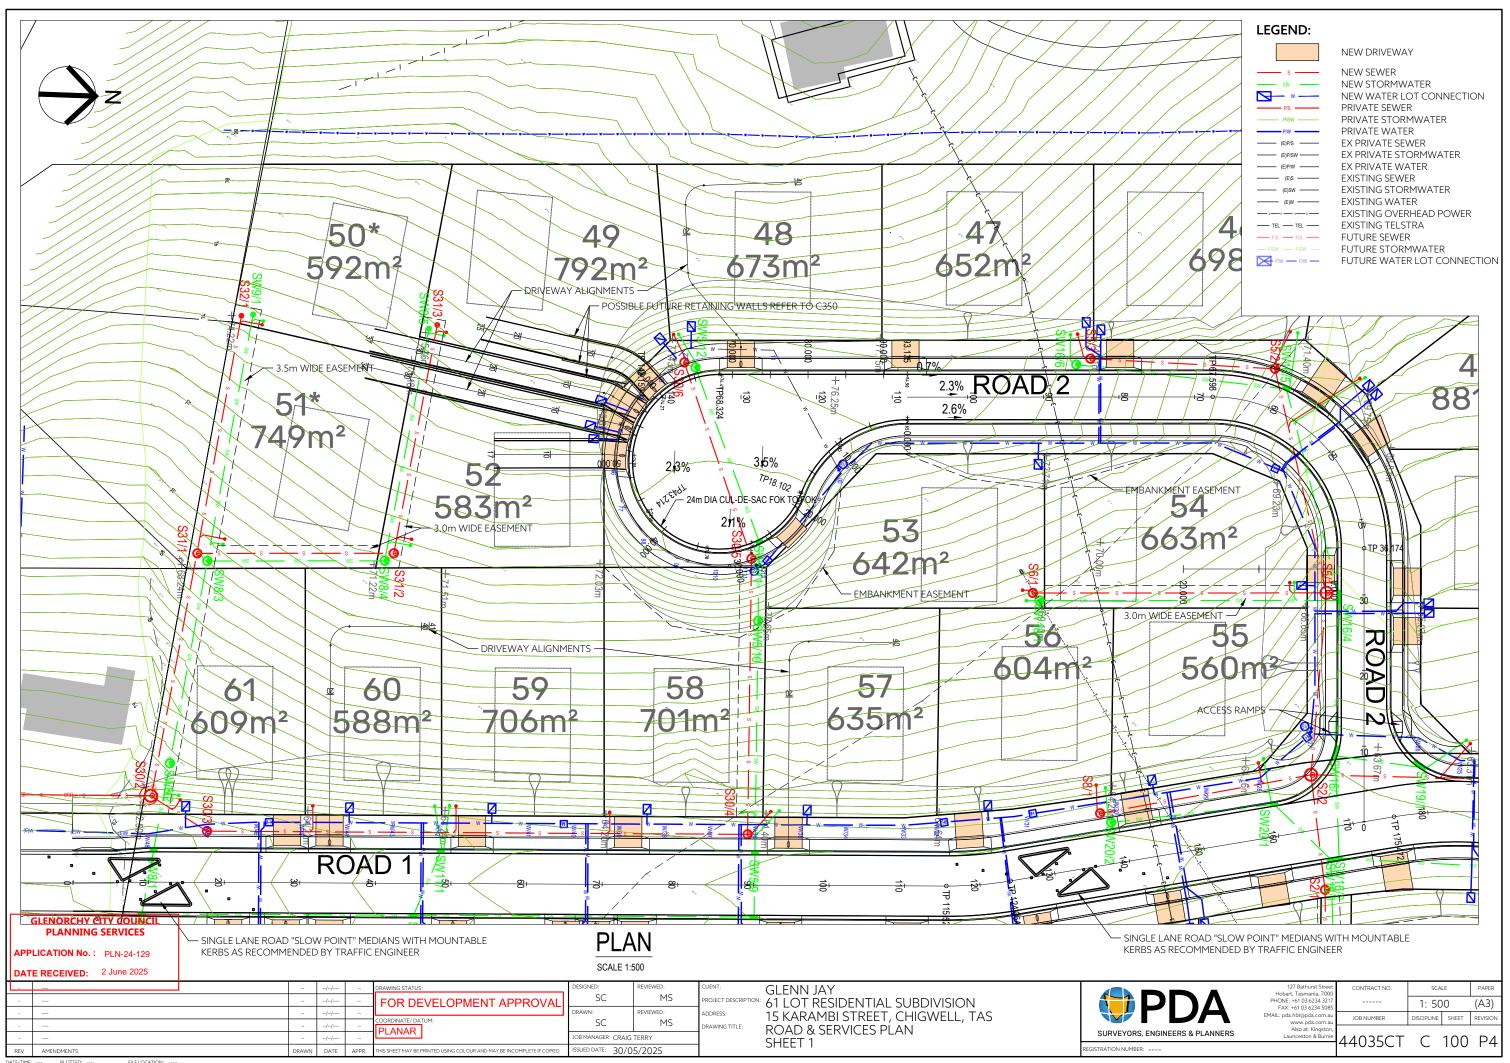
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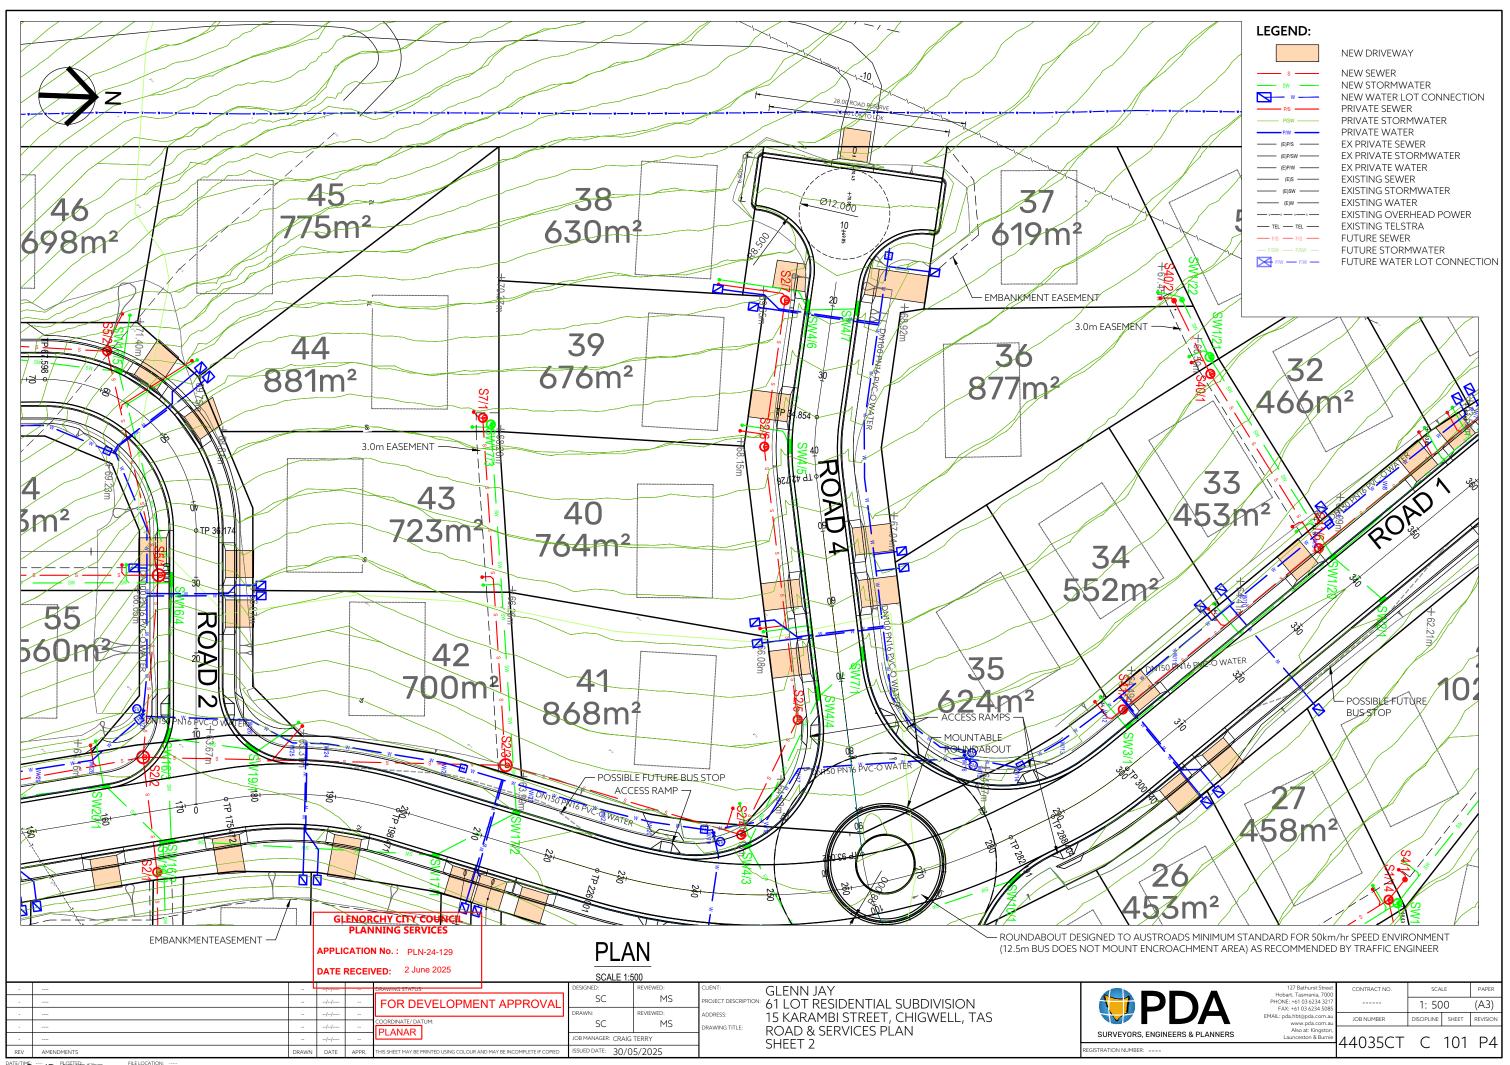
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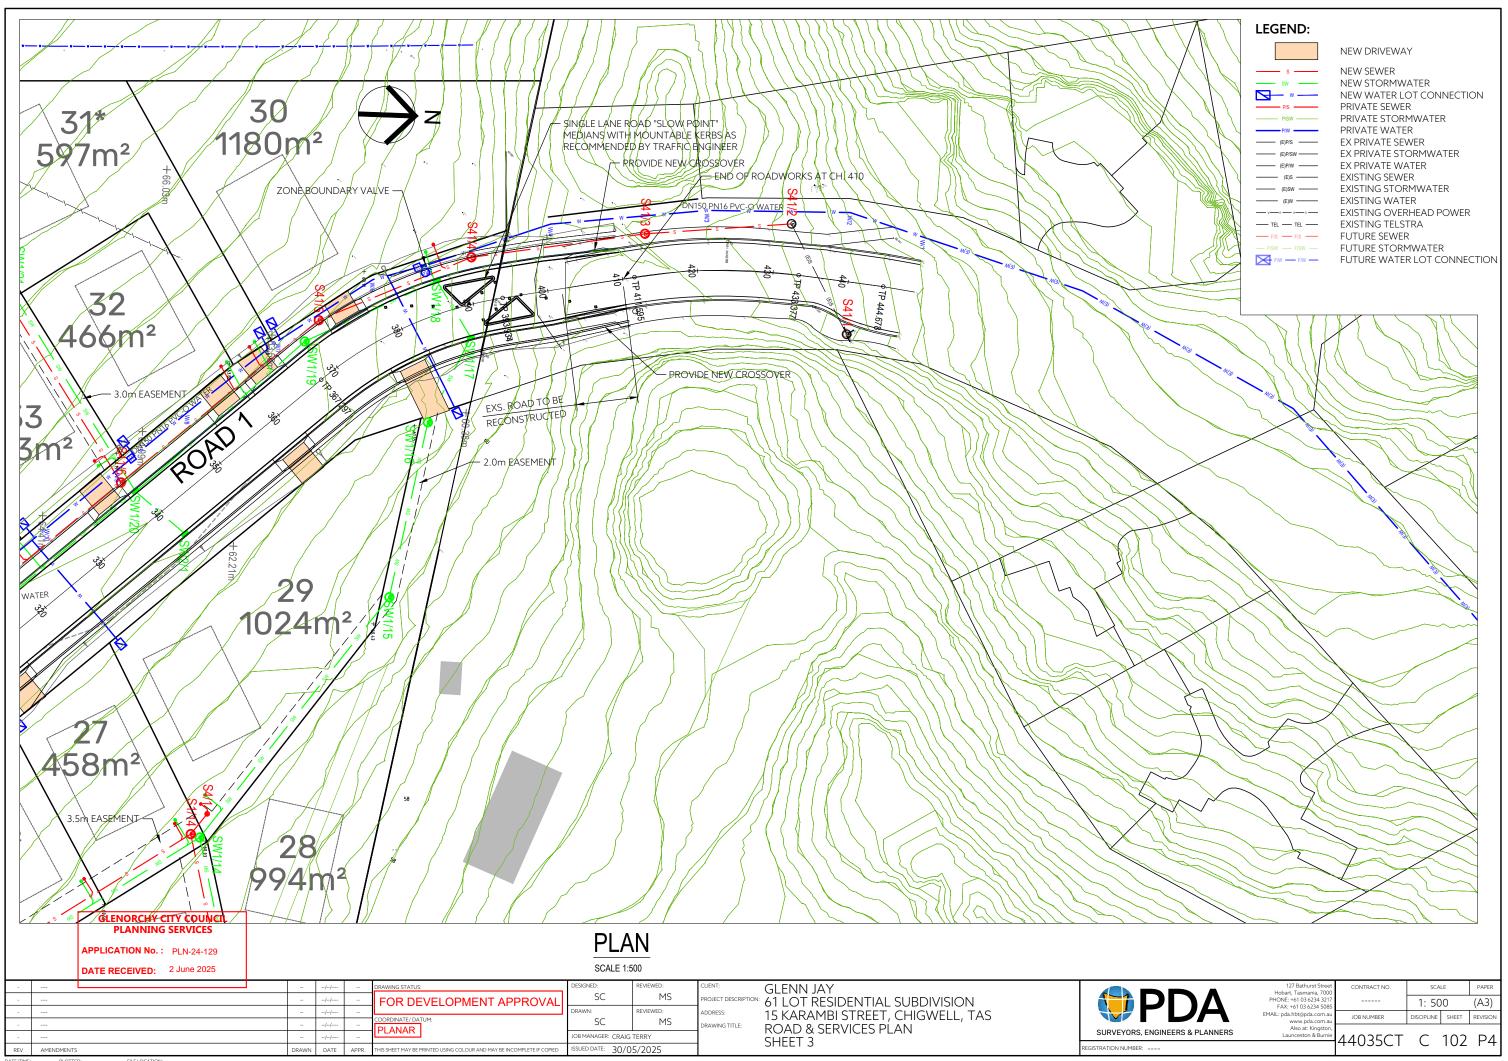











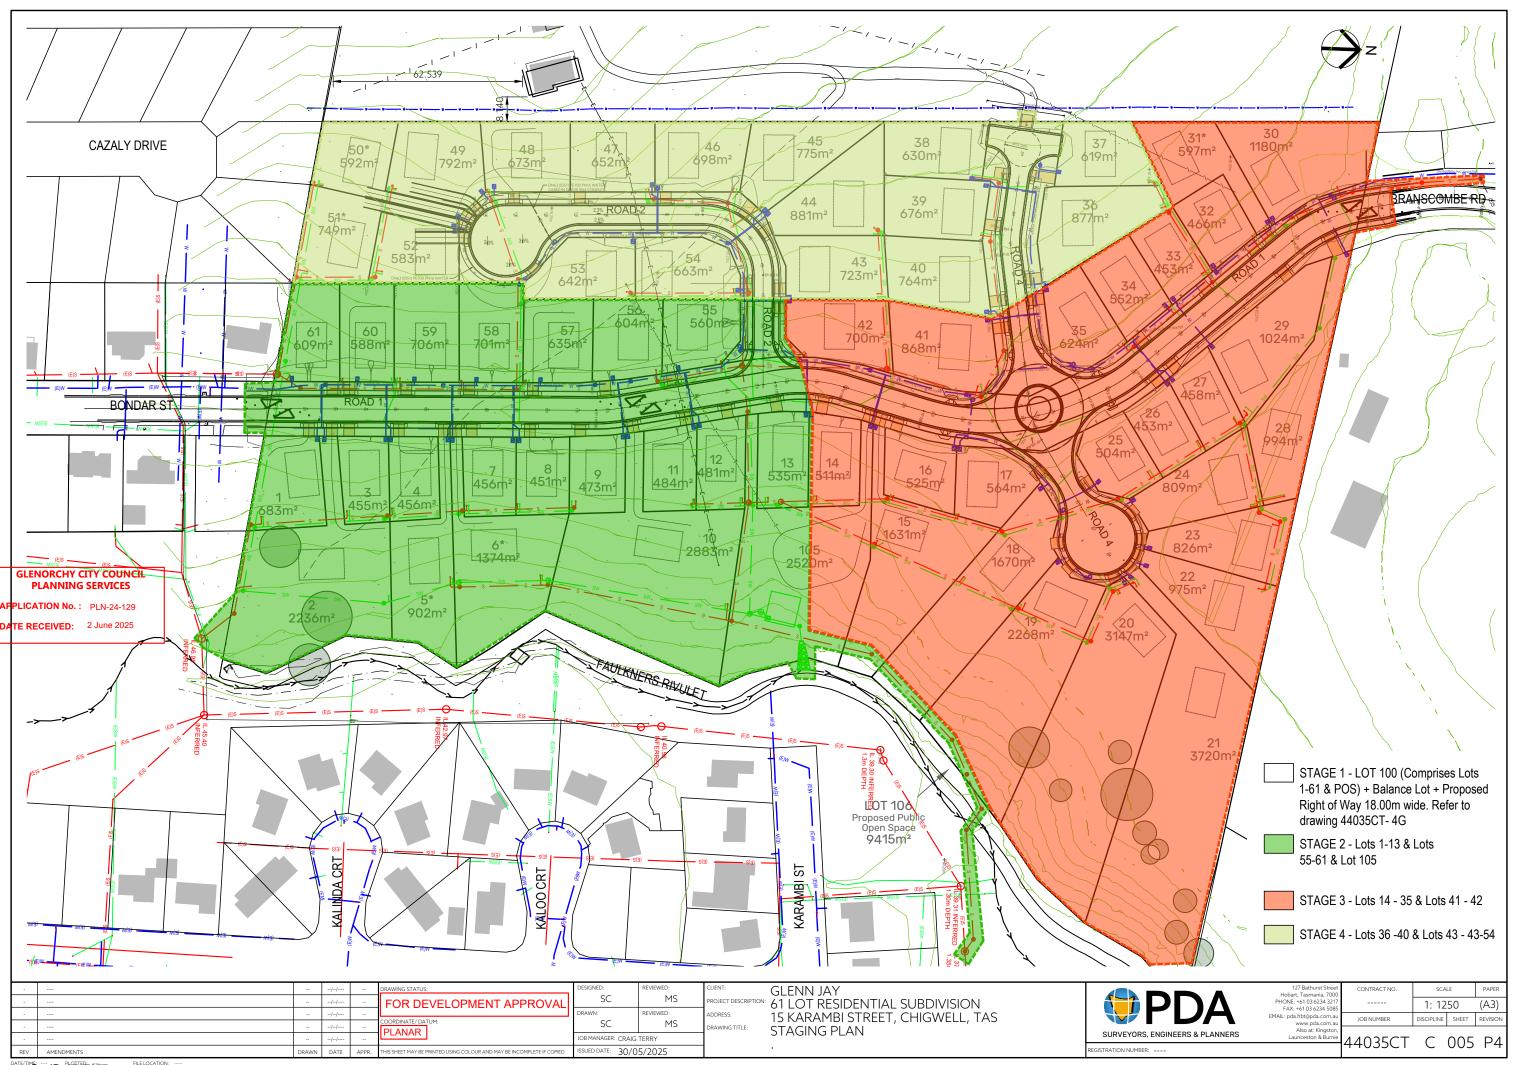


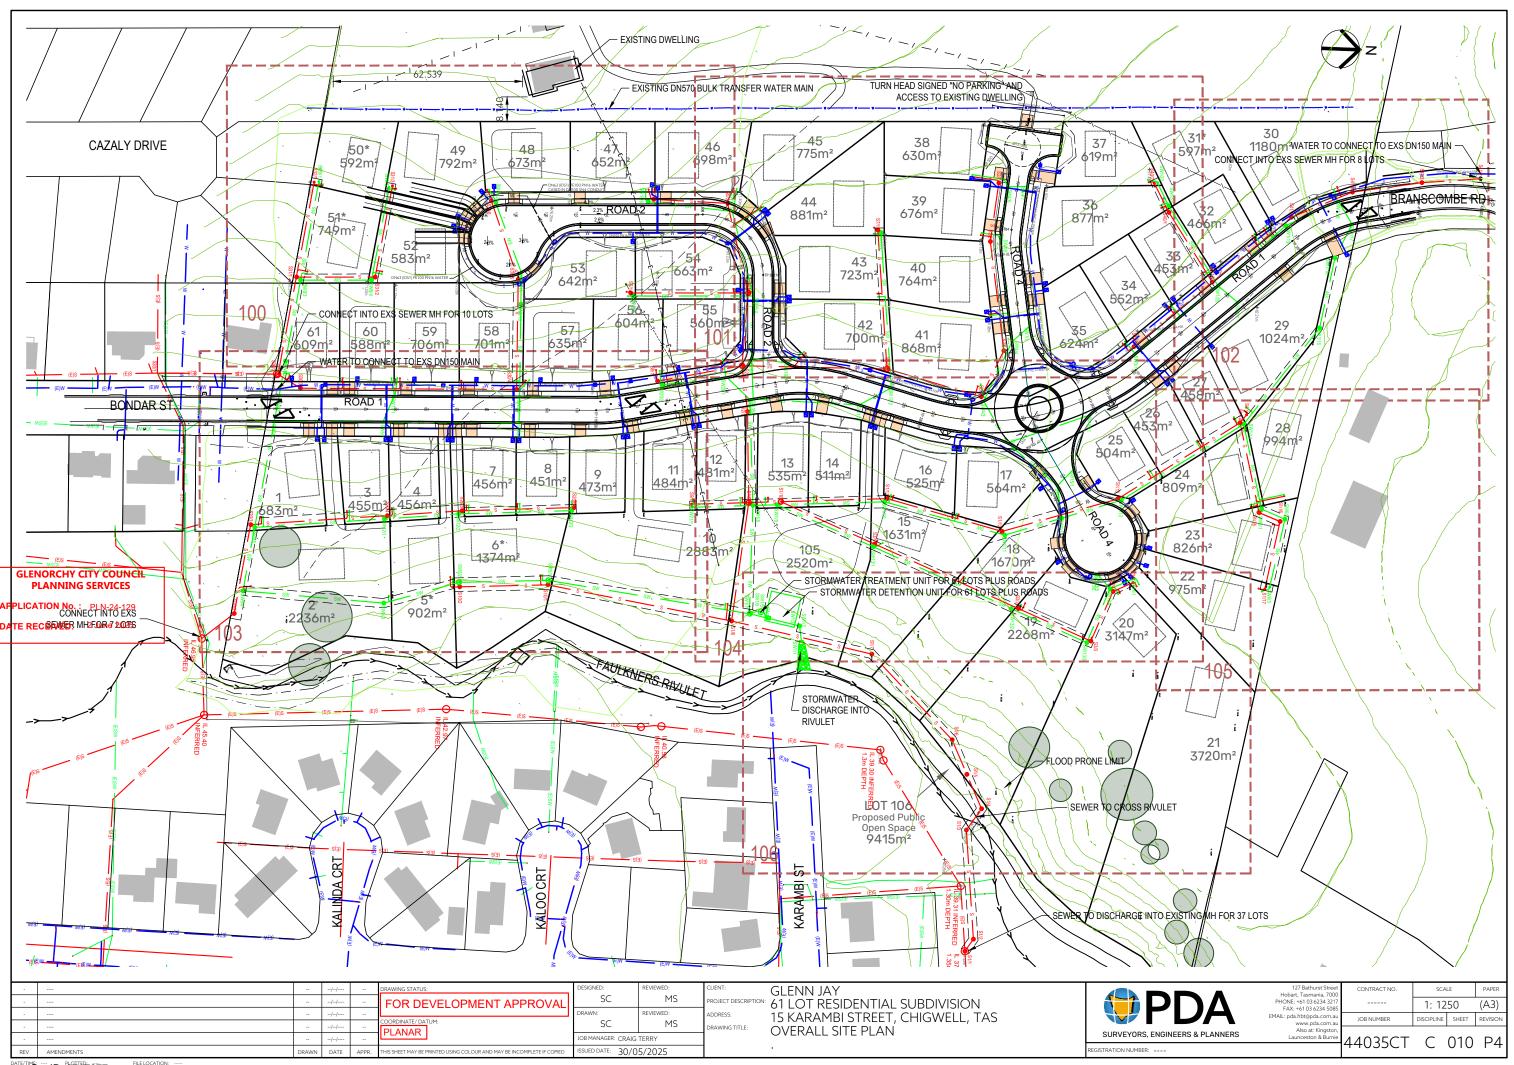

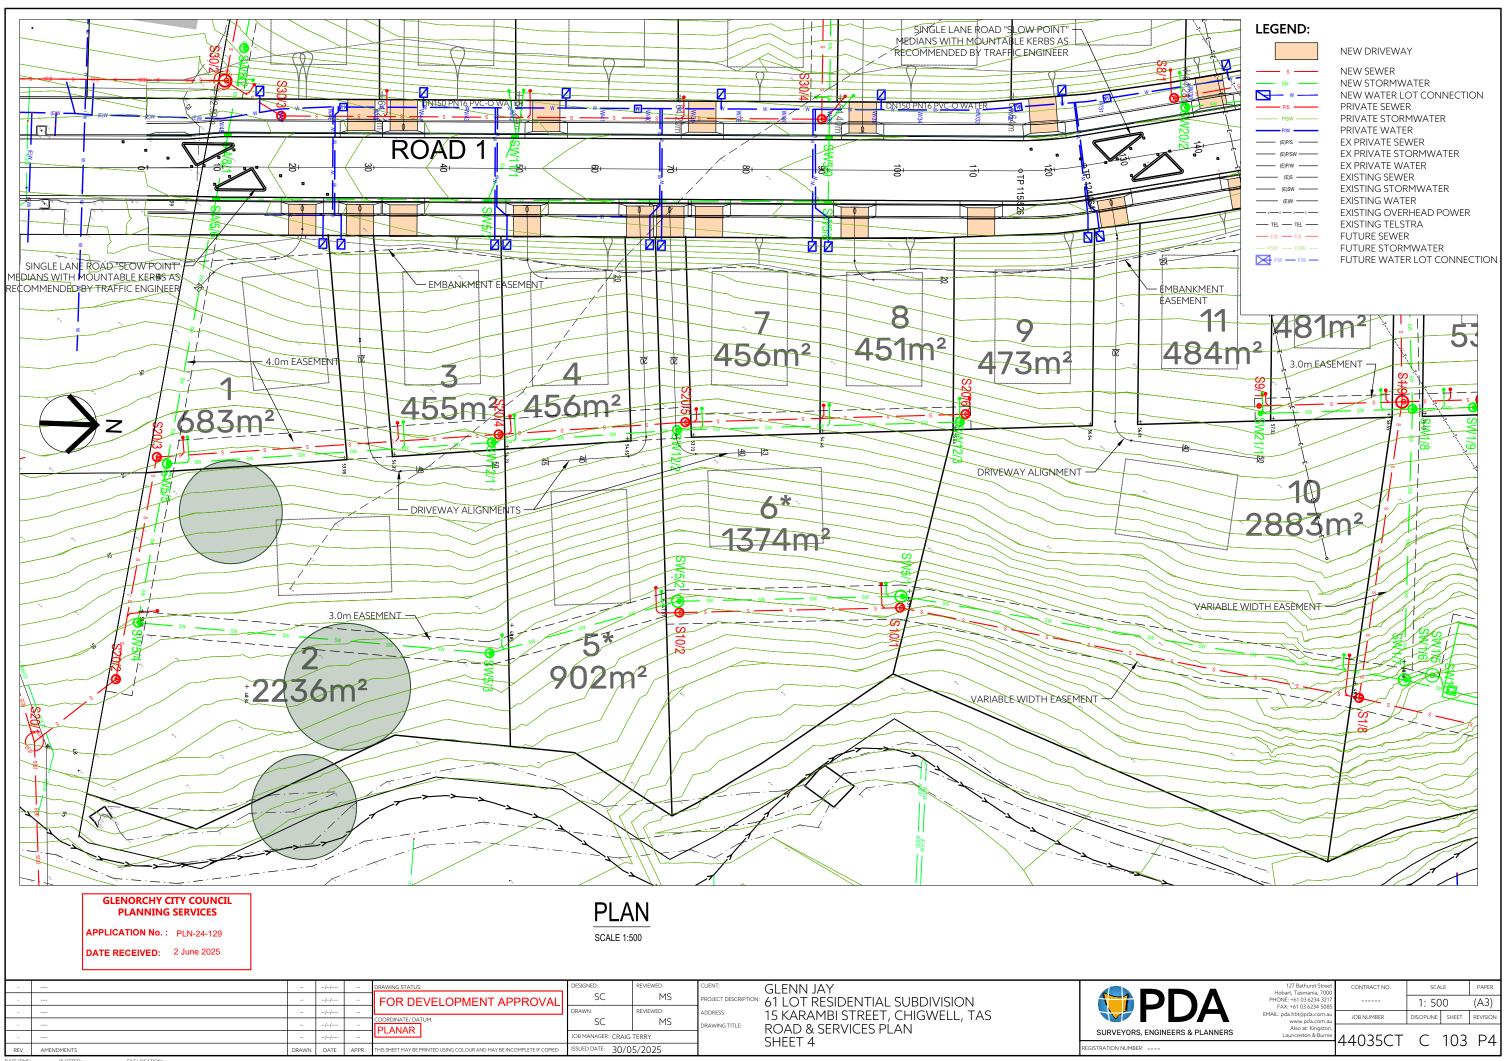


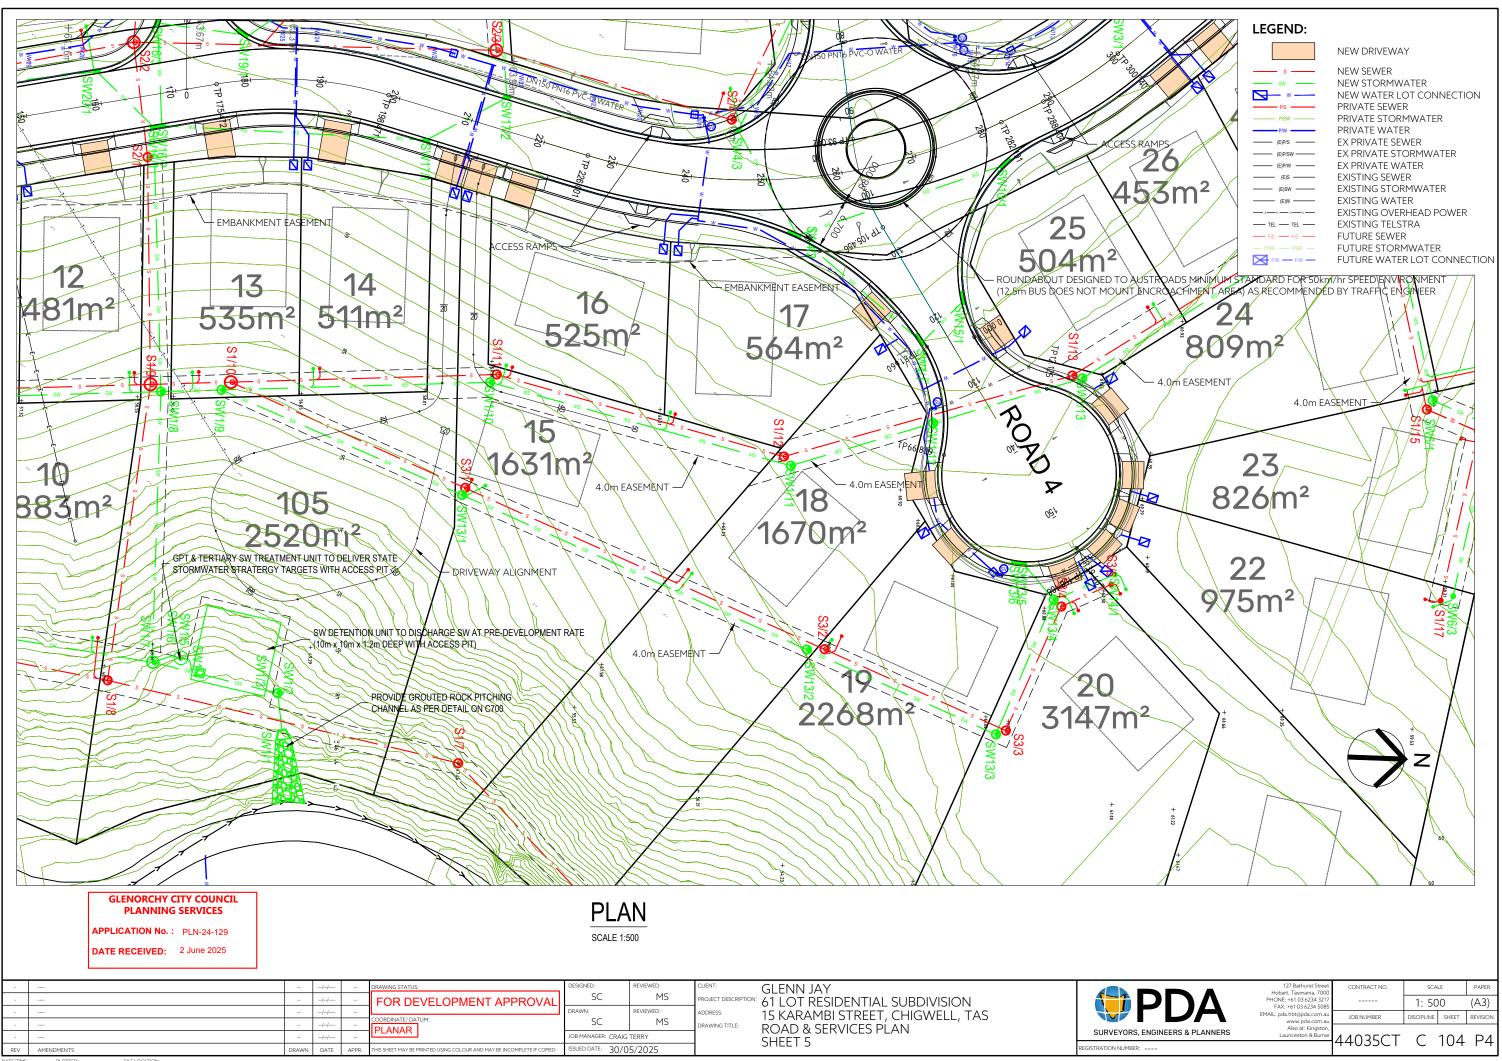


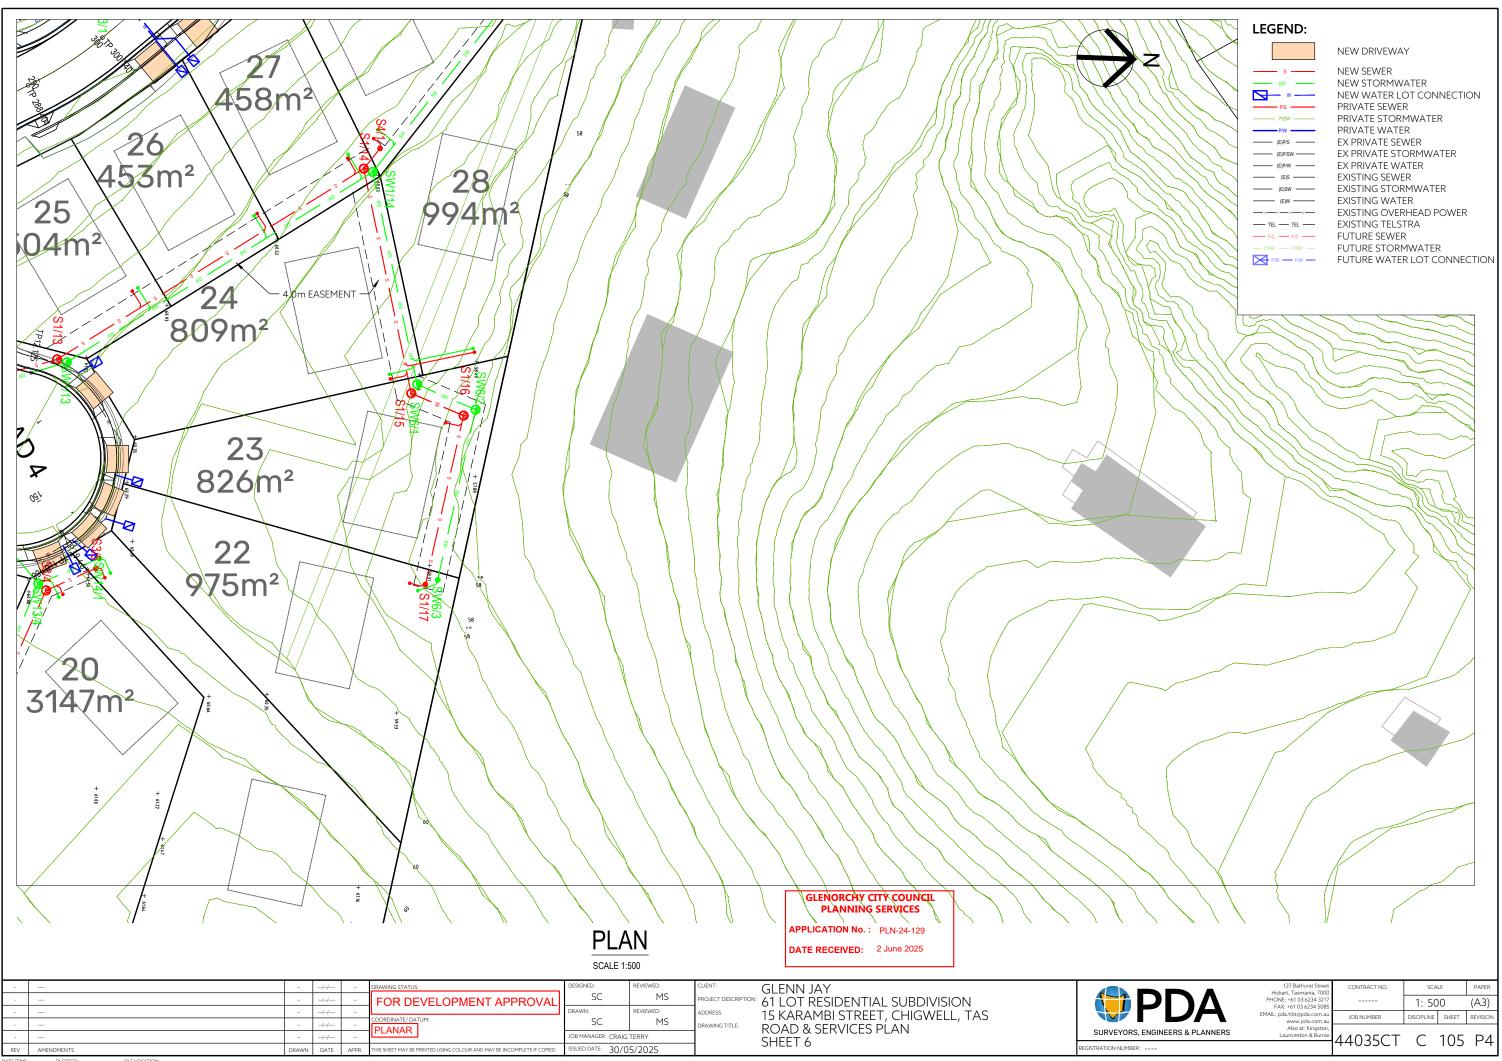

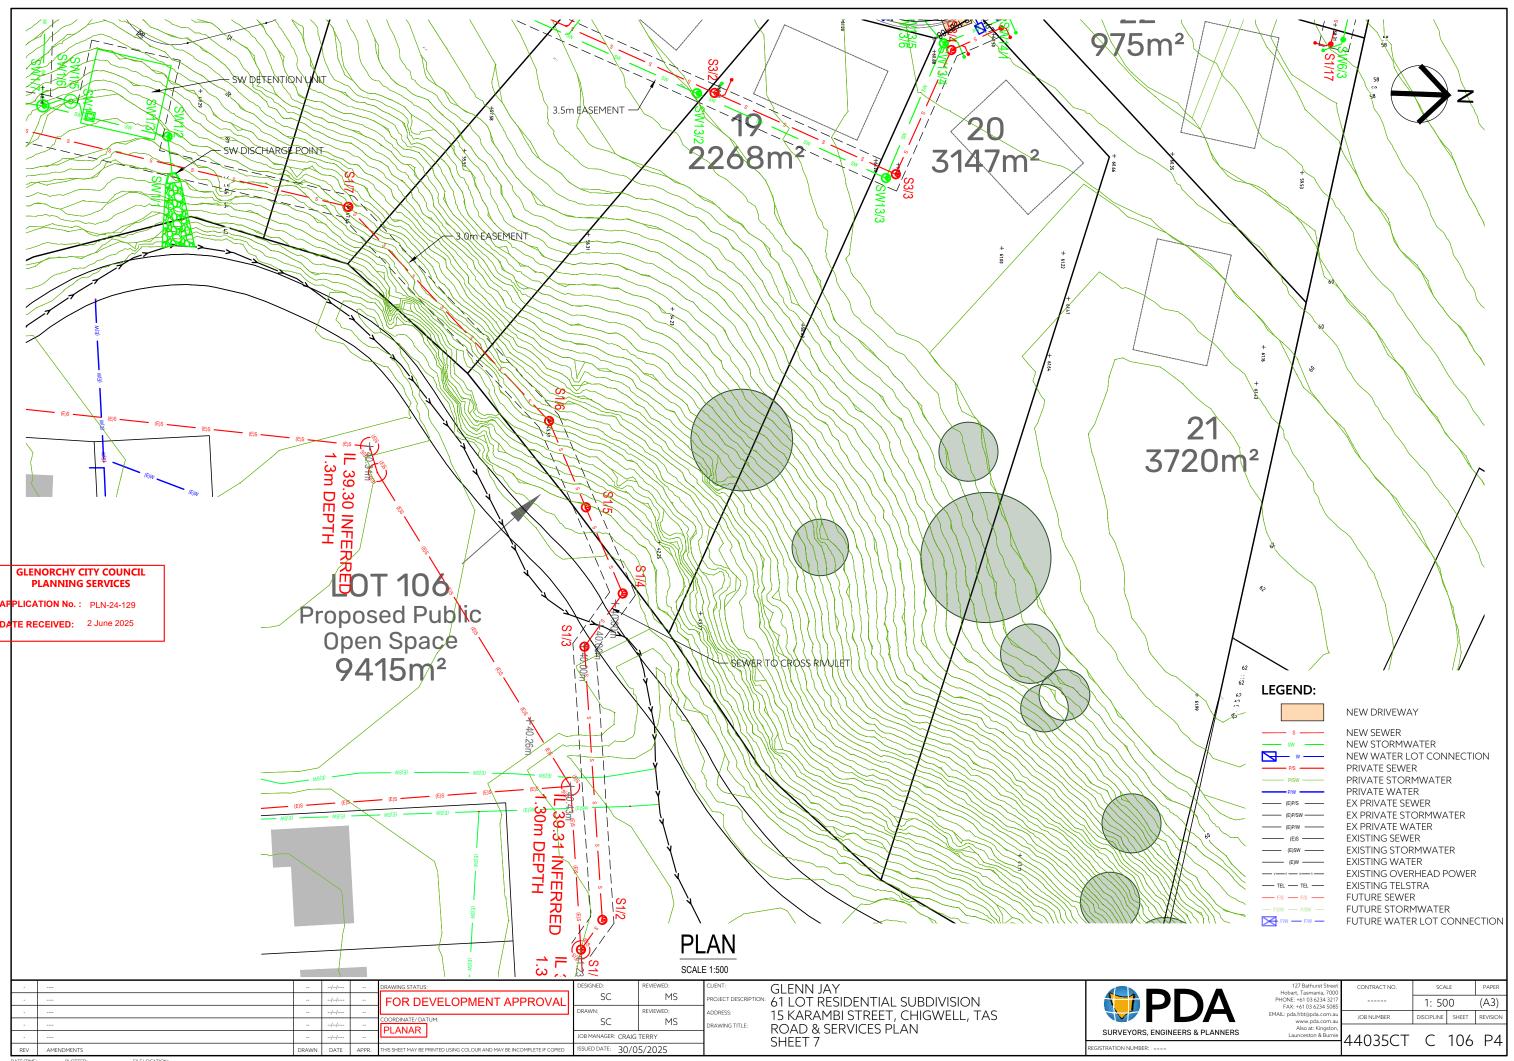

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LONG SECTION - ROAD 1 SCALES: (H) 1 IN 500 (V) 1 IN 100 (A3)

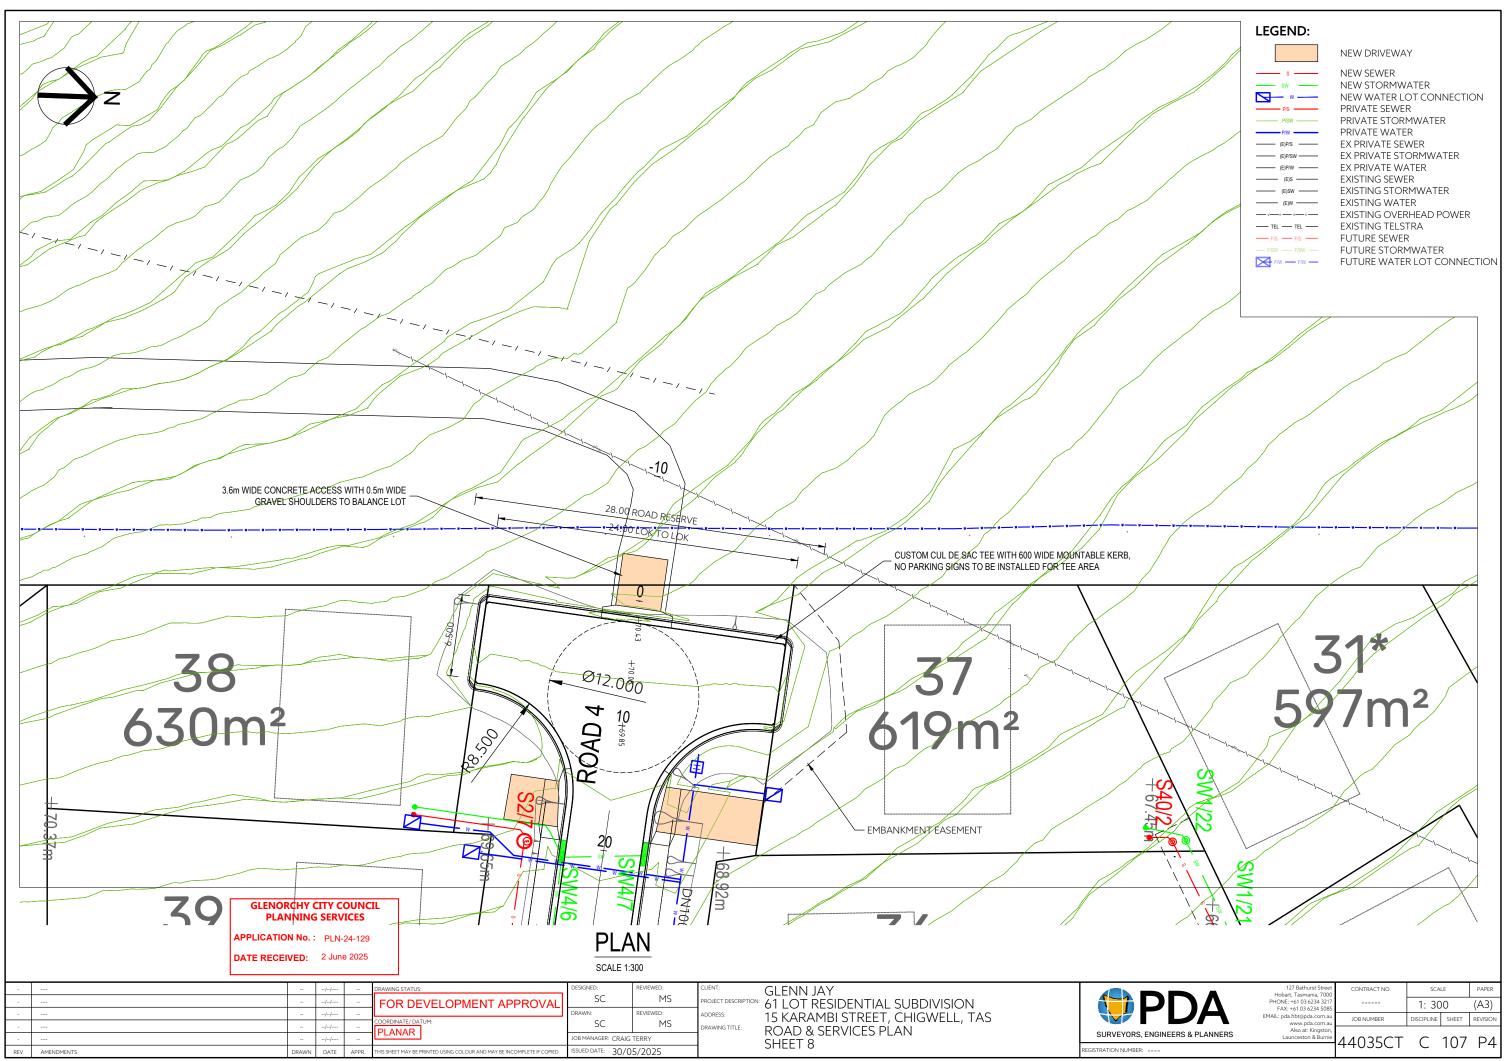ROAD 1

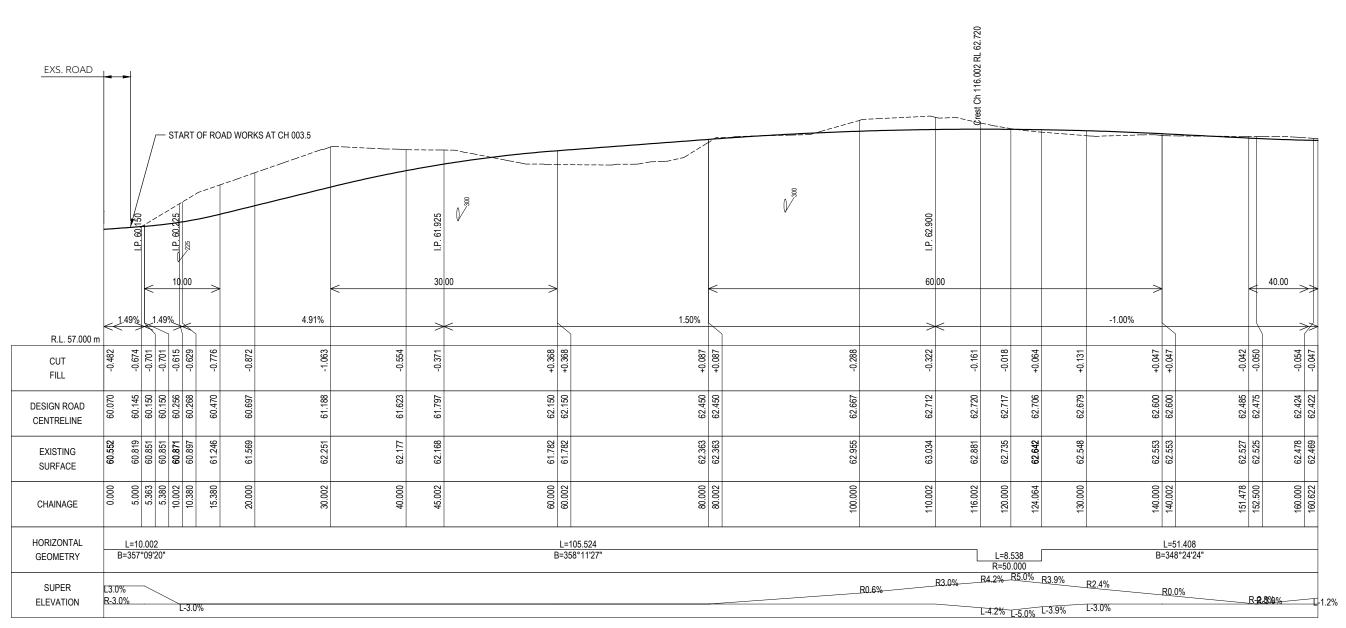GLENORCHY CITY COUNCIL PLANNING SERVICES

APPLICATION No.: PLN-24-129

DATE RECEIVED: 2 June 2025

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| SC | MS | DR | | | |
| JOB MANAGER: CRAIG TERRY | | | | | |
| ISSUED DATE: 30/0 | 5/2025 | | | | |

CLIENT: GLENN JAY
PROJECT DESCRIPTION: 61 LOT RESIDENTIAL SUBDIVISION
ADDRESS: 15 KARAMBI STREET, CHIGWELL, TAS
DRAWING TITLE: LONG SECTION
ROAD 1 - SHEET 1


| PDA | |
|---------------------------------|--|
| SURVEYORS, ENGINEERS & PLANNERS | |

REGISTRATION NUMBER: ----

| Hobart, Tasmania, 7000 PHONE: +61 03 6234 3217 FAX: +61 03 6234 5085 1: 500 | Launceston & Burnie | 44035CT | \overline{C} | 20 |
|--|---|--------------|----------------|-----|
| Hobart, Tasmania, 7000 PHONE: +61 03 6234 3217 FAX: +61 03 6234 5085 | www.pda.com.au | JOB NUMBER | DISCIPLINE | SHE |
| | FAX: +61 03 6234 5085 | | 1: 50 | 00 |
| 127 Pathumt Charat | 127 Bathurst Street Hobart, Tasmania, 7000 | CONTRACT NO. | SCALE | |

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(A3)

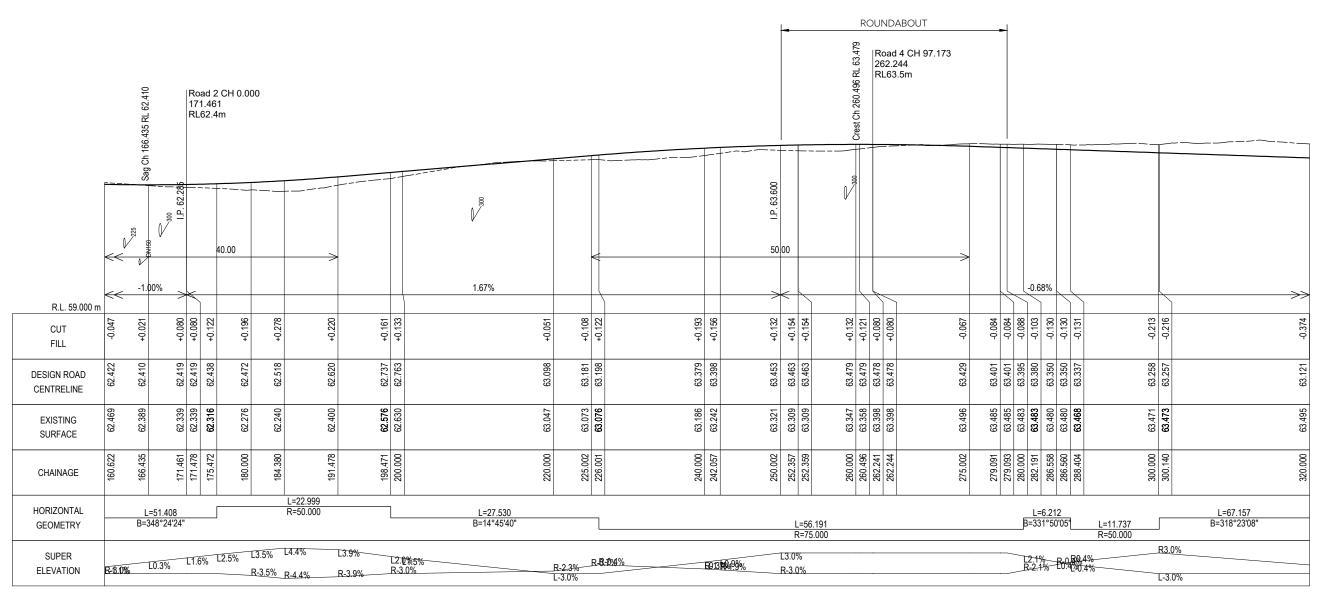

LONG SECTION - ROAD 1 SCALES: (H) 1 IN 500 (V) 1 IN 100 (A3)

ROAD 1

GLENORCHY CITY COUNCIL **PLANNING SERVICES**

APPLICATION No.: PLN-24-129 DATE RECEIVED: 2 June 2025

| | **** | | // | | DRAWING STATUS: |
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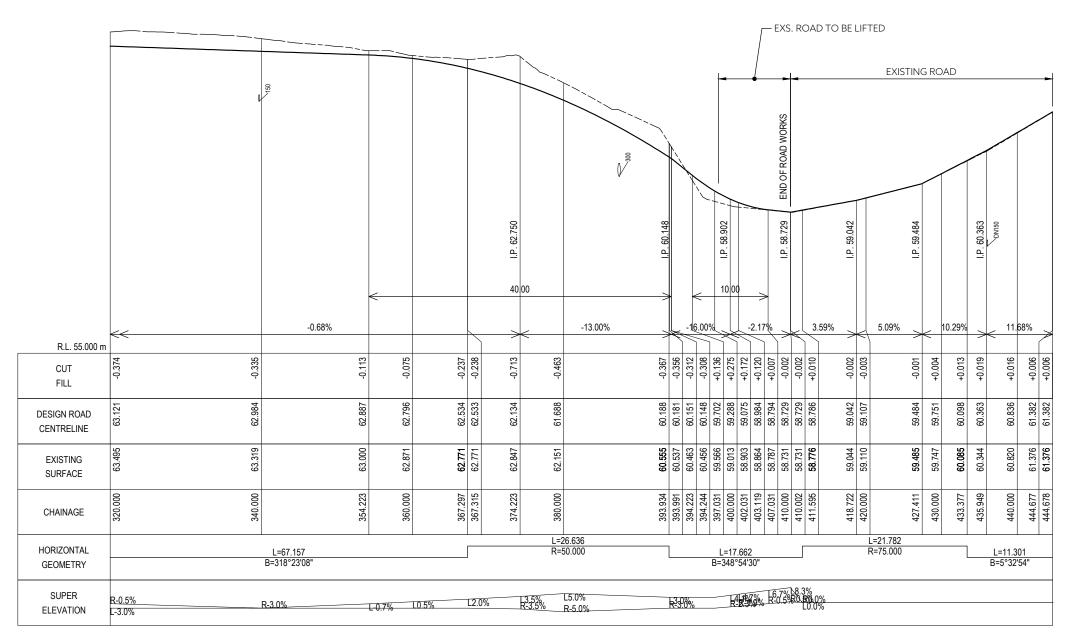
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GLENN JAY TION: 61 LOT RESIDENTIAL SUBDIVISION 15 KARAMBI STREET, CHIGWELL, TAS LONG SECTION ROAD 1 - SHEET 2

| PDA |
|---------------------------------|
| SURVEYORS, ENGINEERS & PLANNERS |
| |

| 127 Bathurst Street Hobart, Tasmania, 7000 | CONTRACT NO. | SCA | PAPER | |
|--|--------------|---------------|-------|----------|
| PHONE: +61 03 6234 3217 FAX: +61 03 6234 5085 | | 1: 50 | 00 | (A3) |
| MAIL: pda.hbt@pda.com.au www.pda.com.au | JOB NUMBER | DISCIPLINE | SHEET | REVISION |
| Also at: Kingston, Launceston & Burnie | 11035CT | \mathcal{C} | 201 | DΛ |

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LONG SECTION - ROAD 1 SCALES: (H) 1 IN 500 (V) 1 IN 100 (A3)

ROAD 1

GLENORCHY CITY COUNCIL PLANNING SERVICES

APPLICATION No.: PLN-24-129

DATE RECEIVED: 2 June 2025

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| | JOB MANAGER: CRAIG | | | |
| D | ISSUED DATE: 30/0 | | | |

CLIENT: GLENN JAY
PROJECT DESCRIPTION: 61 LOT RESIDENTIAL SUBDIVISION
ADDRESS: 15 KARAMBI STREET, CHIGWELL, TAS
DRAWING TITLE: LONG SECTION
ROAD 1 - SHEET 3

| PDA |
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| SURVEYORS, ENGINEERS & PLANNERS |


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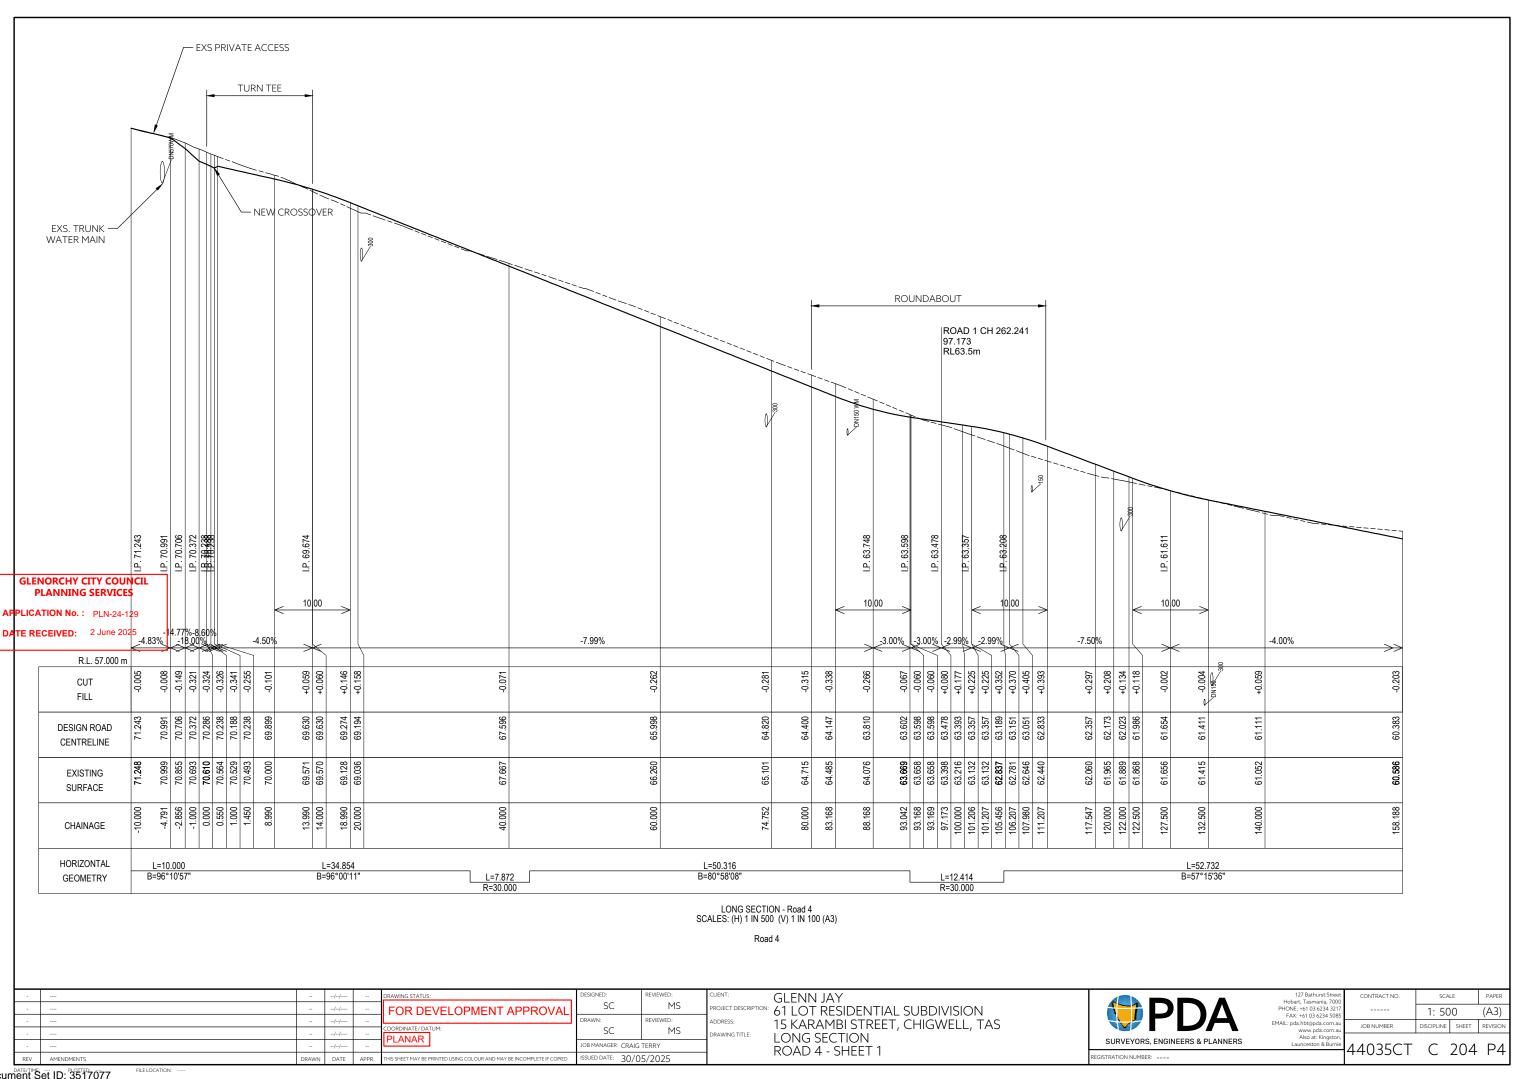
| 127 Bathurst Street Hobart, Tasmania, 7000 | CONTRACT NO. | |
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| PHONE: +61 03 6234 3217 FAX: +61 03 6234 5085 | | Γ |
| EMAIL: pda.hbt@pda.com.au www.pda.com.au | JOB NUMBER | |
| Also at: Kingston, Launceston & Burnie | 4402ECT | |

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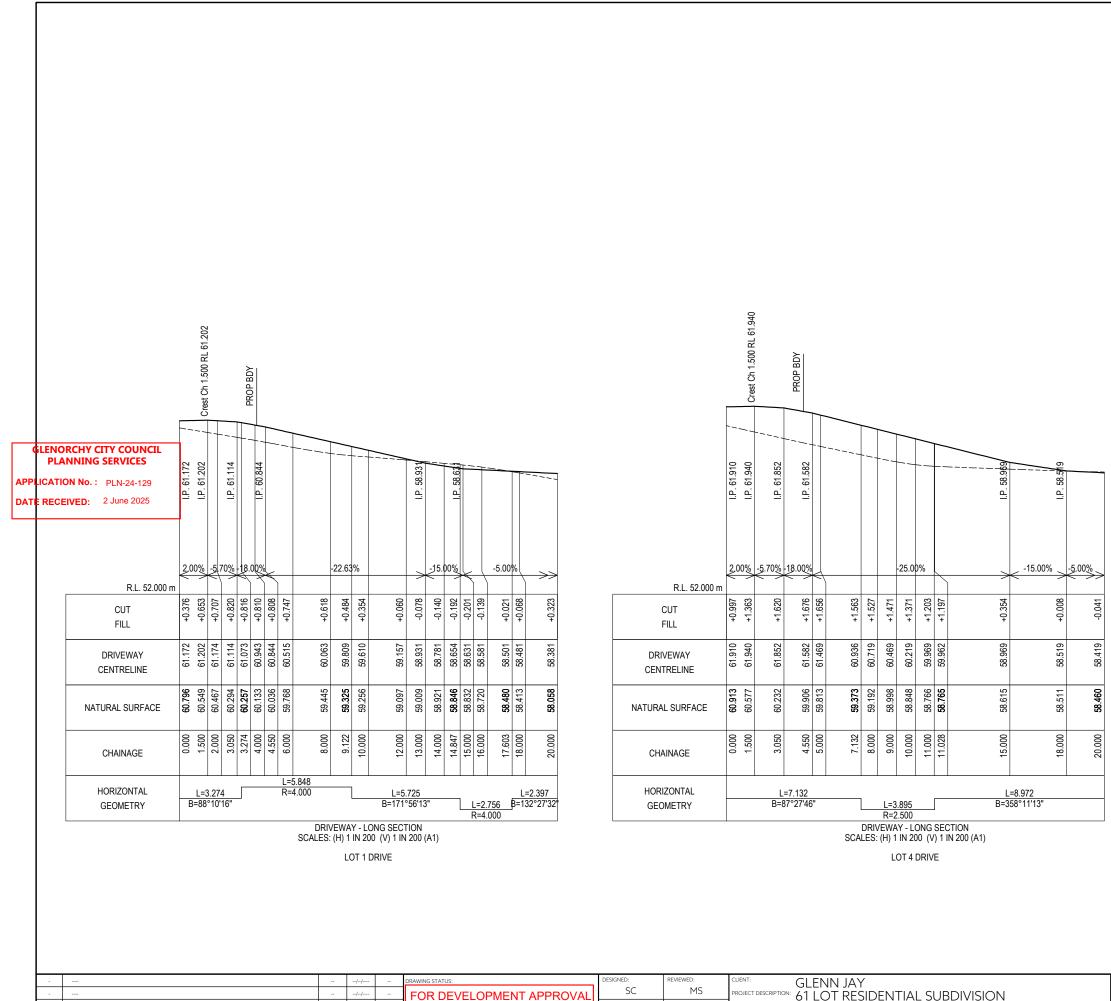
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SC MANAGER: CRAIG TERRY ISSUED DATE: 30/05/2025

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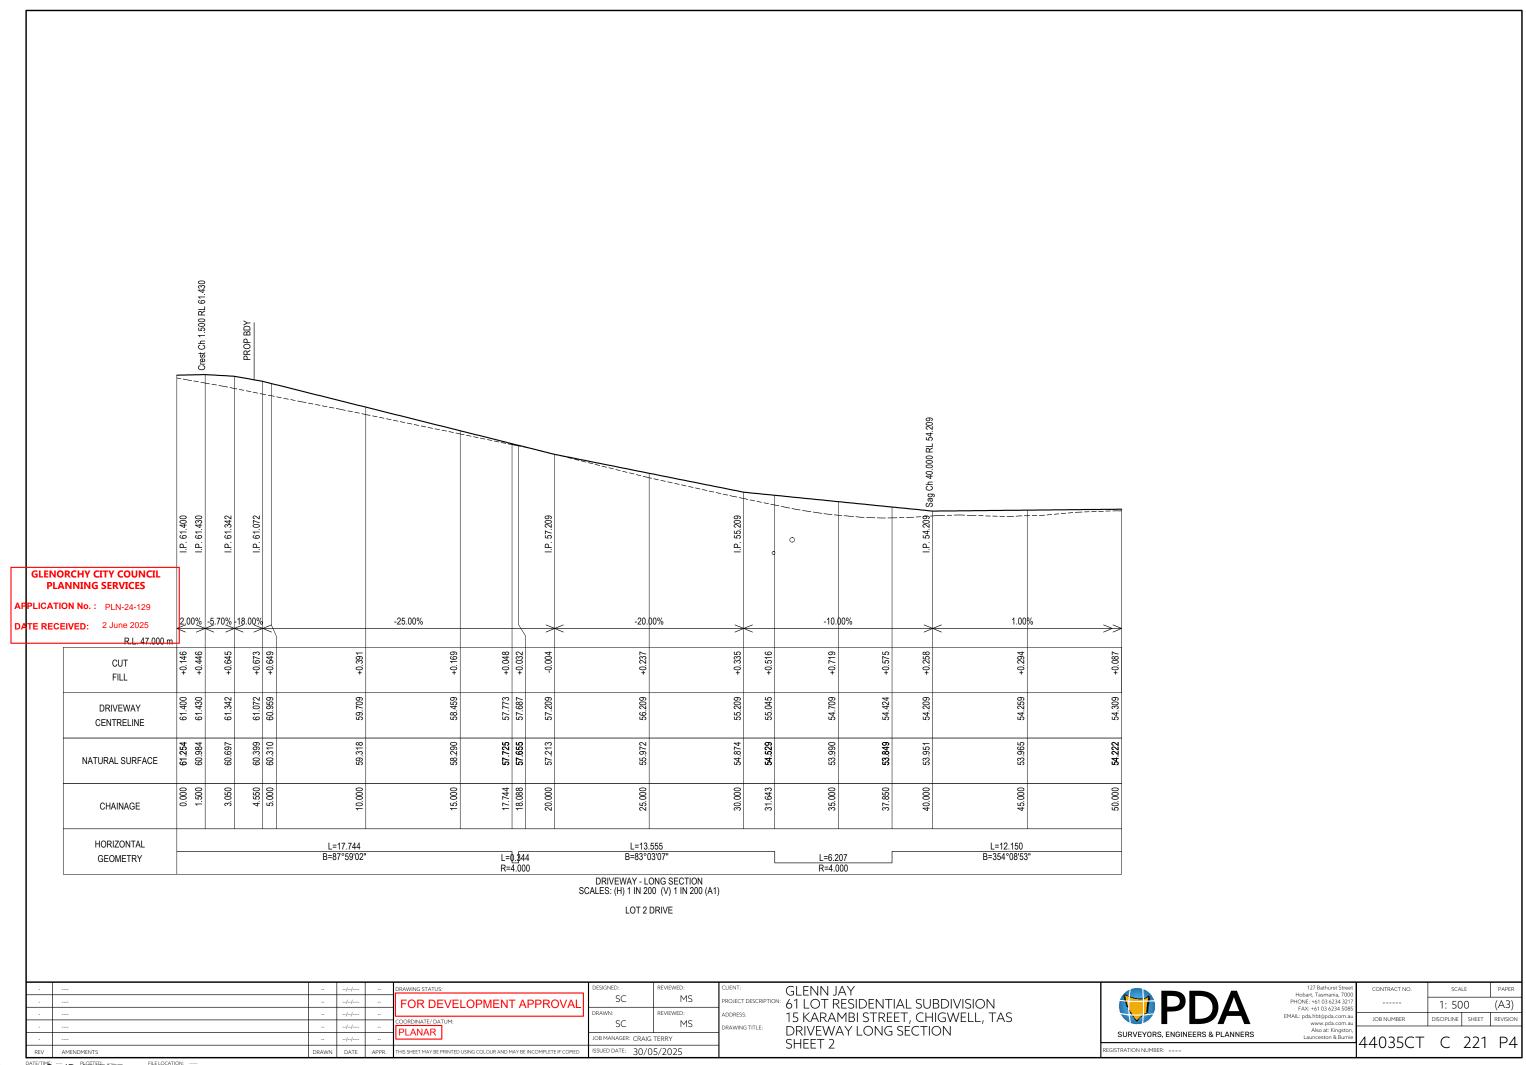
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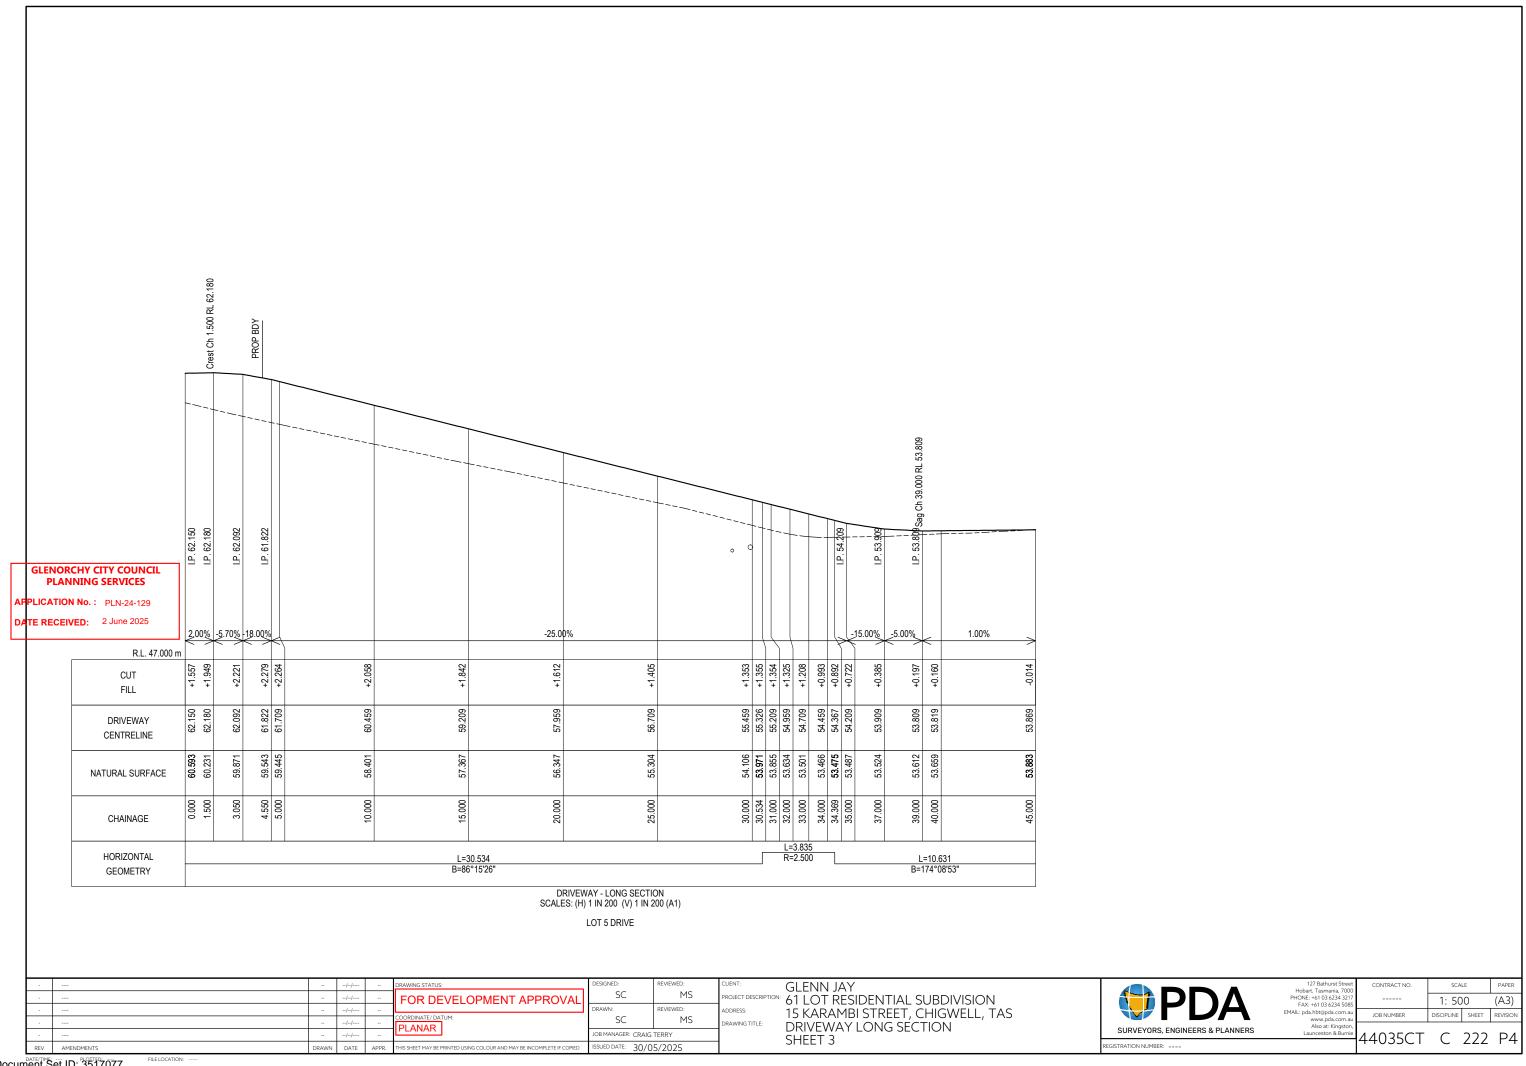
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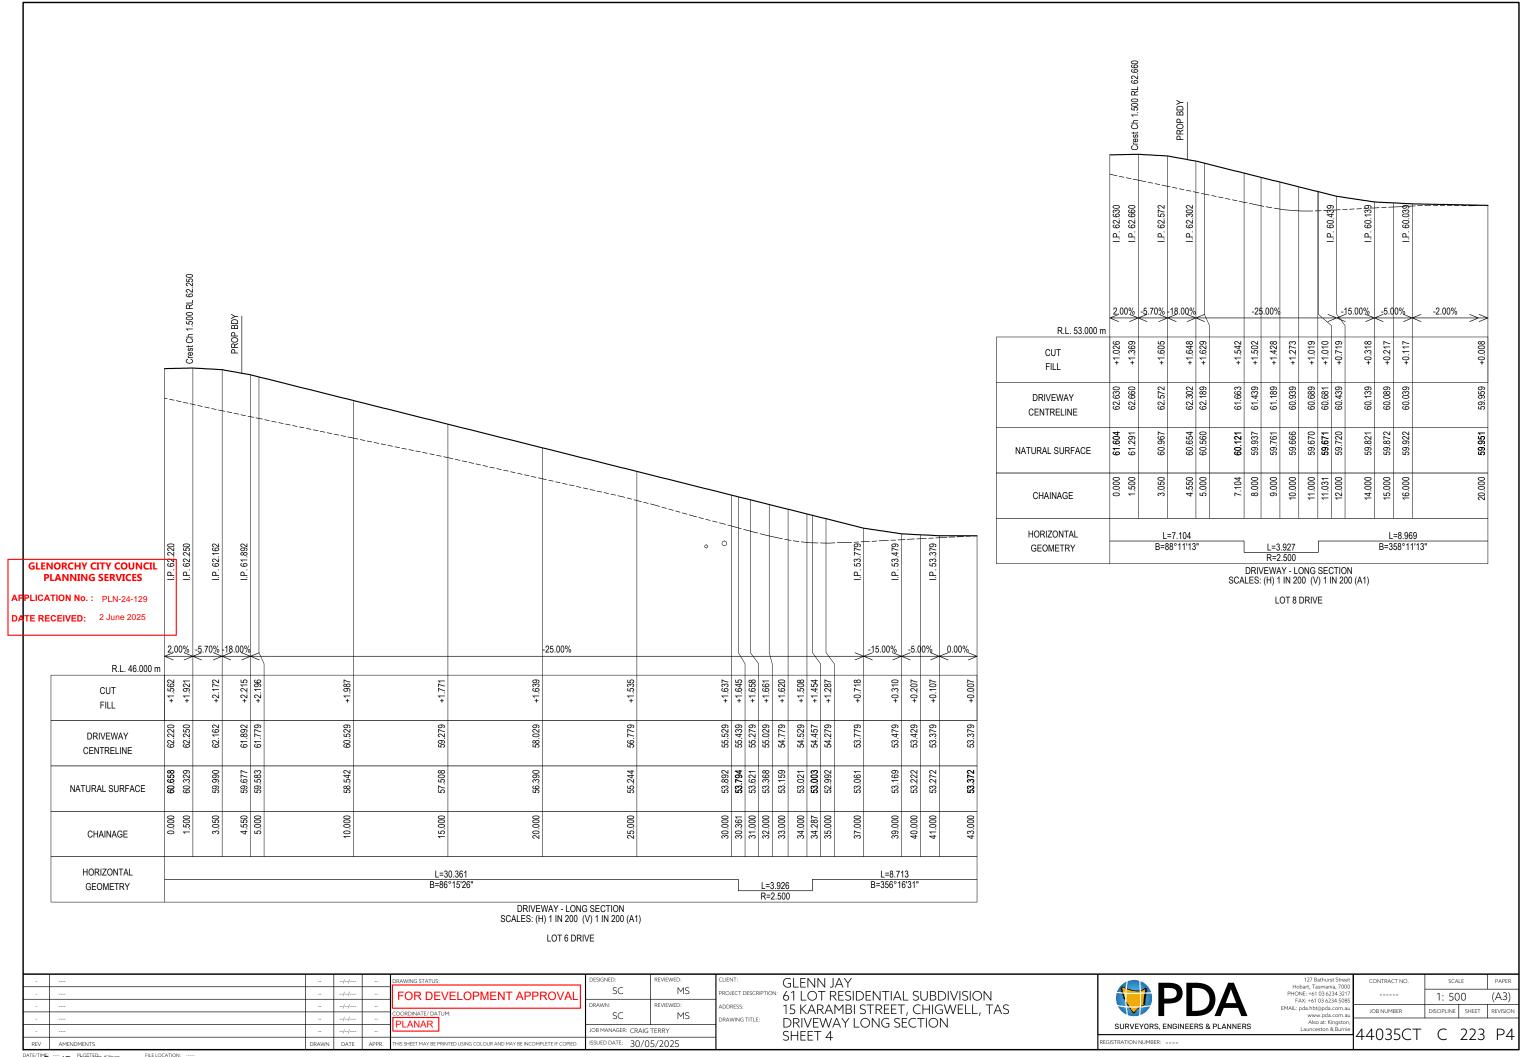
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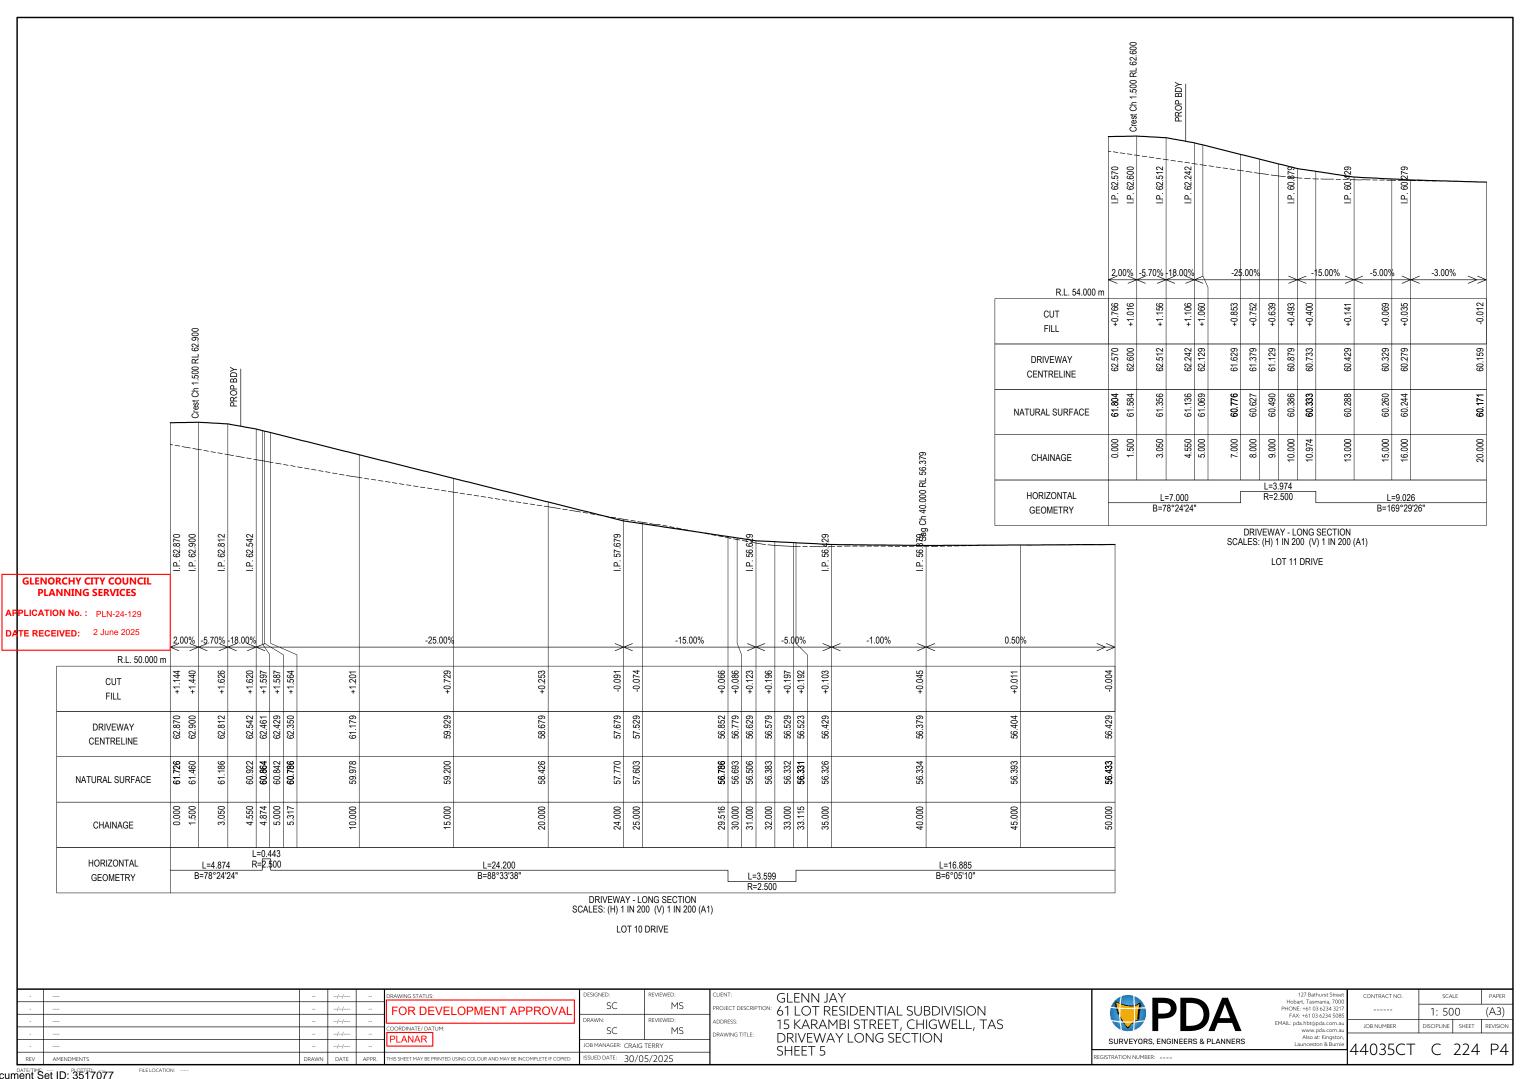
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44035CT C 220 P4






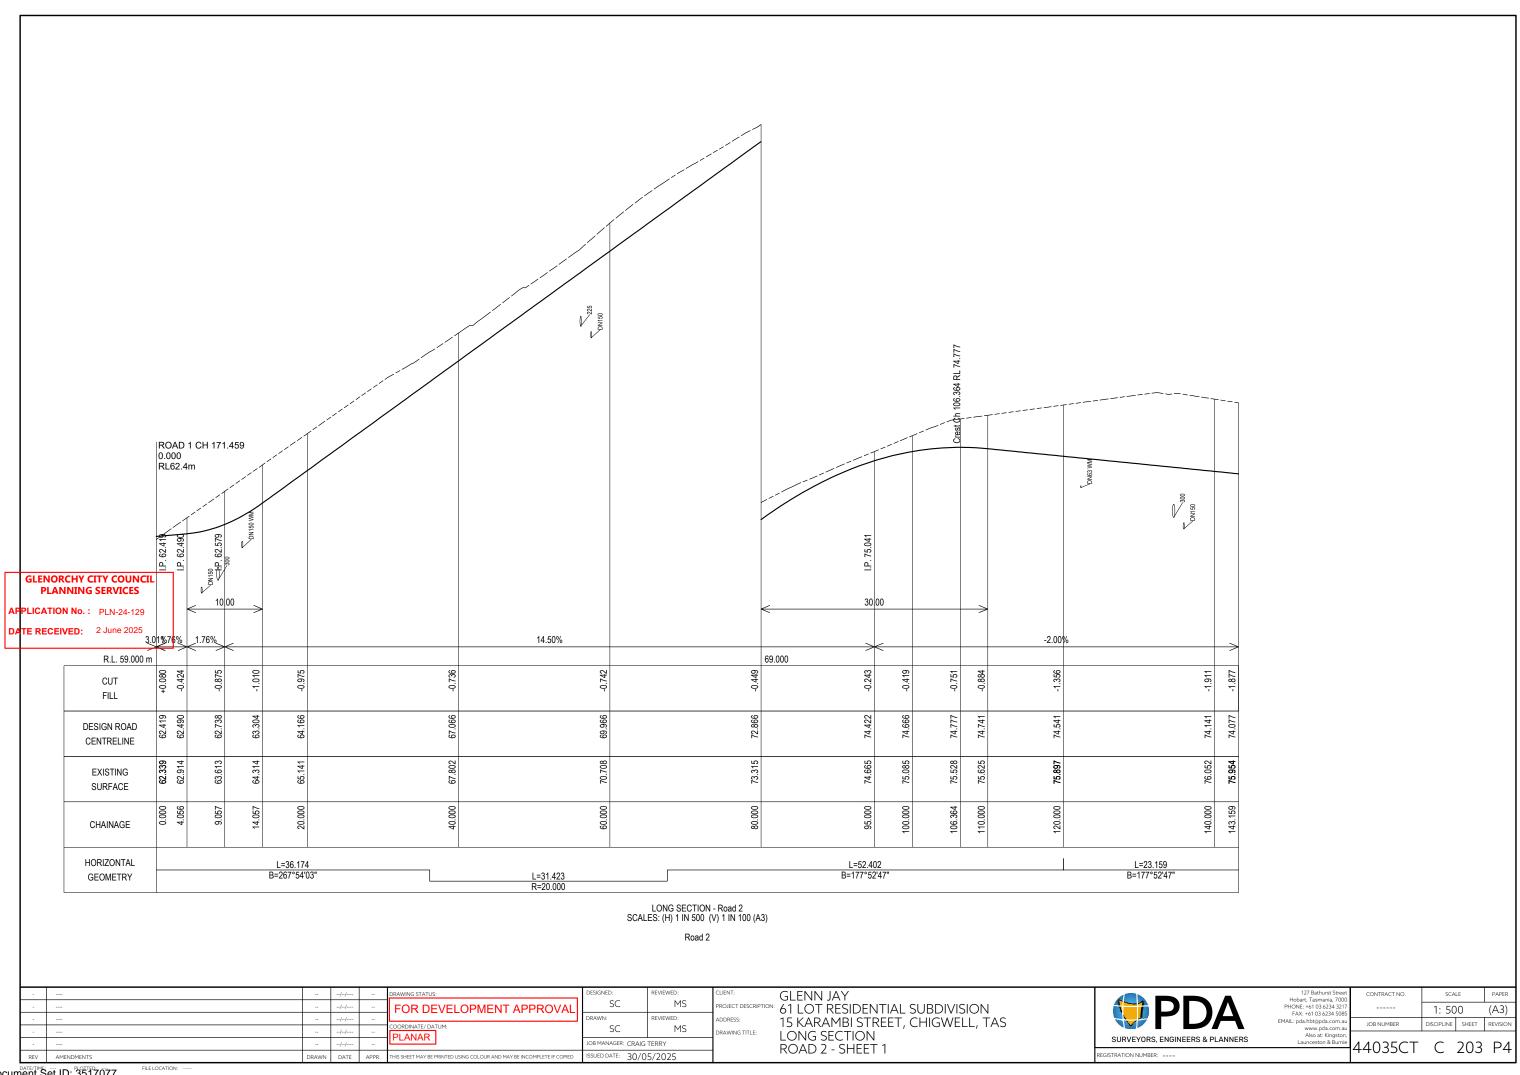




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183 66 J. ₫. 2,00% 8,60% 11.00% 18.00% 8.00% 5.00% R.L. 60.000 m +0.008 .965 CUT FILL 66.348 66.429 67.329 DRIVEWAY CENTRELINE **67.166** 67.233 68.221 NATURAL SURFACE 10.000 4.550 CHAINAGE HORIZONTAL L=20.000 B=177°54'03" GEOMETRY

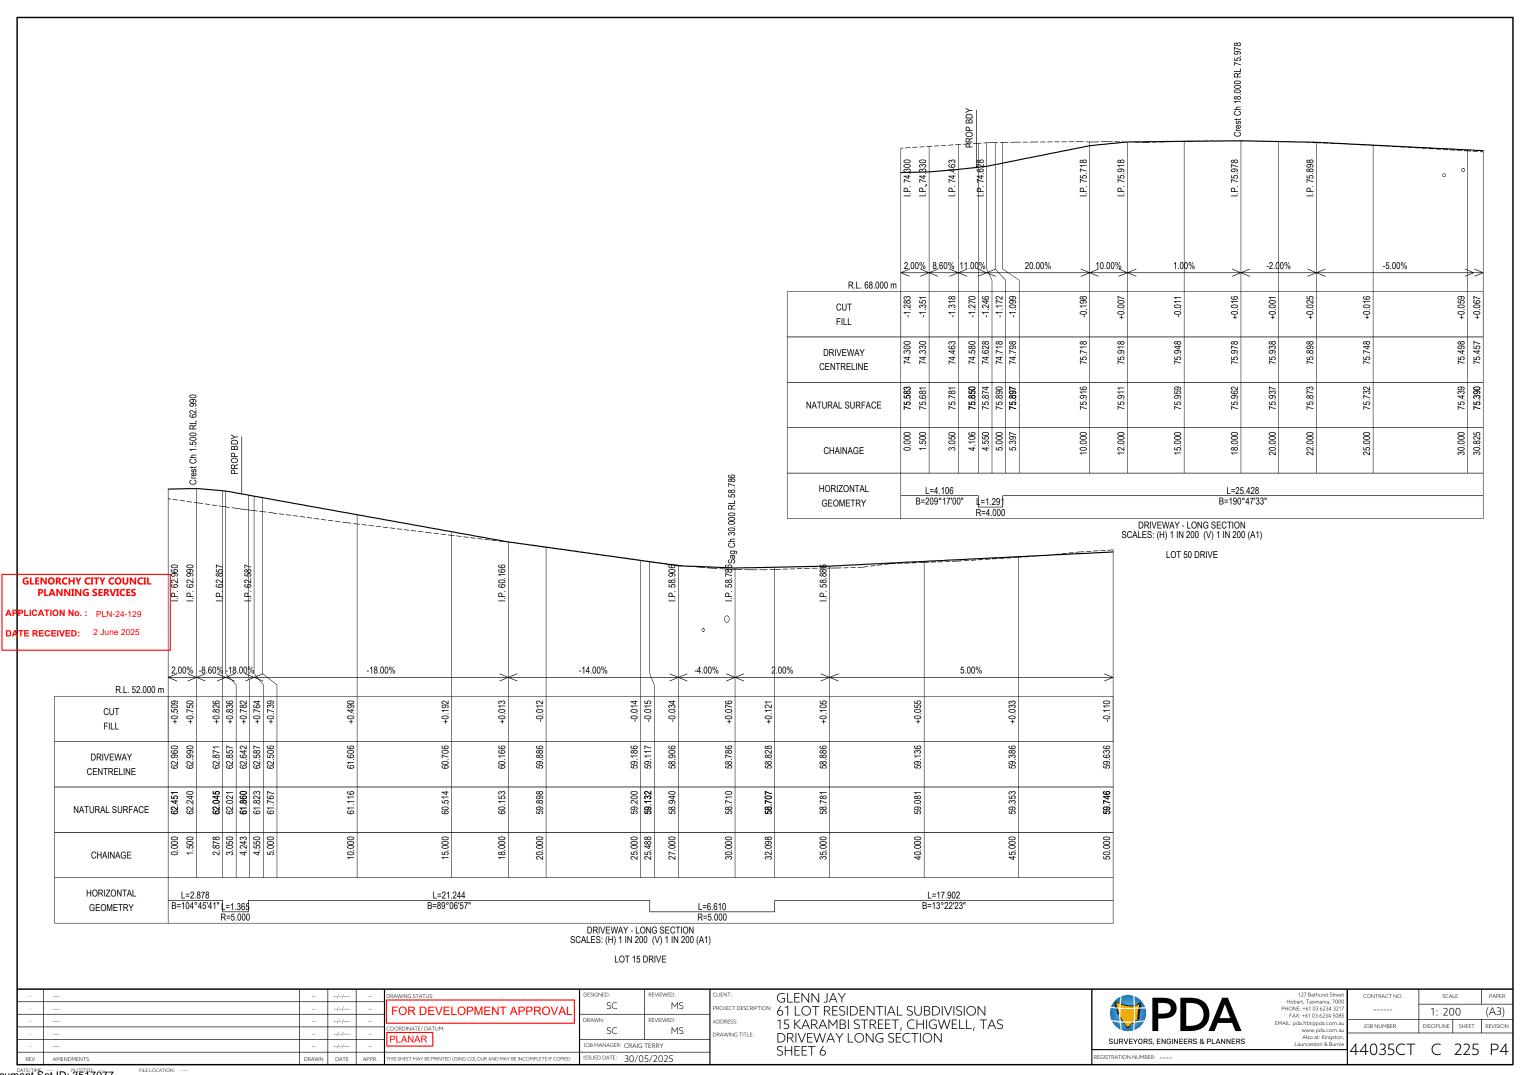DRIVEWAY - LONG SECTION SCALES: (H) 1 IN 200 (V) 1 IN 200 (A1)

LOT 54 DRIVE

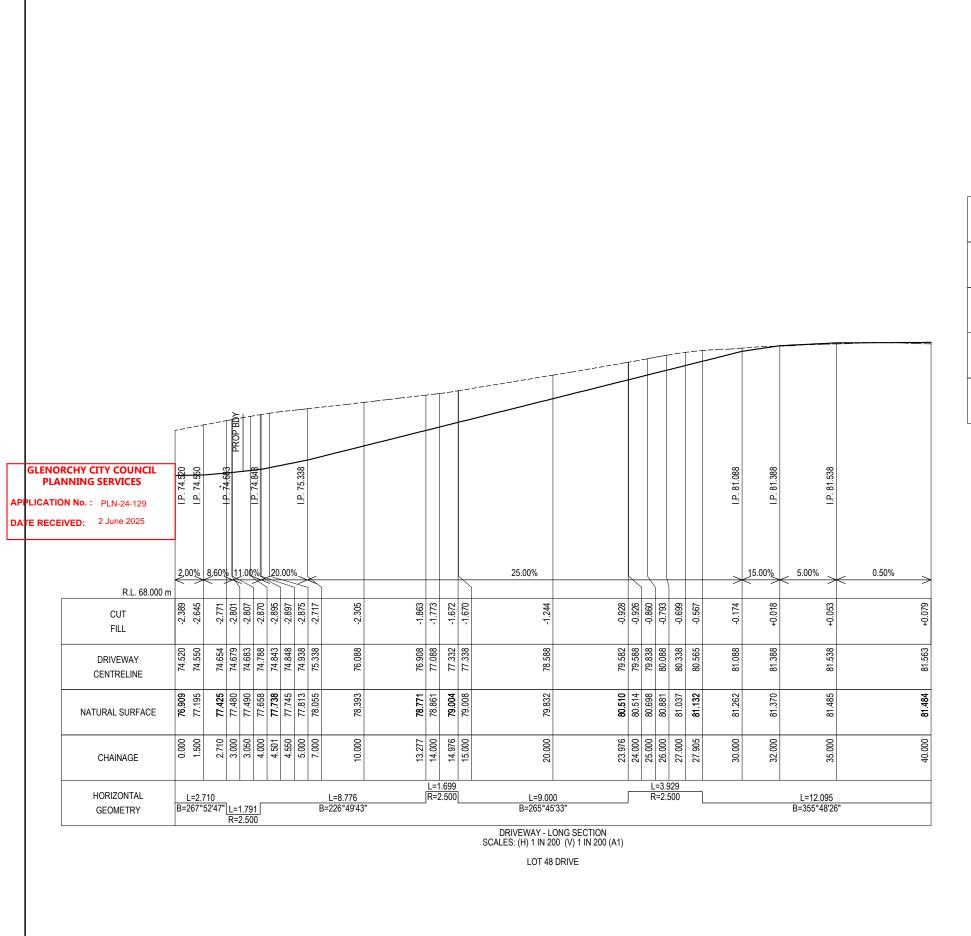SURVEYORS, ENGINEERS & PLANNERS ISTRATION NUMBER: ---


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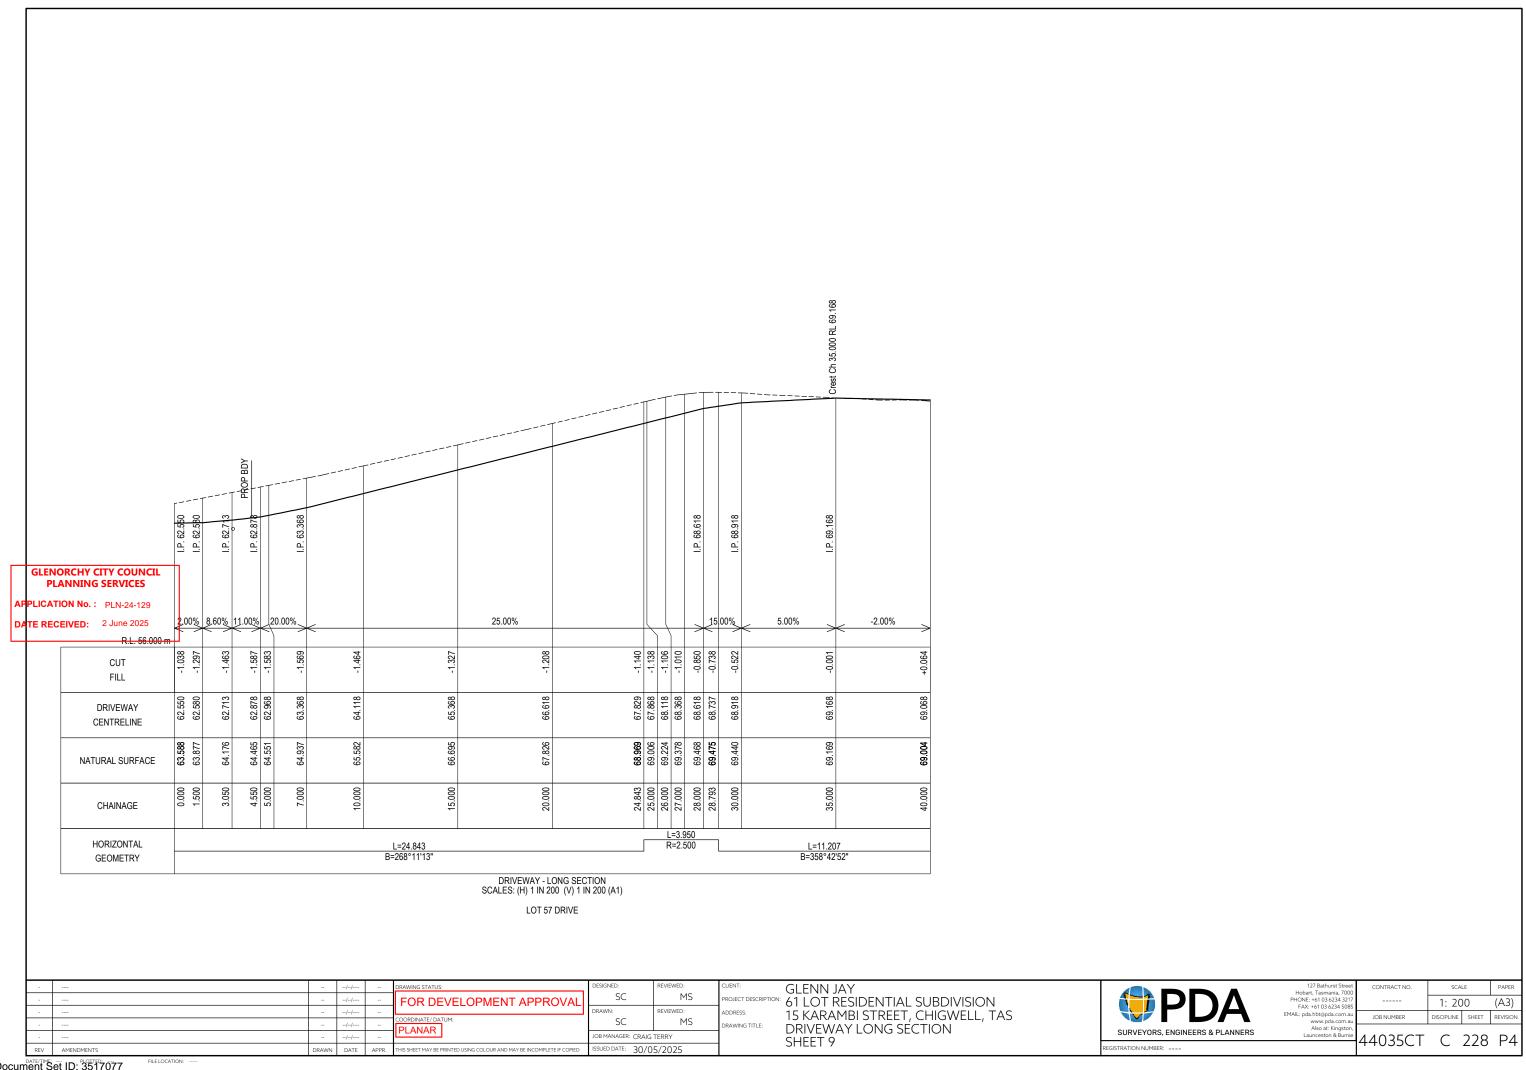
44035CT C 226 P4


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GLENN JAY 61 LOT RESIDENTIAL SUBDIVISION 15 KARAMBI STREET, CHIGWELL, TAS DRIVEWAY LONG SECTION SHEET 7





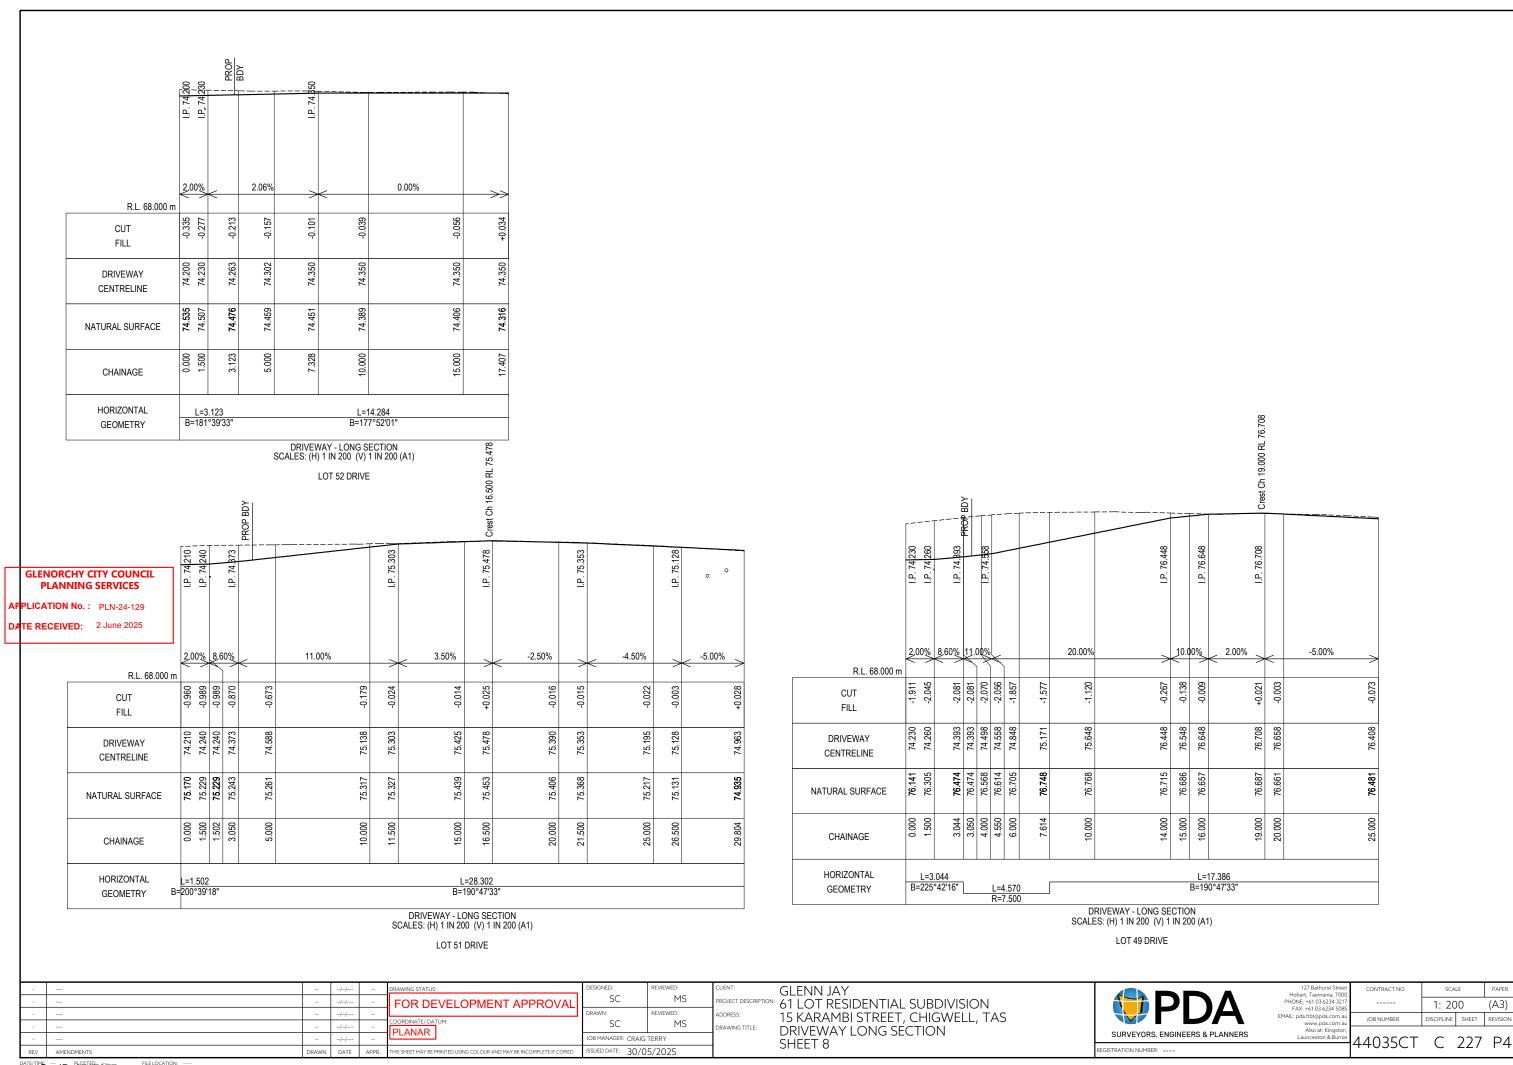

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| JOB MANAGER: CRAIG TERRY | | | | | | | |
| 1 | ISSUED DATE: 20/0 | 5/2025 | | | | | |

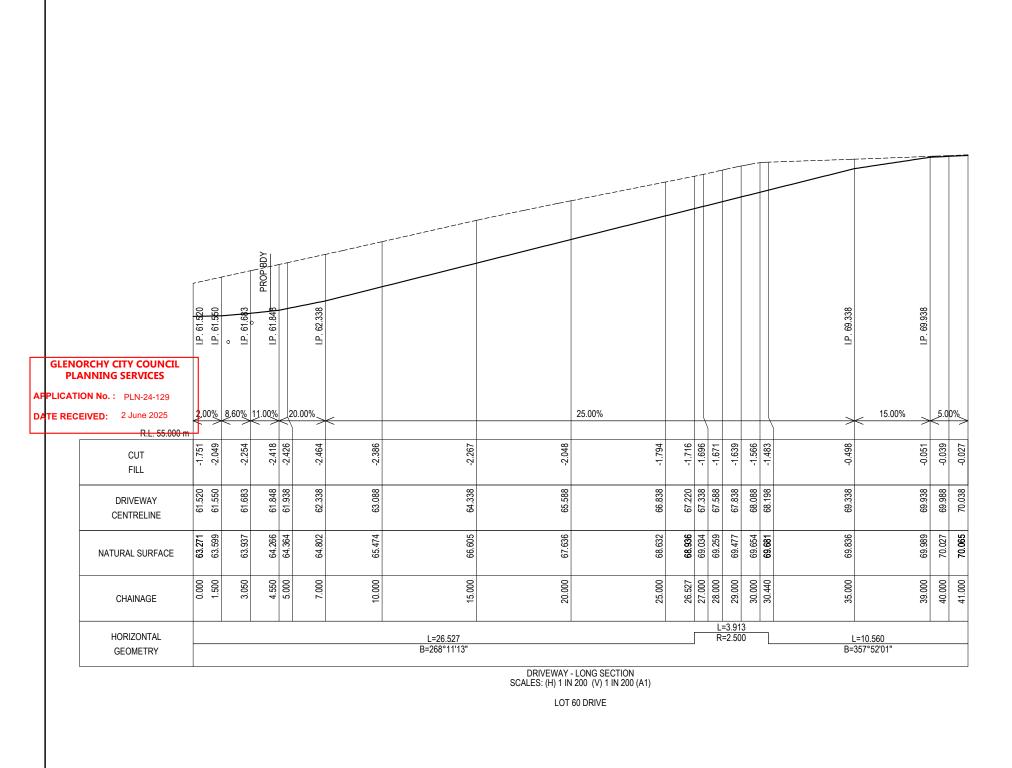
GLENN JAY OJECT DESCRIPTION: 61 LOT RESIDENTIAL SUBDIVISION
15 KARAMBI STREET, CHIGWELL, TAS DRIVEWAY LONG SECTION SHEET 10





| CONTRACT | 127 Bathurst Street Hobart, Tasmania, 7000 PHONE: +61 03 6234 3217 FAX: +61 03 6234 5085 |
|-----------|---|
| JOB NUMBE | EMAIL: pda.hbt@pda.com.au www.pda.com.au |
| 1100 | Also at: Kingston, Launceston & Burnie |


1: 200 (A3) DISCIPLINE SHEET

44035CT C 229 P4

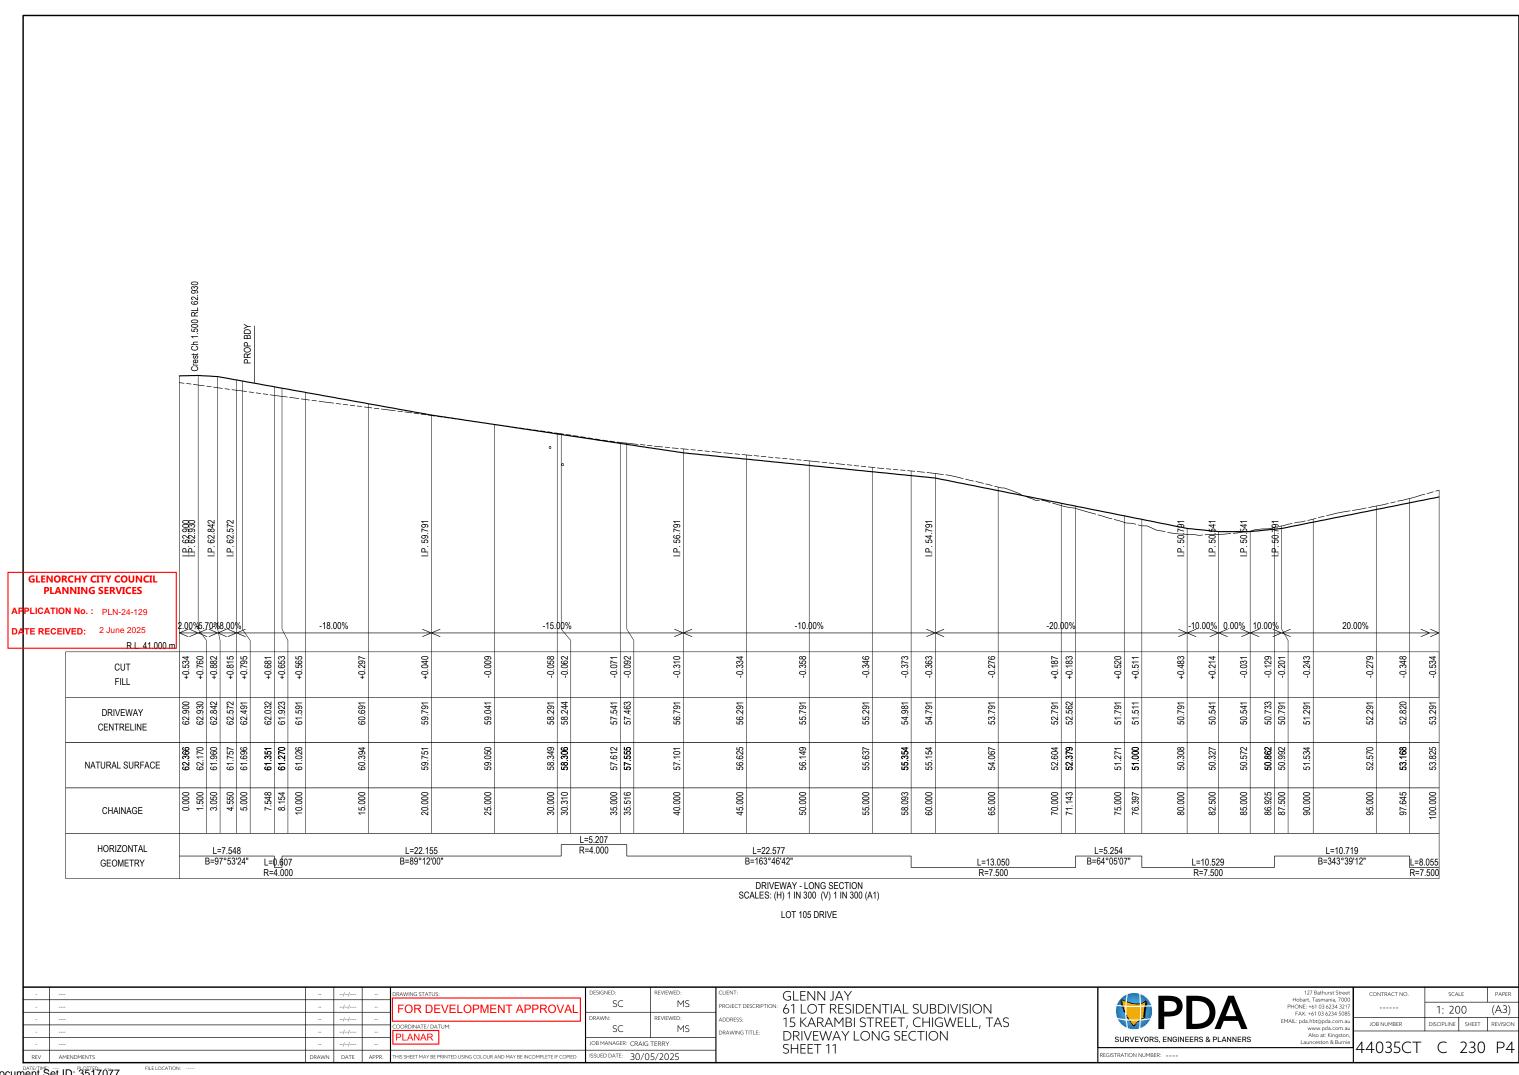

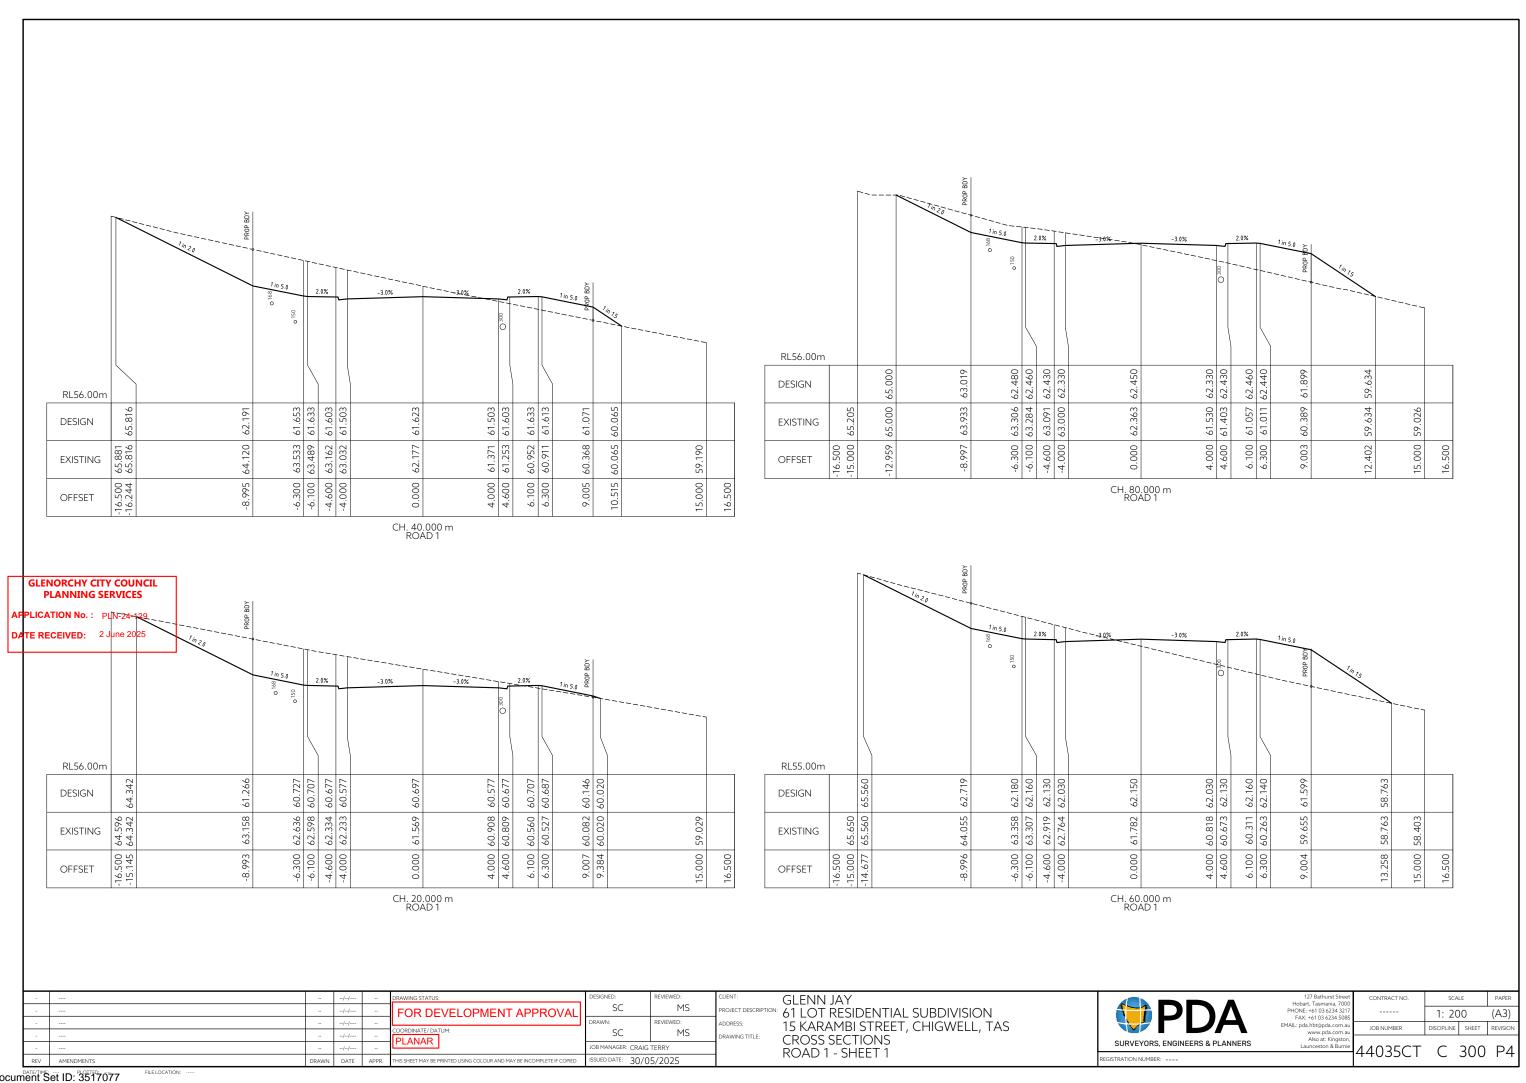

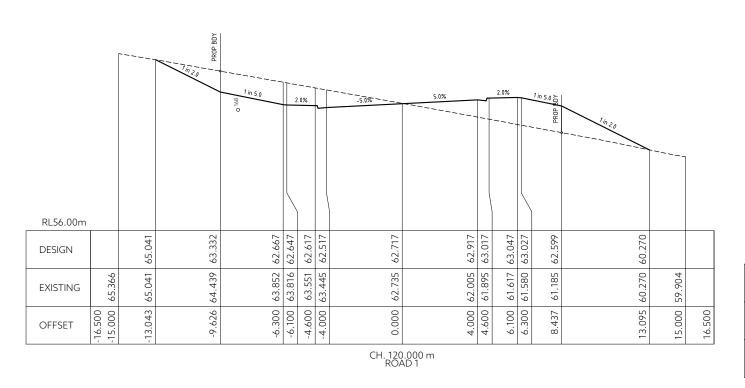

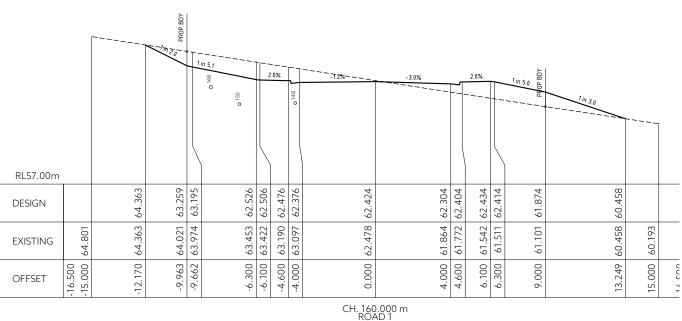

GLENORCHY CITY COUNCIL **PLANNING SERVICES** APPLICATION No.: PLN-24-129 **DATE RECEIVED:** 2 June 2025

-3.0% RL56.00m 64.210 62.697 64.170 62.677 63.871 62.647 63.751 62.547 62.113 62.691 61.986 62.791 61.670 62.821 61.628 62.801 65.646 63.236 62.283 DESIGN .09 65.646 61.075 60.166 65.866 **EXISTING** 16.500 -13.818 -6.300 -6.100 -4.000 6.300 13.121 16.500 OFFSET

CH. 100.000 m ROAD 1

| | | · | TOO BOA | 1 in 5 0 | | 9410 | | -379% | 0.0% | | 2.0% | | 1in50 200 Bud | 1/020 | | |
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| RL57.00m | | | _ | | | | | | | | | | _ | | | |
| DESIGN | | 64.531 | 63.170 | 62.630 | 62.610 | 62.580 | 62.480 | 62.600 | 62 600 | 62.700 | 62.730 | 62.710 | 62.170 | 60.651 | | |
| EXISTING | 65.096 | 64.531 | 64.071 | 63.615 | 63.581 | 63.329 | 63.227 | 62.553 | 41 97 6 | 61.821 | 61.583 | | 61.125 | 199.09 | 60.202 | |
| OFFSET | -16.500 | -11.723 | -9.000 | -6.300 | -6.100 | -4.600 | -4.000 | 0.000 | 000 | 4.600 | 6.100 | 6.300 | 9.000 | 12.038 | 15.000 | 12 EOO |
| | | | | | | | | CH. 140 ROA |).000 m AD 1 | | | | | | | |

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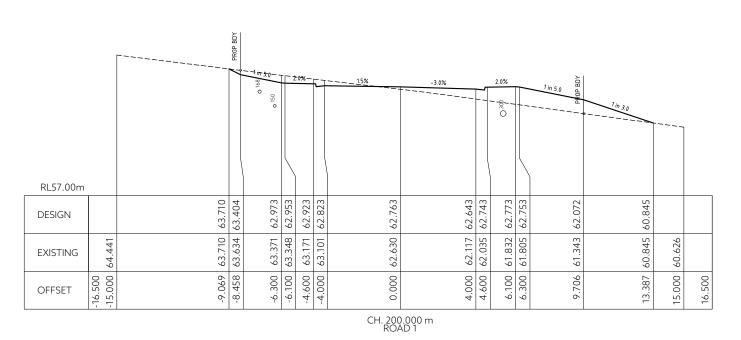
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| | // | | | DRAWN: | REVIEWED: | AD |
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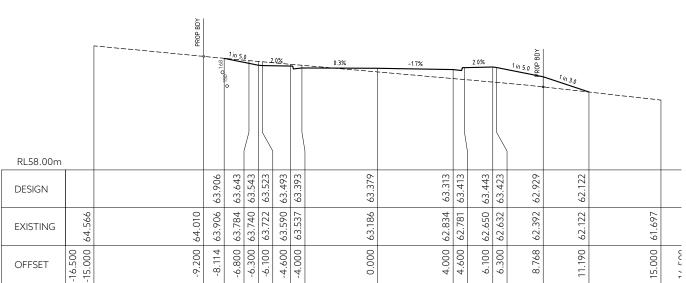
CLIENT: GLENN JAY
PROJECT DESCRIPTION: 61 LOT RESIDENTIAL SUBDIVISION
ADDRESS: 15 KARAMBI STREET, CHIGWELL, TAS
DRAWING TITLE: CROSS SECTIONS
ROAD 1 - SHEET 2

| PDA | |
|---------------------------------|--|
| SURVEYORS, ENGINEERS & PLANNERS | |

| 127 Bathurst Street Hobart, Tasmania, 7000 | CONTRACT NO. | SCA | PAPER | |
|--|--------------|------------|-------|----------|
| PHONE: +61 03 6234 3217 FAX: +61 03 6234 5085 | | 1: 20 | (A3) | |
| MAIL: pda.hbt@pda.com.au www.pda.com.au | JOB NUMBER | DISCIPLINE | SHEET | REVISION |
| Also at: Kingston, Launceston & Burnie | 4.403ECT | | 201 | |

44035CT C 301 P4





GLENORCHY CITY COUNCIL **PLANNING SERVICES** APPLICATION No.: PLN-24-129 DATE RECEIVED: 2 June 2025 RL57.00m 62.332 63.183
 6.100
 61.484
 62.462

 6.300
 61.458
 62.442
 702 61.667 DESIGN 62. 61.756 60.955 63.995 63.120 62.276 60.500 EXISTING 60. -6.205 10.177 12.435 0.000 15.000 13.675 16.500 OFFSET CH. 180.000 m ROAD 1

| | | | O 150 PROP BDY | 7 — — — — — — — — — — — — — — — — — — — | 2 | .0% | | | -2.3% | | 2.0% | | 1 in 5.0 Ob | 1 in 3 o | | |
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| RL58.00m | | | | | | | | | | | | | | | | |
| DESIGN | | 64.144 | 63.642 | 63.128 | 63.108 | 63.078 | 62.978 | 63.098 | 63.008 | 63.108 | 63.138 | 63.118 | 62.604 | 61.646 | | |
| EXISTING | 64.725 | 64.144 | 64.030 | 63.745 | 63.723 | 63.557 | 63.490 | 63.047 | 62.603 | 62.537 | 62.354 | 62.329 | 62.006 | 61.646 | 61.214 | |
| OFFSET | -16.500 | -9.874 | -8.871 | -6.300 | -6.100 | -4.600 | -4.000 | 0.000 | 4.000 | 4.600 | 6.100 | 6.300 | 8.870 | 11.742 | 15.000 | 11 500 |
| | | | | | | | | CH. 220 ROA | 0.000 m AD 1 | | | | | | | |

CH. 240.000 m ROAD 1

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| SC | MS | DRA | | | | |
| JOB MANAGER: CRAIG TERRY | | | | | | |
| ISSUED DATE: 30/0 | 5/2025 | 1 | | | | |

CLIENT:

GLENN JAY

PROJECT DESCRIPTION:

61 LOT RESIDENTIAL SUBDIVISION

ADDRESS:

15 KARAMBI STREET, CHIGWELL, TAS


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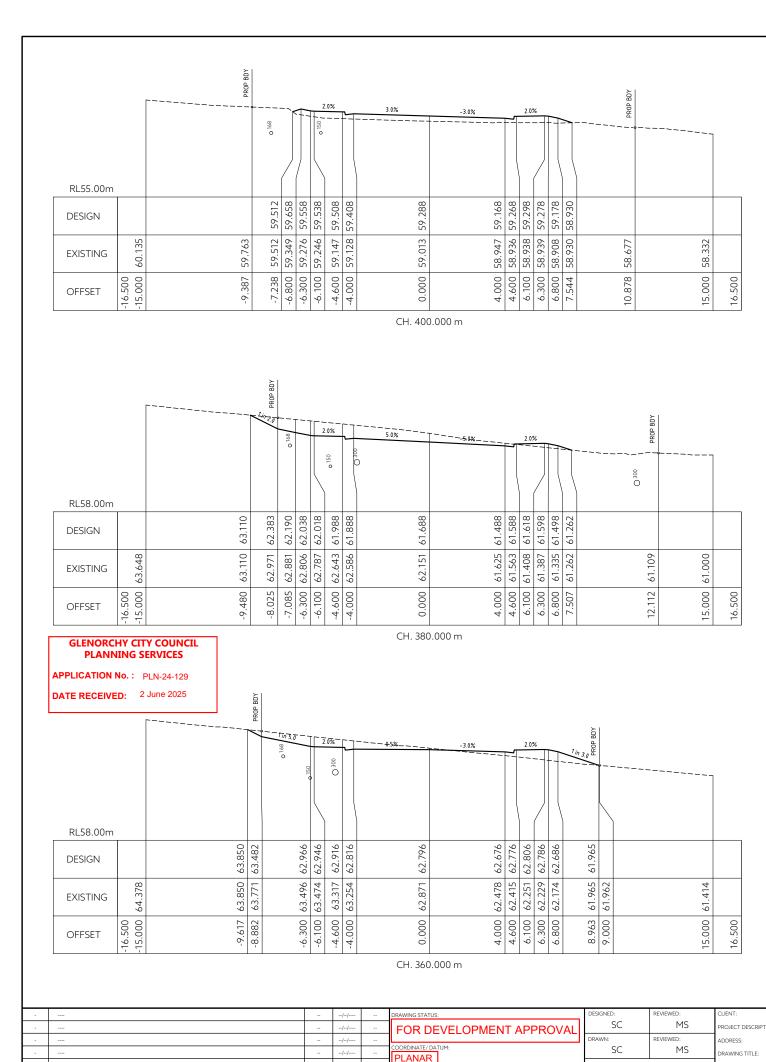
CROSS SECTIONS

ROAD 1 - SHEET 3

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| PHONE: +61 03 6234 3217 FAX: +61 03 6234 5085 | | 1: 20 | 00 | (A3) |
| MAIL: pda.hbt@pda.com.au www.pda.com.au | JOB NUMBER | DISCIPLINE | SHEET | REVISION |
| Also at: Kingston, Launceston & Burnie | 4402ECT | | 202 | DΛ |
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GLENN JAY
61 LOT RESIDENTIAL SUBDIVISION
15 KARAMBI STREET, CHIGWELL, TAS
CROSS SECTIONS
ROAD 1 - SHEET 5

MANAGER: CRAIG TERRY

ISSUED DATE: 30/05/2025
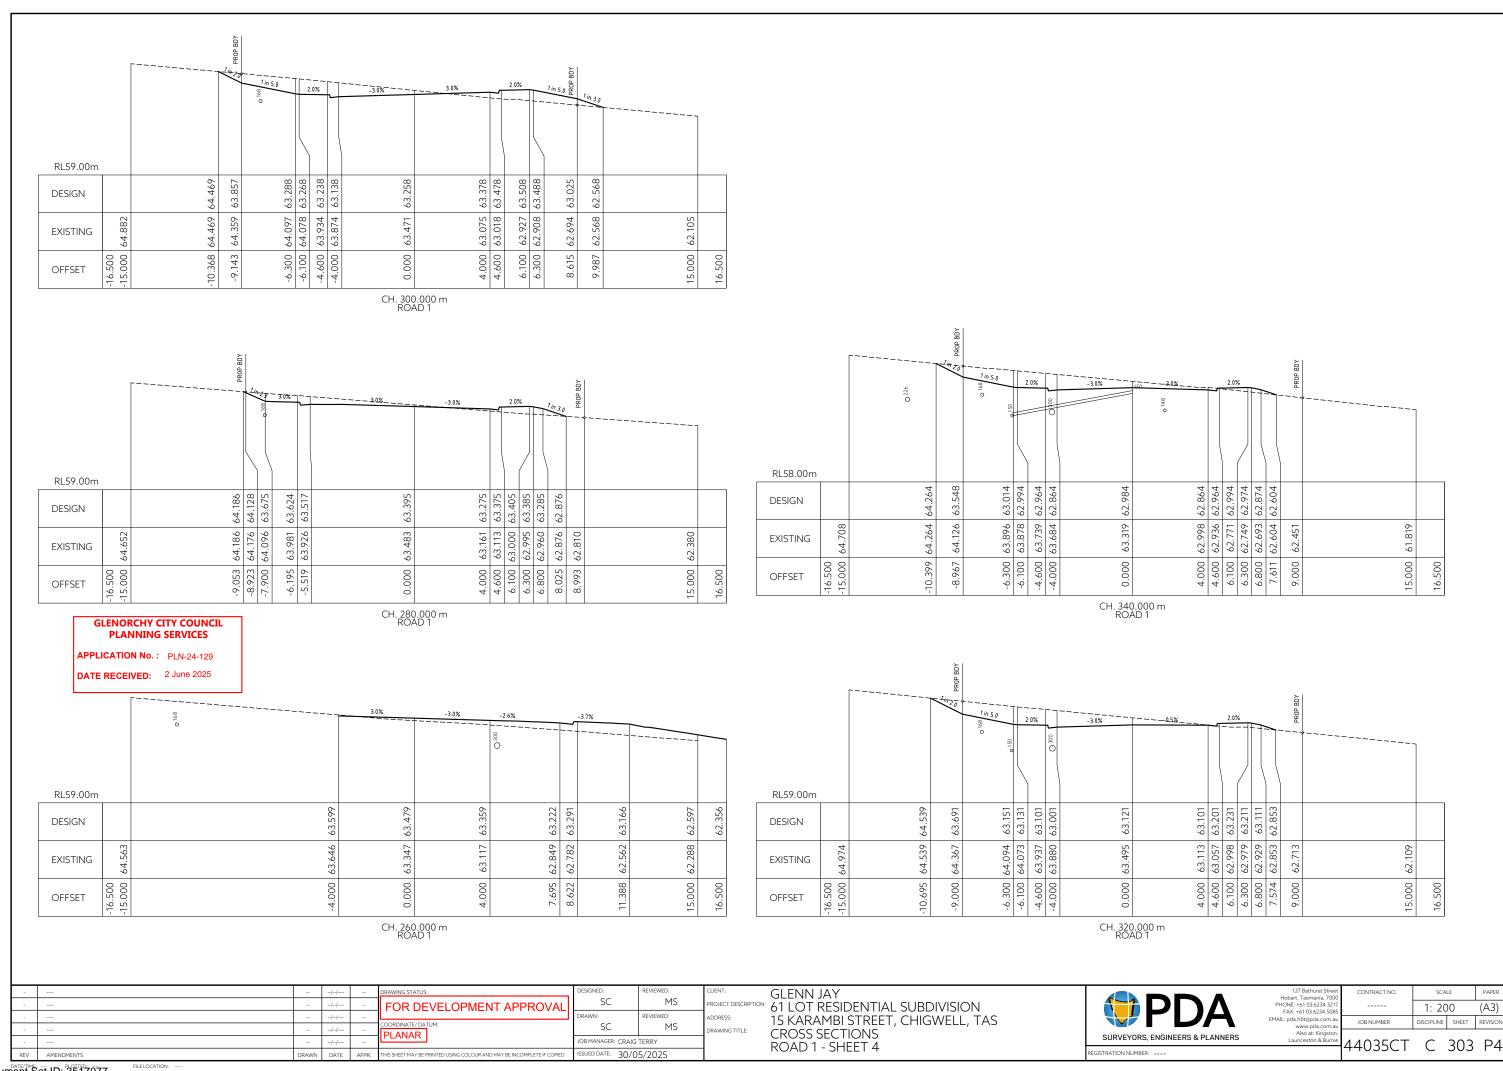
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SURVEYORS, ENGINEERS & PLANNERS


127 Bathurst Street
Hobart, Tasmania, 7000
PHONE: +61 03 6234 3217
FAX: +61 03 6234 5085
EMAIL: pda.hbt@pda.com.au
www.pda.com.au
Also at: Kingston,
Launceston & Burnie


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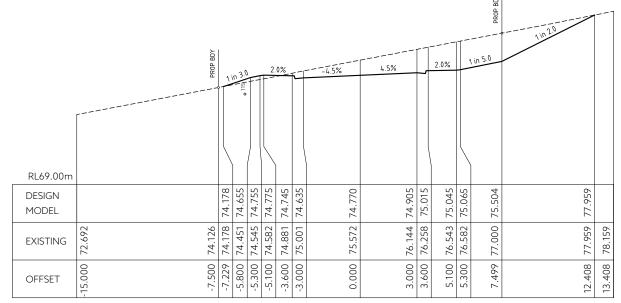




CH. 122.018 m Road 2

GLENORCHY CITY COUNCIL PLANNING SERVICES

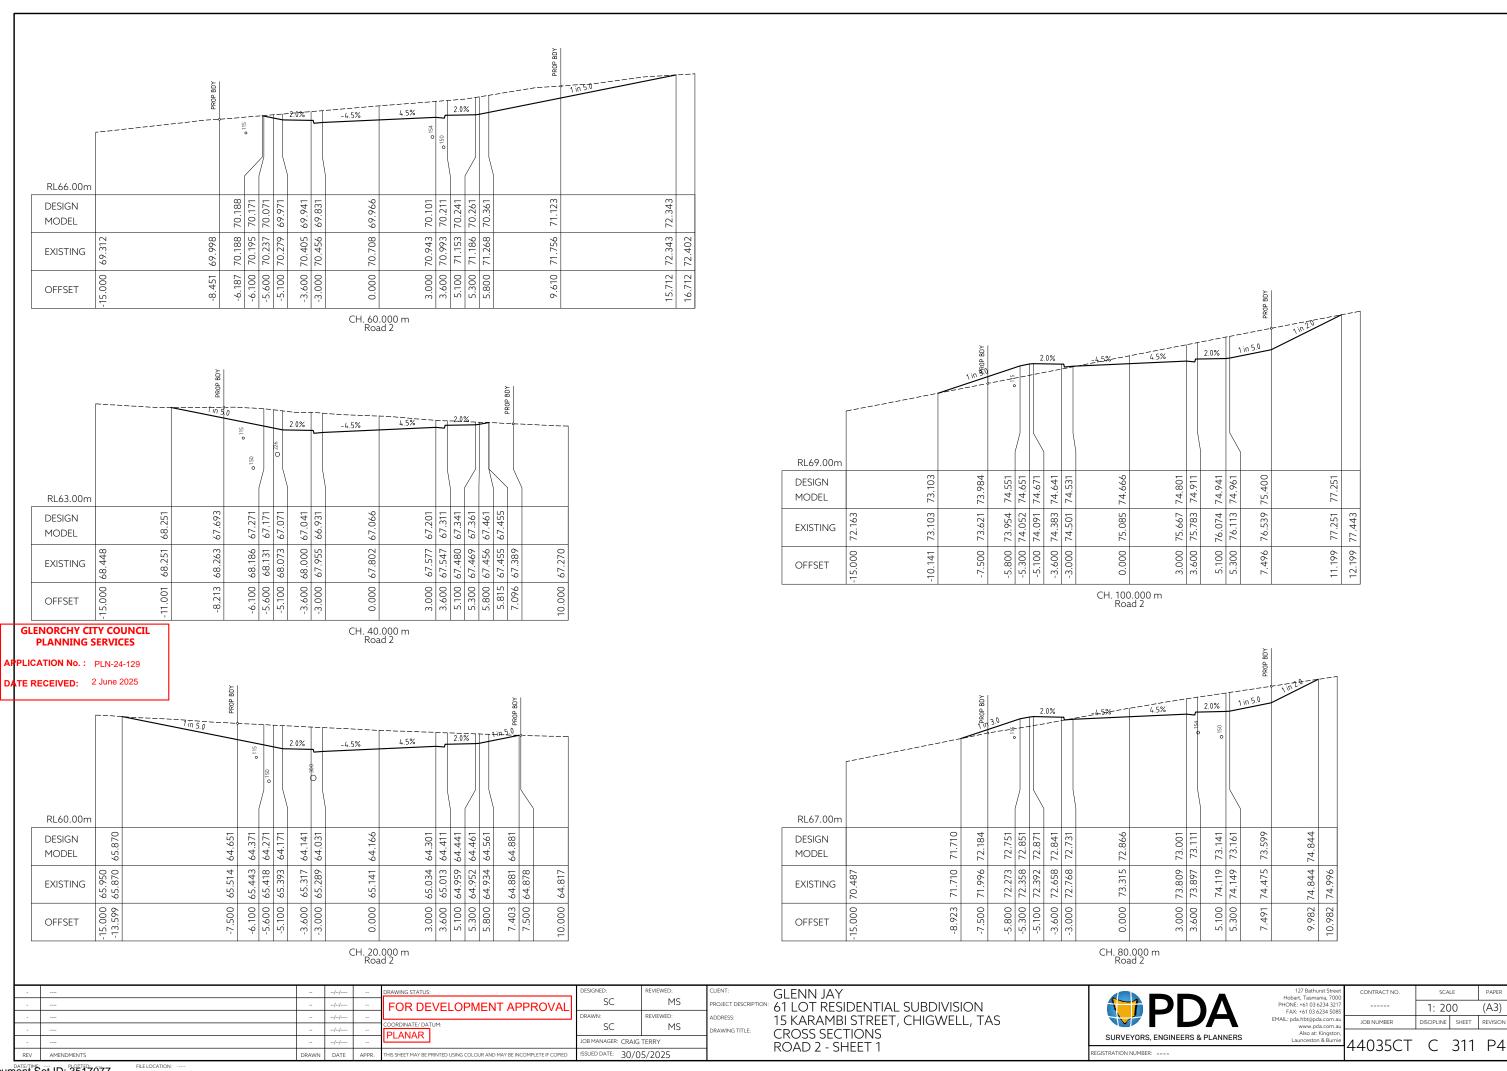APPLICATION No.: PLN-24-129 **DATE RECEIVED:** 2 June 2025

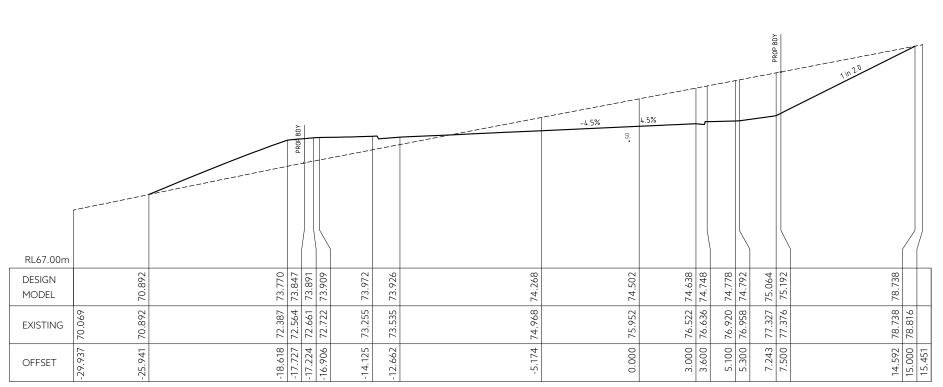

CH. 108.000 m Road 2

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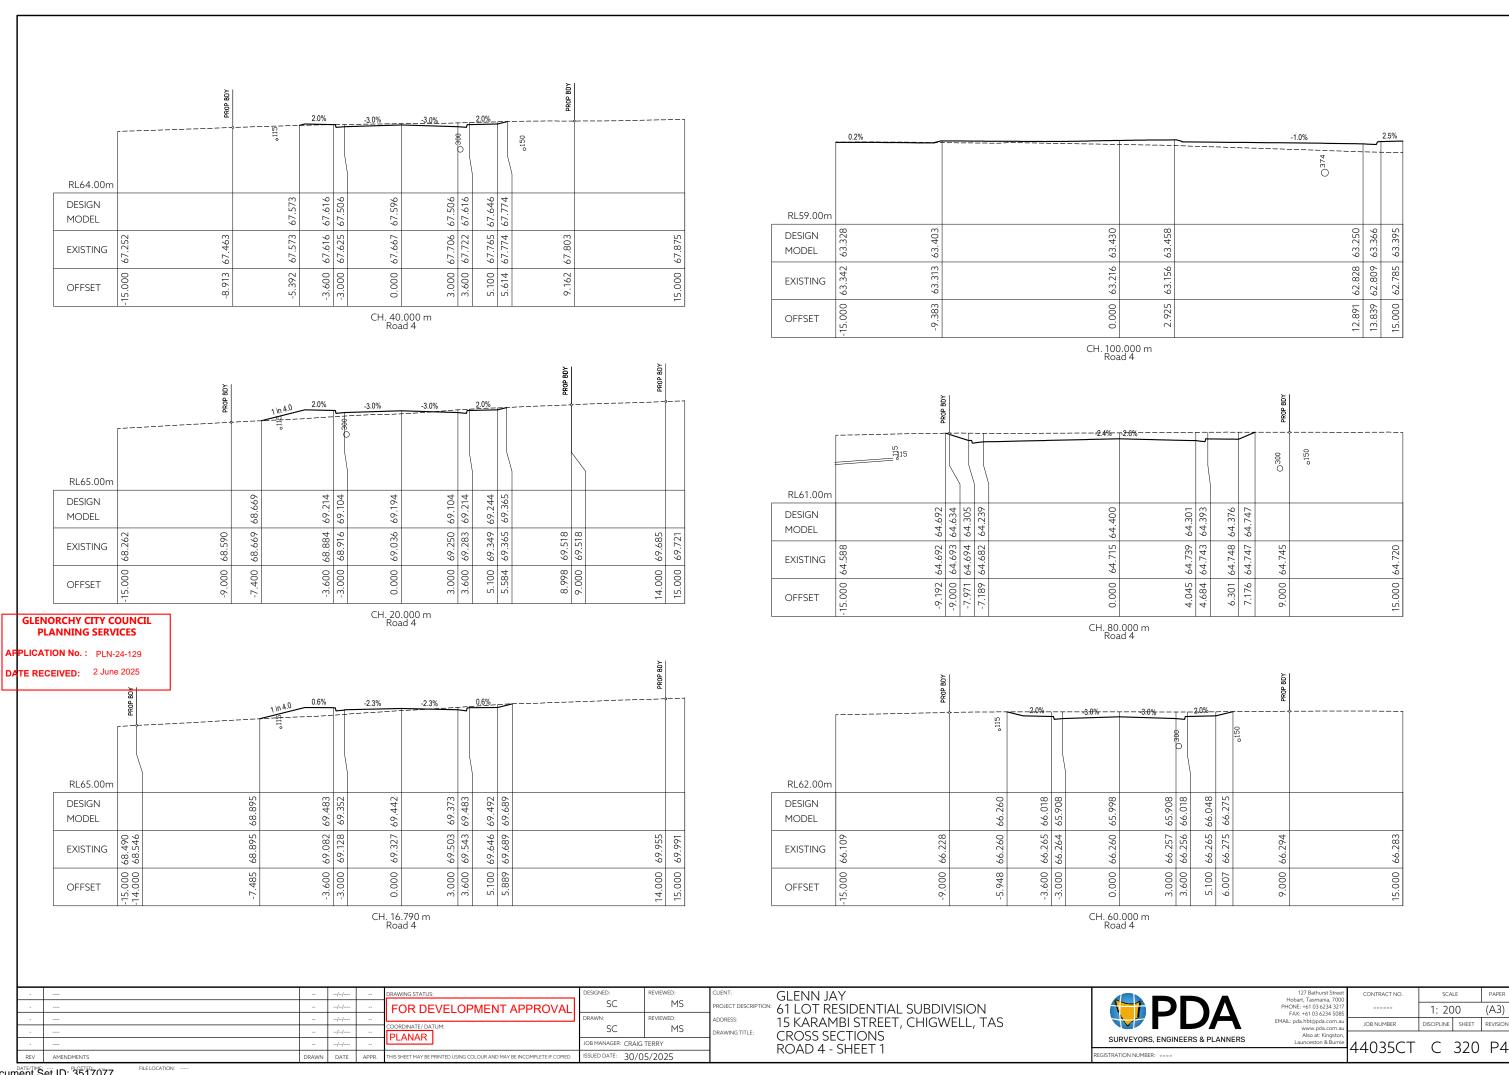
CLIENT: GLENN JAY
PROJECT DESCRIPTION: 61 LOT RESIDENTIAL SUBDIVISION
ADDRESS: 15 KARAMBI STREET, CHIGWELL, TAS
DRAWING TITLE: CROSS SECTIONS
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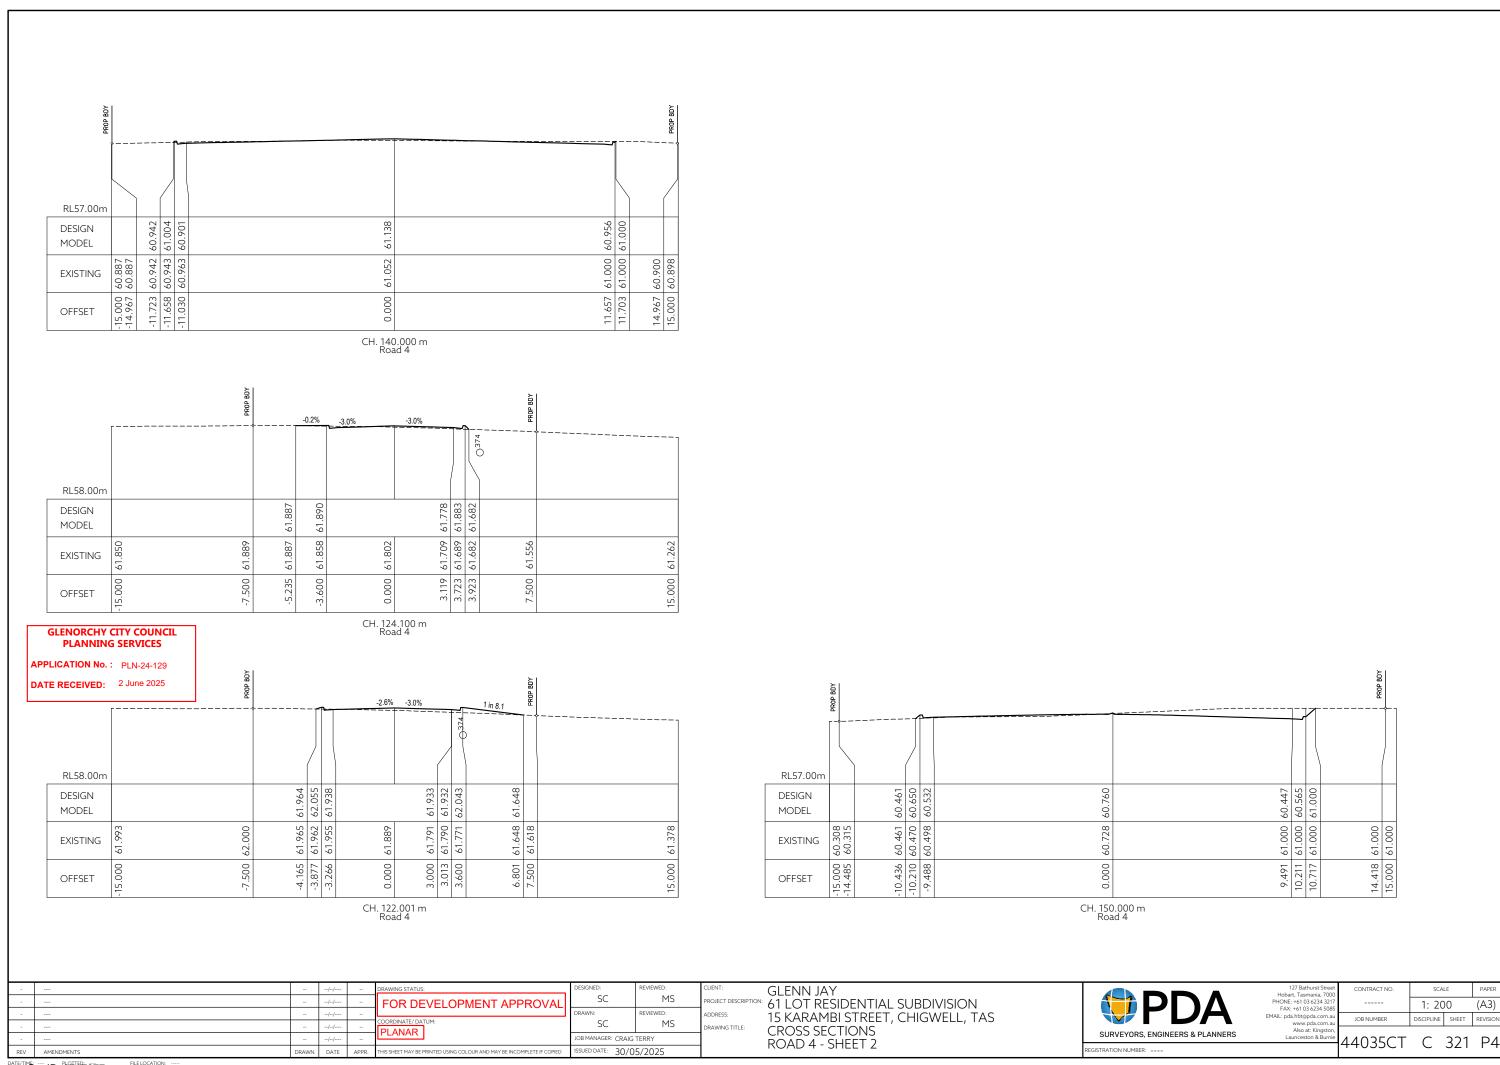
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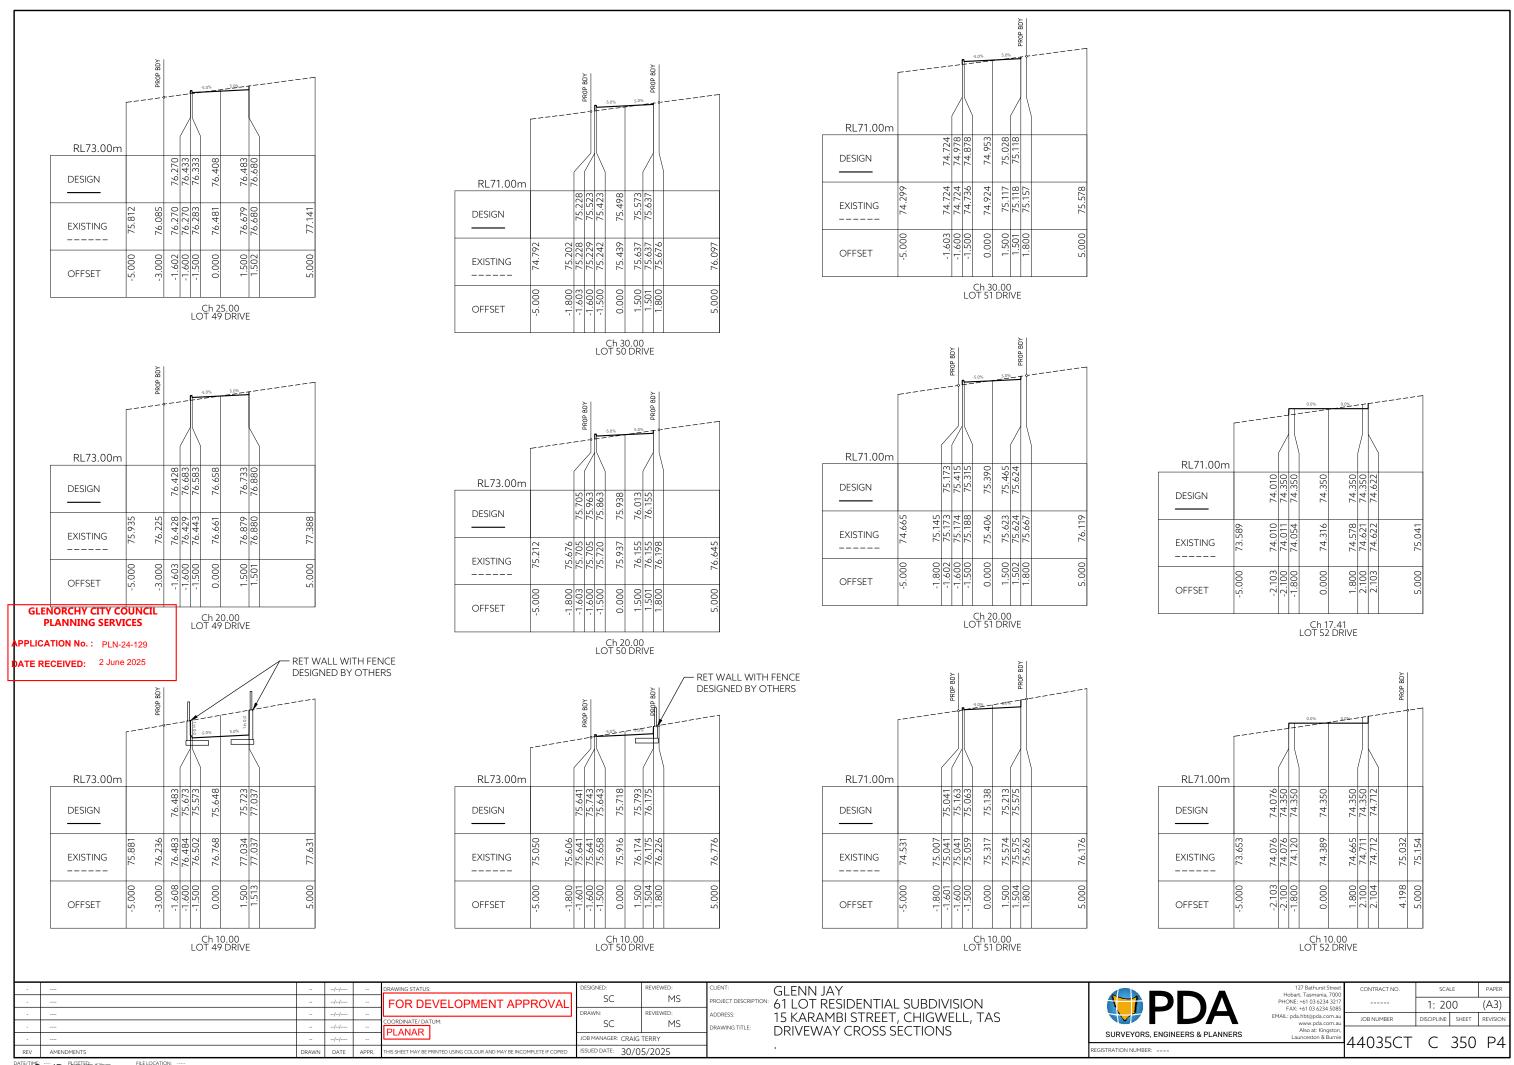
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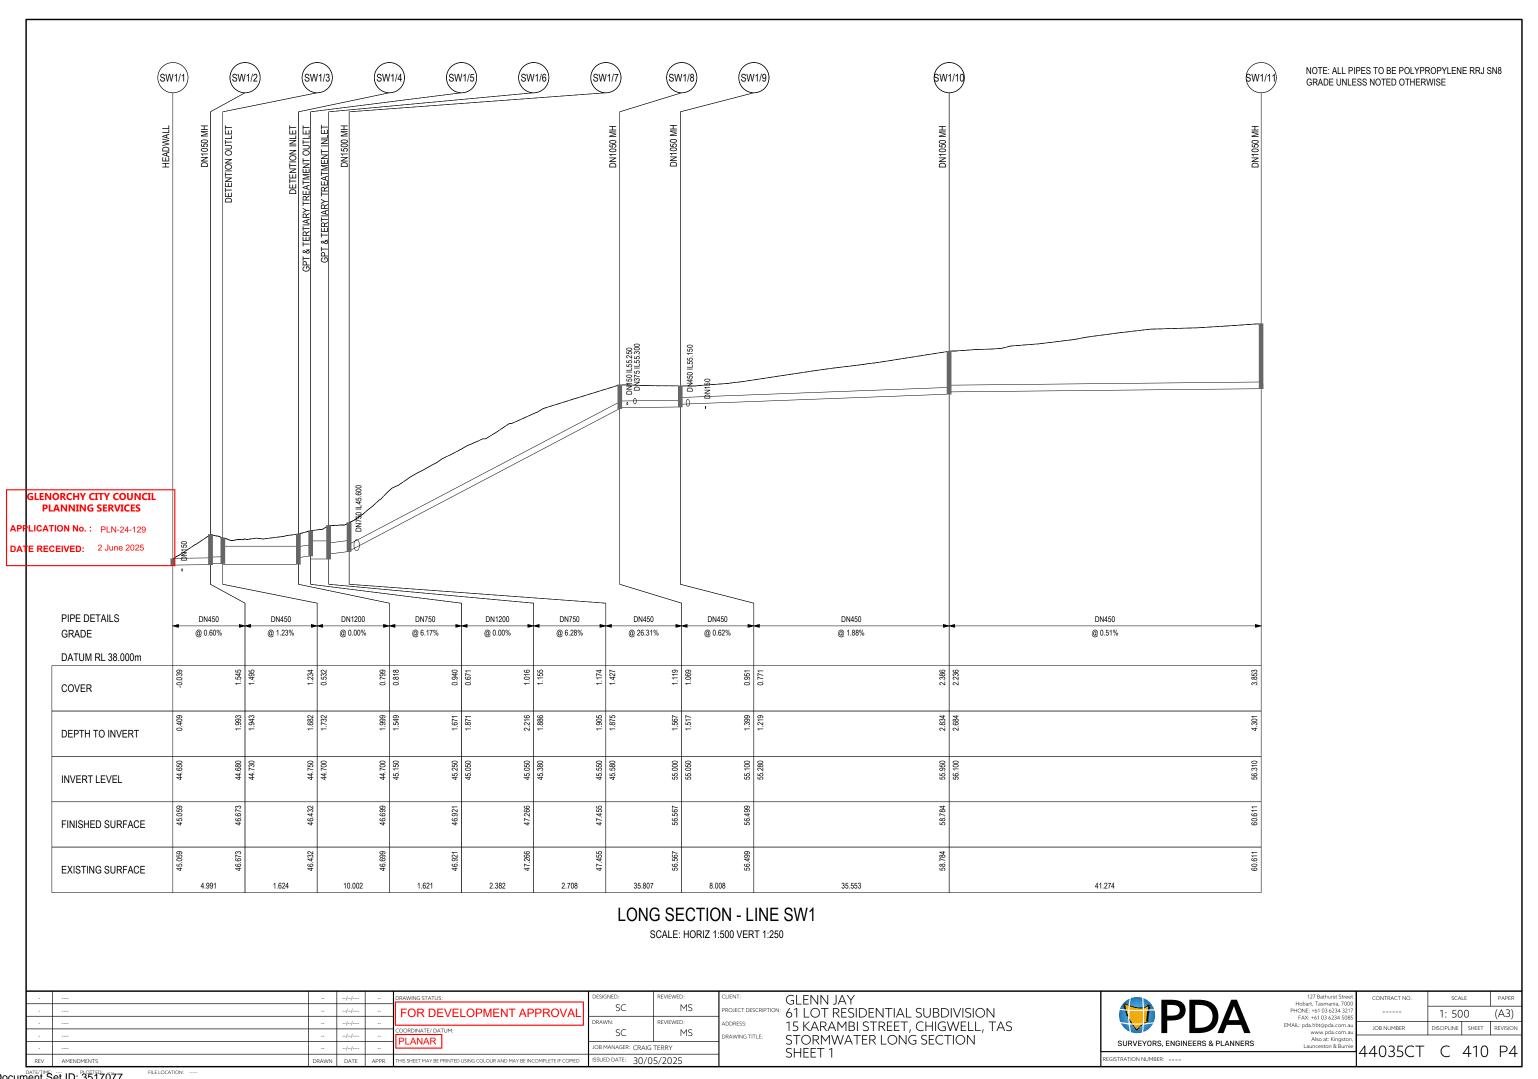
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| Hobart, Tasmania, 7000 | | L |
| PHONE: +61 03 6234 3217 | | |
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| MAIL: pda.hbt@pda.com.au | IOB NUMBER | |
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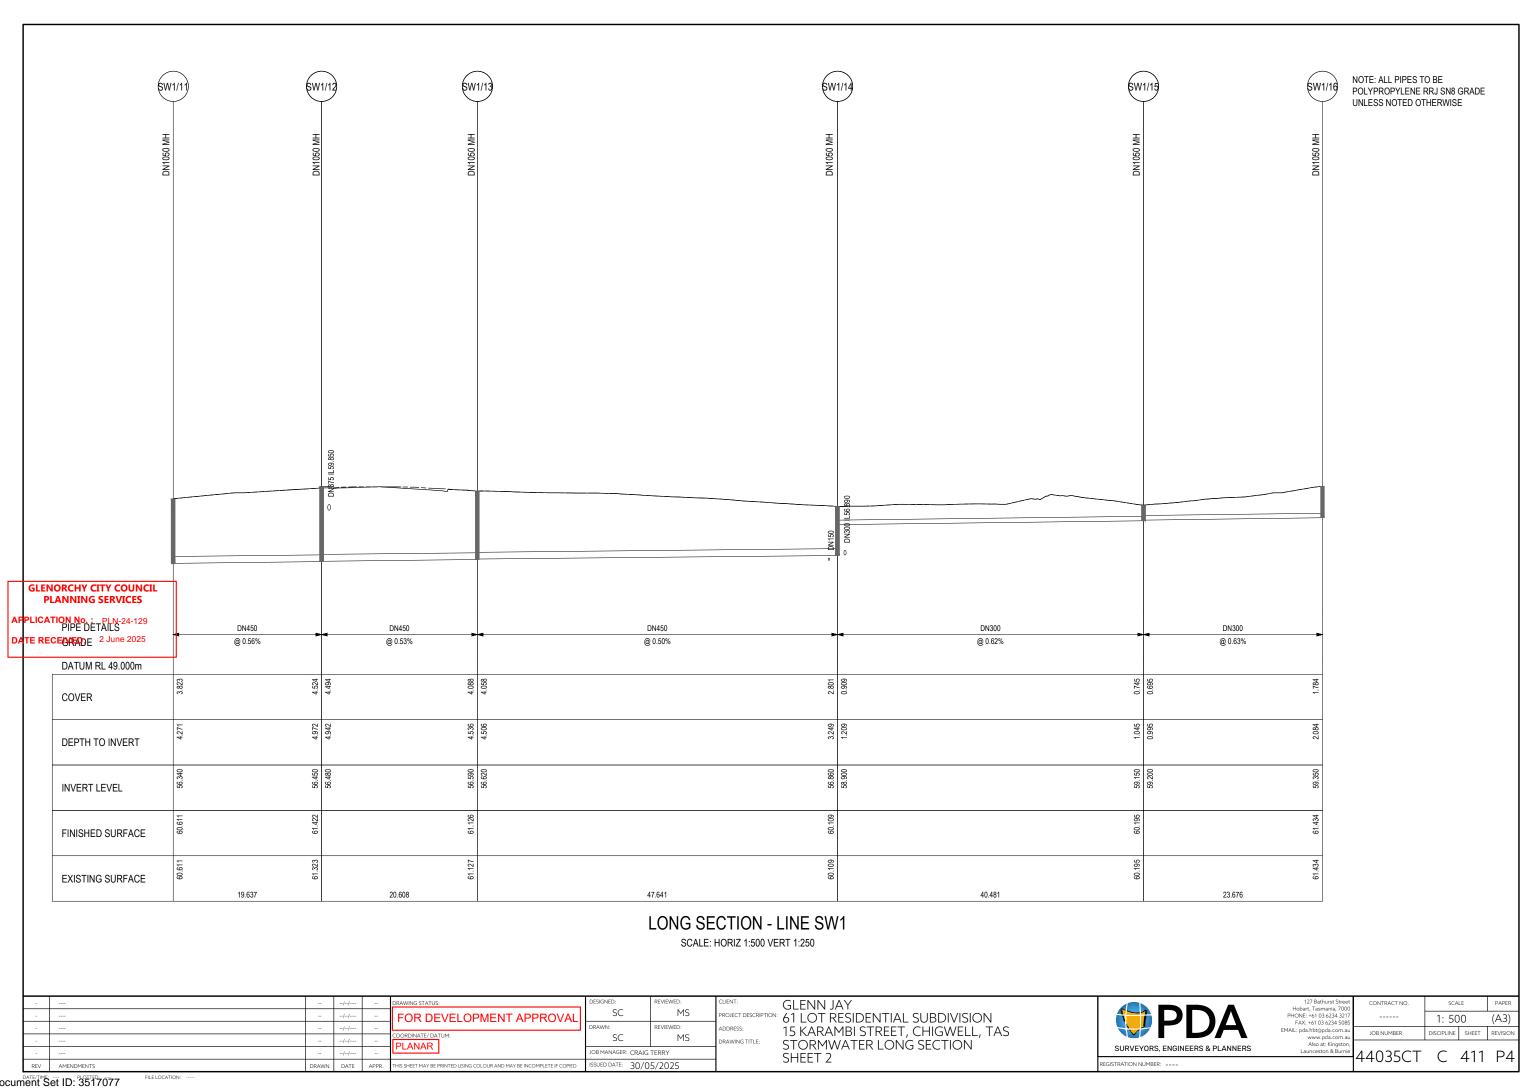
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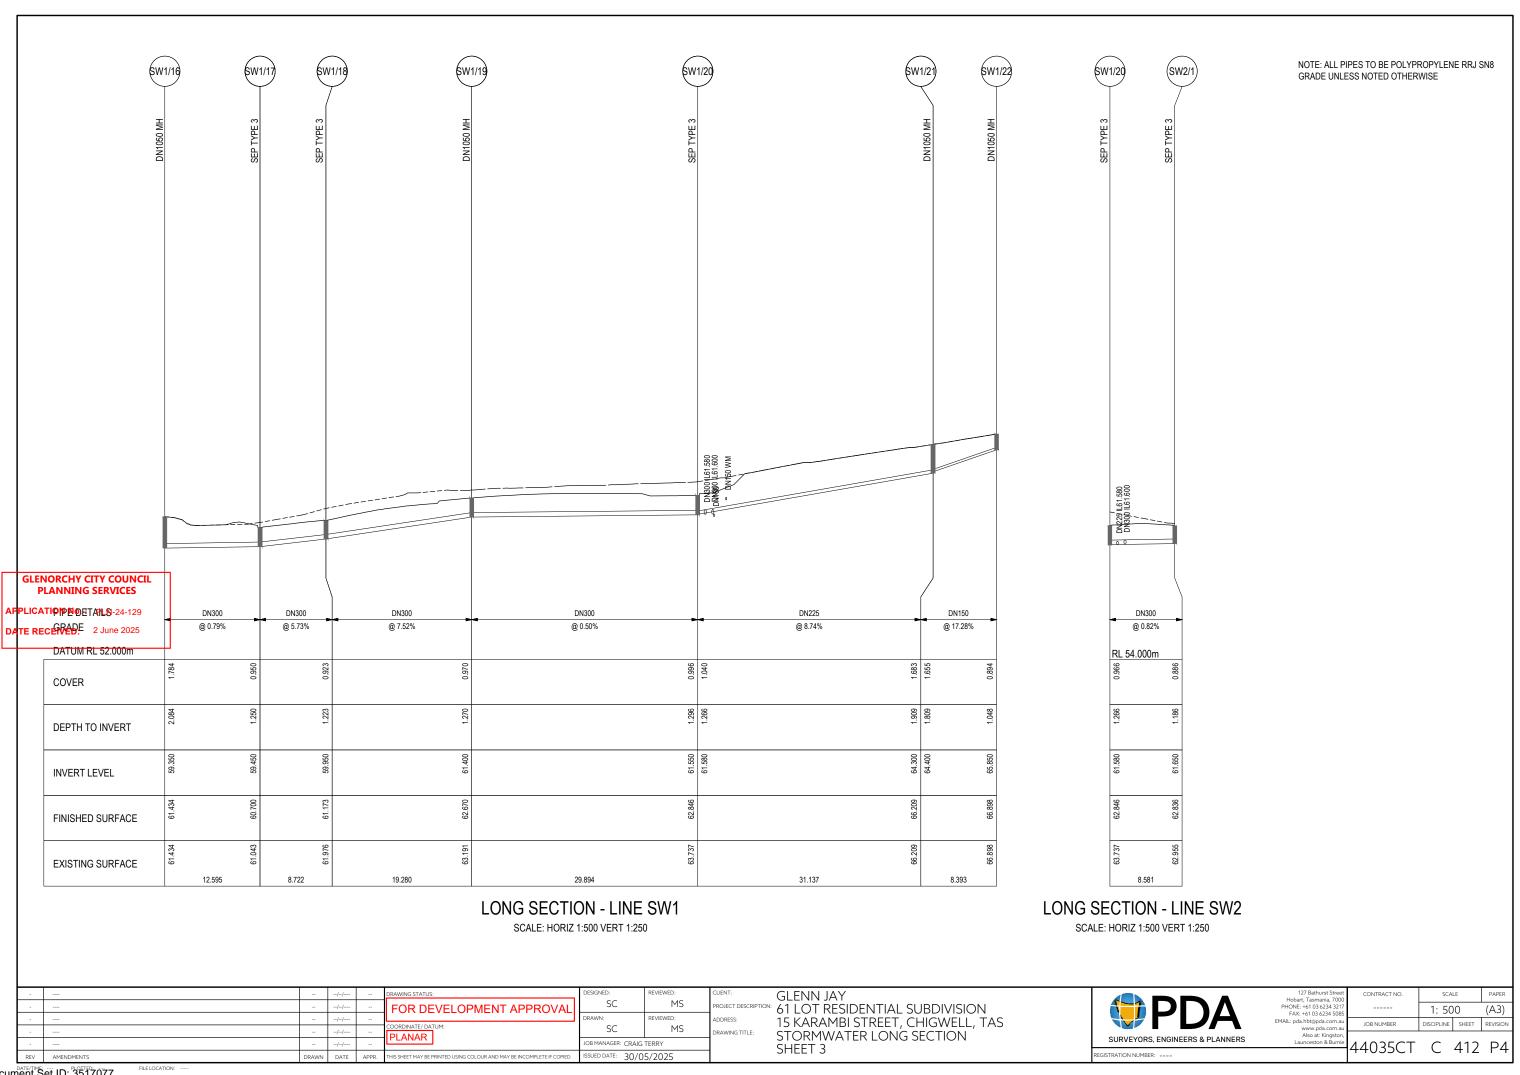

















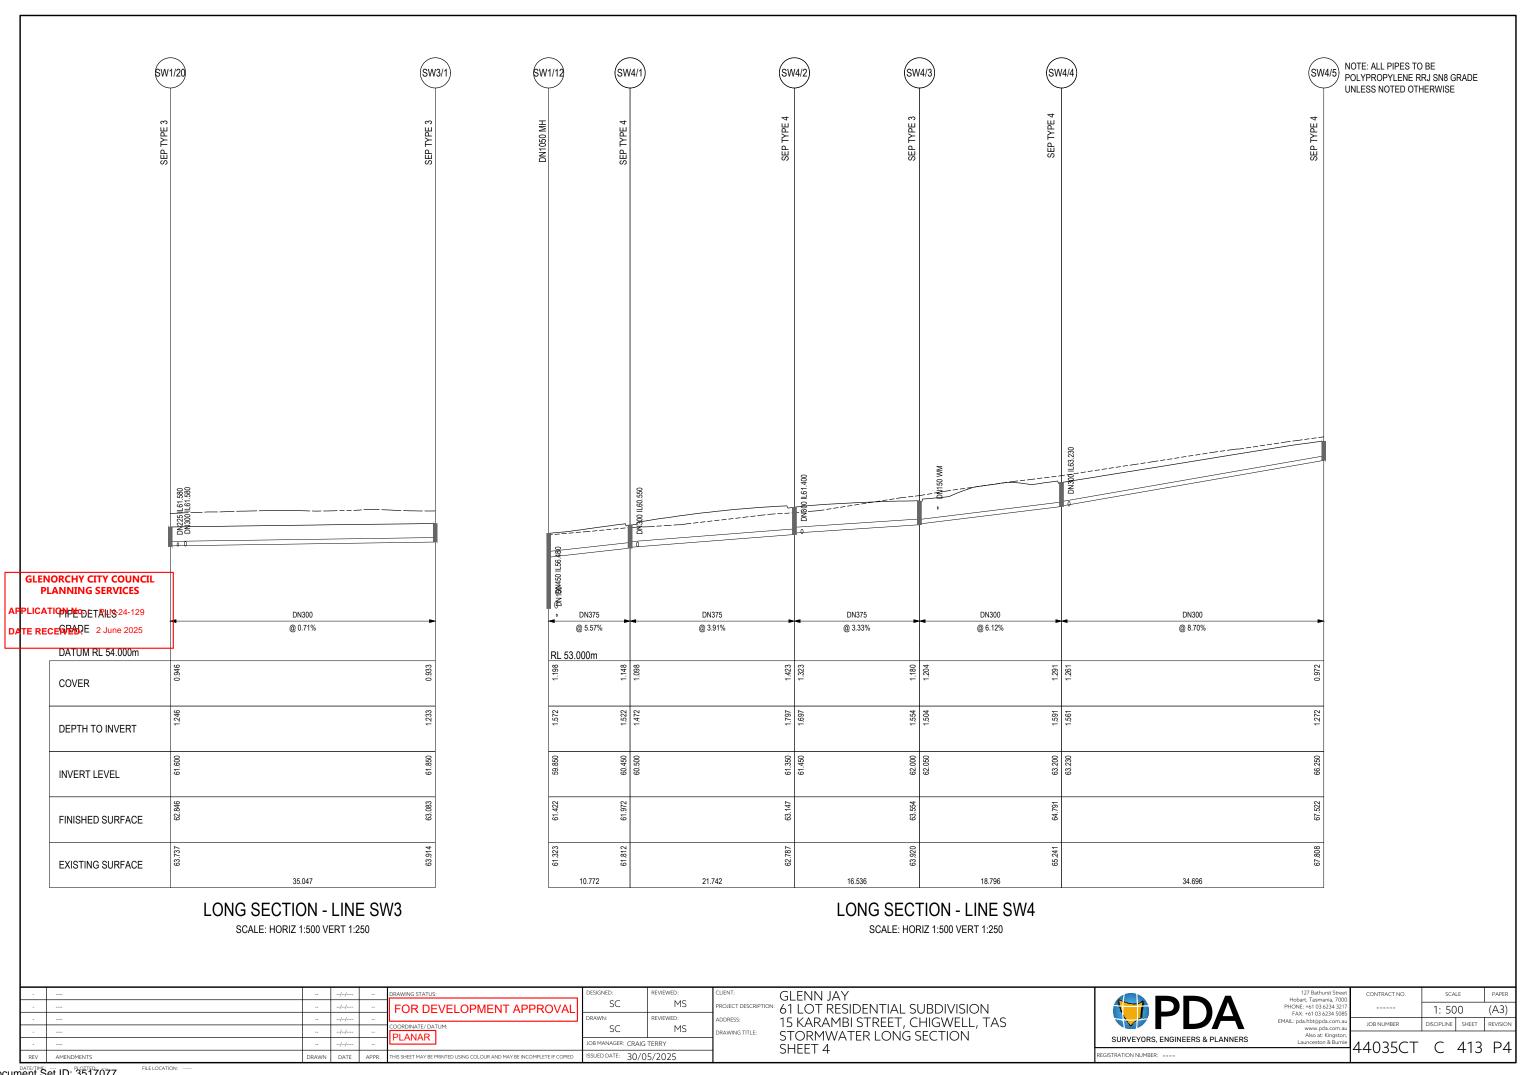


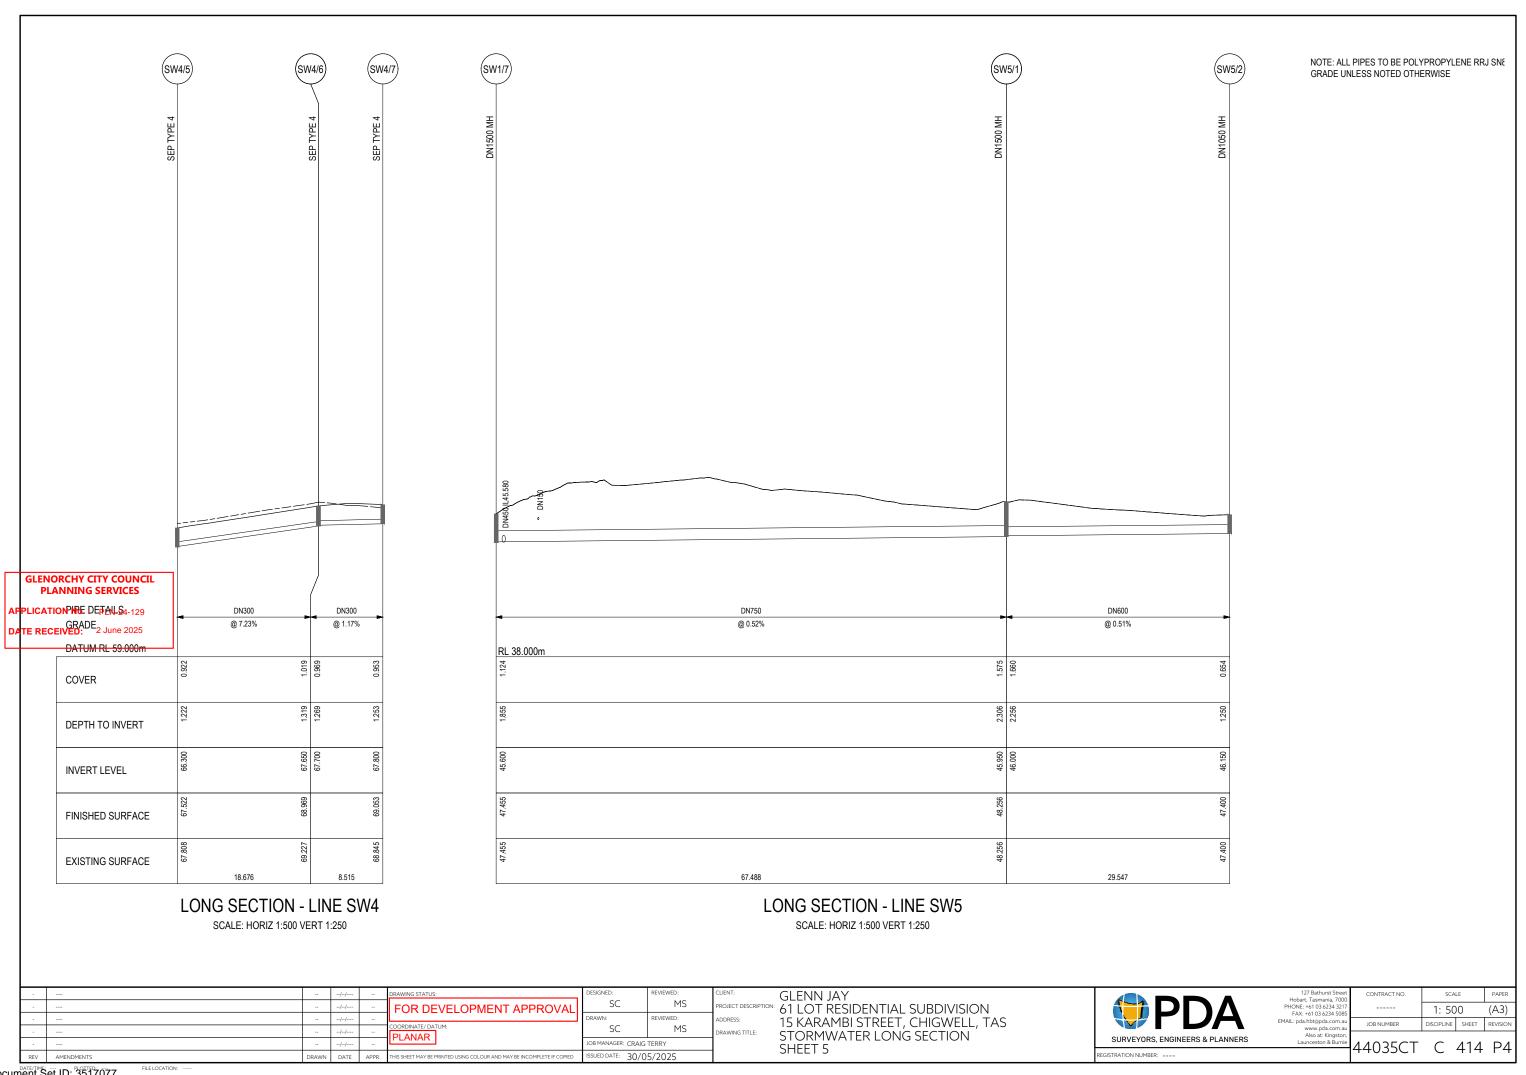


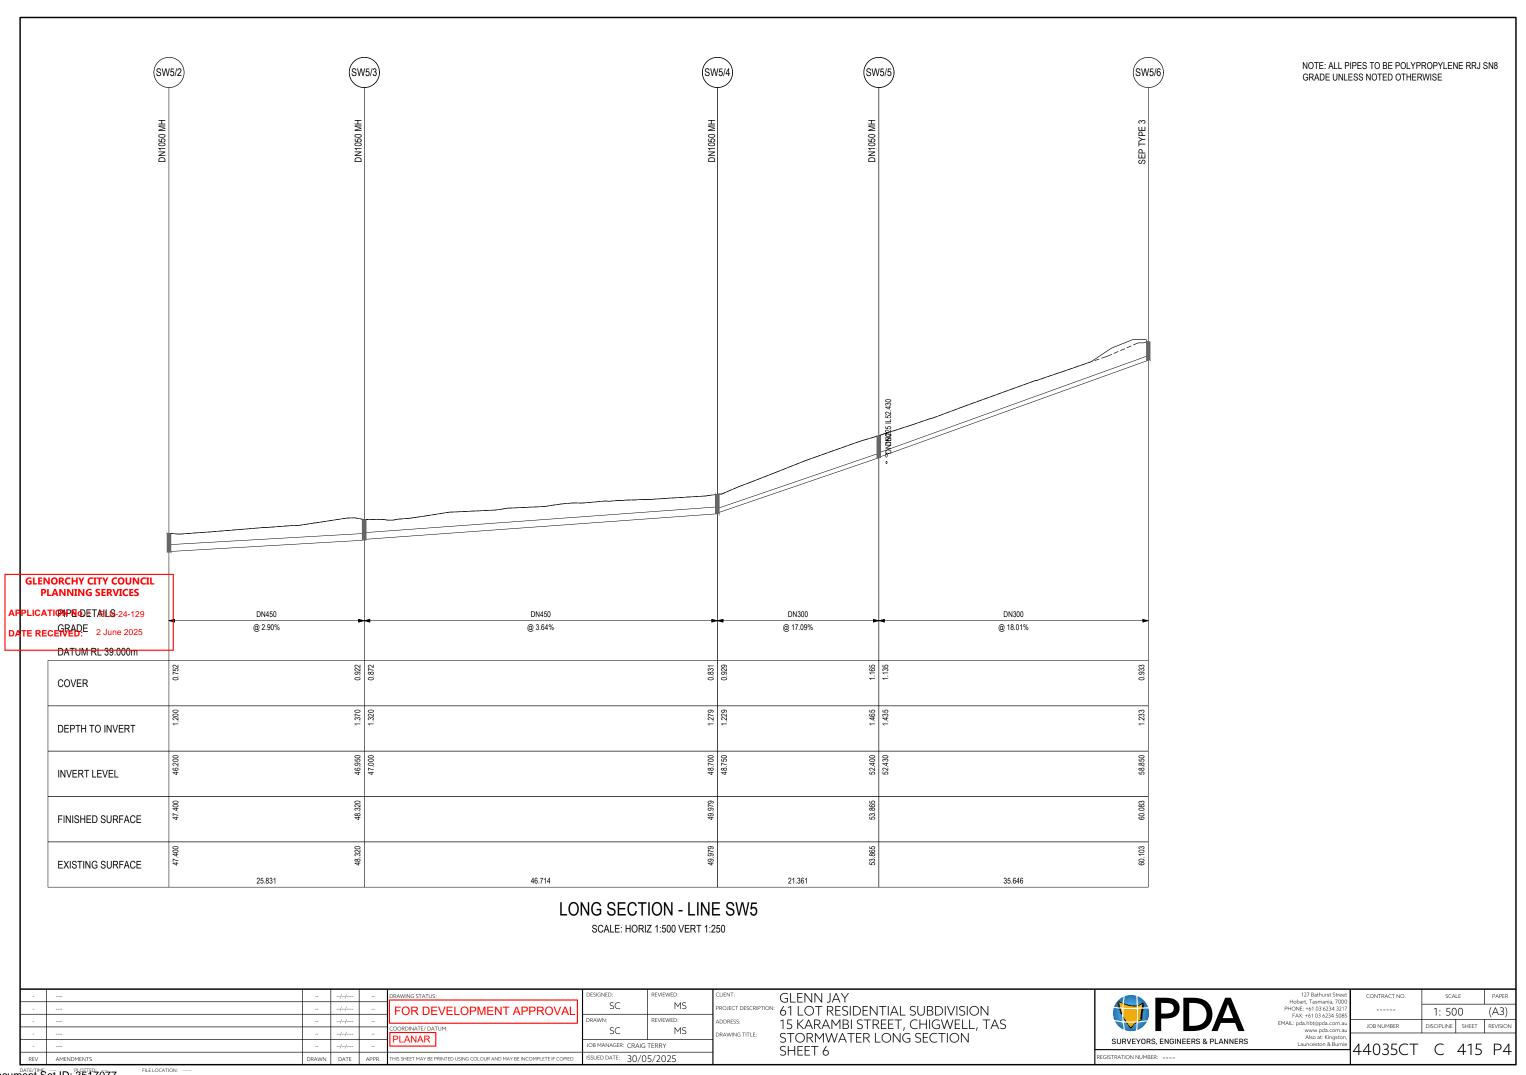


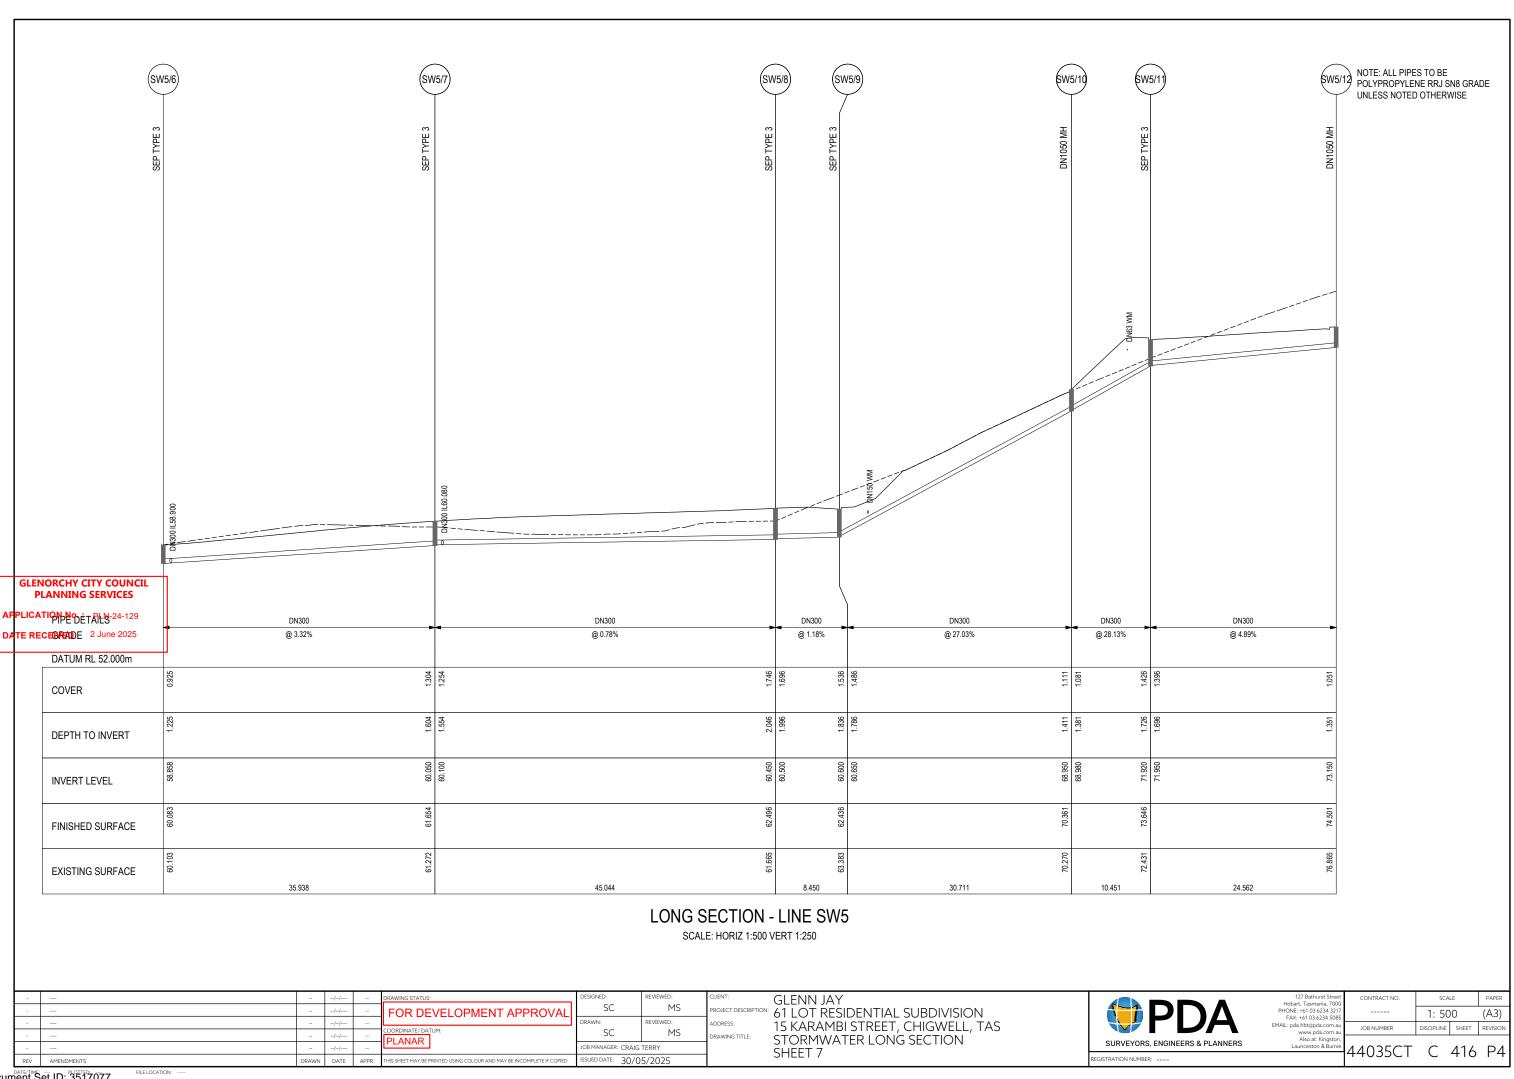


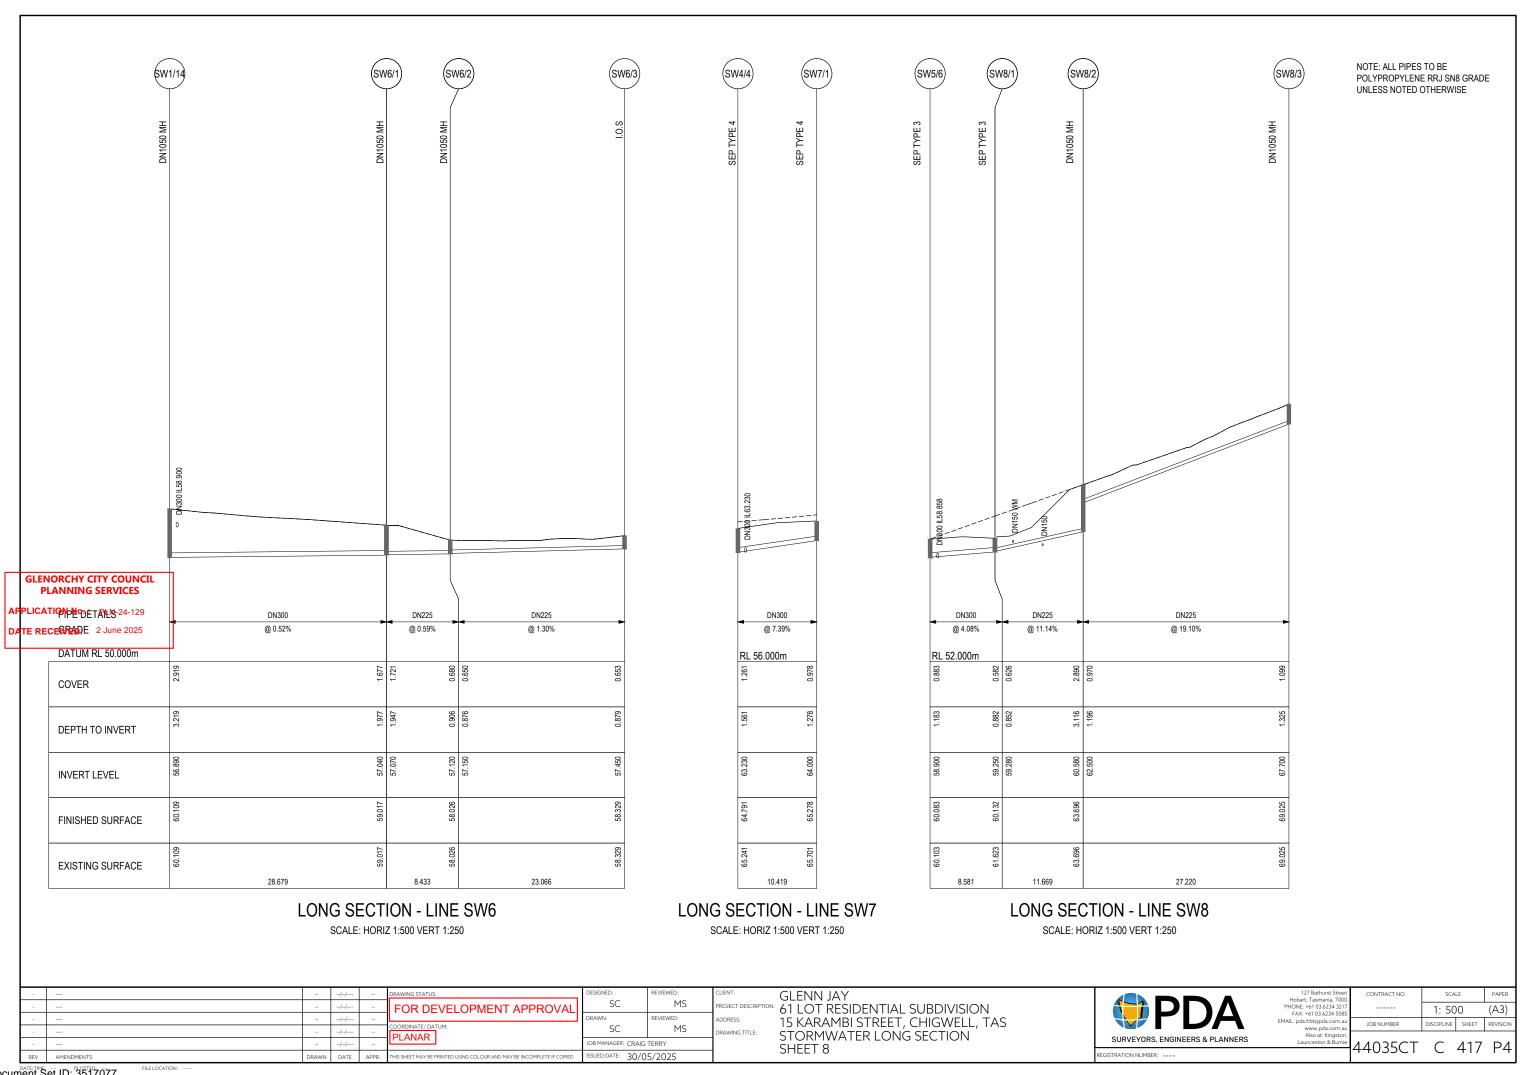


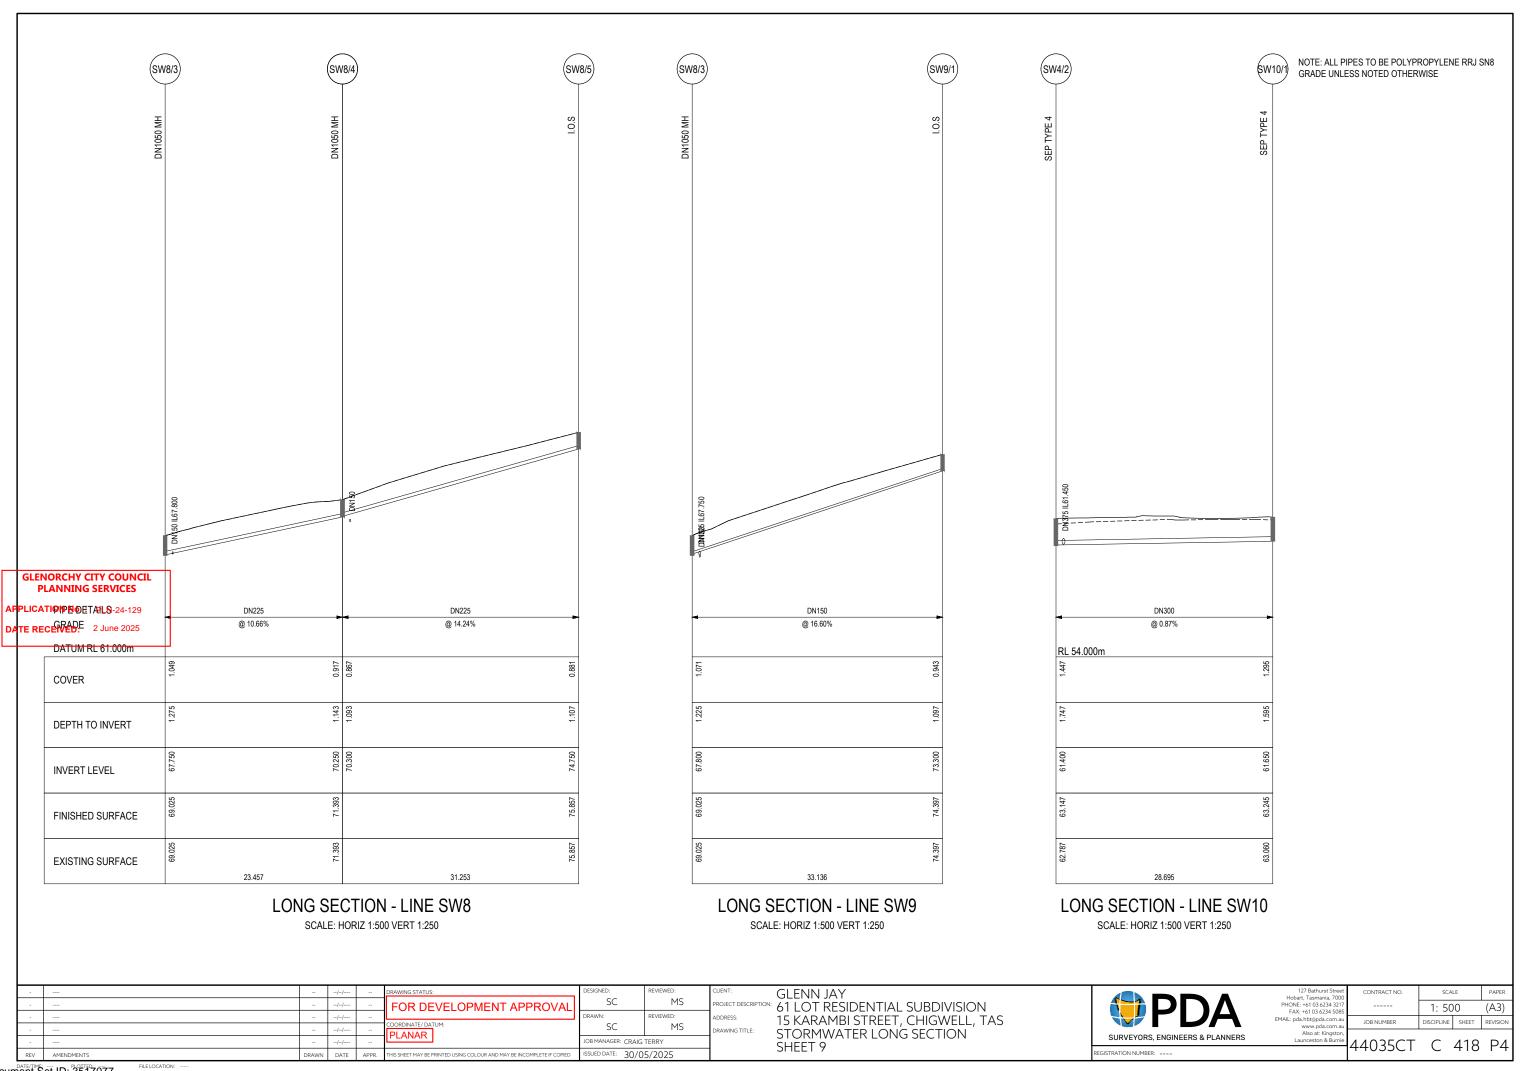


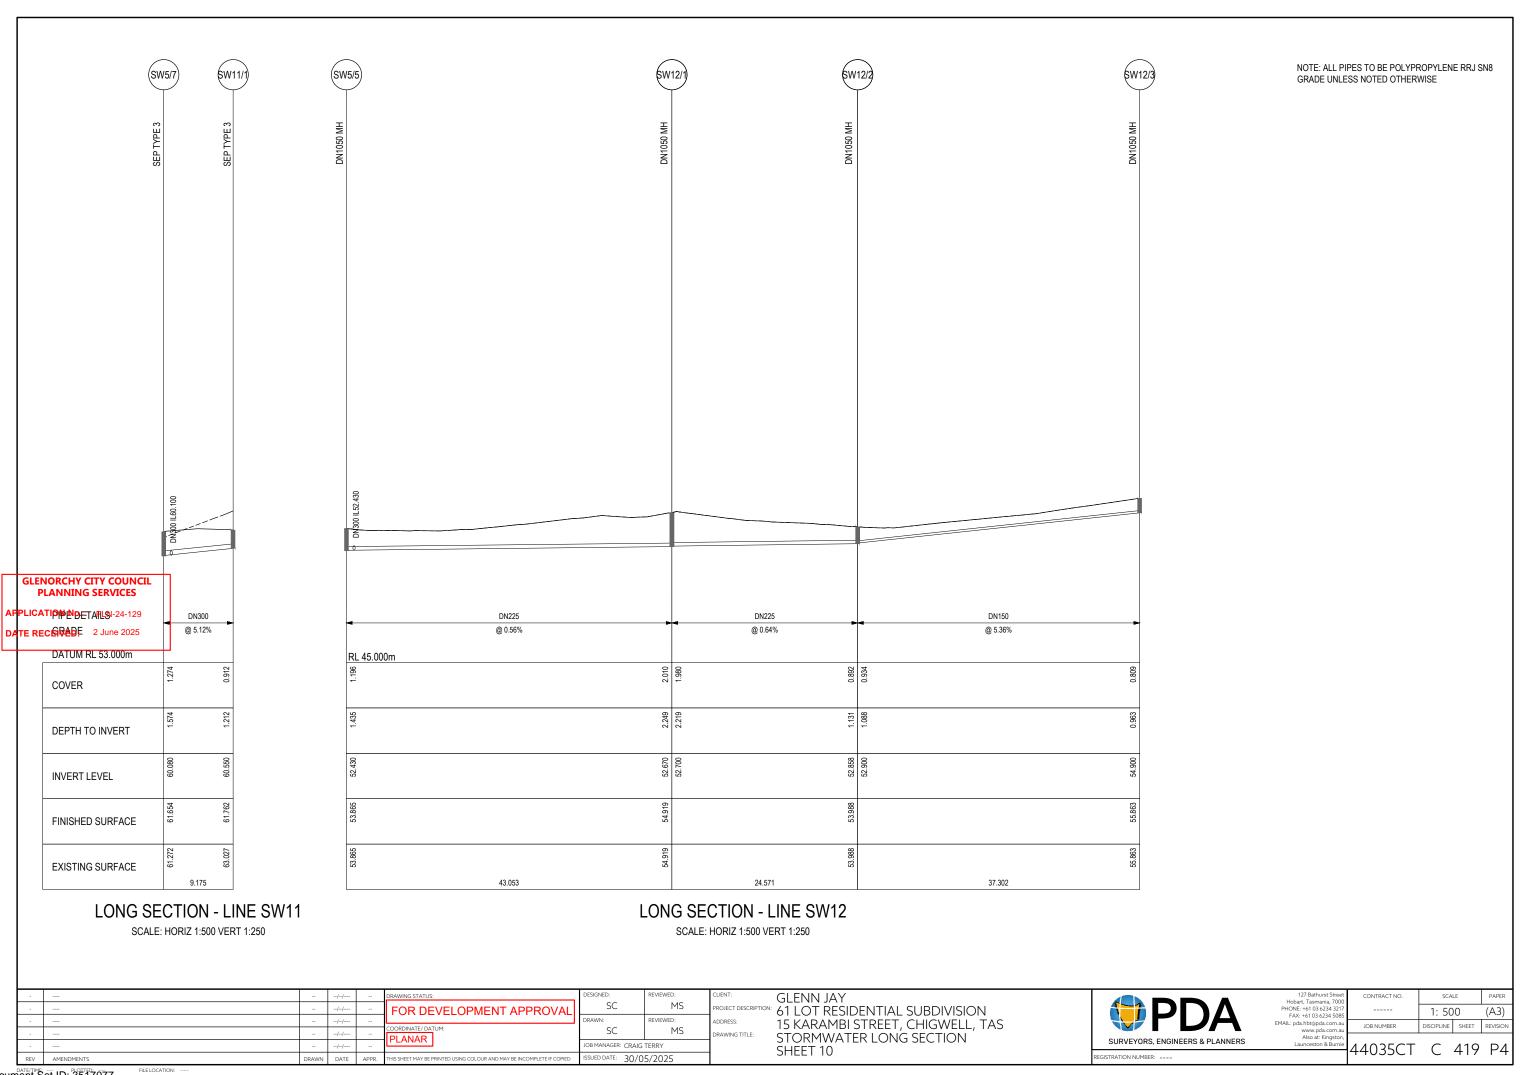


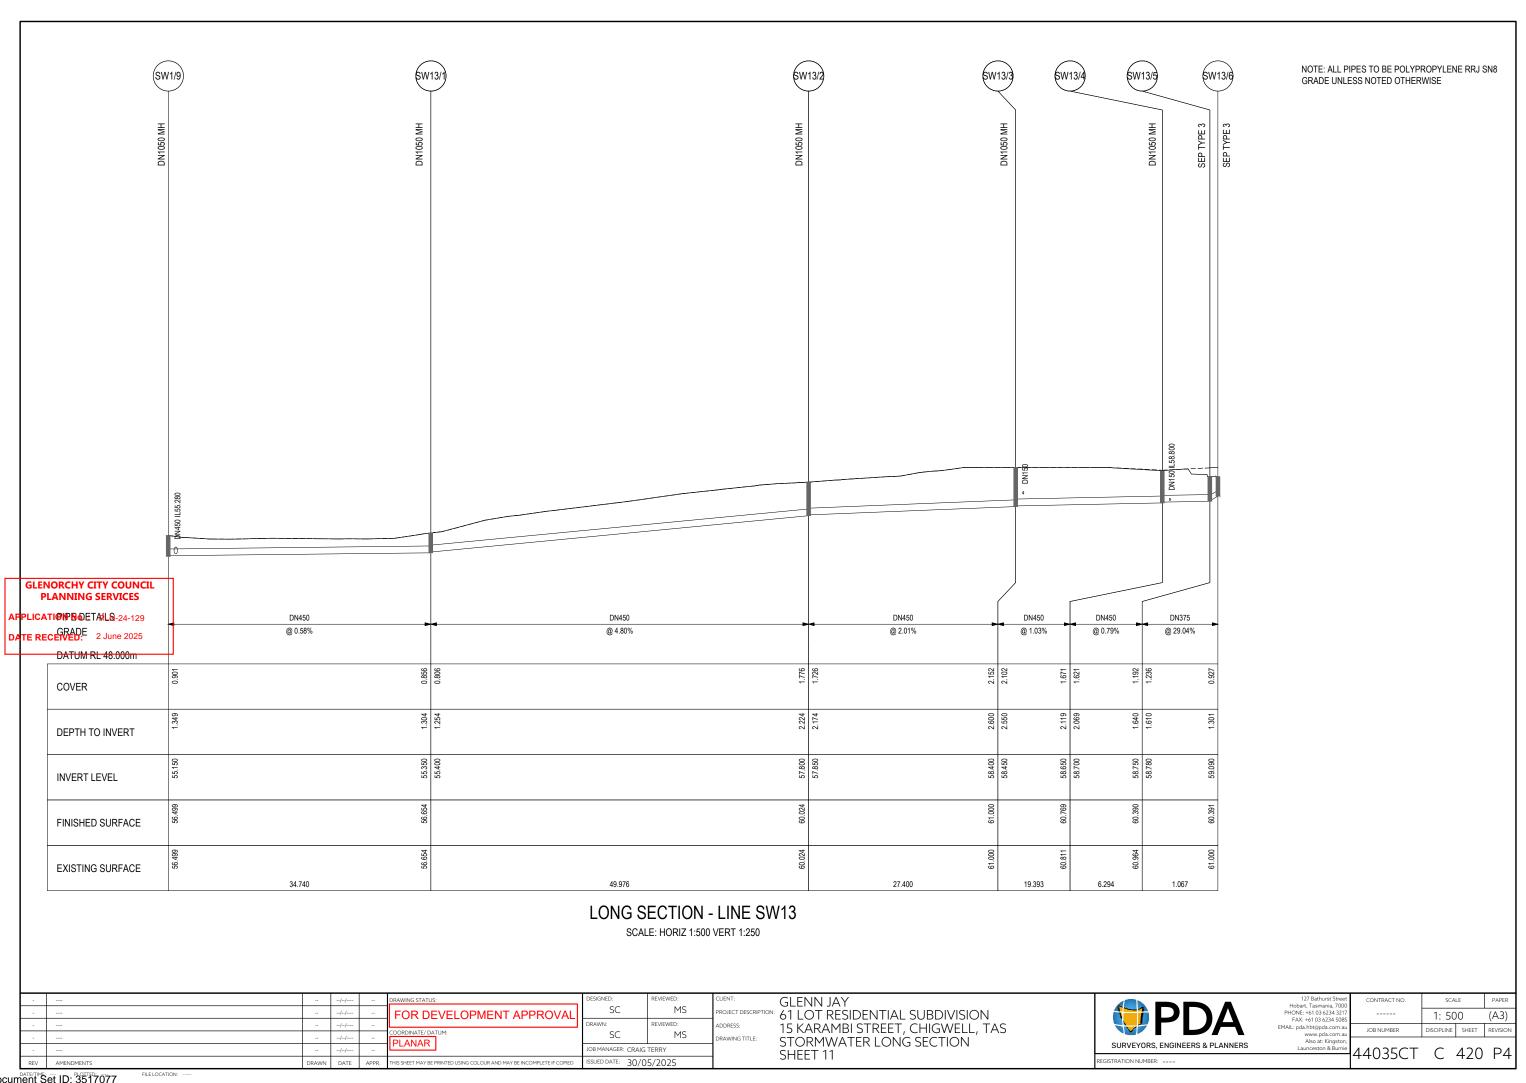


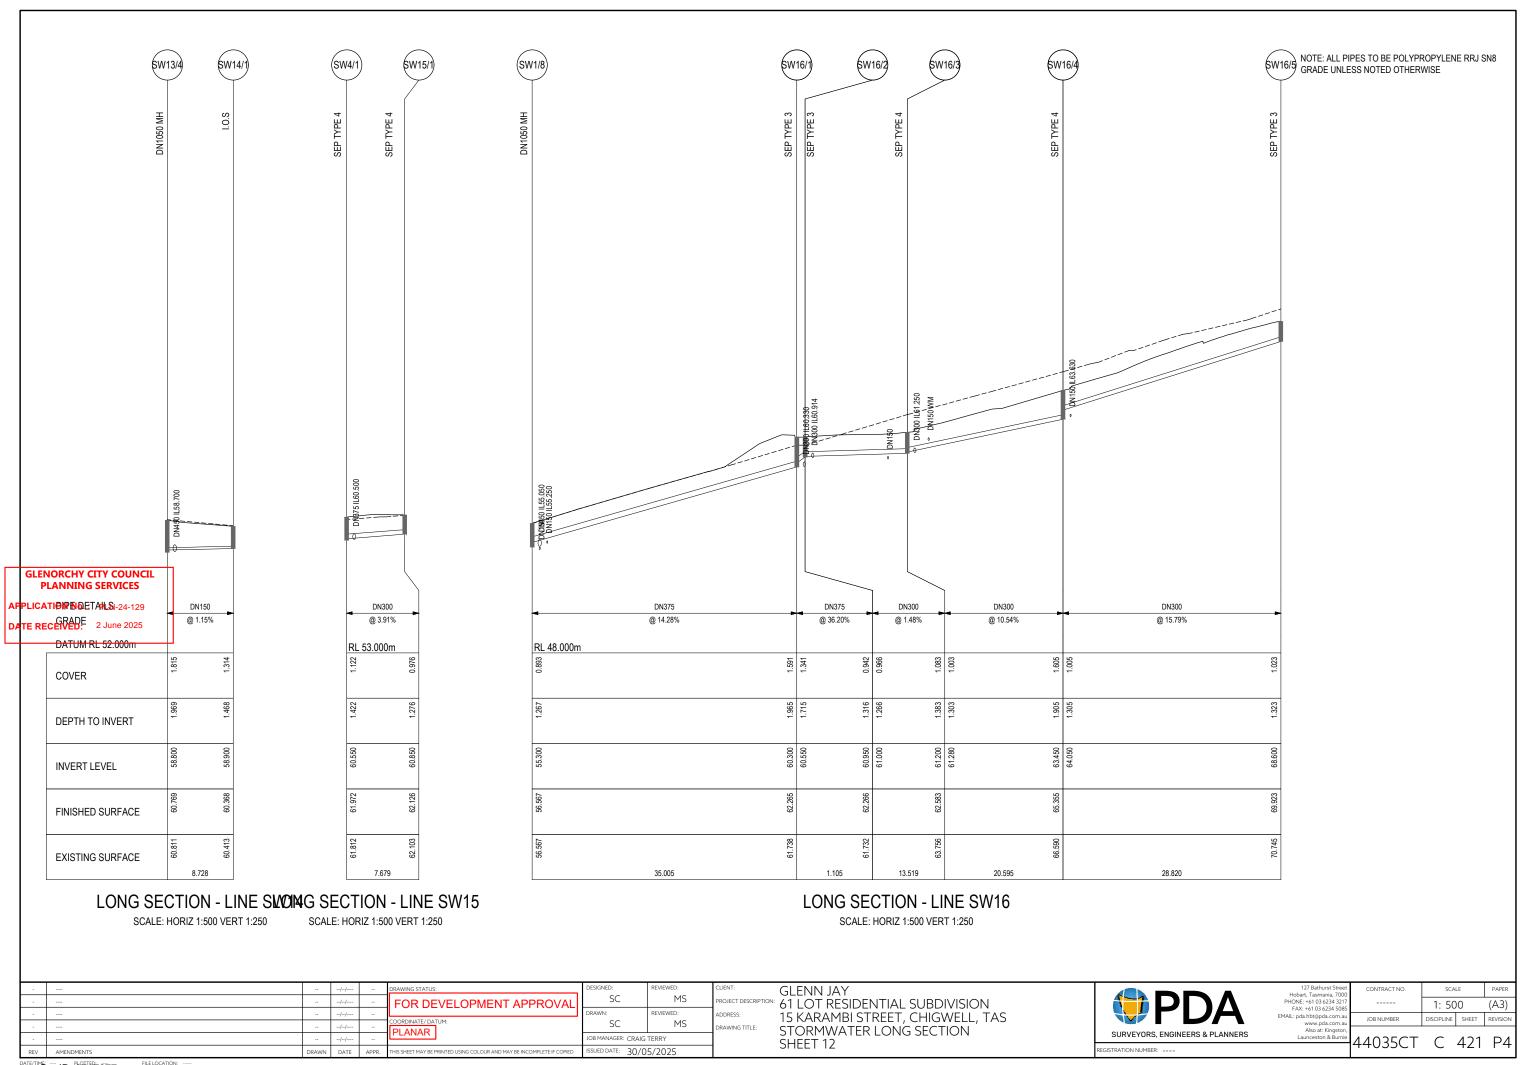


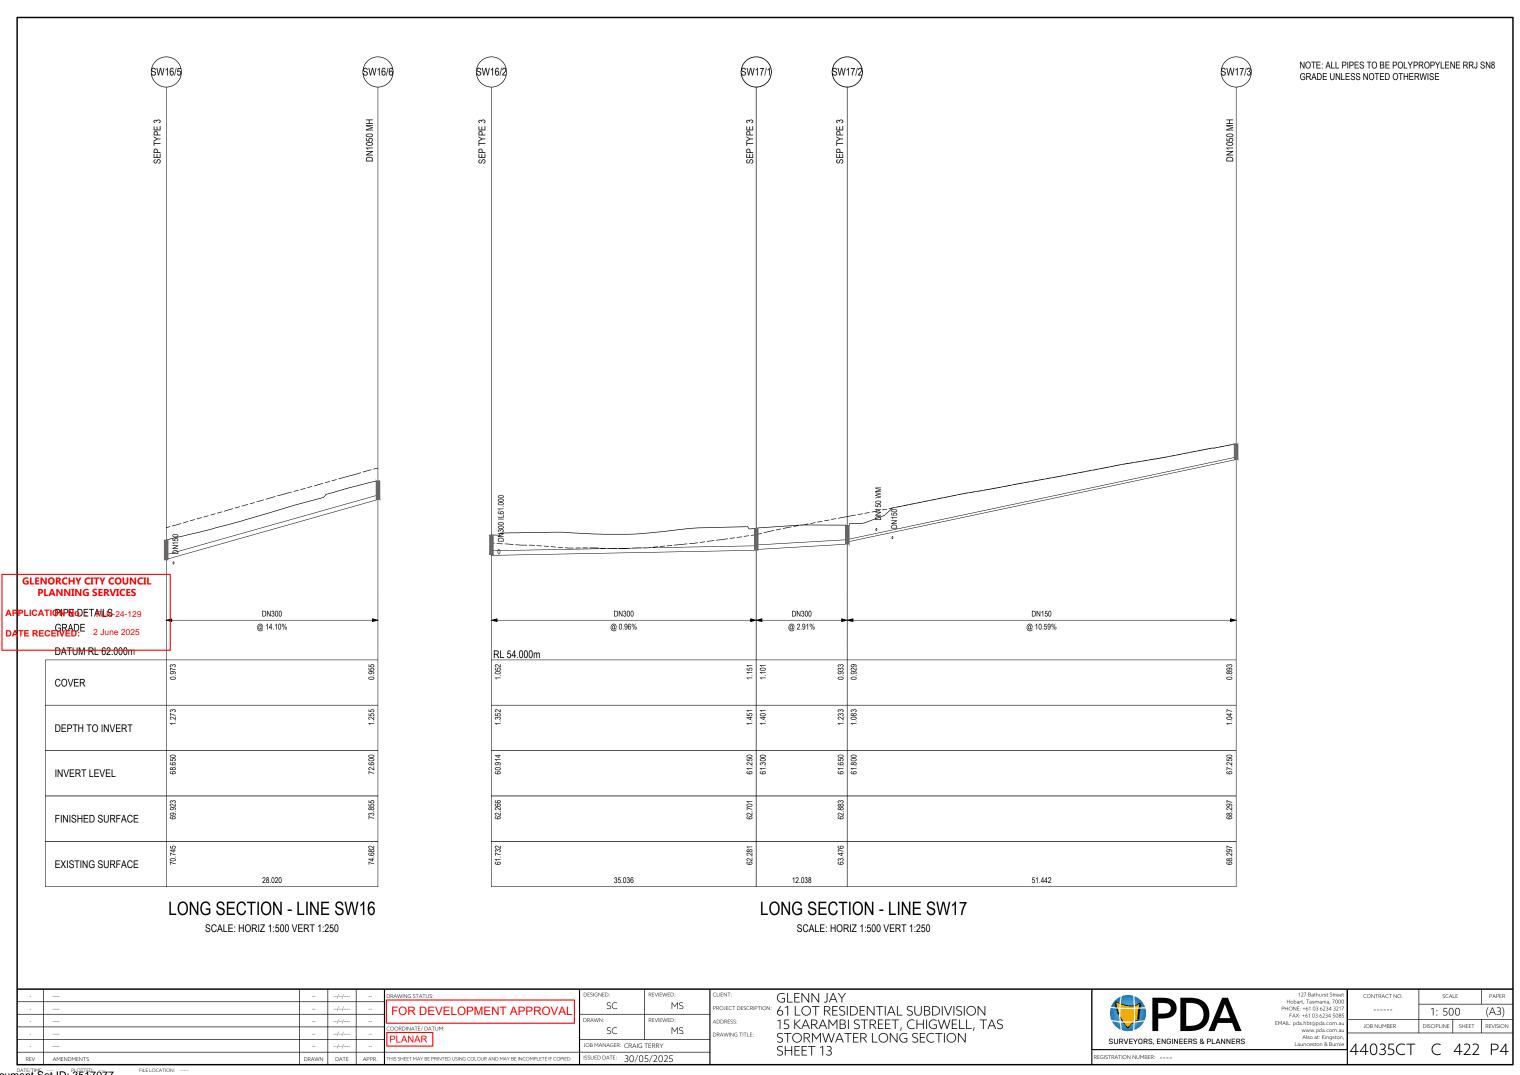


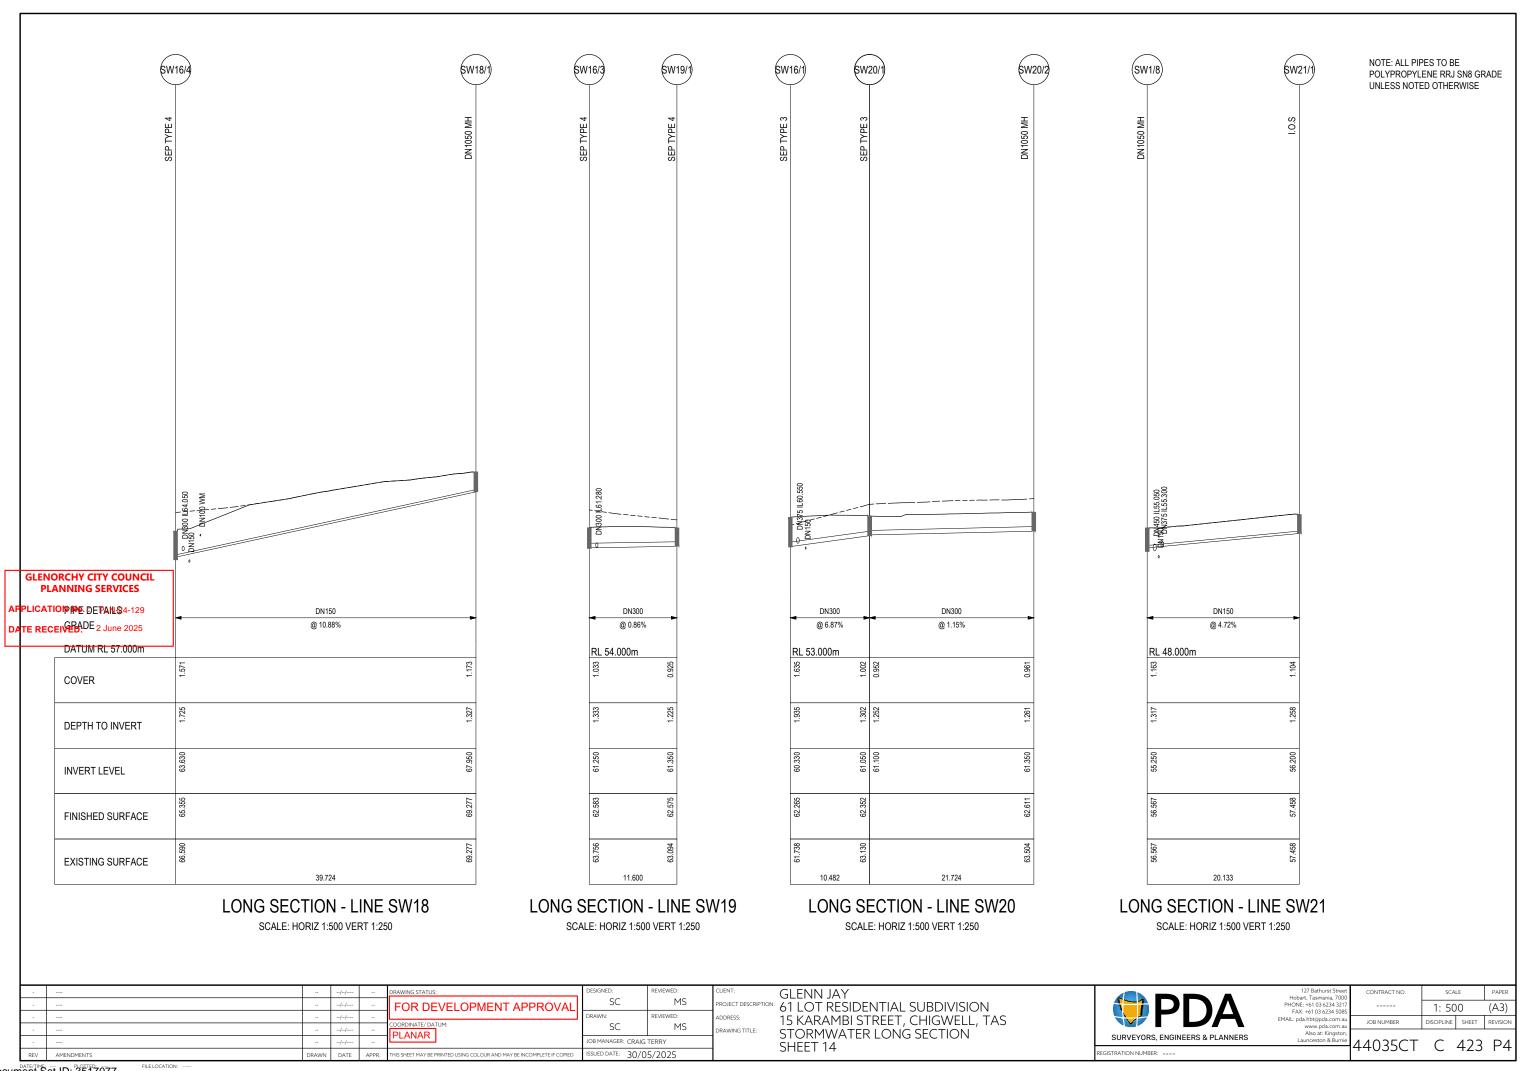


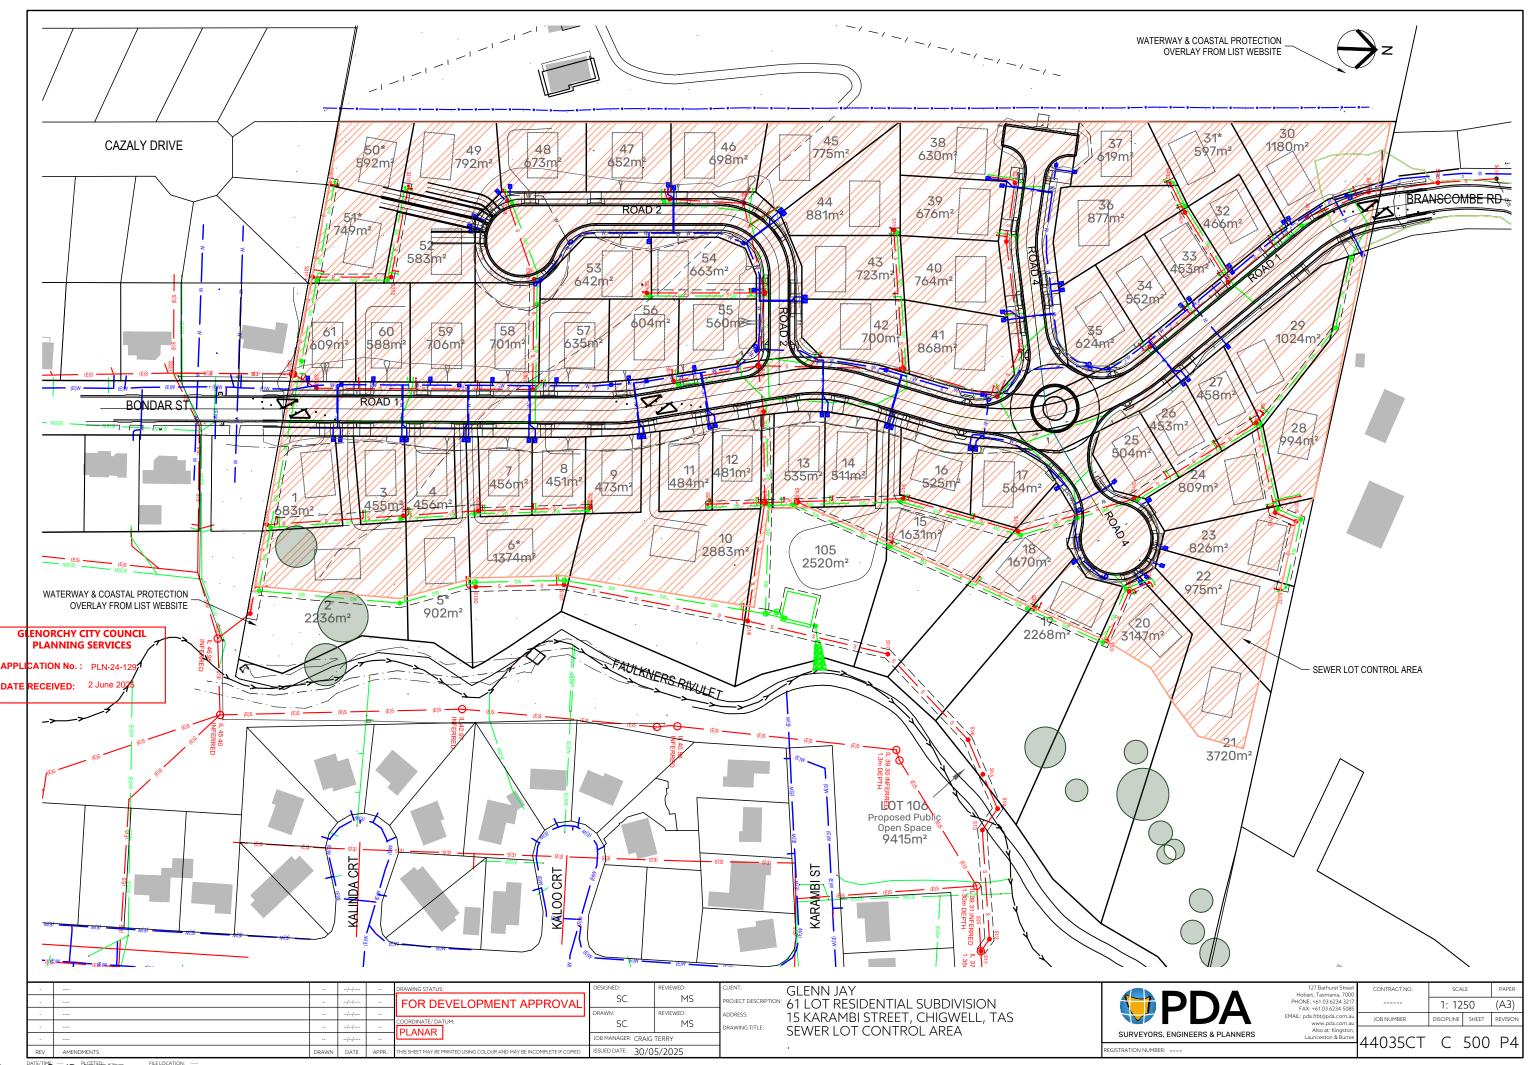


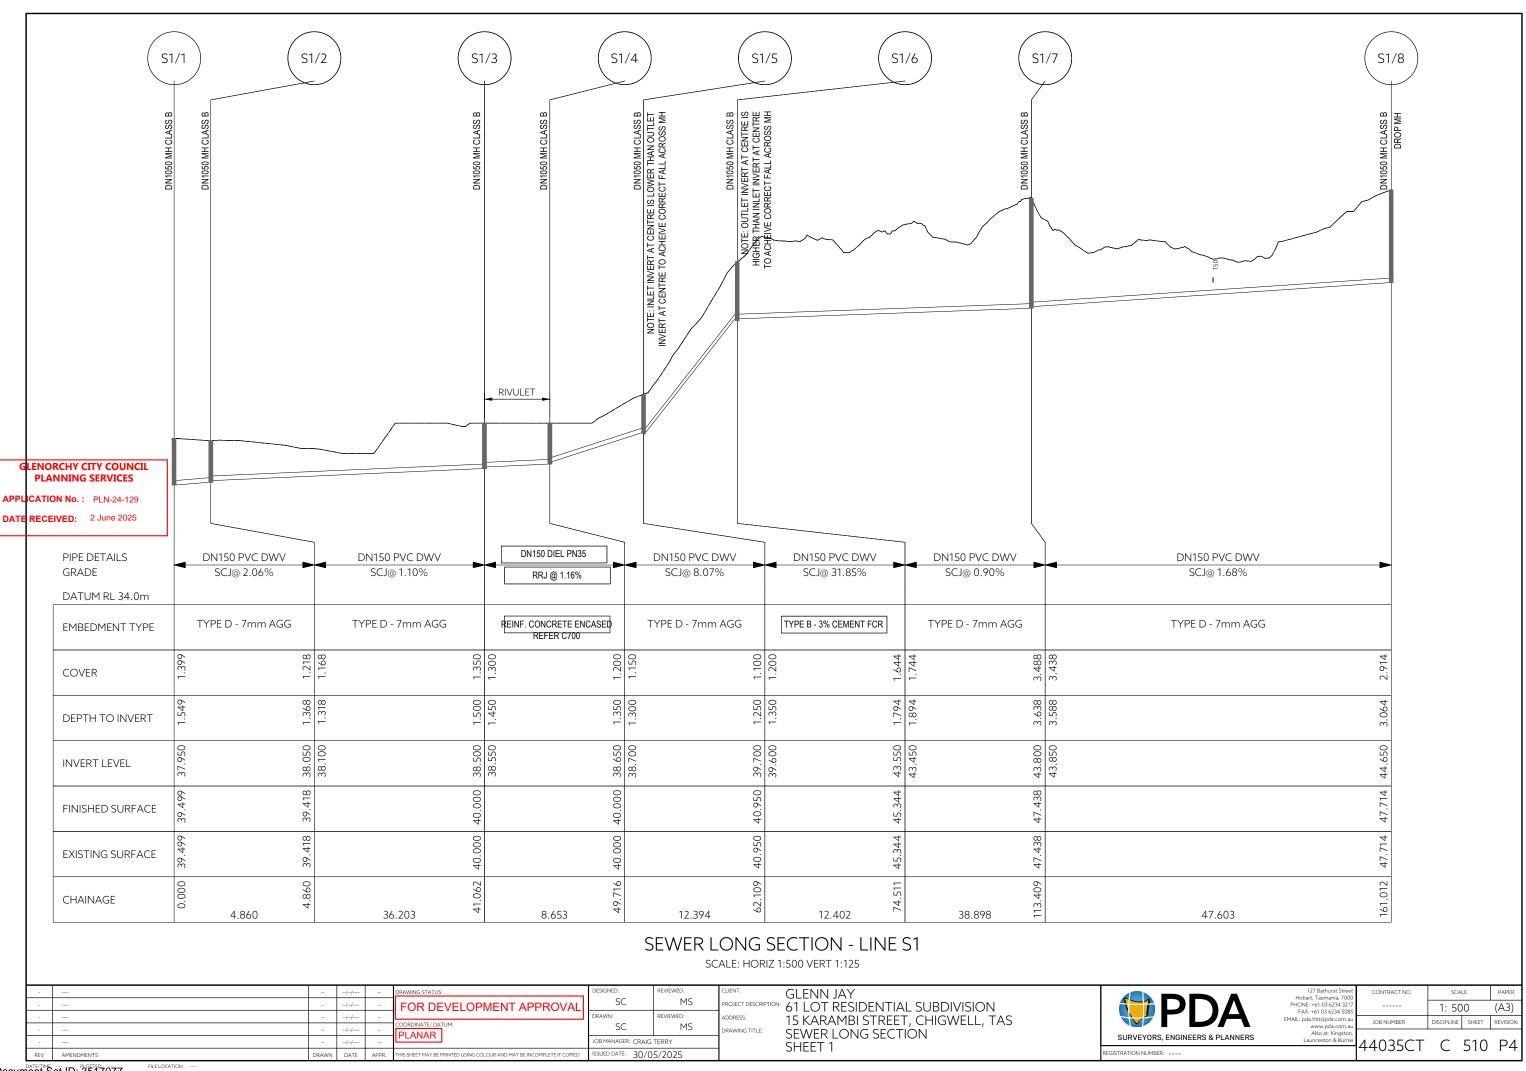


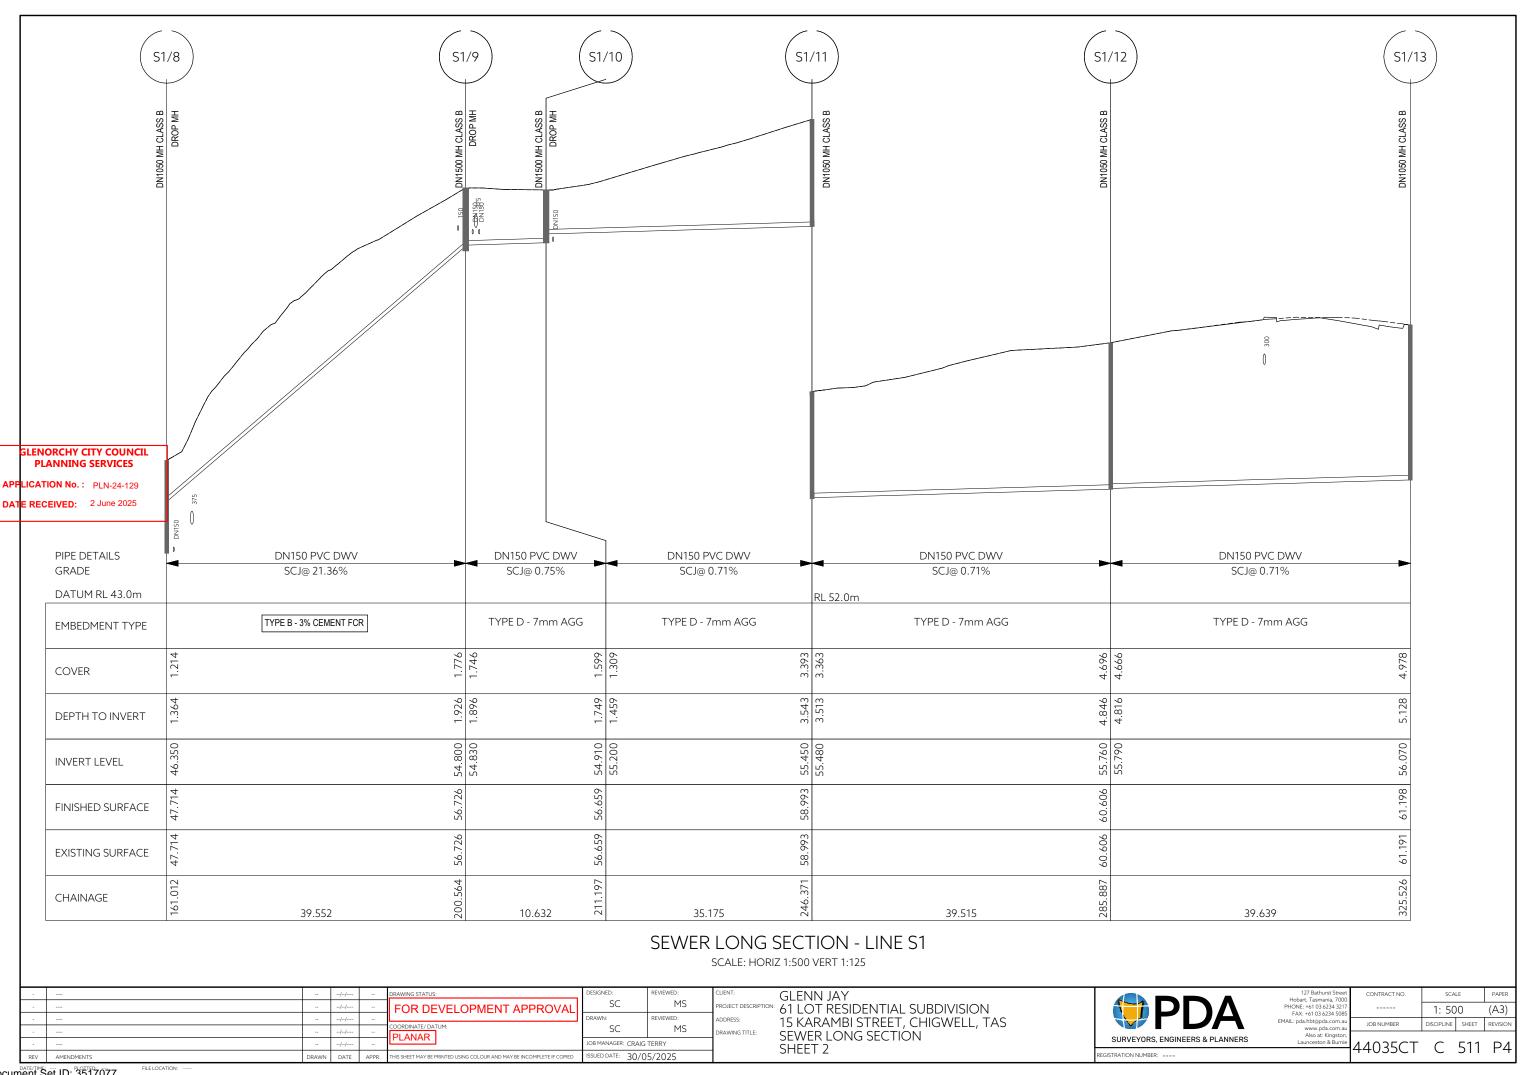


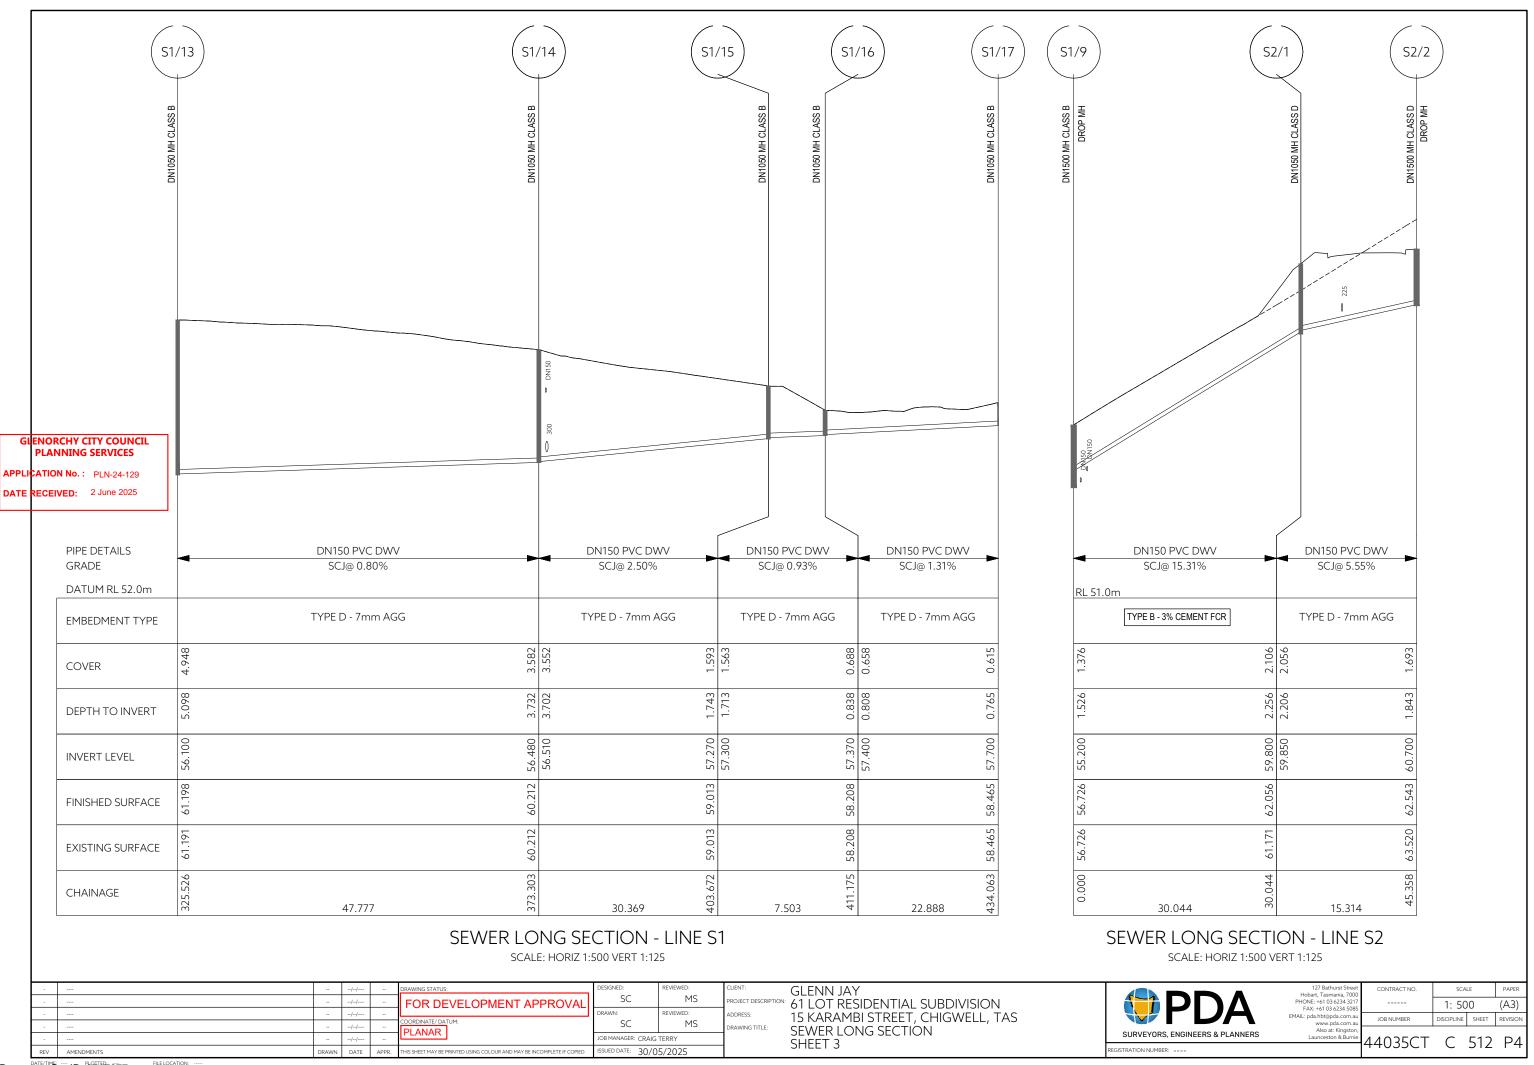


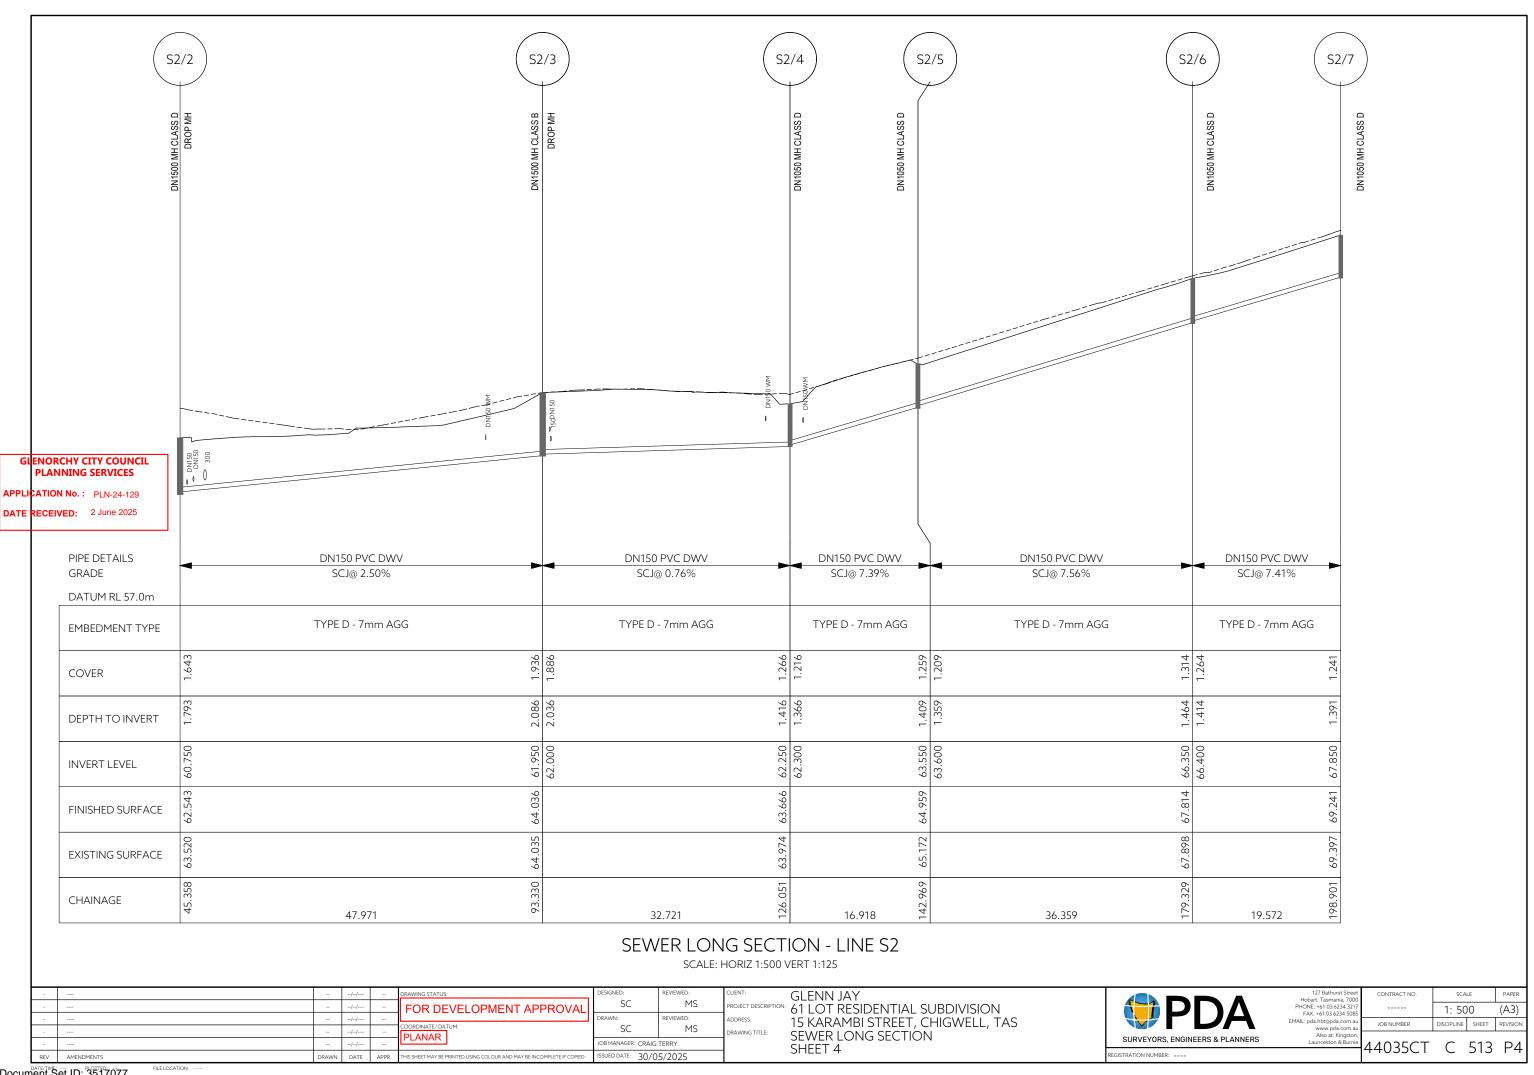

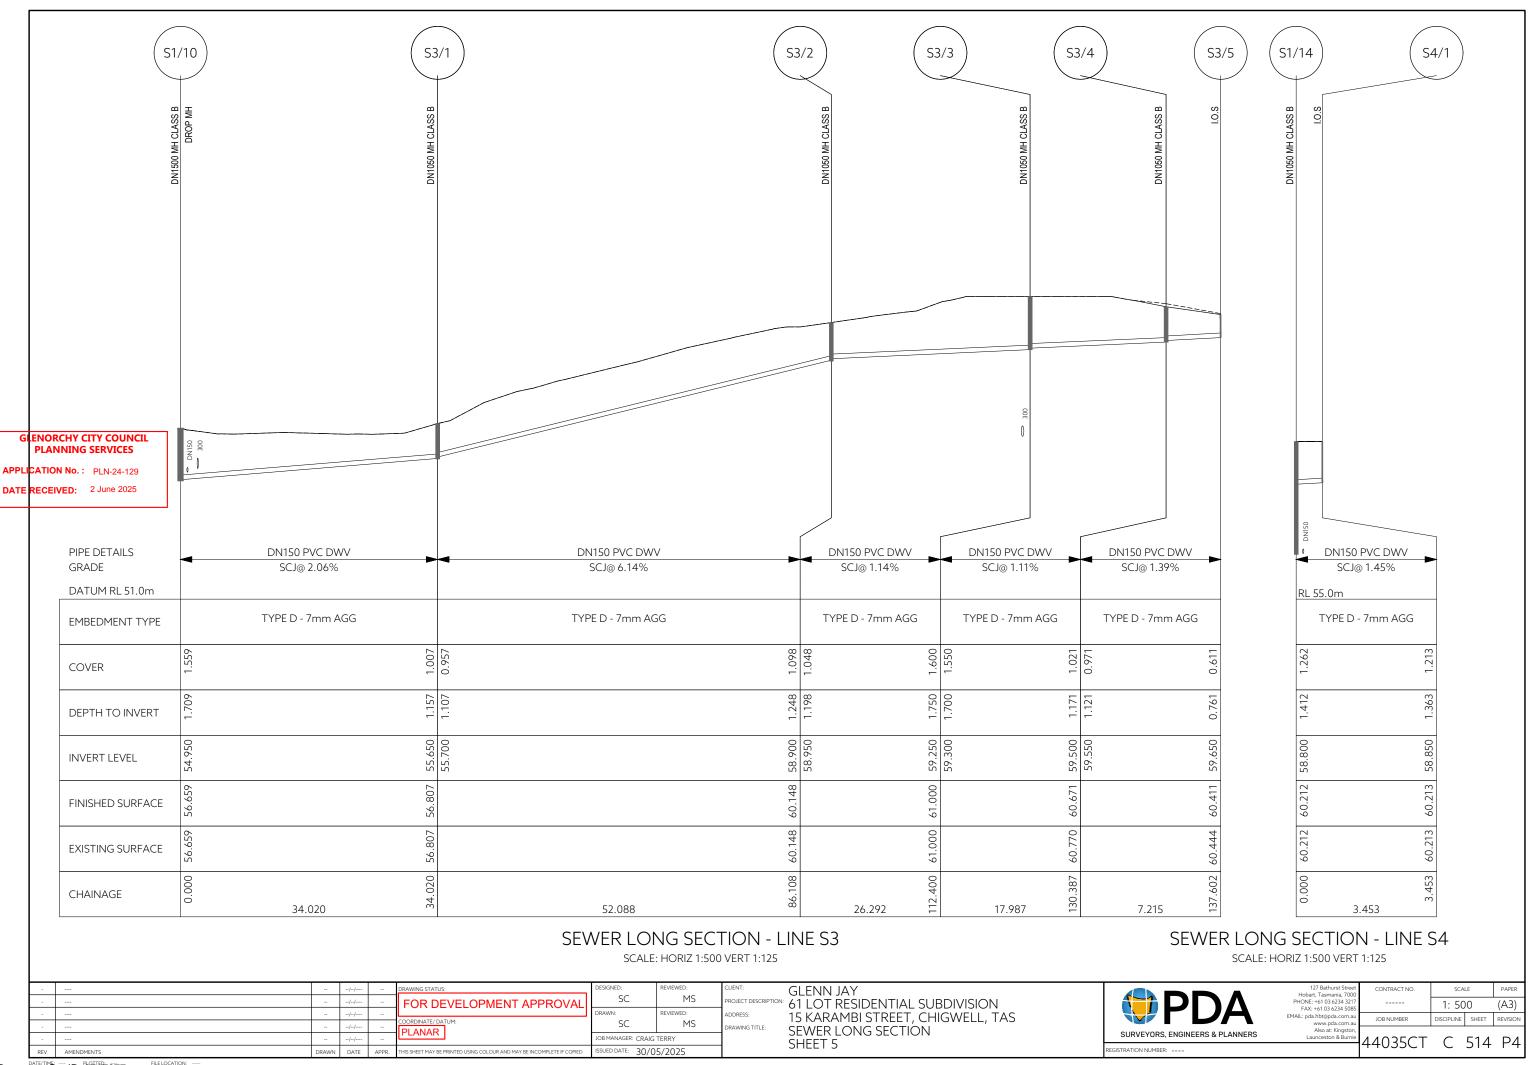


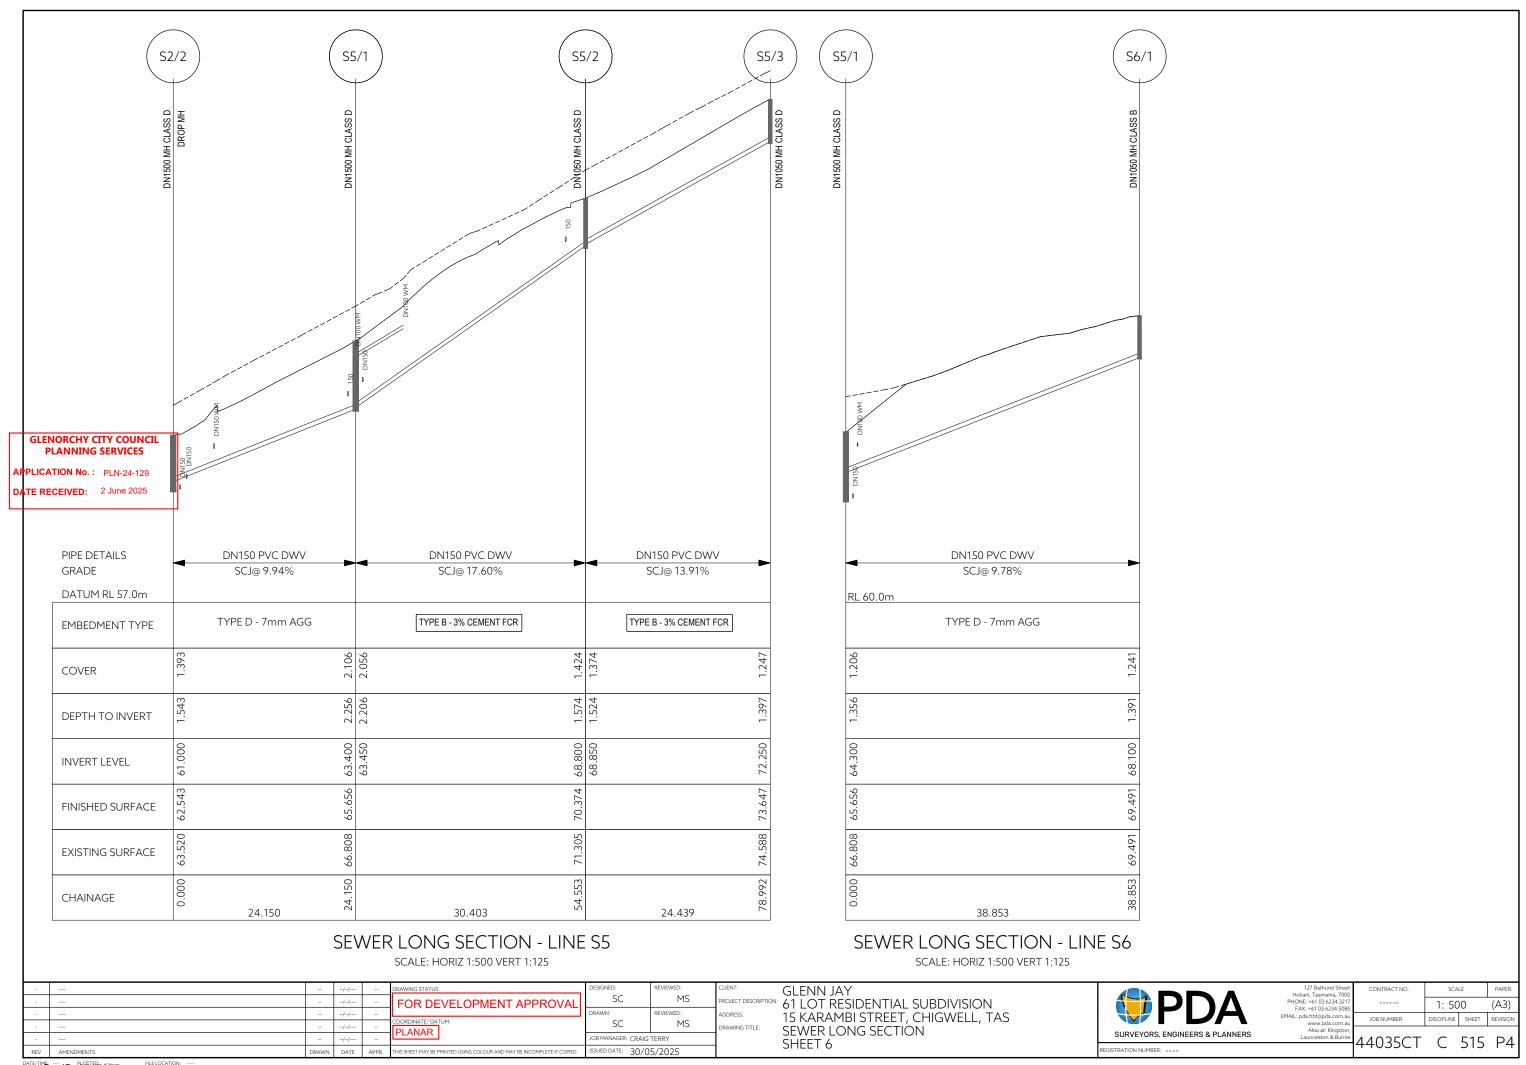


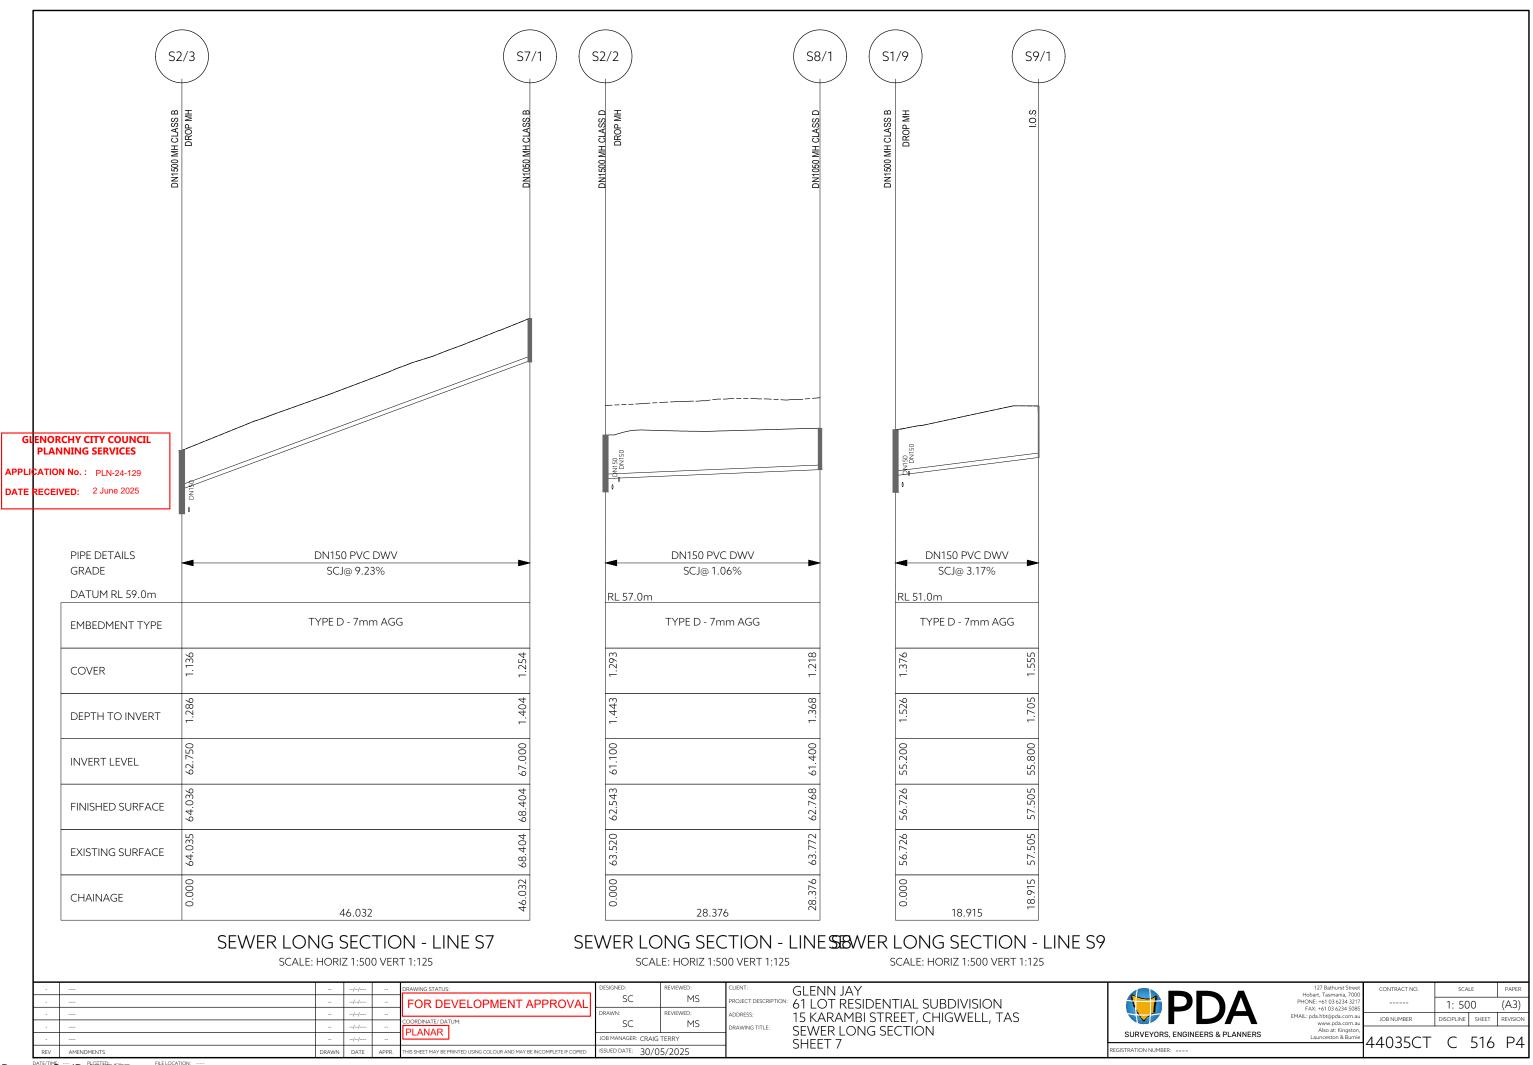

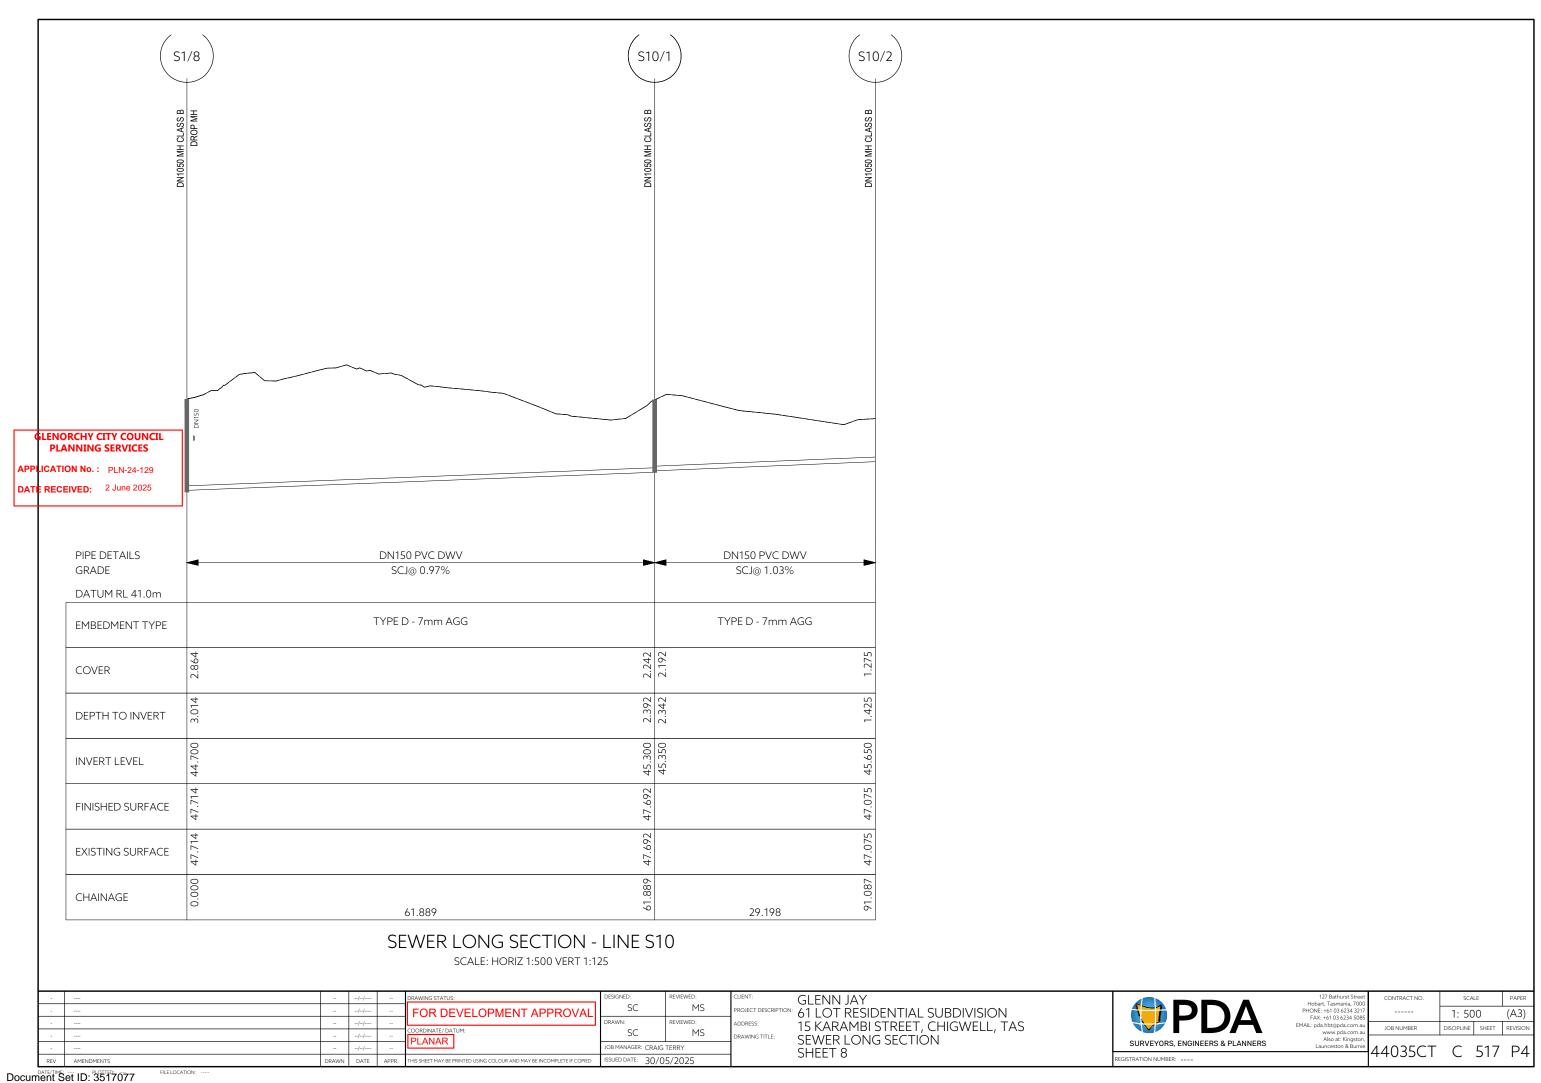



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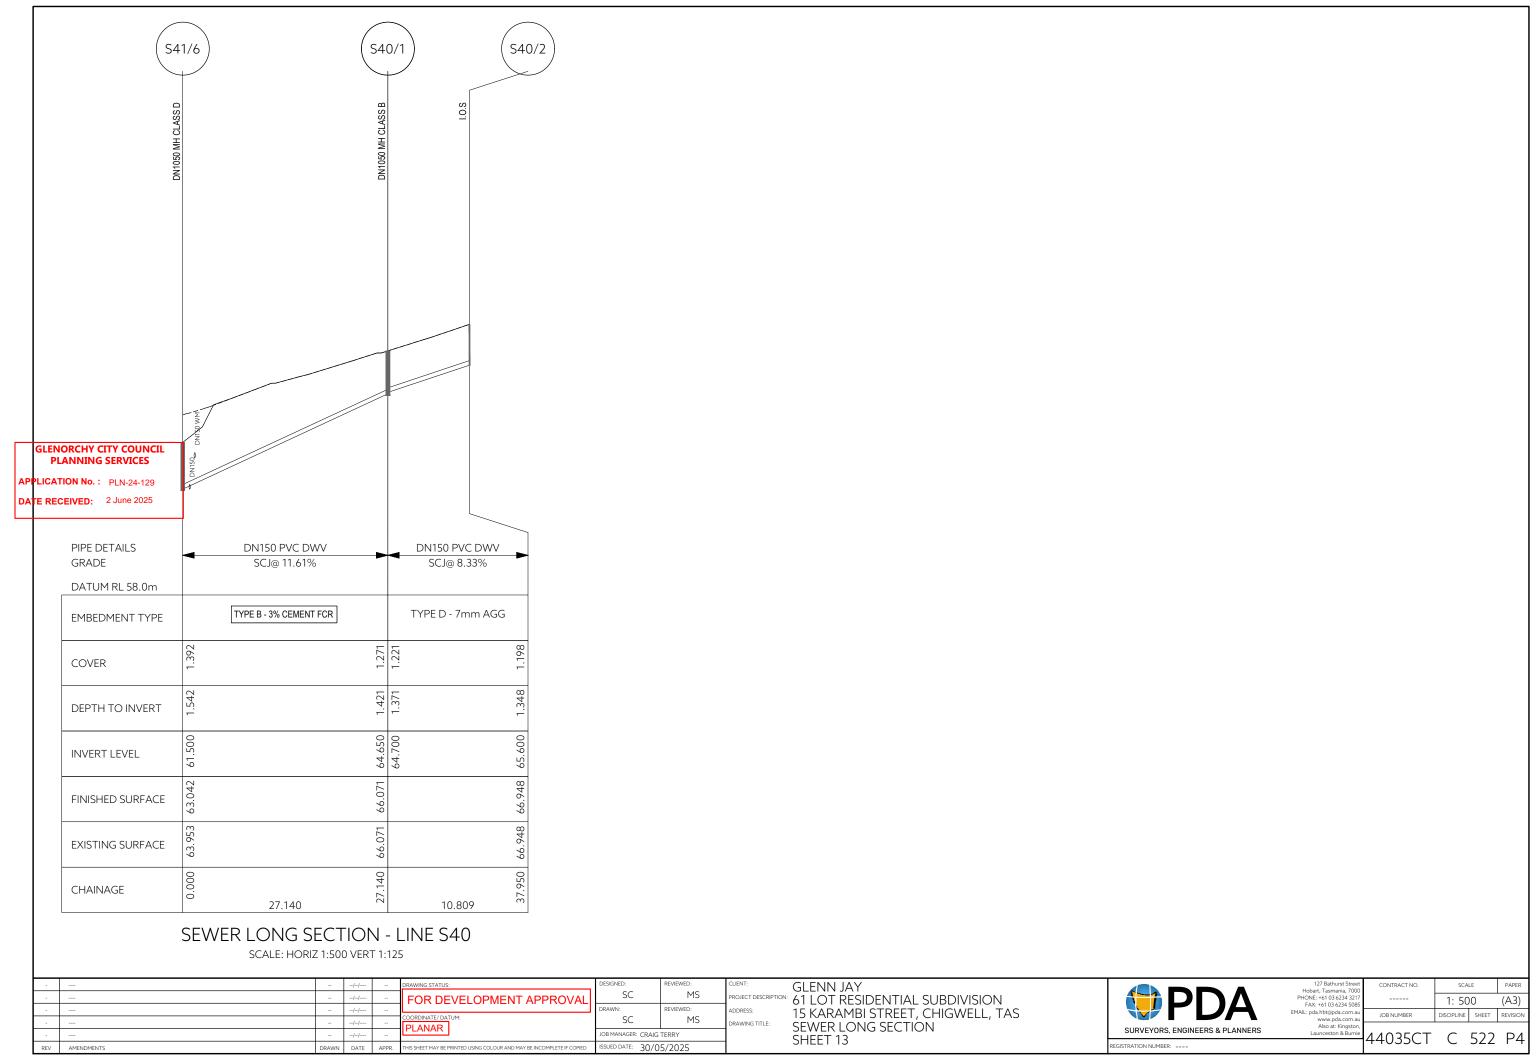


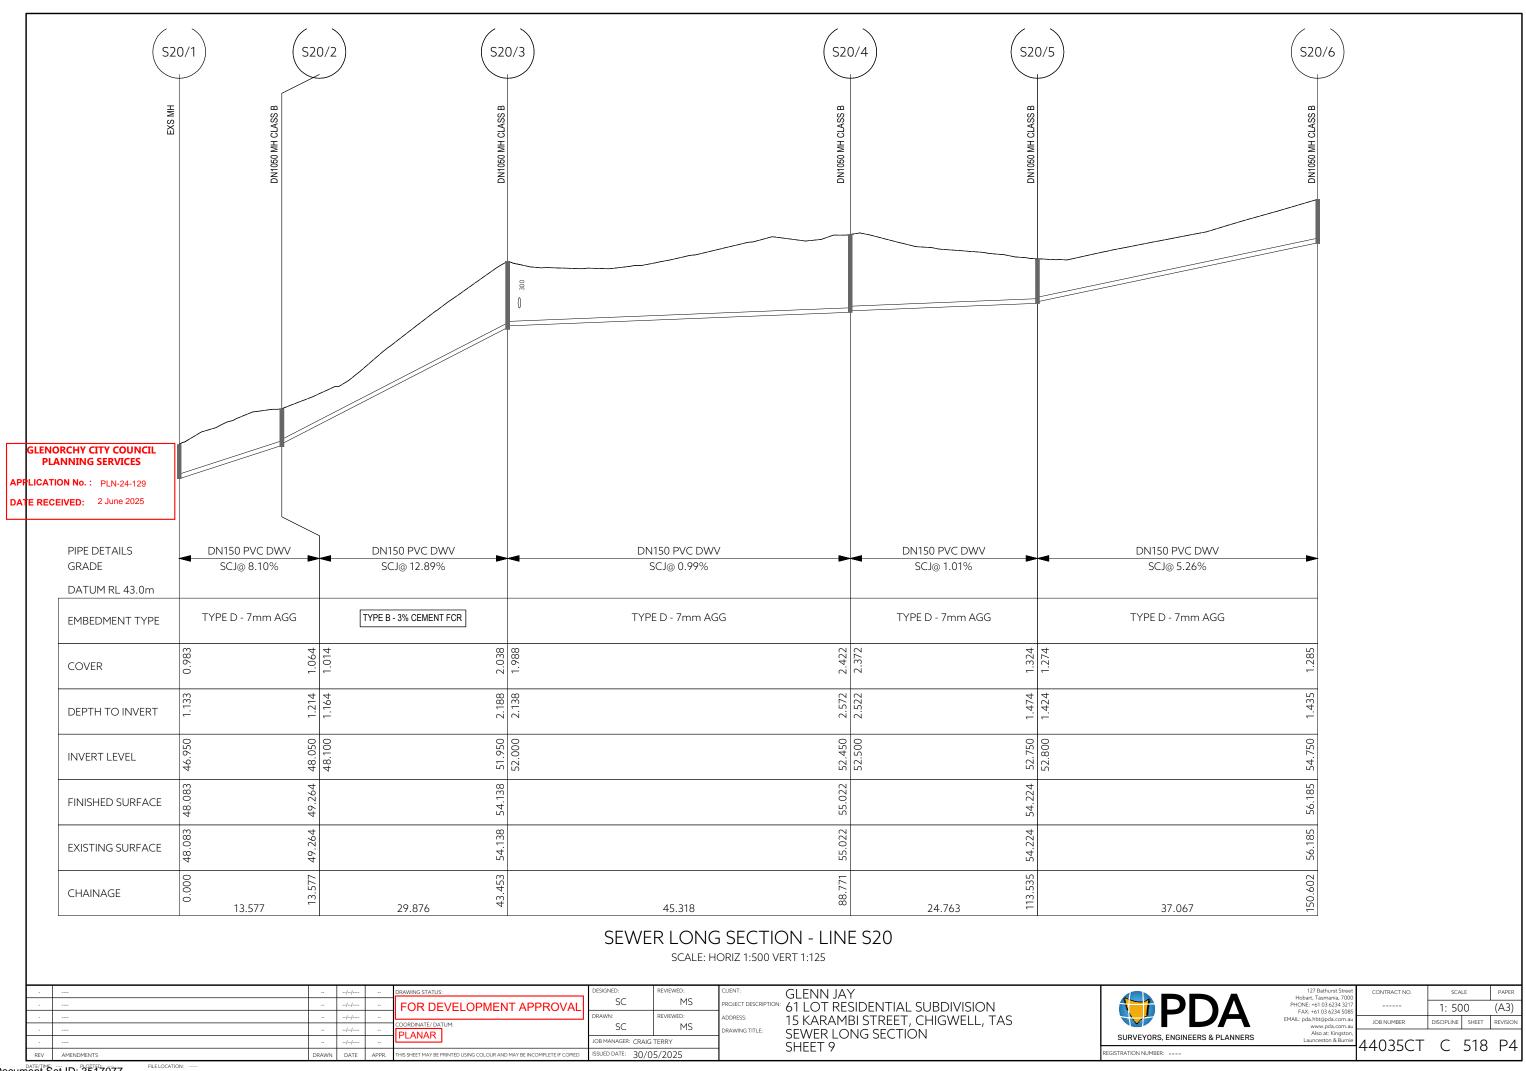


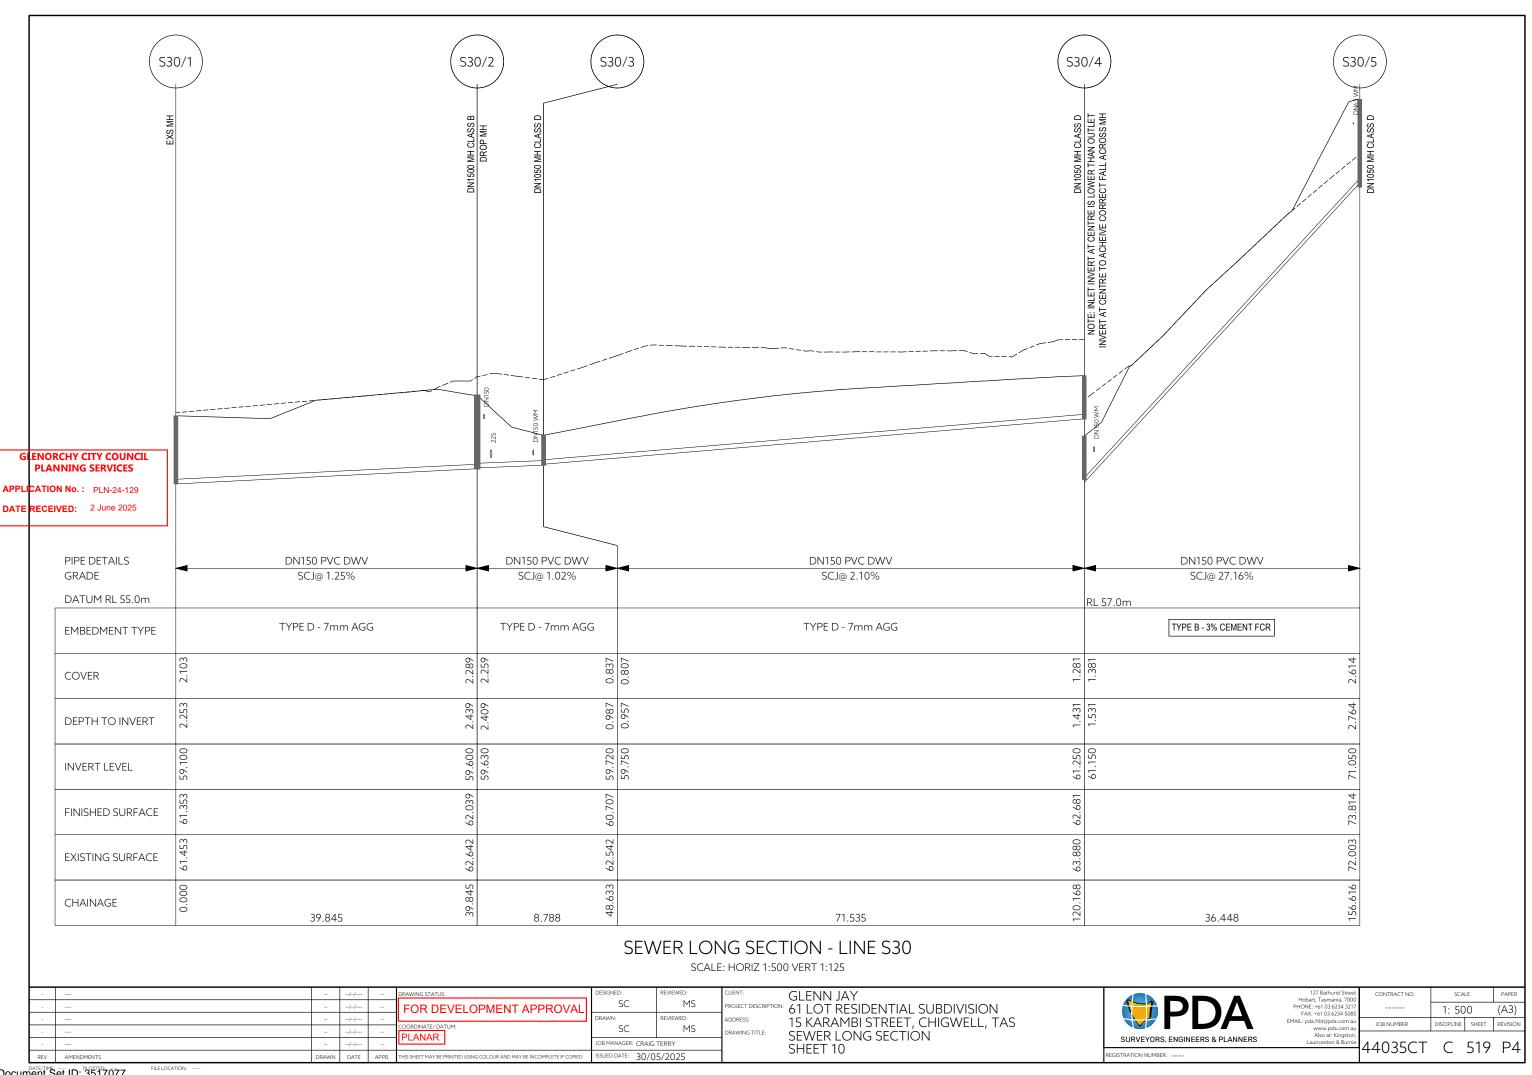
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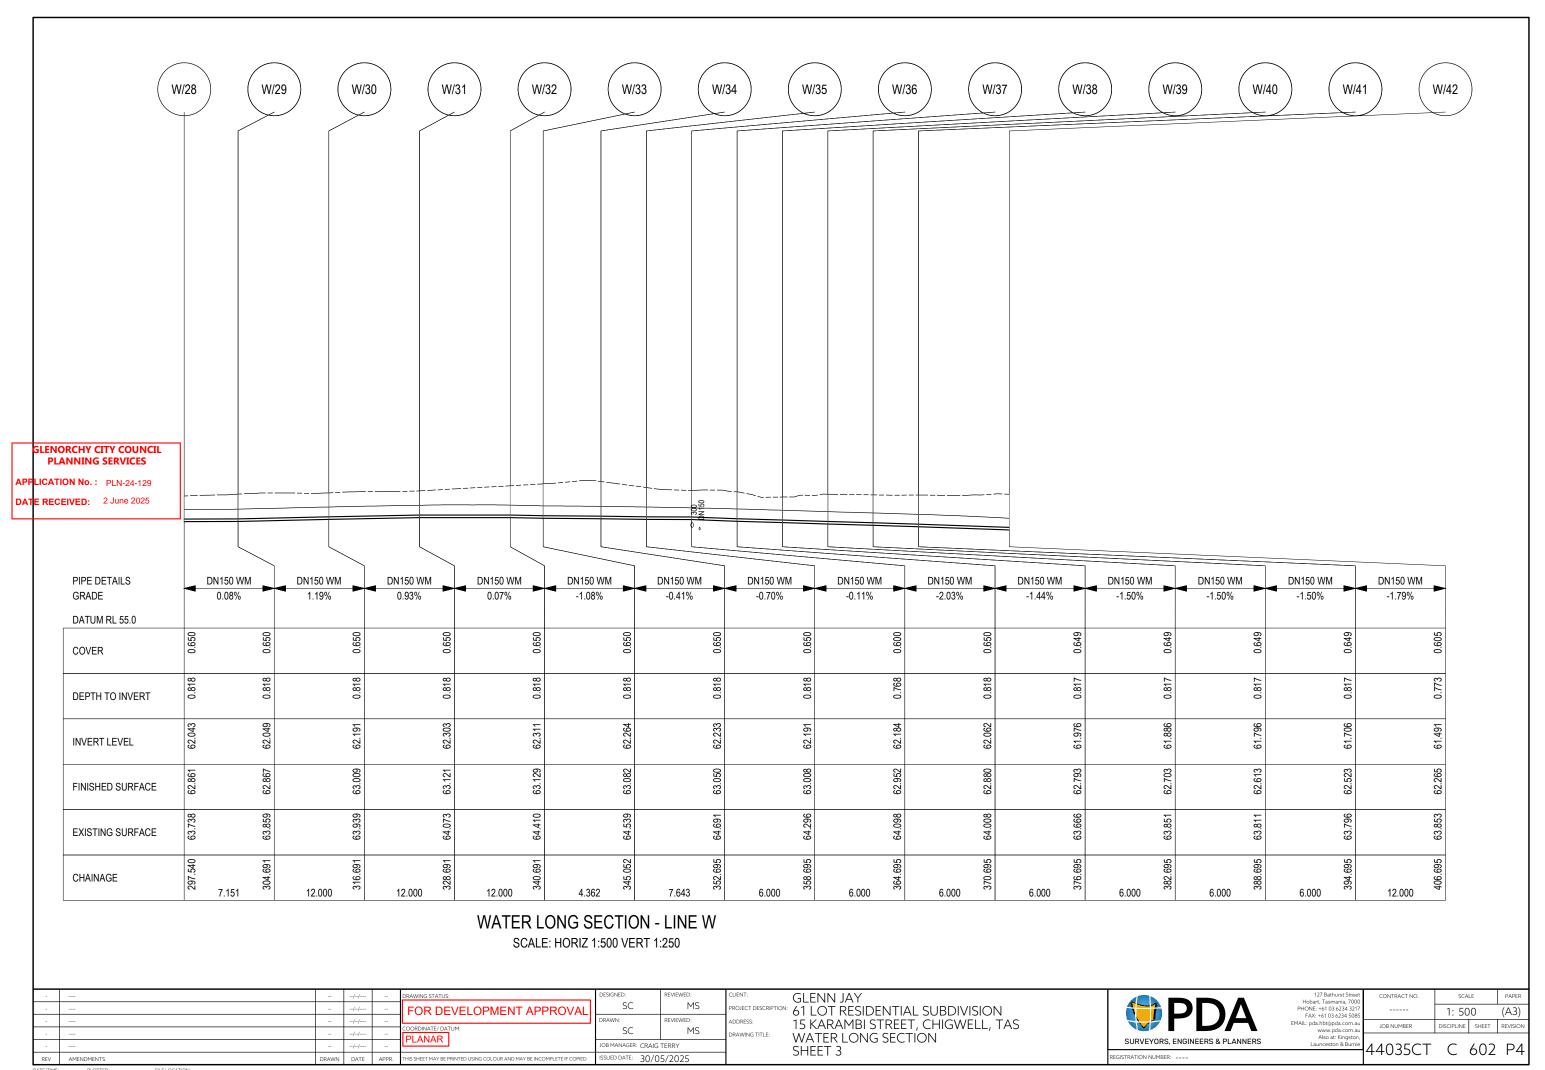





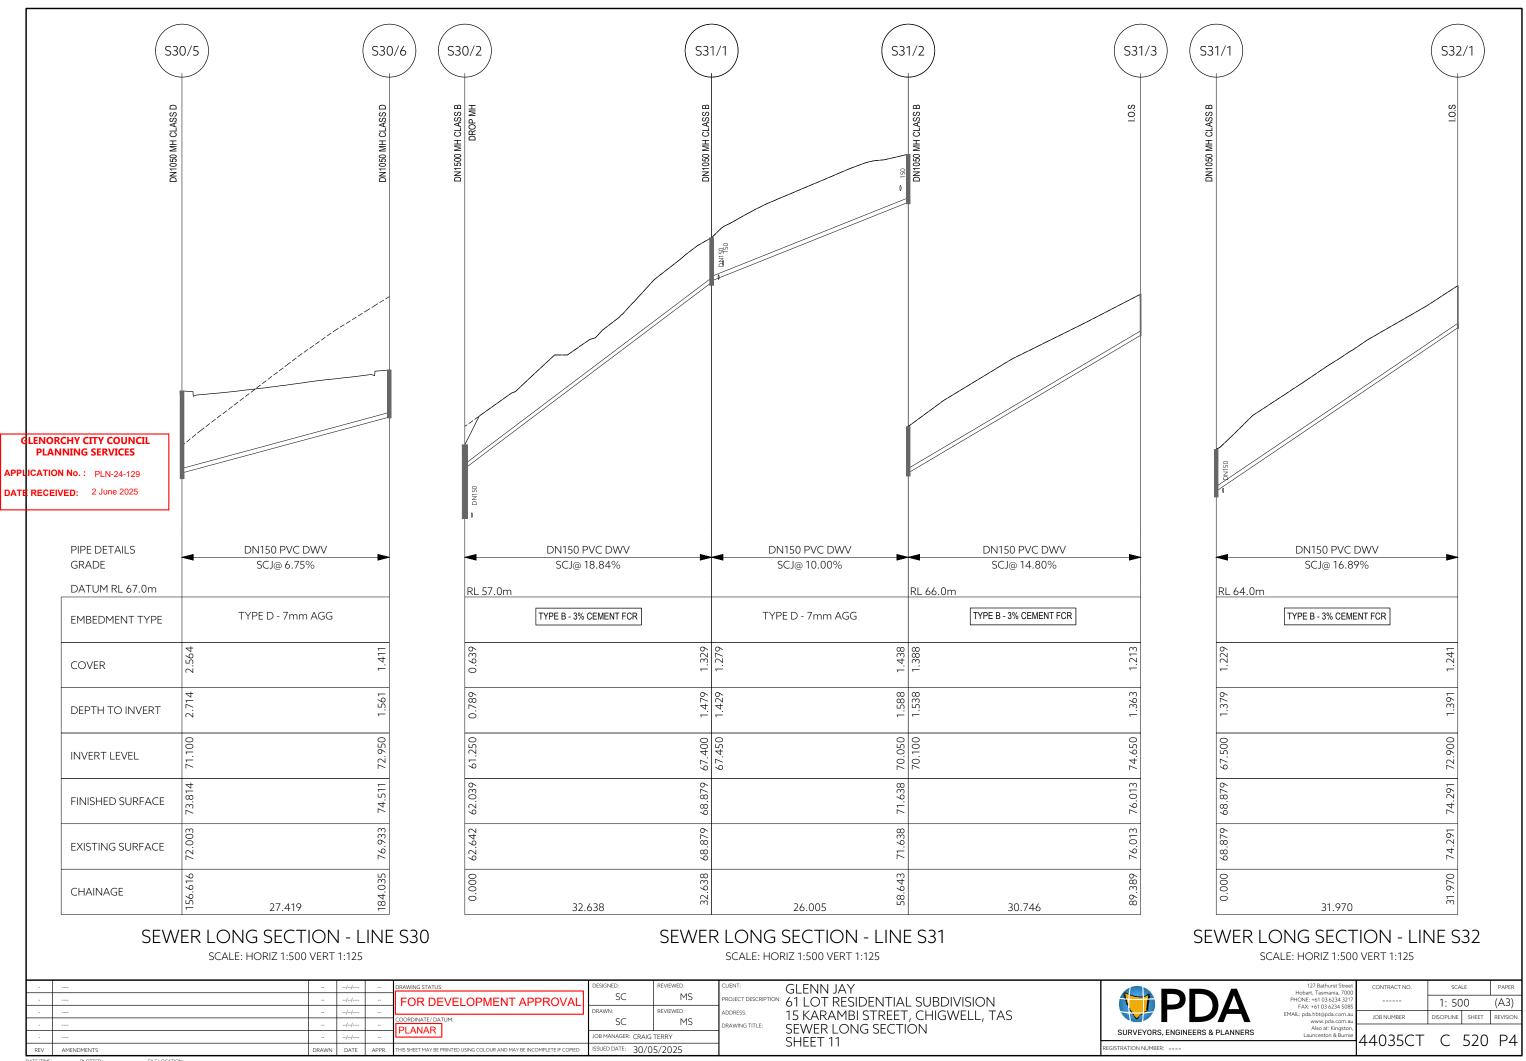

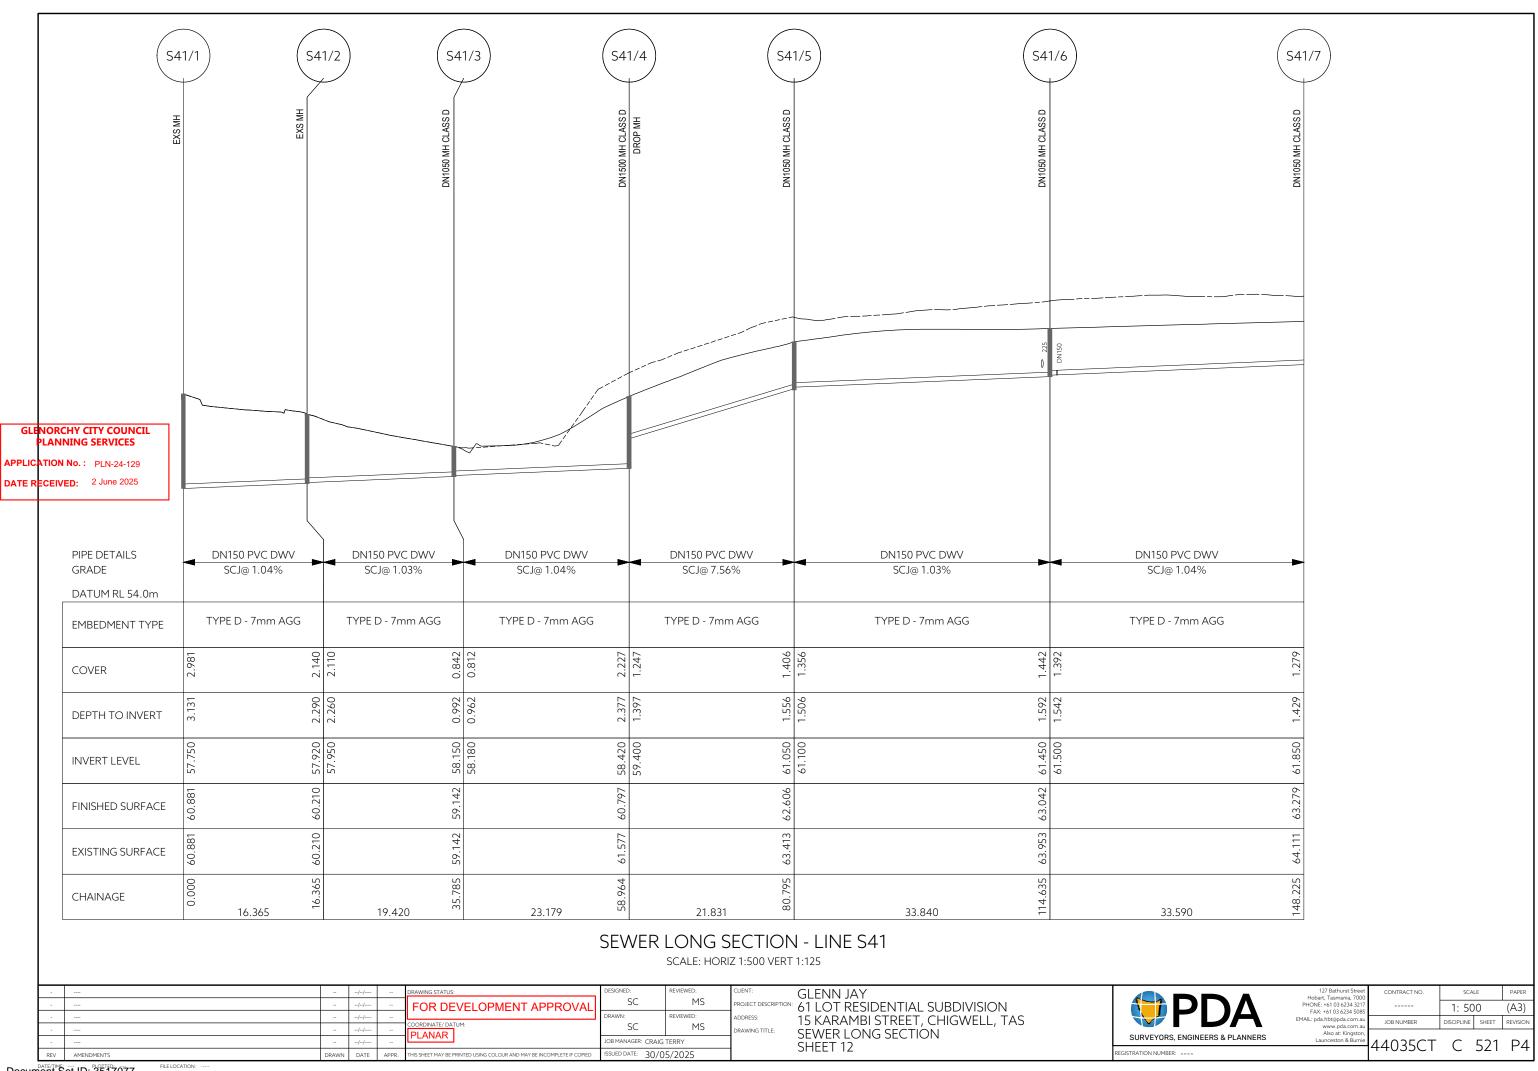
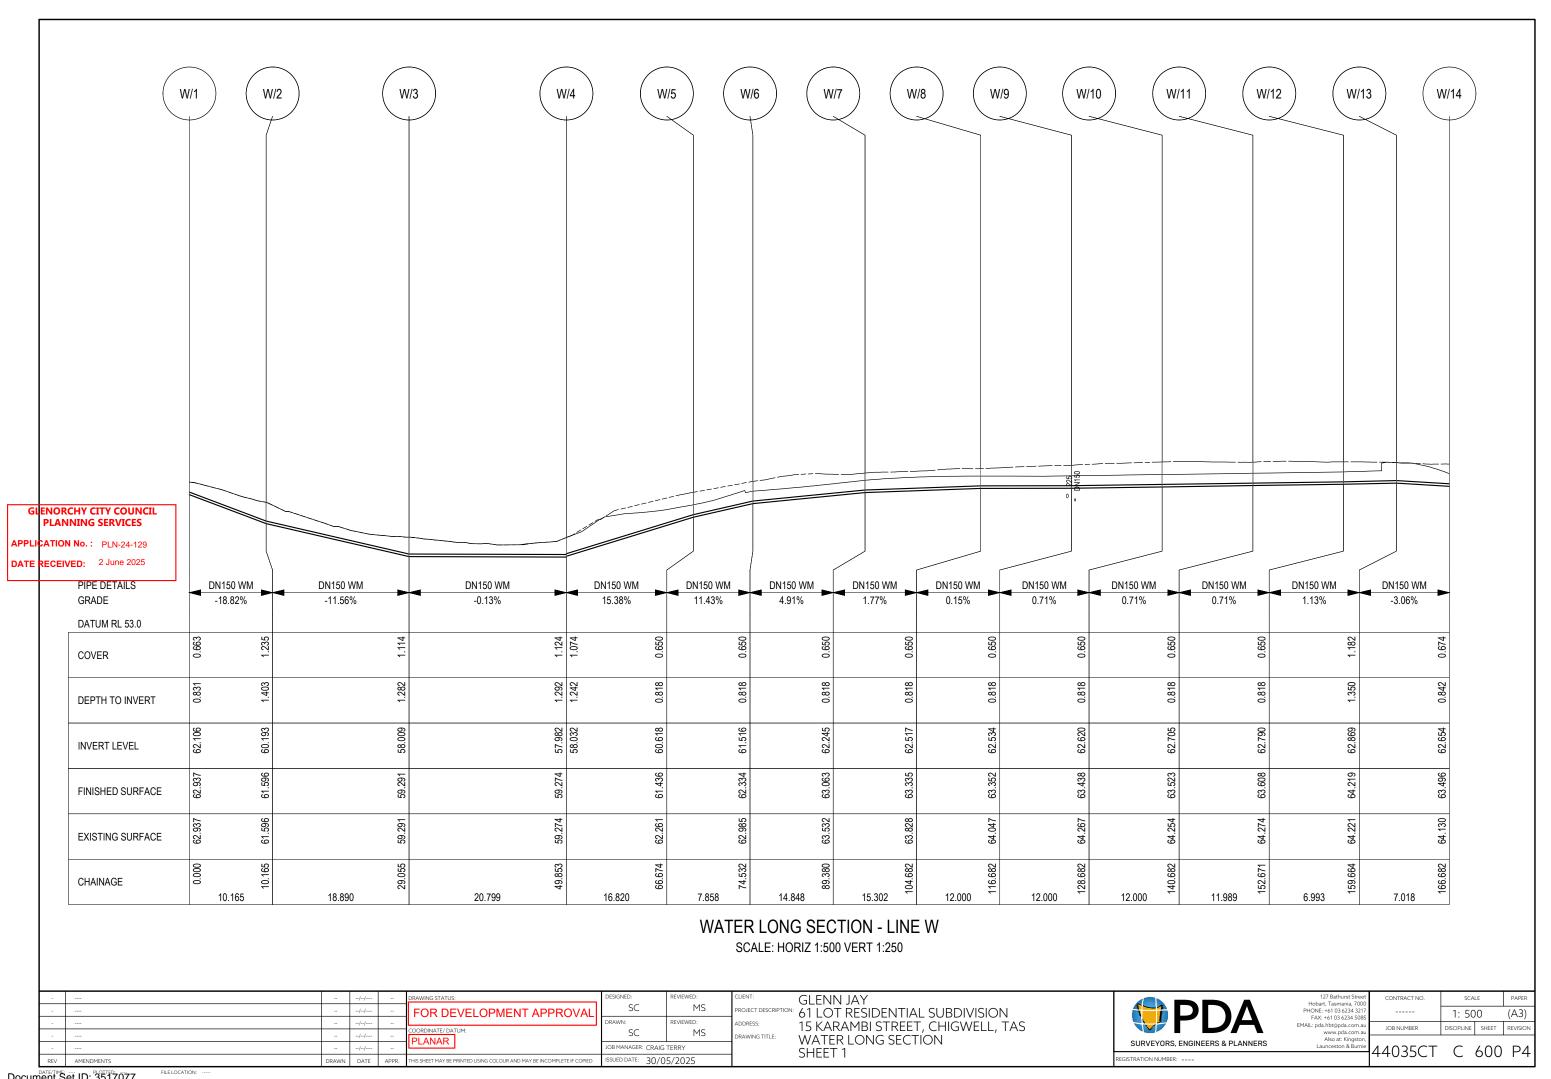
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| JOB MANAGER: CRAIG | | |
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GLENN JAY 61 LOT RESIDENTIAL SUBDIVISION 15 KARAMBI STREET, CHIGWELL, TAS WATER LONG SECTION SHEET 4

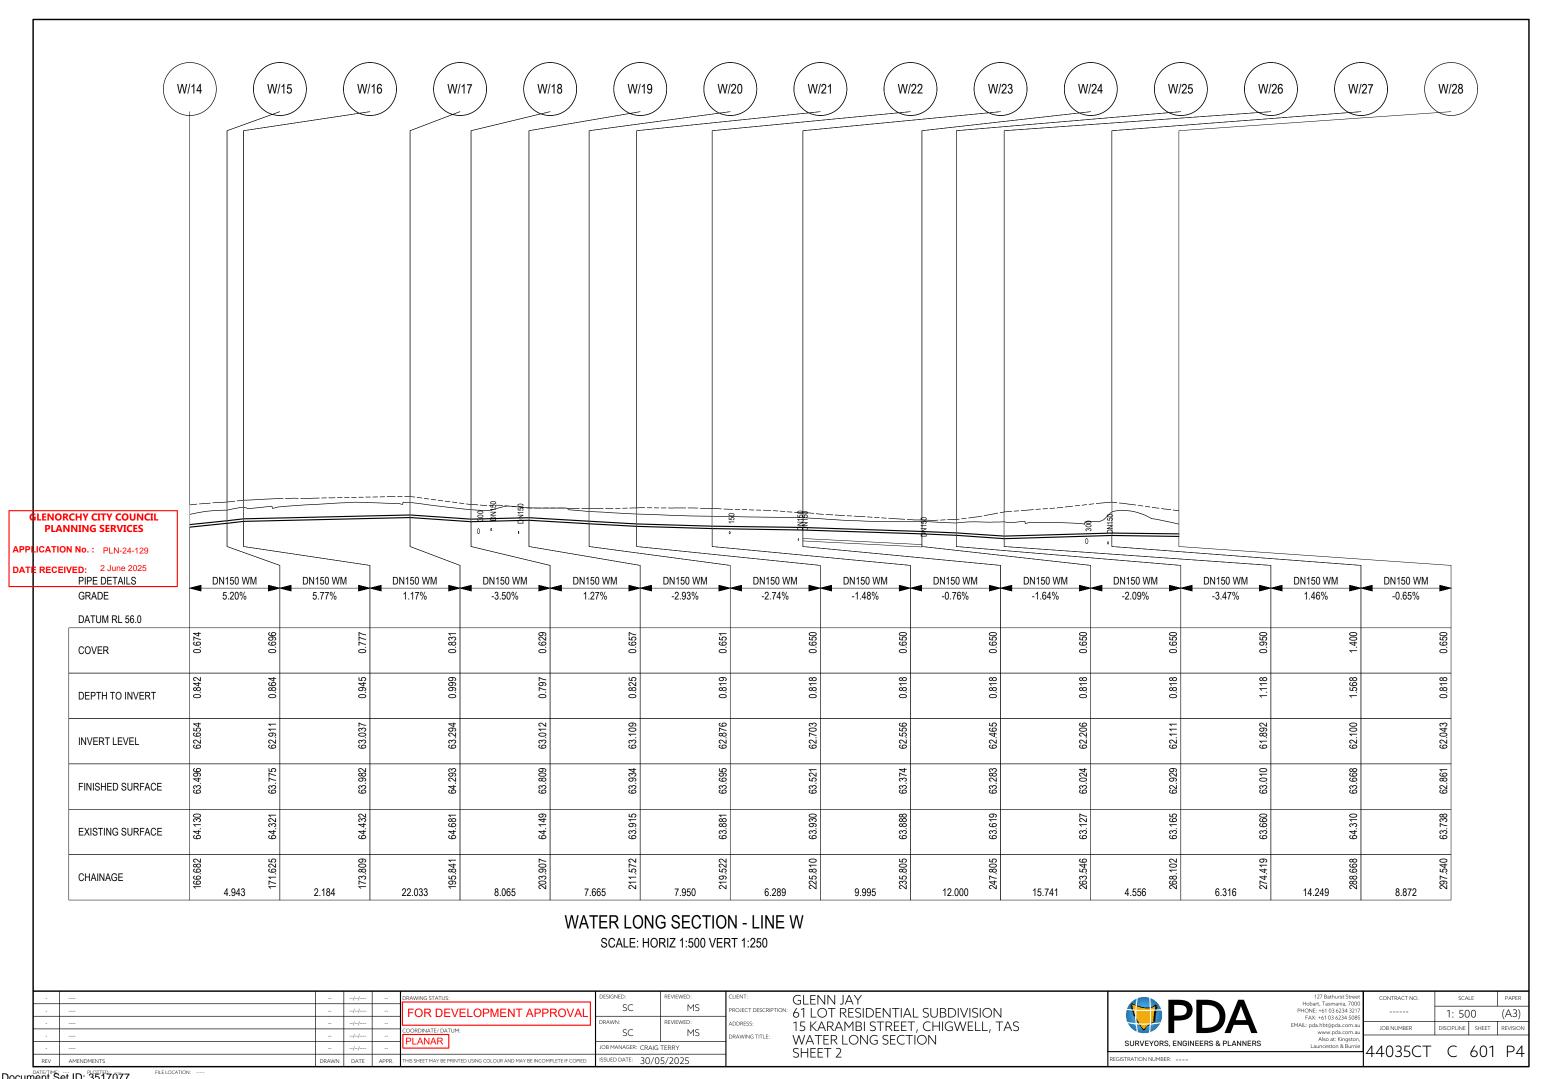
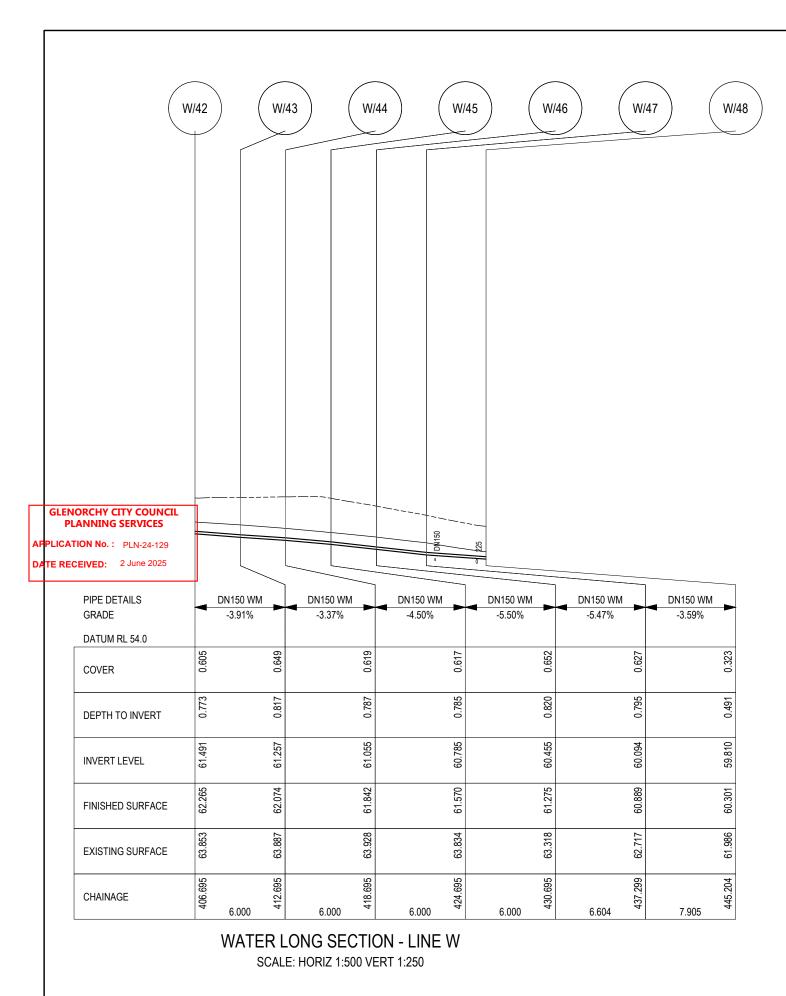
| 127 Bathurst Street Hobart, Tasmania, 7000 | CONTRACT NO. | SCALE | |
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| PHONE: +61 03 6234 3217 FAX: +61 03 6234 5085 | | 1: 50 | 0 |
| MAIL: pda.hbt@pda.com.au www.pda.com.au | JOB NUMBER | DISCIPLINE | SHE |
| Also at: Kingston, Launceston & Burnie | 4402ECT | | , , |

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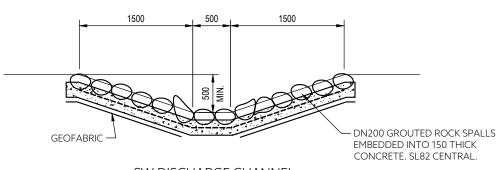
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NOTE: PLACE CONCRETE ENCASEMENT 600 ONLY AFTER PRESSURE TESTING HAS BEEN COMPLETED DN150 DIEL PIPE - SL82 REO WITH 75 COVER, N25 CONCRETE

CONCRETE ENCASEMENT OF DIEL PIPE ACROSS RIVULET SCALE 1:20


GLENORCHY CITY COUNCIL

APPLICATION No.: PLN-24-129 DATE RECEIVED: 2 June 2025



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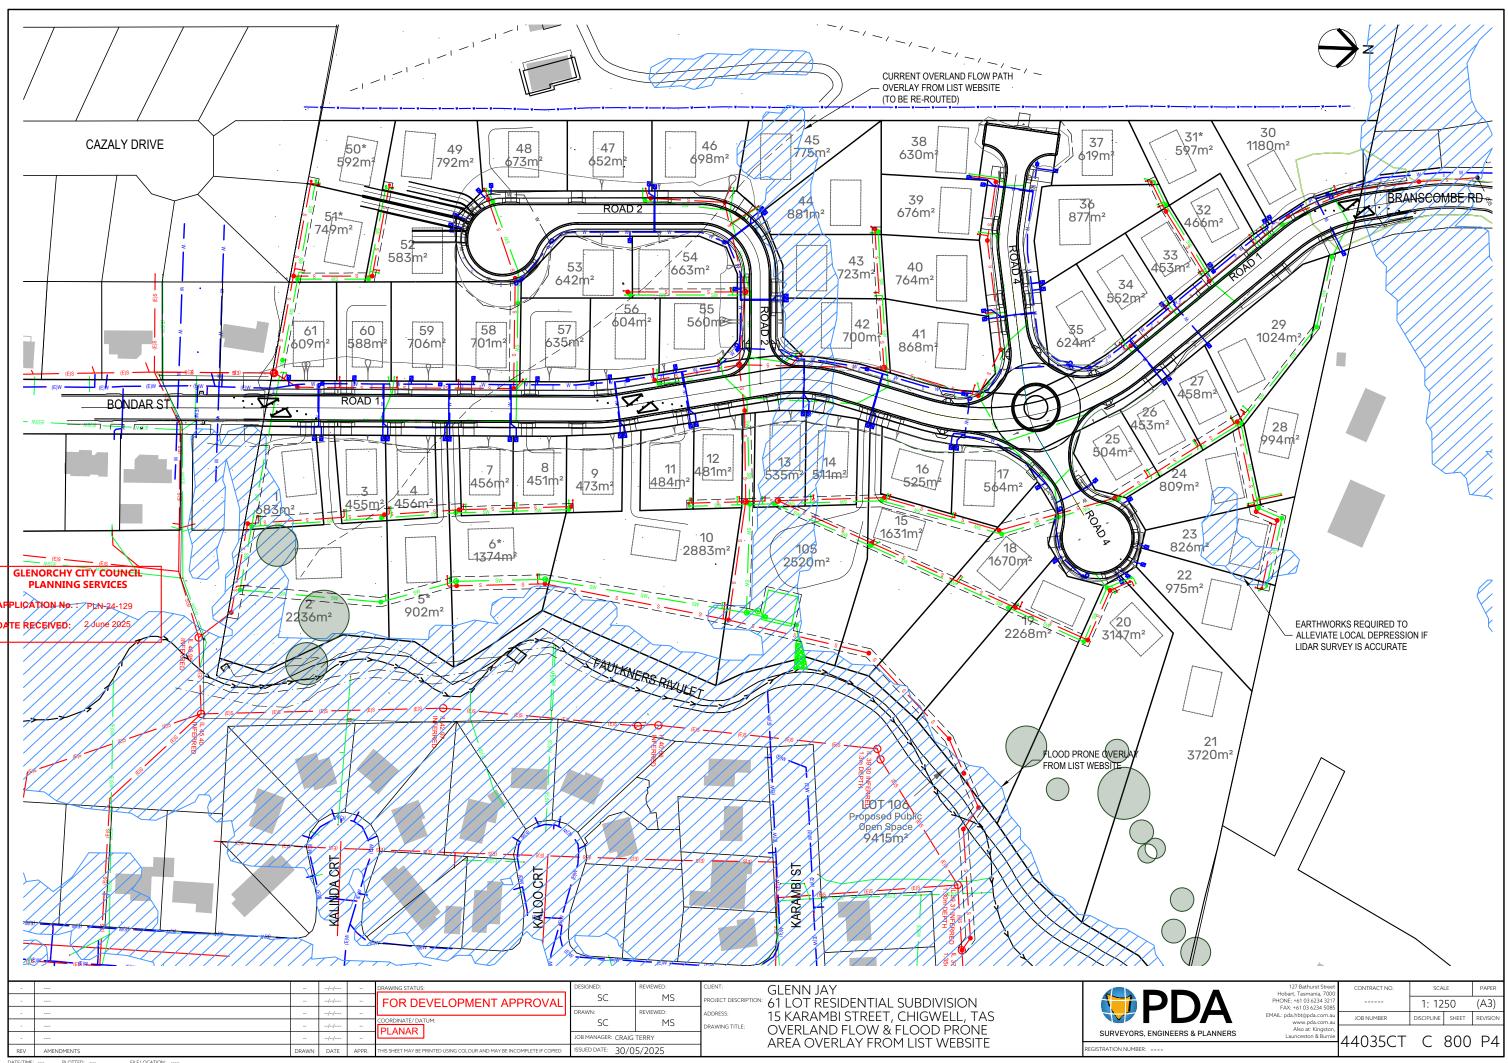
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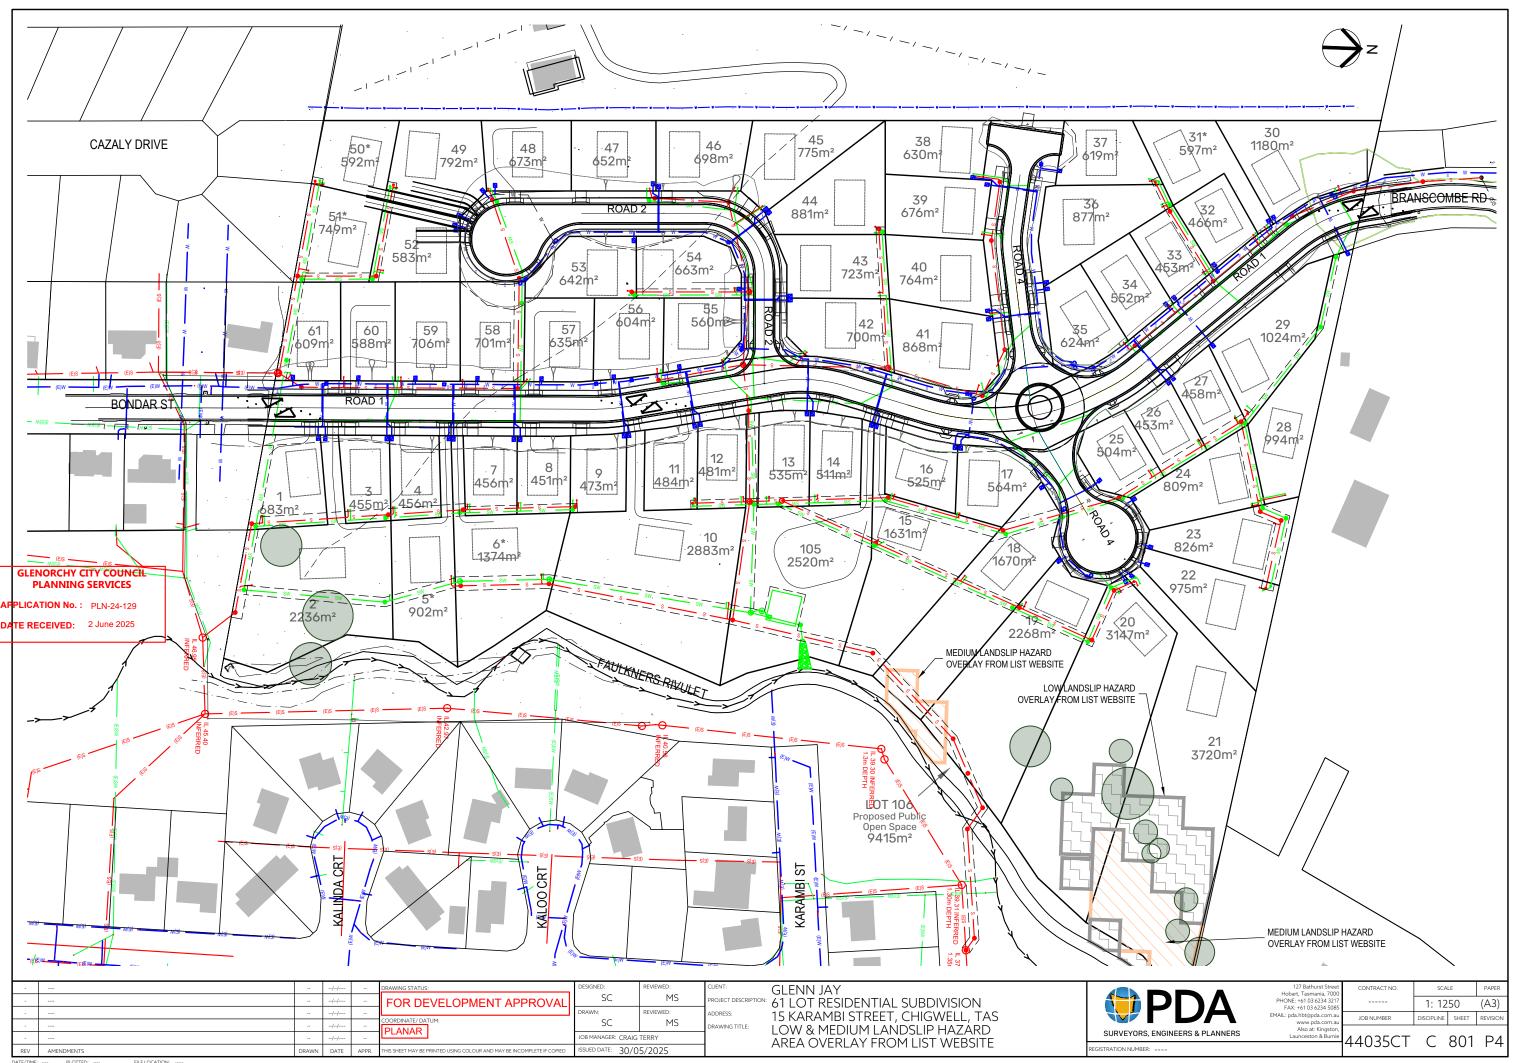
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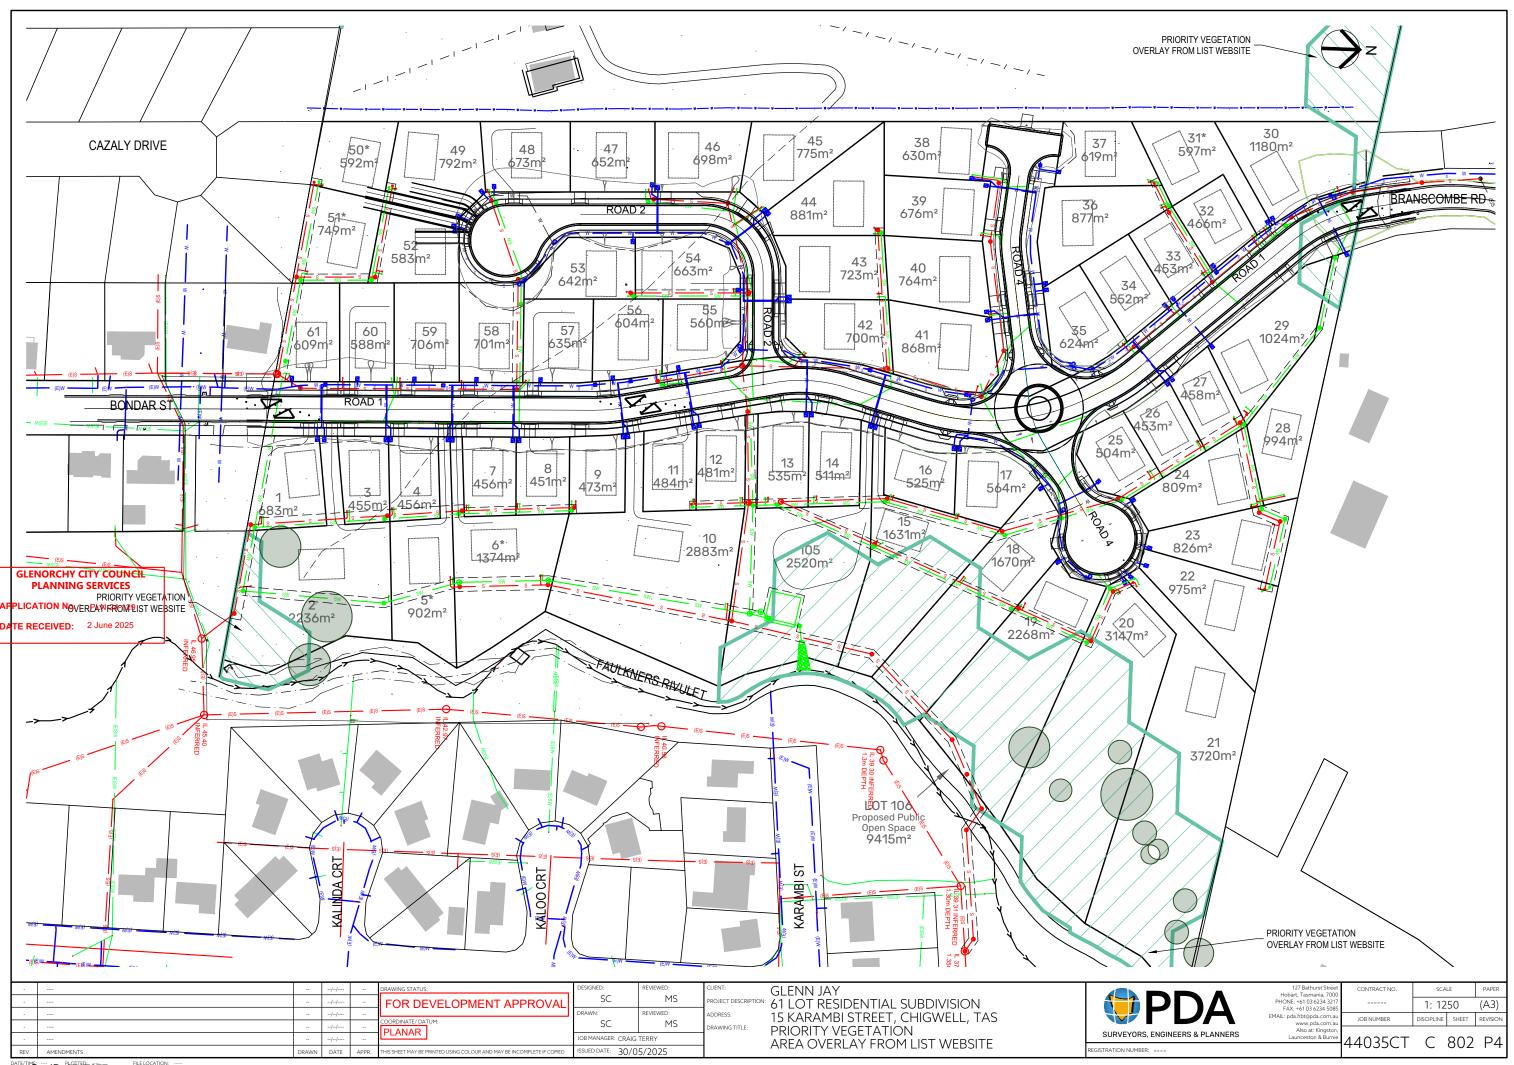
GLENN JAY PROJECT DESCRIPTION: 61 LOT RESIDENTIAL SUBDIVISION 15 KARAMBI STREET, CHIGWELL, TAS DETAILS


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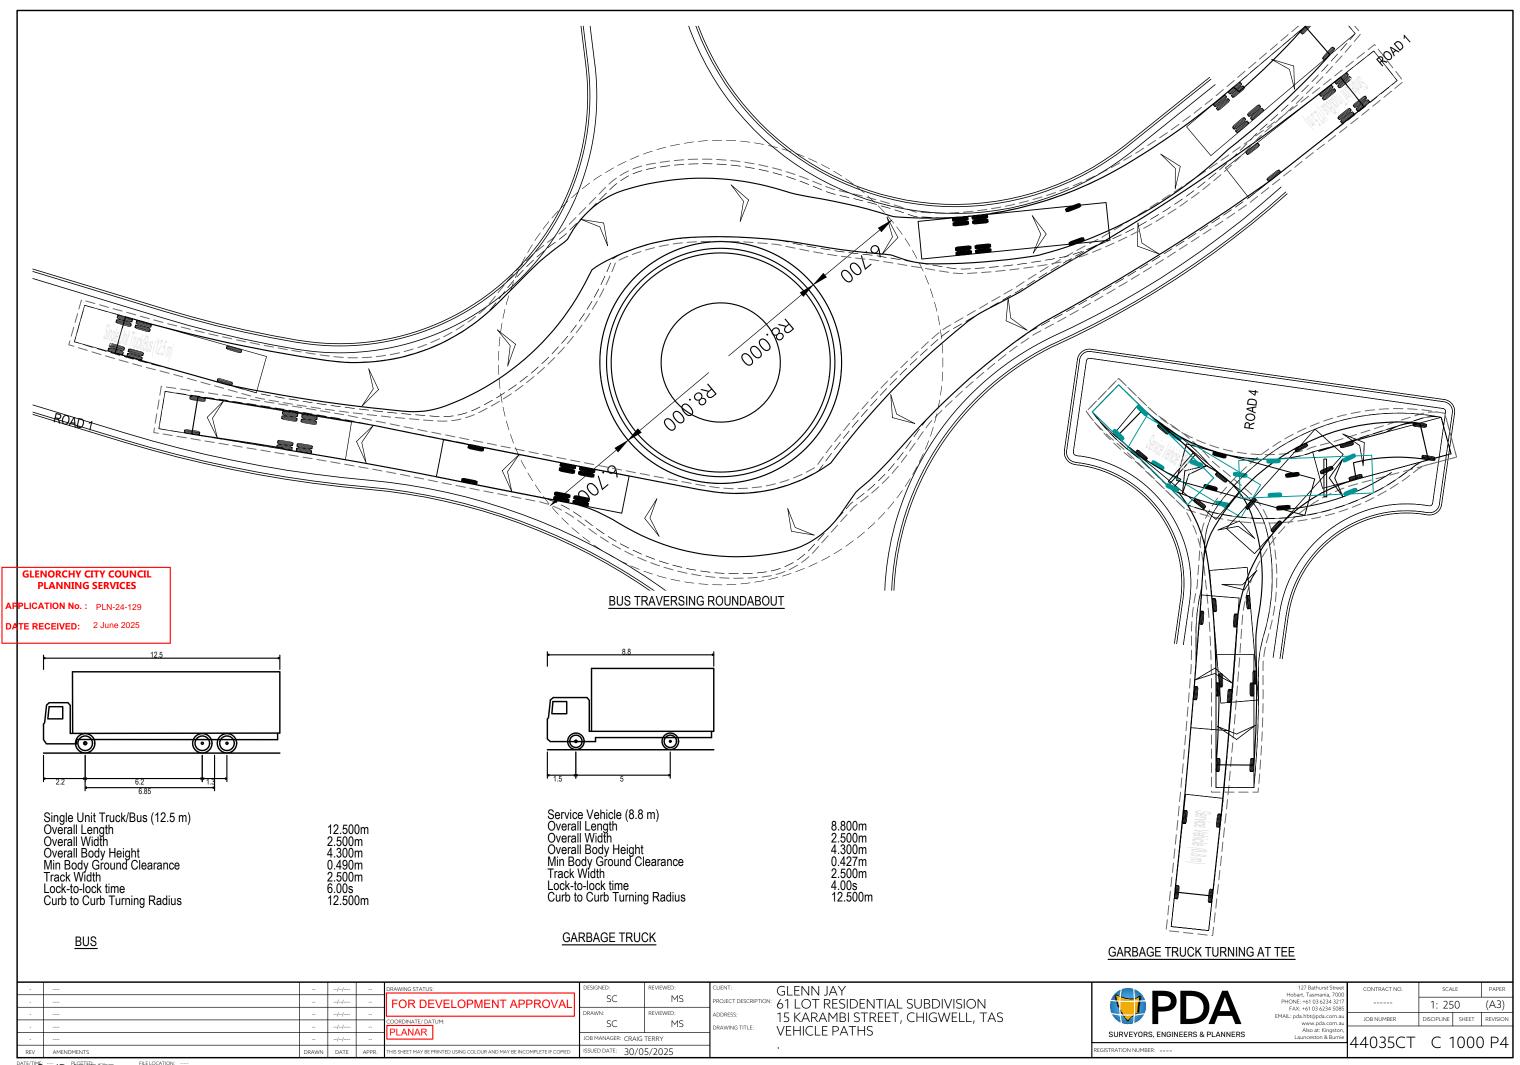
| 127 Bathurst Street Hobart, Tasmania, 7000 PHONE: +61 03 6234 3217 FAX: +61 03 6234 5085 EMAIL: pda.hbt@pda.com.au www.pda.com.au | CONTRACT NO. | SCA | LE | PAPER |
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| Also at: Kingston, Launceston & Burnie | 44035CT | | 700 | DΛ |
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Submission to Planning Authority Notice

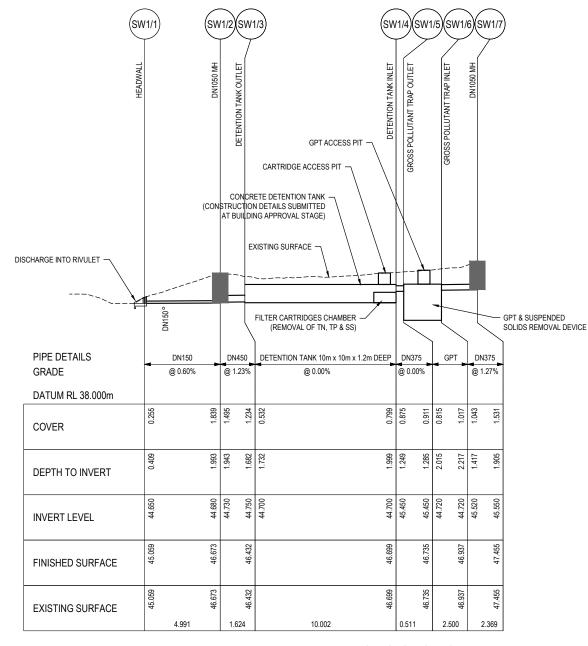Application details

Council Planning Permit No. PLN-24-129

Council notice date 1/08/2024

TasWater Reference No. TWDA 2024/00913-GCC

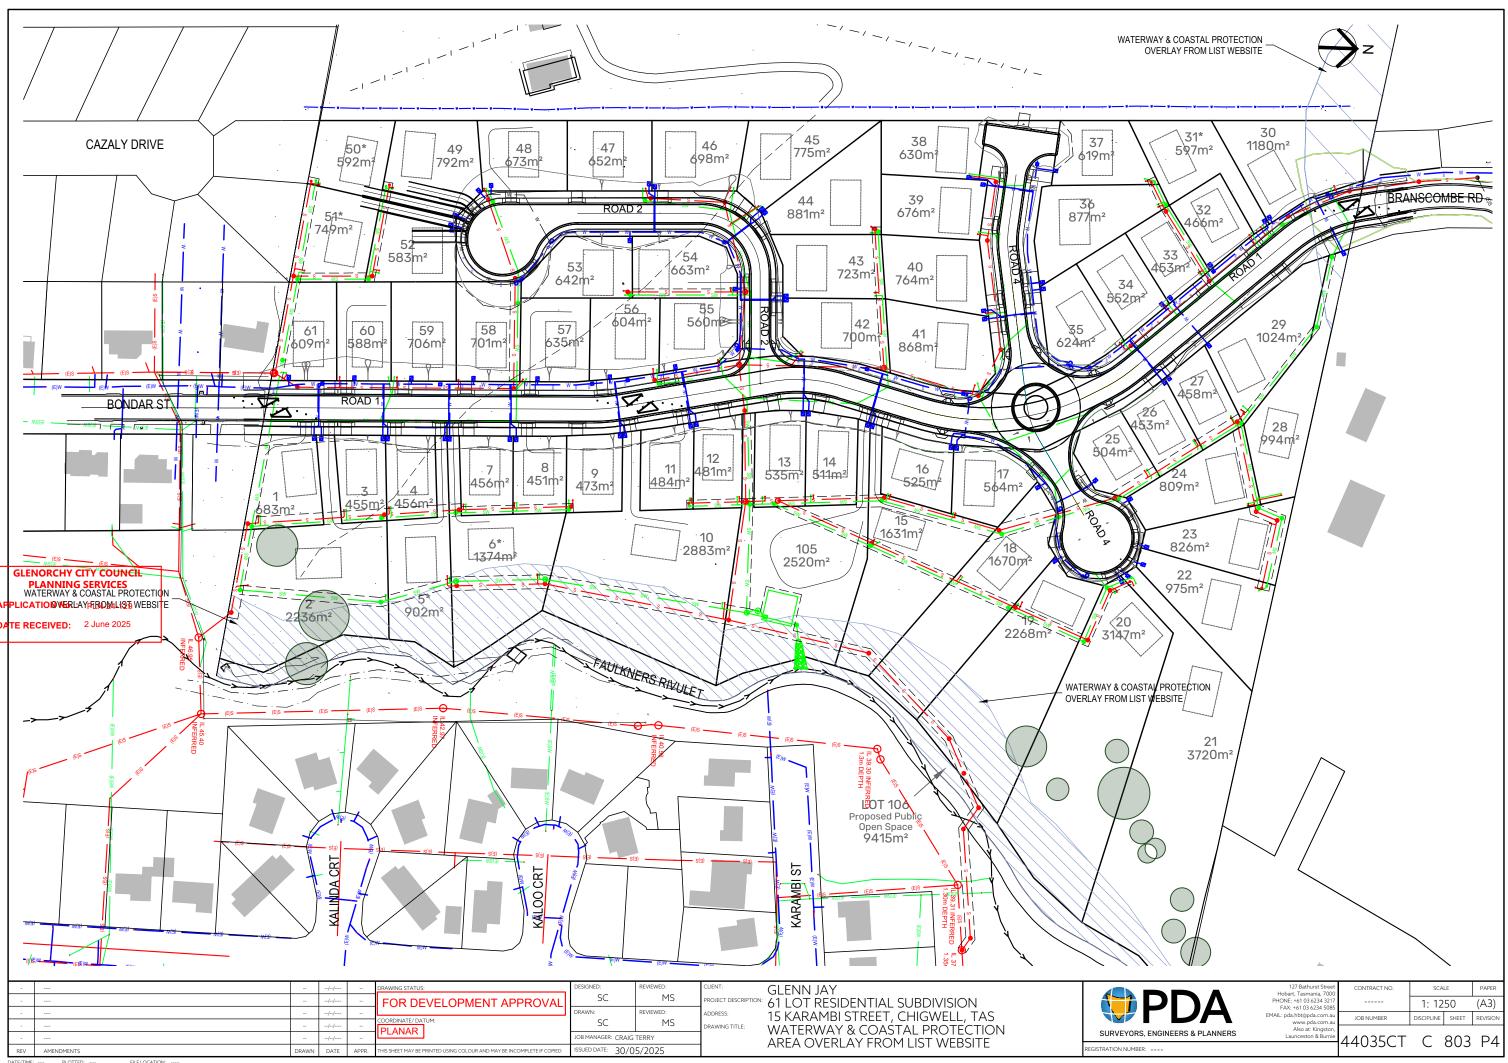Date of response 10/04/2025

TasWater Contact Al Cole

Phone No. 0439605108

Response issued to

Council name GLENORCHY CITY COUNCIL

Contact details gccmail@gcc.tas.gov.au

Development details

Address 15 KARAMBI ST, CHIGWELL

Property ID (PID) 5297675

Description of development Subdivision 61 lots

Schedule of drawings/documents

| Prepared by | Drawing/document No. | Revision No. | Issue date |
|-------------|-----------------------|--------------|------------|
| PDA | 44035CT/100-107, 500, | P3 | 07/03/2025 |

Conditions

Pursuant to the *Water and Sewerage Industry Act* 2008 (TAS) Section 56P(1) TasWater imposes the following conditions on the permit for this application:

CONNECTIONS, METERING & BACKFLOW

- A suitably sized water supply with metered connections and sewerage system and connections to each lot of the development must be designed and constructed to TasWater's satisfaction and be in accordance with any other conditions in this permit.
 - <u>Advice:</u> If the balance lot and existing house wish to retain the existing water connection, a new metered connection from the new reticulated water infrastructure must be installed. Any connection(s) to the TasWater bulk water main must be removed by TasWater at the applicant's cost.
- 2. Any removal/supply and installation of water meters and/or the removal of redundant and/or installation of new and modified property service connections must be carried out by TasWater at the developer's cost.
- 3. Prior to commencing construction of the subdivision/use of the development, any water connection utilised for construction/the development must have a backflow prevention device and water meter installed, to the satisfaction of TasWater.

Tasmanian Water & Sewerage Corporation Pty Ltd GPO Box 1393 Hobart, TAS 7001 <u>development@taswater.com,.au</u> ABN: 47 162 220 653

Page 1 of 5



ASSET CREATION & INFRASTRUCTURE WORKS

- 4. Prior to applying for Engineering Design Approval, the developer must physically locate all existing infrastructure to provide sufficient information for accurate design and physical works to be undertaken.
- 5. Plans submitted with the application for Engineering Design Approval must, to the satisfaction of TasWater show, all existing, redundant and/or proposed property services and mains.
- 6. Prior to applying for a Permit to Construct new infrastructure the developer must obtain from TasWater Engineering Design Approval for new TasWater infrastructure. The application for Engineering Design Approval must include engineering design plans prepared by a suitably qualified person showing the hydraulic servicing requirements for water and sewerage to TasWater's satisfaction.
 - <u>Advice:</u> Where applicable, detailed M/H base sections must be provided to demonstrate compliance with MRWA-S-200 requirements for fall through sewer M/H, e.g. S1/5, S1/6.
- 7. Prior to works commencing, a Permit to Construct must be applied for and issued by TasWater. All infrastructure works must be inspected by TasWater and be to TasWater's satisfaction.
- 8. Prior to undertaking any works related to water and sewerage, physical markers must be in place that clearly identify where water and/or sewer connections are to be made in accordance with any approved plan to TasWater's satisfaction.
- 9. In addition to any other conditions in this permit, all works must be constructed under the supervision of a suitably qualified person in accordance with TasWater's requirements.
- 10. Prior to the issue of a Consent to Register a Legal Document all additions, extensions, alterations or upgrades to TasWater's water and sewerage infrastructure required to service the development, are to be completed generally as shown on, and in accordance with, the plans listed in the schedule of drawings/documents, and are to be constructed at the expense of the developer to the satisfaction of TasWater, with live connections performed by TasWater.
- 11. After testing, to TasWater's requirements, of newly created works, the developer must apply to TasWater for connection of these works to existing TasWater infrastructure, at the developer's cost.
- 12. At practical completion of the water and sewerage works and prior to TasWater issuing a Consent to a Register Legal Document the developer must obtain a Certificate of Practical Completion from TasWater for the works that will be transferred to TasWater. To obtain a Certificate of Practical Completion:
 - a. Written confirmation from the supervising suitably qualified person certifying that the works have been constructed in accordance with the TasWater approved plans and specifications and that the appropriate level of workmanship has been achieved.
 - b. A request for a joint on-site inspection with TasWater's authorised representative must be made.
 - c. Security for the twelve (12) month defects liability period to the value of 10% of the works must be lodged with TasWater. This security must be in the form of a bank guarantee.



d. Work As Constructed drawings and documentation must be prepared by a suitably qualified person to TasWater's satisfaction and forwarded to TasWater.

Upon TasWater issuing a Certificate of Practical Completion, the newly constructed infrastructure is deemed to have transferred to TasWater.

- 13. After the Certificate of Practical Completion has been issued, a 12-month defects liability period applies to this infrastructure. During this period all defects must be rectified at the developer's cost and to the satisfaction of TasWater. A further 12-month defects liability period may be applied to defects after rectification. TasWater may, at its discretion, undertake rectification of any defects at the developer's cost. Upon completion, of the defects liability period the developer must request TasWater to issue a "Certificate of Final Acceptance". TasWater will release any security held for the defect's liability period.
- 14. The developer must take all precautions to protect existing TasWater infrastructure. Any damage caused to existing TasWater infrastructure during the construction period must be promptly reported to TasWater and repaired by TasWater at the developer's cost.
- 15. Ground levels over the TasWater assets and/or easements must not be altered without the written approval of TasWater.
- 16. A construction management plan must be submitted with the application for TasWater Engineering Design Approval. The construction management plan must detail how the new TasWater infrastructure will be constructed while maintaining current levels of services provided by TasWater to the community. The construction plan must also include a risk assessment and contingency plans covering major risks to TasWater during any works. The construction plan must be to the satisfaction of TasWater prior to TasWater's Engineering Design Approval being issued.

FINAL PLANS, EASEMENTS & ENDORSEMENTS

- 17. Prior to the Sealing of the Final Plan of Survey, a Consent to Register a Legal Document must be obtained from TasWater as evidence of compliance with these conditions when application for sealing is made.

 Advice: Council will refer the Final Plan of Survey to TasWater requesting Consent to Register a Legal Document be issued directly to them on behalf of the applicant.
- 18. Pipeline easements, to TasWater's satisfaction, must be created over any existing or proposed TasWater infrastructure and be in accordance with TasWater's standard pipeline easement conditions.
- 19. Prior to the issue of a Consent to Register a Legal Document / Certificate of Practical Completion from TasWater, the applicant must submit a copy of the completed Transfer for the provision of a Pipeline and Services Easement(s)/lot(s) to cover proposed TasWater infrastructure as required by condition 18. All costs and expenses related to the transfer of easement(s) to TasWater are to be paid by the developer.
- 20. In the event that the property sewer connection for affected lots cannot control the lot for a gravity connection, the Plan of Subdivision Council Endorsement Page for those affected lots is to note, pursuant to Section 83 of the Local Government (Building and Miscellaneous Provisions) Act 1993, that TasWater cannot guarantee sanitary drains will be able to discharge via gravity into TasWater's sewerage system.
 - <u>Advice:</u> See WSA 02—2014–3.1 MRWA Version 2 section 5.6.5.3 Calculating the level of the connection point



- 21. Prior to the issue of a TasWater Consent to Register a Legal Document, the applicant must submit a .dwg file, prepared by a suitably qualified person to TasWater's satisfaction, showing:
 - a. the exact location of the existing bulk water main and associated infrastructure,
 - b. the easement protecting that infrastructure.

The developer must locate the existing TasWater infrastructure and clearly show it on the .dwg file. Existing TasWater infrastructure may be located by a surveyor and/or a private contractor engaged at the developers cost.

DEVELOPER CHARGES

- 22. Prior to TasWater issuing a Consent to Register a Legal Document, the applicant or landowner as the case may be, must pay a developer charge totalling \$210,840.00 to TasWater for water and sewerage infrastructure for 60 additional Equivalent Tenements, indexed by the Consumer Price Index All groups (Hobart) from the date of this Submission to Planning Authority Notice until the date it is paid to TasWater.
- 23. In the event Council approves a staging plan, prior to TasWater issuing a Consent to Register a Legal Document for each stage, the developer must pay the developer charges commensurate with the number of Equivalent Tenements in each stage, as approved by Council.

DEVELOPMENT ASSESSMENT FEES

24. The applicant or landowner as the case may be, must pay a development assessment fee of \$1,307.93, and a Consent to Register a Legal Document fee of \$256.99 to TasWater, as approved by the Economic Regulator and the fees will be indexed, until the date paid to TasWater.

The payment is required within 30 days of the issue of an invoice by TasWater.

In the event Council approves a staging plan, a Consent to Register a Legal Document fee for each stage, must be paid commensurate with the number of Equivalent Tenements in each stage, as approved by Council.

Advice

General

For information on TasWater development standards, please visit https://www.taswater.com.au/building-and-development/technical-standards
For application forms please visit

https://www.taswater.com.au/building-and-development/development-application-form

Developer Charges

For information on Developer Charges please visit the following webpage - https://www.taswater.com.au/building-and-development/developer-charges

Service Locations

Please note that the developer is responsible for arranging to locate the existing TasWater infrastructure and clearly showing it on the drawings. Existing TasWater infrastructure may be located by a surveyor and/or a private contractor engaged at the developers cost to locate the infrastructure.

(a) A permit is required to work within TasWater's easements or in the vicinity of its infrastructure. Further information can be obtained from TasWater.

4



- (b) TasWater has listed a number of service providers who can provide asset detection and location services should you require it. Visit https://www.taswater.com.au/building-and-development/service-locations for a list of companies.
- (c) Sewer drainage plans or Inspection Openings (IO) for residential properties are available from your local council.

Declaration

The drawings/documents and conditions stated above constitute TasWater's Submission to Planning Authority Notice.

GPA - Attachment 2 15 Karambi Street Chigwell

Referral Officers Reports

DEVELOPMENT APPLICATIONS

DEVELOPMENT ENGINEER REFERRAL

| DA No. | PLN-24-129 | Date Referred | 20/06/2024 |
|----------------------|--------------|-------------------------|---------------|
| Planner | Helen Ayers | To Be Returned By | 27/06/2024 |
| Development Engineer | David Morley | Date Returned | Select |
| Property File No. | 5297675 | Discretionary Permitted | Discretionary |

| Details of Application | Applicant | PDA Surveyors Engineering and Planners |
|------------------------|------------------------|--|
| Аррисаціон | Business Contact Name | |
| | Contact Email | jane.monks@pda.com.au |
| | Address of Development | 15 Karambi Street Chigwell |
| | Proposal in Detail | Subdivision (61 Lots plus balance) |

Comments

Subdivision Proposal Summary

The developer has submitted a proposal to construct a 61-lot residential subdivision. The design includes a central road linking Boondar Street to Branscombe Road, from which three smaller roads will branch off, each terminating in a cul-de-sac. Two of these cul-de-sacs will connect via a central roundabout, while the third joins the main road through a T-junction.

The development is to proceed in four stages and will take place on moderately steep terrain. Notably, a portion of the eastern and northeastern parcels falls within a moderate landslip area, which may pose design challenges.

Assessment and Conditions


Conditions applied to this approval are intended to protect the integrity and longevity of the road network and associated infrastructure, which will be transferred to council ownership and maintenance. These requirements also serve to ensure the broader community and future residents benefit from safe, high-quality infrastructure and developable land.

Building envelopes must be located entirely within designated drainage and embankment easements. Furthermore, construction within embankment easements will impose additional restrictions on individual developments, particularly with respect to parking and access.

Conclusion

The subdivision represents a reasonably well-considered design, effectively maximizing lot yield within the constraints of the usable land. Due to steep lot gradients, many lots may require elevated parking structures, which should be addressed at the individual dwelling design stage rather than through broad subdivision restrictions.

While the subdivision is supported in principle at the development application stage, the applicant is advised that the current layout may require modification following detailed design and geotechnical investigation.

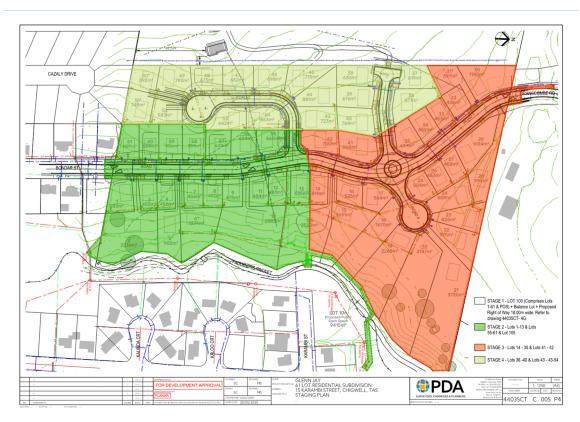

Standard Conditions

GENERAL

- Use and development must be substantially in accordance with planning permit application No. PLN-24-149 and Drawings submitted on 30th of May 2025 Rev P4 except as otherwise required by this permit
- 2. Prior to the approval of engineering plans, a detailed cost estimate for all civil works must be provided. This estimate will be used to calculate the engineering assessment fee. Under Council Schedule of fees and charges, the engineering drawings approval fee is 2.2% of the value of the civil works. This amount is subject to annual adjustment in accordance with the Council Fees and Charges Register. This fee must be paid prior to the issuing of the approved engineering plans.
- 3. The loading and unloading of goods from vehicles, including building materials and equipment, must only be carried out on the land.
- 4. The property owner is to ensure that Council's Road Assets and Infrastructure are protected during the construction process. The owner is to ensure that damage to road assets, footpaths, kerb and channel, drainage pits, nature strips and other services is kept to a minimum and any damaged assets are reinstated. Should damages occur, the repair costs associated with such damages are the responsibility of the property owner. If reinstatement works are not undertaken promptly or to Council's satisfaction, Council may elect to reinstate or rectify any defects and recover the expenses reasonably incurred in doing so from the property owner.
- 5. Prior to the issue of building approval and/or commencement of works (whichever occurs first), including demolition and excavation, a Construction Management Plan, must be submitted and approved as a Condition Endorsement, to the satisfaction of the Council's Senior Statutory Planner. The plan must provide details of the following:
 - a) Hours for construction activity in accordance with any other condition of this permit;
 - b) Measures to control noise, dust, water and sediment laden runoff;

- c) Measures relating to removal of hazardous or dangerous material from the site, where applicable;
- d) A plan showing the location of parking areas for construction and sub-contractors' vehicles on and surrounding the site, to ensure that vehicles associated with construction activity cause minimum disruption to surrounding premises. Any basement car park on the land must be made available for use by sub-constructors/tradespersons upon completion of such areas, without delay;
- e) A Traffic Management Plan showing truck routes to and from the site;
- f) Swept path analysis demonstrating the ability for trucks to enter and exit the site in a safe manner for the largest anticipated truck associated with the construction;
- g) A plan showing the location and design of a vehicle wash-down bay for construction vehicles on the site;
- h) Measures to ensure that sub-contractors/tradespersons operating on the site are aware of the contents of the construction management plan;
- Contact details of key construction site staff;
- A site plan showing the location of any site sheds, on-site amenities, building waste storage and the like, noting that Council does not support site sheds on Council road reserves; and
- k) Any other relevant matters

Advice: This condition requires further information to be submitted as a Condition Endorsement. Refer to the Condition Endorsement advice at the end of this permit.

ENGINEERING

- 6. No civil works related to or associated with the use or development approved by this permit are to occur on or external to the site unless these works are in accordance with engineering drawings that have been approved by Council's Development Engineer. Changes to the design and/or location of civil works will require the submission of amended engineering drawings prepared by a licensed civil engineer for approval by Council's Engineer.
- 7. Prior to the issuing of building approval and/or the commencement of works, including demolition (whichever occurs first), a Soil and Water Management Plan detailing proposed sediment and erosion control measures must be submitted and approved as Condition Endorsement, to the satisfaction of the Council's Senior Development Engineer. These plans must be prepared in accordance with the Derwent Estuary Program guidelines (Erosion and Sediment Control).

The approved control measures must be installed prior to any disturbance of soil or construction activity such as concrete cutting or demolition. The measures must be regularly inspected and maintained during the construction and demolition period to prevent soil and other materials entering the local stormwater system, roadways, or adjoining properties.

The approved control measures must remain in place until such time as all construction activity likely to generate sediment has been completed or all disturbed areas have been stabilised using vegetation and/or restored or sealed to the satisfaction of the Councils Senior Development Engineer. Any temporary or permanent batter stabilisation works must be designed according to the recommendations from a qualified Geotechnical Engineer.

ROAD INFRASTRUCTURE

8. The developer shall undertake engineering design drawings, which include three slow points and a road width of between 8.5m and 8.9m on the main through road, along with footpaths on both sides of all the roads. The engineering drawings must be submitted to Council, to the satisfaction of the Director of Infrastructure and Works. The works shall be installed as per the engineering drawings by the developer prior to tiles being issued.

- 9. Provide detailed drawings of all road infrastructure associated with the subdivision for the approval of the Council's Director Infrastructure Services. must be submitted and approved as a Condition Endorsement, to the satisfaction of the Director of Infrastructure and Works and Senior Development Engineer. All road infrastructure drawings are to be designed by a suitably qualified and experienced engineer in accordance with the Institute of Public Works Engineering's 'Tasmanian Standard Drawings and Guidelines', the Department of State Growth Specifications and all other relevant standards, guidelines and procedures.

 Advice: Minimum road pavement widths to be in compliance with Table 1, Road requirements, IPWEA TSD R06. Design drawings shall include, but not be limited to:
 - a) Fully dimensioned horizontal and vertical geometry, including the intersections;
 - b) Construction details in typical cross sections;
 - c) Drainage details;
 - d) Crossfalls;
 - e) Kerb lines;
 - f) Spot levels;
 - g) Stormwater pits and reticulation details;
 - h) Pipe material, class and gradients;
 - i) Pedestrian and vehicle safety barriers;
 - j) Traffic management signage;
 - k) Traffic management devices;
 - I) Footpath details (footpaths to be constructed using concrete);
 - m) Kerb ramp details and locations;
 - n) Long section of road showing grades;
 - o) Road cross sections;
 - p) Details of any benching required for the road construction; and
 - q) All weather access to stormwater devices.

The design drawings when/if approved by the Council's Director Infrastructure Services will be issued as the Council-approved engineering drawings. Structural certificates will be required for pedestrian and vehicle safety barriers to ensure compliance with relevant codes and standards. The approved plans must be complied with.

10. Design of any excavation and/or any earth retaining structures (e.g. embankments, cuttings, retaining walls) and associated structural certificates for any structures must be submitted to council for condition endorsement.

The design must:

- a) Be in accordance with AS4678
- b) Take into account any additional surcharge loadings as required by relevant Australian Standards.
- c) Take into account and reference accordingly any Geotechnical findings.
- d) Detail any mitigation measures required.
- e) The structure certificated and/or design should note accordingly the above.
- f) Include a safe design of structures assessment in accordance with The Safe Design of Structures Code of Practice 2018.

 All work required by this condition must be constructed undertaken in accordance with the approved engineering drawings.

11. Vehicle crash barriers with the proposed highway reservation compliant with the Australian/New Zealand Standard AS / NZS 1170.1 and/or the (IPWEA) LGAT – Tasmanian Standard Drawings must be installed prior to the sealing of the final plan of subdivision for each stage.

A certified design/report prepared by a suitably qualified engineer, to satisfy the above requirements, must be provided to the Council prior to the commencement of work.

All works, required by this condition must be undertaken in accordance with certified design/report. Upon completion the barriers must be inspected by a qualified engineer and a certification submitted to the Council, confirming that the installed barriers comply with the above requirement.

Advice:

- Once the engineering construction drawings have been approved the Council will issue a condition endorsement.
- Separate to Council public infrastructure approval, approvals under the Building Act 2016 will be required and completion documentation required prior to Council taking ownership of this infrastructure.
- This condition permits the staging of the development
- 12. Compaction of all infill areas including lots to be at 98%.

State clearly on plans that "all earthworks are to be completed under level 1 supervision and testing by a licensed geotechnical authority".

Provision of supervision report and copies of compaction tests with locations to be provided to the Council prior to the issuing of any Completion Certificate under the Building Act 2016.

- 13. Prior to the issue of building approval and/or commencement of works (whichever occurs first), plans showing the detailed design of the new vehicle crossings must be submitted and approved as a Condition Endorsement, to the satisfaction of the Council's Senior Development Engineer. The design and construction must be in accordance with the Tasmanian standard drawing TSD-R09-v3 between the kerb and the property boundary. The vehicle crossing must be completed prior to the occupancy of the dwelling.
 - a) Design driveway access onto the lots with gradients that comply with AS2890 and LGAT drawings.
 - b) Long and cross sections of the road, footpaths, walkways and driveways onto each lot.
 - c) Clearly show that there is 2m behind any proposed retaining wall either by road reservation or embankment easement.
 - d) Include designs of any excavation and/or any earth-retaining structures (e.g. embankments, cuttings, retaining walls) and associated structural certificates for any structures such as vehicle parking decks.
- 14. A street lighting design for all roads and footways must be submitted and approved, prior to sealing of the final plan. The street lighting design must be:
 - a) In accordance with AS/NZS 1158 series to the requirements of Tas Network and Council.
 - b) Include Tas Networks standard supplied poles and energy-efficient road light fittings.
 - c) Be certified by a suitably qualified person.

All work required by this condition must be undertaken in accordance with the approved street lighting design.

15. An approved reflectorised "no-road" sign and barrier must be erected at the end of each stage of construction.

SERVICES

General

- 16. A separate service connection for water supply, sewerage, and stormwater must be provided to each lot in accordance with the requirements of Council's Senior Development Engineer.
- 17. Easements must be created over all existing and proposed service lines in accordance with the requirements of Council's Senior Development Engineer.
- 18. Services for rear lots must be provided from the front boundary or legal point of connection for the total length of the access of internal rear blocks.
- 19. The developer must provide underground electrical reticulation for power and street lighting. Underground TasNetworks cables must be used subject to any underground cables in joint use trenches complying with Council's Senior Development Engineer's requirements.

Stormwater Management

- 20. Engineering design drawings must be submitted and approved, prior to the construction or the issue of Building/Pluming Permit, whichever occurs first. The engineering drawings must:
 - d) be certified by a qualified and experienced Engineer;
 - e) Clearly distinguish between public and private infrastructure;
 - f) Include provision for future development within the catchment to be adequately and efficiently serviced, i.e., via appropriate easements;
 - g) Show the final Lot boundaries, with each Lot serviced separately by Council infrastructure and all private plumbing contained within each lot;
 - h) Specify lot connection sizes, depths, and locations such that as much as practicable of the lots can be drained via gravity;
 - i) Show any existing connections. Any redundant connections must be sealed by the Council at the owner's expense prior to sealing of the final plan;
 - show in both plan and long-section the proposed stormwater mains, including but not limited to, connections, flows, velocities, hydraulic grade lines, clearances, cover, gradients, sizing, material, pipe class, adequate working platforms around manholes, easements, and inspection openings;
 - k) Provide details of the cutoff drain extension as suggested in concept engineering plans by PDA Revision P4, dated 30.05.2025. It should include drain geometry with a minimum 200mm freeboard and suitable batter treatment/lining to safely convey overland flows;
 - I) Provide details of the proposed On-site detention device (OSD) including inlet, outlet, orifice control, overflow mechanism and access points for maintenance;
 - m) Provide details of the proposed Stormwater quality treatment devices including inlet, outlet, orifice control, overflow mechanism/ hy flow bypass and access points and path for maintenance. A safe grass decanting area must be provided near the proposed infrastructure that is at least 30m away from the watercourse;
 - n) Be substantially in accordance with the LGAT Standard Drawings and Tasmanian Subdivision Guidelines 2013.

All work required by this condition must be undertaken in accordance with the approved engineered drawings.

21. Extend the proposed partial 'PIPELINE AND SERVICES & DRAINAGE EASEMENT' within lot 20 all the way to the watercourse along the shared boundary with lot 19. The proposed low point of the cul-de-sac should be designed to ensure that any upwelling or surcharge of runoff on the roadway can be effectively directed into the drainage easement of Lot 20.

- 22. The new stormwater infrastructure must be constructed prior to the sealing of the final plan / issue of a final certificate.
- 23. Digital copies of a post construction work CCTV video and associated report(s) of any proposed Council stormwater main must be submitted to the satisfaction of Council after completion of all work but prior to the issue of any Certificate of Completion.
- 24. Prior to the commencement of the use or development, a new stormwater connection, equivalent to a 150mm diameter pipe, unless specified otherwise in the approved plans, must be installed from the property boundary to Council's public stormwater. The detailed design of the connection must comply with the LGAT drawing and be submitted for approval prior to the issuing of the building permit or the commencement of works (whichever occurs first). Any existing stormwater connections that are abandoned must be decommissioned and sealed at the owner's expense.
- 25. The stormwater connection(s) must be constructed by a suitably qualified person, inspected by Council's Plumbing Surveyor, and completed to the satisfaction of Council. The applicant must notify the relevant Council officer for an inspection prior to backfilling.
 - Advice: If the stormwater connection works are not left exposed for inspection, Council may require the Applicant to undertake a CCTV inspection at the Applicant's cost. A digital copy of the CCTV inspection video, along with the associated report(s), must be submitted to Council prior to the issuance of any Certificate of Completion.
- 26. Residential underground power and fibre ready facilities (pit and pipe that can hold optical telecommunication fibre line) to each lot and street lighting must be installed prior to the sealing of the final plan.

SUBDIVISION

- 27. If the subdivision is proposed to be staged, then a Plan of Survey and Schedule of Easements for each stage of the subdivision in accordance with the approved plan of subdivision is to be submitted separately for sealing by Council.
- 28. The applicant must make available to all prospective purchasers, or their agents upon request, a copy of the Geotechnical Sit Investigation prepared by GES dated 19/12/2024.
- 29. All public open space areas must be shown as lots on the Final Plan with the notation, "Public Open Space".
- 30. Residential underground power to each lot must be installed prior to the sealing of the final plan. *Reason for the condition*

To ensure that the subdivision of land provides adequate services to meet the projected needs of future development.

PUBLIC OPEN SPACE PROVIDED

31. All public open space areas must be shown as lots on the Final Plan with the notation, "Public Open Space".

EMBANKMENT EASMENTS

32. Embankment Easement must be shown on the final diagram where road batters or retaining structure extend into any lot. To ensure protection of the road reservation no construction in the embankment easements must not occur without express permission from Council.

COPY OF PLAN OF SUBDIVISION

33. An original of each of the Plan of Subdivision and Schedule of Easements must be submitted to Council for sealing.

TRANSFER OF ROADS, ROAD, WALKWAYS AND OPEN SPACE TO COUNCIL

34. Any lots described as "public open space", "public access way", "road" or "to be acquired by the Highway Authority" on the Final Plan must be transferred to the Council for a nominal sum of \$1.00 and must be accompanied by a Memorandum of Transfer to the Glenorchy City Council, all documentation in relation to discharges of any Mortgages, caveats or the like, and all relevant registrable dealings. This Transfer must be executed by the vendor, identifying the lot(s) to be transferred and the applicant is responsible for all Land Titles Office and stamp duty fees and charges.

The applicant remains responsible for ensuring that any Land Titles Office requisitions are effectively resolved, and the applicant must meet the costs of such requisitions.

FEES

35. The applicant must pay Council the amount of \$305.00 per lot on the diagram to complete the measure up and record 'as constructed' data for all assets to be taken over by Council prior to the sealing of a Final Plan. This amount is subject to annual adjustment with the Council Fees and Charges Register.

SURVEY

36. Prior to the sealing of the final plan, private sewer, stormwater (including surface drainage) and water services/connections are to be entirely separate to each lot and contained wholly within the lots served.

Reason for condition;

To ensure that each lot is services separately.

37. Prior to the sealing of the final plan, the developer must verify compliance with condition condition 36 by supplying the Council with as-installed services plan(S) clearly indicating the location and details of all relevant services (entirely contained within their respective lots or appropriate easements). The as-installed services plan must be accompanied by certification from a suitably qualified person that all engineering work required by this permit has been completed.

Advice:

Any final plan submitted for sealing will not be processed unless it is accompanied by documentation by a suitably qualified person that clearly certifies that this condition has been satisfied and that all the work required by This condition has been completed. A 'suitably qualified person' must be a Professional Engineer or Professional Surveyor or other persons acceptable to

Council.


Reason for condition


To ensure that the Developer provides the Council with clear written confirmation that the separation of services is complete.

APPENDIX

C2.0 Parking and Sustainable Transport Code

| Standard | Acceptable Solution | Proposed | Complies? |
|---------------------|--|----------|-----------|
| | C2.5 Use Standards | | , |
| C2.5.1 | A1 | | N/A |
| Car parking numbers | The number of on-site car parking spaces must be no less than the number specified in Table C2.1, excluding if: (a) the site is subject to a parking plan for the area adopted by council, in which case parking provision (spaces or cash-in-lieu) must be in accordance with that plan; (b) the site is contained within a parking precinct plan and subject to Clause C2.7; (c) the site is subject to Clause C2.5.5; or (d) it relates to an intensification of an existing use or development or a change of use where: (i) the number of on-site car parking spaces for the existing use or development specified in Table C2.1 is greater than the number of car parking spaces specified in Table C2.1 for the proposed use or development, in which case no additional on-site car parking is required; or | | |

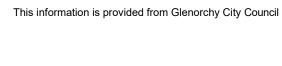

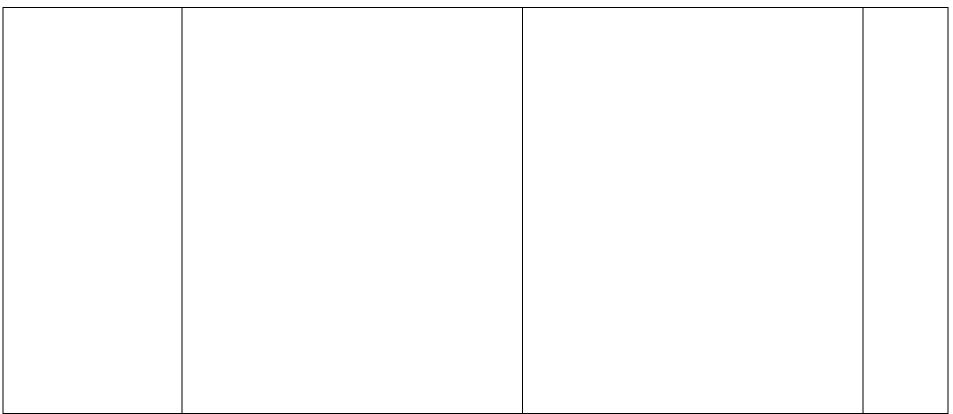

| Standard | Acceptable Solution | Proposed | Complies? |
|--|---|----------|-----------|
| | (ii) the number of on-site car parking spaces for the existing use or development specified in Table C2.1 is less than the number of car parking spaces specified in Table C2.1 for the proposed use or development, in which case on-site car parking must be calculated as follows: | | N/A |
| | N = A + (C- B) | | |
| | N = Number of on-site car parking spaces required | | |
| | A = Number of existing on site car parking spaces | | |
| | B = Number of on-site car parking spaces required for the existing use or development specified in Table C2.1 | | |
| | C= Number of on-site car parking spaces required for the proposed use or development specified in Table C2.1. | | |
| C2.5.2 | A1 | | N/A |
| Bicycle parking numbers | Bicycle parking spaces must: | | |
| | (a) be provided on the site or within 50m of the site; and | | |
| | (b) be no less than the number specified in Table C2.1. | | |
| C2.5.3 | A1 | | N/A |
| Motorcycle parking numbers This applies to: | The number of on-site motorcycle parking spaces for all uses must: | | |
| Business and Professional Services; | (a) be no less than the number specified in Table C2.4; and | | |

| Standard | Acceptable Solution | Proposed | Complies? |
|--|--|----------|-----------|
| Community Meeting and Entertainment; | (b) if an existing use or development is extended or intensified, the number of on-site motorcycle parking | | |
| Custodial Facility; | spaces must be based on the proposed extension or intensification, provided the existing number of | | |
| Crematoria and Cemeteries; | motorcycle parking spaces is maintained. | | |
| Educational and Occasional Care; | | | |
| Food Services; | | | |
| General Retail and Hire; | | | |
| Hospital Services; | | | |
| Hotel Industry; | | | |
| Pleasure Boat Facility; | | | |
| Residential if for a communal residence, multiple dwellings or hostel use; | | | |
| Sports and Recreation; and | | | |
| Tourist Operation. | | | |
| C2.5.4 | A1 | | N/A |
| Loading bays | A loading bay must be provided for uses with a floor area of | | |
| This applies to: | more than 1000m ² in a single occupancy. | | |
| Bulky Goods Sales; | | | |
| General Retail and Hire; | | | |
| Manufacturing and Processing; and | | | |
| Storage. | | | |

| Standard | Acceptable Solution | Proposed | Complies? |
|---|--|-------------------|-----------|
| C2.5.5 | A1 | | N/A |
| Number of car parking spaces within the General Residential Zone and Inner Residential Zone | Within existing non-residential buildings in the General Residential Zone and Inner Residential Zone, on-site car parking is not required for: | | |
| This applies to: | (a) Food Services uses up to 100m ² floor area or 30 seats, whichever is the greater; and | | |
| Business and Professional Services; | (b) General Retail and Hire uses up to 100m² floor area, | | |
| Community Meeting and Entertainment; | provided the use complies with the hours of operation specified in the relevant Acceptable Solution for the relevant | | |
| Educational and Occasional Care; | zone. | | |
| Emergency Services; | | | |
| Food Services; | | | |
| General Retail and Hire; | | | |
| Sports and Recreation; and | | | |
| Utilities, if not for minor utilities. | | | |
| | C2.6 Development Standards fo | or Building Works | |
| C2.6.1 | A1 | | N/A |
| Construction of parking areas | All parking, access ways, manoeuvring and circulation spaces must: | | |
| | (a) be constructed with a durable all weather pavement; | | |
| | (b) be drained to the public stormwater system, or contain stormwater on the site; and | | |

| Standard | Acceptable Solution | Proposed | Complies? |
|------------------------------------|---|----------|-----------|
| | (c) excluding all uses in the Rural Zone, Agriculture Zone, Landscape Conservation Zone, Environmental Management Zone, Recreation Zone and Open Space Zone, be surfaced by a spray seal, asphalt, concrete, pavers or equivalent material to restrict abrasion from traffic and minimise entry of water to the pavement. | | |
| C2.6.2 | A1.1 | | |
| Design and layout of parking areas | Parking, access ways, manoeuvring and circulation spaces must either: | | |
| | (a) comply with the following: | | |
| | (i) have a gradient in accordance with Australian Standard AS 2890 - Parking facilities, Parts 1-6; | | |
| | (ii) provide for vehicles to enter and exit the site in a forward direction where providing for more than 4 parking spaces; | | |
| | (iii) have an access width not less than the requirements in Table C2.2; | | |
| | (iv) have car parking space dimensions which satisfy the requirements in Table C2.3; | | |
| | (v) have a combined access and manoeuvring width adjacent to parking spaces not less than the requirements in Table C2.3 where there are 3 or more car parking spaces; | | |
| | (vi) have a vertical clearance of not less than 2.1m above the parking surface level; and | | |

| Standard | Acceptable Solution | Proposed | Complies? |
|---------------------------------|--|--------------------------------|-----------|
| | (vii) excluding a single dwelling, be delineated by line marking or other clear physical means; or | | |
| | (b) comply with Australian Standard AS 2890- Parking facilities, Parts 1-6. | | |
| | A1.2 | | |
| | Parking spaces provided for use by persons with a disability must satisfy the following: | | |
| | (a) be located as close as practicable to the main entry point to the building; | | |
| | (b) be incorporated into the overall car park design; and | | |
| | (c) be designed and constructed in accordance with Australian/New Zealand Standard AS/NZS 2890.6:2009 Parking facilities, Off-street parking for people with disabilities. [S35] | | |
| C2.6.3 | A1 | One access per lot is provided | YES |
| Number of accesses for vehicles | The number of accesses provided for each frontage must: | | |
| verticles | (a) be no more than 1; or | | |
| | (b) no more than the existing number of accesses, | | |
| | whichever is the greater. | | |
| | A2 | | |
| | Within the Central Business Zone or in a pedestrian priority street no new access is provided unless an existing access is removed. | | |

| Standard | Acceptable Solution | Proposed | Complies? |
|--|---|----------|-----------|
| C2.6.4 Lighting of parking areas | A1 In car parks within the General Business Zone and Central | | N/A |
| within the General Business Zone and Central Business Zone | Business Zone, parking and vehicle circulation roads and pedestrian paths serving 5 or more car parking spaces, which are used outside daylight hours, must be provided with lighting in accordance with Clause 3.1 "Basis of Design" and Clause 3.6 "Car Parks" in Australian Standard/New Zealand | | |
| | Standard AS/NZS 1158.3.1:2005 Lighting for roads and public spaces Part 3.1: Pedestrian area (Category P) lighting – Performance and design requirements. | | NI/A |
| C2.6.5 | A1.1 | | N/A |
| Pedestrian access | Uses that require 10 or more car parking spaces must: (a) have a 1m wide footpath that is separated from the access ways or parking aisles, excluding where crossing access ways or parking aisles, by: (i) a horizontal distance of 2.5m between the edge of the footpath and the access way or parking aisle; or (ii) protective devices such as bollards, guard rails or planters between the footpath and the access way or parking aisle; and (b) be signed and line marked at points where pedestrians cross access ways or parking aisles. | | |
| | A1.2 | | |

| Standard | Acceptable Solution | Proposed | Complies? |
|--|--|----------|-----------|
| | In parking areas containing accessible car parking spaces for use by persons with a disability, a footpath having a width not less than 1.5m and a gradient not steeper than 1 in 14 is required from those spaces to the main entry point to the building. | | |
| C2.6.6 | A1 | | N/A |
| Loading bays | The area and dimensions of loading bays and access way areas must be designed in accordance with Australian Standard AS 2890.2–2002, Parking facilities, Part 2: Offstreet commercial vehicle facilities, for the type of vehicles likely to use the site. | | |
| | A2 | | N/A |
| | The type of commercial vehicles likely to use the site must be able to enter, park and exit the site in a forward direction in accordance with Australian Standard AS 2890.2 – 2002, Parking Facilities, Part 2: Parking facilities Offstreet commercial vehicle facilities. | | |
| C2.6.7 | A1 | | N/A |
| Bicycle parking and storage facilities within the General Business Zone and Central Business Zone | Parking and vehicle circulation roadways and pedestrian paths serving 5 or more car parking spaces, used outside daylight hours, must be provided with lighting in accordance with clause 3.1 "Basis of Design" and clause 3.6 "Car Parks" in AS/NZS 1158.3.1:2005 Lighting for roads and public spaces Part 3.1: Pedestrian area (Category P) lighting. | | |
| | A2 | | N/A |
| | Bicycle parking spaces must: | | |
| | (a) have dimensions not less than: | | |

| Standard | Acceptable Solution | Proposed | Complies? |
|-------------------------------------|--|----------|-----------|
| | (i) 1.7m in length; | | |
| | (ii) 1.2m in height; and | | |
| | (iii) 0.7m in width at the handlebars; | | |
| | (b) have unobstructed access with a width of not less than 2m and a gradient not steeper than 5% from a road, cycle path, bicycle lane, shared path or access way; and (c) include a rail or hoop to lock a bicycle that satisfies Australian Standard AS 2890.3-2015 Parking | | |
| | facilities - Part 3: Bicycle parking. | | N/A |
| C2.6.8 | A1 | | IN/A |
| Siting of parking and turning areas | Within an Inner Residential Zone, Village Zone, Urban Mixed Use Zone, Local Business Zone or General Business Zone, parking spaces and vehicle turning areas, including garages or covered parking areas must be located behind the building line of buildings, excluding if a parking area is already provided in front of the building line. | | |
| | A2 | | N/A |
| | Within the Central Business Zone, on-site parking at ground level adjacent to a frontage must: | | |
| | (a) have no new vehicle accesses, unless an existing access is removed; | | |
| | (b) retain an active street frontage; and | | |
| | (c) not result in parked cars being visible from public places in the adjacent roads. | | |
| | C2.7 Parking Precinct | Plan | |

| Standard | Acceptable Solution | Proposed | Complies? |
|-----------------------|--|----------|-----------|
| C2.7.1 | A1 | | N/A |
| Parking Precinct Plan | Within a parking precinct plan, onsite parking must: | | |
| | (a) not be provided; or | | |
| | (b) not be increased above existing parking numbers. | | |

Footnotes

[S35] Requirements for the number of accessible car parking spaces are specified in part D3 of the National Construction Code 2016.

C3 Road and Railway Assets Code

| Standard | Acceptable Solution | Proposed | Complies? | | | |
|--|--|----------|--|--|--|--|
| | C3.5 Use Standards | | | | | |
| C3.5.1 Traffic generation at a vehicle crossing, level crossing or new junction | A1.1 For a category 1 road or a limited access road, vehicular traffic to and from the site will not require: (a) a new junction; (b) a new vehicle crossing; or (c) a new level crossing. A1.2 For a road, excluding a category 1 road or a limited access road, written consent for a new junction, vehicle crossing, or level crossing to serve the use and development has been issued by the road authority. A1.3 For the rail network, written consent for a new private level crossing to serve the use and development has been issued by the rail authority. A1.4 Vehicular traffic to and from the site, using an existing vehicle crossing or private level crossing, will not increase by more than: | | P1 MET A1.2 N/A A1.3 N/A A1.4 N/A A1.5 N/A | | | |

| Standard | Acceptable Solution | Proposed | Complies? |
|--|---|-----------------------|-----------|
| | (a) the amounts in Table C3.1; or (b) allowed by a licence issued under Part IVA of the Roads and Jetties Act 1935 in respect to a limited access road. A1.5 | | |
| | Vehicular traffic must be able to enter and leave a major road in a forward direction. | | |
| | C3.6 Development Standards fo | r Buildings and Works | |
| C3.6.1 | A1 | | N/A |
| Habitable buildings for sensitive uses within a road or railway attenuation area | Unless within a building area on a sealed plan approved under this planning scheme, habitable buildings for a sensitive use within a road or railway attenuation area, must be: | | |
| | (a) within a row of existing habitable buildings for sensitive uses and no closer to the existing or future major road or rail network than the adjoining habitable building; | | |
| | (b) an extension which extends no closer to the existing or future major road or rail network than: | | |
| | (i) the existing habitable building; or | | |
| | (ii) an adjoining habitable building for a sensitive use;(c) located or designed so that external noise levels are not more than the level in Table C3.2 measured in accordance with Part D of the Noise Measurement | | |

| Standard | Acceptable Solution | Proposed | Complies? | | |
|--|--|----------|-----------|--|--|
| C3.7 Development Standards for Subdivision | | | | | |
| C3.7.1 | A1 | | N/A | | |
| Subdivision for sensitive uses within a road or railway attenuation area | A lot, or a lot proposed in a plan of subdivision, intended for a sensitive use must have a building area for the sensitive use that is not within a road or railway attenuation area. | | | | |

DEVELOPMENT APPLICATIONS

TRAFFIC ENGINEER REFERRAL

| DA No:. | PLN-24-129 | Date Referred: | 1/08/2024 |
|--------------------------|-------------|----------------------------|---------------|
| Development Engineer: | | Date Returned: | 8/08/2024 |
| Traffic Engineer: | Emily Burch | Property File No: | 5297675 |
| Standard: | | Discretionary Permitted | Discretionary |

| Details of Application: | Applicant's Name: | PDA Surveyors Engineering and Planners |
|-------------------------|-------------------------|--|
| | Business Contact Name: | Jane Monks |
| | Contact Email: | jane.monks@pda.com.au |
| | Address of Development: | 15 Karambi Street Chigwell |
| | Proposal in Detail: | Subdivision (61 Lots plus balance) |

Comments:

Introduction

The developer proposes to construct a 61-lot subdivision with the main road linking Boondar Street to Branscombe Road. The main road will have three road off it, all ending in cul-de-sacs. One of the roads forms a T-junction with the main road. The other two roads meet at a roundabout on the main road.

The assessment below is based on the Traffic Impact Assessment (TIA) undertaken by Hubble Traffic, dated February 2025. The TIA addresses the performance criteria C3.5.1 P1 due to the increase in traffic generated by the proposed subdivision.

Traffic Generation

The traffic generated by the development is expected to be 451 daily trips with 48 trips in am and pm peak hour as per the Roads and Maritime Services, Road Traffic Authority (RTA) NSW Guide to Traffic Generation Development for a residential dwelling.

Traffic generated by the development could either travel south onto Boondar Street or north onto Branscombe Road. It is assumed in the TIA that traffic from the subdivision would travel onto Boondar Street which connects onto Allunga Road via a roundabout and then drivers would continue onto the Brooker Highway. This assumption is made as the distance from the subdivision is shorter via Boondar Street with better traffic conditions.

As the subdivision will create a connecting road between Boondar Street to Branscombe Road, the TIA has assumed that 20% of traffic currently heading north on Branscombe Road onto Box Hill Road, will use the new connection. This assumption is made as the distance to the Brooker Highway is less for most of the traffic on Branscombe Road at the junction with Box Hill Road.

Additionally, the subdivision proposes to put in traffic calming slow points along with the roundabout, to deter through traffic. The existing Branscombe Road from the proposed subdivision to Box Hill Road already has traffic calming in place with kerb outstands and has undulating horizontal alignment.

The TIA undertook surveys of the current traffic at the intersections of Allunga Road / Boondar Street and Branscombe Road / Box Hill Road.

At the junction with Box Hill Road the peak traffic was approximately 150 vehicles in the morning and 180 vehicles in the afternoon on Branscombe Road. The traffic volume on Branscombe Road is below that for a local residential street, which can carry a maximum peak of 300 vehicles. Traffic is not expected to increase at the junction of Branscombe Road / Box Hill Road. However, if it did the survey data shows that there is capacity in the network for this to occur.

At the roundabout of Allunga Road / Boondar Street the current peak traffic is shown below in the tables, along with the increase in traffic from the subdivision and 20% increase in traffic from Branscombe Road.

Table 1 – Traffic Data Morning Peak Hour

| Road | Existing | Subdivision | 20% Increase | Total | |
|-------------------------|----------|-------------|--------------|-------|--|
| Branscombe Road (south) | 72 | 0 | 27 | 99 | |
| Boondar Street | 49 | 48 | 27 | 124 | |
| Allunga Road (north) | 257 | 15 | 8 | 280 | |
| Allunga Road (south) | 276 | 33 | 19 | 327 | |

Table 2 - Traffic Data Afternoon Peak Hour

| Road | Existing | Subdivision | 20% Increase | Total |
|-------------------------|----------|-------------|--------------|-------|
| Branscombe Road (south) | 77 | 0 | 36 | 113 |
| Boondar Street | 85 | 48 | 36 | 169 |
| Allunga Road (north) | 337 | 14 | 10 | 361 |
| Allunga Road (south) | 368 | 34 | 26 | 428 |

The increase in traffic on Branscombe Road and Boondar Street is below that for a local residential street, which can be a maximum peak of 300 vehicles. The increase in traffic for Allunga Road is below that for a collector road, which can be a maximum peak of 500 vehicles. Based on this the increase in traffic is not expected to have an unreasonable impact.

The TIA undertook SIDRA traffic modelling at the roundabout of Allunga Road / Boondar Street. The modelling showed that the roundabout operates at the highest level of service now and into the future with the construction of the subdivision. The subdivision is not expected to cause any adverse traffic impacts at the roundabout or the wider network.

Subdivision Roads and Footpaths

The subdivision will connect into Boondar Street which is 8.5m wide and Branscombe Road which varies in width between 10.4m and 8m wide due to the kerb extensions along the road. Both streets have a posted speed limit of 50km/h and so will the subdivision.

The developer proposes a road width of between 8.5m to 8.9m for the main access road. The standard road width for a local through road is 8.9m. However, 8.5m road width is acceptable if geometry allows to reduce through traffic via narrowing the road. This road narrowing is also proposed by the installation of three single lane slow points along the road.

Single lane slow point devices are suitable for lightly trafficked urban residential roads to moderate vehicles speeds and deter through traffic. They operate similarly to when vehicles are parked opposite each other, reducing the road to a single traffic lane, requiring a driver to give way to an oncoming vehicle.

The developer has proposed that the exact location of the slow points is undertaken once the road is constructed, to ensure there is adequate sight distance and minimal impact on properties. Council is of the view, that the slow points need to be designed as part of the detailed engineering design drawings prior to the construction of the road, to ensure that they can and will be undertaken. Thus, this will be conditioned on the permit.

The access roads of the main through road, are proposed to be 6.9m wide which is acceptable for a short local cul-de-sac road. The access roads all end in cul-de-sac with the one to the existing property being a T type cul-de-sac. This is to allow for a future subdivision road of the remaining lot.

The subdivision has footpaths on both sides of the road along the main through road but only a footpath on one side of the road for the three local roads. There is adequate space for a footpath on both sides of the local roads and the permit will be conditioned as such.

Connection to Boondar Street and Branscombe Road

Boondar Street has two existing roads that connect onto it prior to Allunga Road being Coach Road and Arunta Crescent. At these connections both Coach Road and Arunta Crescent meet the safe intersection sight distance (SISD) of 90m. This allows a driver to pick a gap in the traffic to turn out of side road without the vehicles on the main road adjusting their speed.

Branscombe Road between the subdivision and Box Hill Road has five junctions. The TIA details that due to the topography of the road including vertical sags and crest curves, driver sight lines are below the SISD of 90m for four of the five junctions. Sight distances are for a speed of 50km/h which is the posted speed limit in the street.

For lightly trafficked junctions, a lower sight distance parameter can be suitable, being Approach Sight Distance (ASD) of 62m. ASD means as a side vehicle turns out onto the major road, the vehicle on the major road may need to adjust their speed. With Branscombe Road being lightly trafficked, the potential for the vehicle needing to adjust their speed is low. The lowest sight distance parameter is Stopping Sight Distance (SSD) of 42m and must be available at junctions.

The sight distance was assessed in the TIA and shown below in the table. The sight distance at all junctions met the required ASD of 62m. It is also noted that the crash data was reviewed in the TIA, in which there have been no crashes in the past five years reported to the Police.

Table 3 – Branscombe Road Existing Sight Distances

| Side Road | Sight distance to | Sight distance to | | |
|-----------------|--------------------|-------------------|--|--|
| | the right (metres) | the left (metres) | | |
| Lesdelle Street | 73 | 90 | | |
| Forsythe Court | 100 | 100 | | |
| Rosanna Court | 66 | 90 | | |
| Bluegum Court | 68 | 100 | | |
| Ironbark Drive | 90 | 70 | | |

Although the road connection has the potential to slightly intensify the traffic flow, ASD is met. Thus, no adverse safety impact is expected, with vehicles able to turn at the junction in a safe and efficient manner. Additionally, slow point devices on the new road connection are expected to limit the intensification of traffic on Branscombe Road.

CONCLUSION

Based on the TIA, the proposed development is not expected to have any unreasonable detrimental impacts on the surrounding road network in terms of traffic efficiency or road safety and satisfies the preference criteria for C3.5.1 P1. I have no objection to the development on traffic engineering or road safety grounds.

Condition to be included in the development engineer's referral (otherwise in mine):

The developer shall undertake engineering design drawings, which include three slow points and a road width of between 8.5m and 8.9m on the main through road, along with footpaths on both sides of all the roads. The engineering drawings must be submitted to Council, to the satisfaction of the Director of Infrastructure and Works. The works shall be installed as per the engineering drawings by the developer prior to tiles being issued.

Emily Burch
Senior Transport Engineer

DEVELOPMENT APPLICATIONS

HYDRAULICS DEPARTMENT REFERRAL

| DA No:. | PLN-24-129 | Date Referred: | 27 March 2025 |
|--------------------------|---|----------------------------|---------------|
| Development Engineer: | Lyndal Byrne/ David Morley (Arete Engineering) | To Be Returned By: | 3/04/2025 |
| Hydraulics Engineer: | Dan Egodawatte | Property File No: | 5297675 |
| Standard: | | Discretionary Permitted | Discretionary |

| Details of Application: | Applicant's Name: | PDA Surveyors Engineers and Planners |
|-------------------------|-------------------------|--------------------------------------|
| | Business Contact Name: | Jane Monks |
| | Contact Email: | jane.monks@pda.com.au |
| | Address of Development: | 15 Karambi Street Chigwell |
| | Proposal in Detail: | Subdivision (61 Lots plus balance) |

Comments

The proposed development includes a 61-lot subdivision for the General Residential zone at 15 Karambi Street, Chigwell. Subdivision also includes extending Branscombe Road to Boondar Street, providing a link and associated stormwater and transport public infrastructure as part of it.

1. Referenced Documents

- Subdivision plans set from 1K to 6K by PDA Surveyors, revision K, dated 10.07.2025,
- b. Concept Engineering plans by PDA surveyors, Revision P4, dated 30.05.2025
- c. Stormwater report by PDA Surveyors, Revision 1 dated 23 May 2025.

2. Stormwater Management Policy (for consent under Section 14 Urban Drainage Act)

a. Stormwater Disposal Method Requirements:

All stormwater generated from the development will drain to stormwater systems by gravity. Therefore, 4 (a) is met.

b. Stormwater Quality Management Requirements:

The stormwater system will incorporate water sensitive urban design principles (WSUD) for the treatment and disposal of stormwater given the new impervious area generated by the development is greater than 500m2. Proposed stormwater treatment train will include a proprietary Gross Pollutant Trap (GPT, model Ocean Protect Cascade CS1500) followed by a Proprietary Filter cartridge system (5 x PSorb cartridge StormFilter system by Ocean Protect) installed inside the underground detention tank.

Therefore, 5 (b) is met.

c. Stormwater Quantity Management Requirements:

The development incorporates a centralised underground on-site detention system to manage the post developed flow rates to pre-developed levels for this subdivision for a 5% AEP rain event. A total storage volume of 150 cubic metres is provided by way of a dedicated underground detention tank (120 cum.) and partial storage from large sized stormwater pipes (33 cum.)

Therefore, 6(a) is met.

d. Stormwater System Design Requirements:

The Minor Stormwater System has been designed for 5% AEP rain event. The major stormwater system including overland flow paths have been designed to cater a 1% AEP rain event with a climate change allowance for climate scenario SSP5-8.5 for 2100 as outlined in Stormwater Report by PDA.

Therefore 3 (a) and (b) are met.

C12.0 Flood-Prone Areas Hazard Code

Flood Hazard Report has been incorporated into the Stormwater Report prepared by PDA, revision 1 dated 23 May 2025. The report demonstrates that the development can meet the acceptable solution under C12.7.1 Subdivision within a flood-prone hazard area and performance criteria under C12.6.1. Building and works within a flood prone area.

Objectives of the above two criteria is to demonstrate whether the proposed development and the use can achieve and maintain a tolerable risk during a 1% AEP flood event with provision for the climate change scenario, notably SSP5-8.5 for year 2100 (Worst Case) as outlined in Australian Rainfall and Runoff Guide (ARR Guidelines) version 4.2.

Flood report by PDA and the subsequent concept engineering plans demonstrates that each lot is able to contain a building area, vehicle access, and services, that are wholly located outside a flood-prone hazard area and thus satisfy Acceptable Solution for C12.7.1 Subdivision within a flood-prone hazard area.

The Stormwater Report by PDA includes a comprehensive assessment of stormwater runoff and overland flow paths for a 1% AEP event including a climate change allowance for a scenario of SSP5-8.5 for year 2100 (Worst Case) as outlined in Australian Rainfall and Runoff Guide (ARR Guidelines) version 4.2. Existing overland flow paths are identified to be low- hazard category as per Council's 1% AEP flood maps.

Overland flows are expected to be conveyed with roadway associated infrastructure (Kerb and gutter and Side Entry pits feeding into underground pipe system) with a low hazard risk. Existing overland flow path to the north of subdivision will be re-directed to the battle axe turning head to follow the new roadway. This overland flow path will continue towards proposed Cul-de-Sac that will run along lot 20 towards the watercourse. While the infrastructure has been designed with additional capacity in this location and downstream, a condition will be added to the permit to extend current partial drainage easement along western boundary of lot 20 all the way towards the watercourse. Thus, it satisfies the performance criteria under C12.6.1. Building and works within a flood prone area.



Figure 1 Existing flood hazard extents as per Council's 1% AEP mapping. Existing low hazard overland flow path will be directed toward the battle axe end of the new roadway infrastructure.

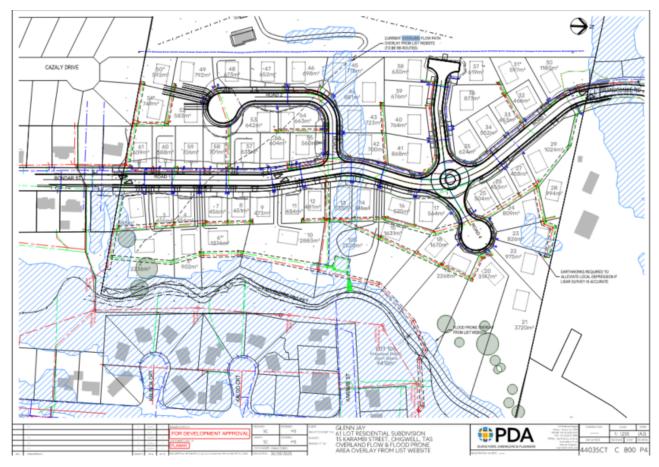


Figure 2 Post Development lot layout over existing Flood Hazard Code overlay

Conclusion

In summary, I have no objections with the proposal from a hydraulics perspective, provided the following conditions are met:

Proposed Engineering Conditions for the planning permit

- 1. Engineering design drawings must be submitted and approved, prior to the construction or the issue of Building/Pluming Permit, whichever occurs first. The engineering drawings must:
 - a) be certified by a qualified and experienced Engineer;
 - b) Clearly distinguish between public and private infrastructure;
 - c) Include provision for future development within the catchment to be adequately and efficiently serviced, i.e., via appropriate easements;
 - d) Show the final Lot boundaries, with each Lot serviced separately by Council infrastructure and all private plumbing contained within each lot;
 - e) Specify lot connection sizes, depths, and locations such that as much as practicable of the lots can be drained via gravity;
 - f) Show any existing connections. Any redundant connections must be sealed by the Council at the owner's expense prior to sealing of the final plan;
 - g) show in both plan and long-section the proposed stormwater mains, including but not limited to, connections, flows, velocities, hydraulic grade lines, clearances, cover, gradients, sizing, material, pipe class, adequate working platforms around manholes, easements, and inspection openings;
 - h) Provide details of the cutoff drain extension as suggested in concept engineering plans by PDA Revision P4, dated 30.05.2025. It should include drain geometry with a minimum 200mm freeboard and suitable batter treatment/lining to safely convey overland flows;

- i) Provide details of the proposed On-site detention device (OSD) including inlet, outlet, orifice control, overflow mechanism and access points for maintenance;
- j) Provide details of the proposed Stormwater quality treatment devices including inlet, outlet, orifice control, overflow mechanism/ hy flow bypass and access points and path for maintenance. A safe grass decanting area must be provided near the proposed infrastructure that is at least 30m away from the watercourse;
- k) Be substantially in accordance with the LGAT Standard Drawings and Tasmanian Subdivision Guidelines 2013.

All work required by this condition must be undertaken in accordance with the approved engineered drawings.

- 2. Extend the proposed partial 'PIPELINE AND SERVICES & DRAINAGE EASEMENT' within lot 20 all the way to the watercourse along the shared boundary with lot 19. The proposed low point of the cul-de-sac should be designed to ensure that any upwelling or surcharge of runoff on the roadway can be effectively directed into the drainage easement of Lot 20.
- 3. The new stormwater infrastructure must be constructed prior to the sealing of the final plan / issue of a final certificate.
- 4. Digital copies of a post construction work CCTV video and associated report(s) of any proposed Council stormwater main must be submitted to the satisfaction of Council after completion of all work but prior to the issue of any Certificate of Completion.
- 5. Prior to the commencement of the use or development, a new stormwater connection, equivalent to a 150mm diameter pipe, unless specified otherwise in the approved plans, must be installed from the property boundary to Council's public stormwater. The detailed design of the connection must comply with the LGAT drawing and be submitted for approval prior to the issuing of the building permit or the commencement of works (whichever occurs first). Any existing stormwater connections that are abandoned must be decommissioned and sealed at the owner's expense.
- 6. The stormwater connection(s) must be constructed by a suitably qualified person, inspected by Council's Plumbing Surveyor, and completed to the satisfaction of Council. The applicant must notify the relevant Council officer for an inspection prior to backfilling.

Advice: If the stormwater connection works are not left exposed for inspection, Council may require the Applicant to undertake a CCTV inspection at the Applicant's cost. A digital copy of the CCTV inspection video, along with the associated report(s), must be submitted to Council prior to the issuance of any Certificate of Completion.

Proposed Conditions for the General Manager's consent under Section 14 of Urban Drainage Act 2013

- 1. The new stormwater infrastructure must be constructed prior to the sealing of the final plan / issue of a completion certificate.
- 2. An adequate overland flow path must be maintained through the site during construction and post development, such that flows are excluded from the structures, and not redirected onto

third-party land, for the 1% AEP as at 2100 (including climate change loading) storm event as outlined in Stormwater report by PDA Surveyors; Revision 1 dated 23 May 2025.

- 3. The development must incorporate the On-Site Detention (OSD) as part of the development as presented in the Concept Stormwater Management Plan dated 02.08.2022 and Concept Engineering Plans dated 09.11.2022. The onsite piped detention element and its associated components must be designed and constructed to the satisfaction of the Council's Senior Civil Engineer and completed prior to the sealing of the Final Plan / issue of a Completion Certificate.
- 4. The development must incorporate the Water Sensitive Urban Design (WSUD) as part of the development as presented in the Stormwater report by PDA Surveyors; Revision 1 dated 23 May 2025. The WSUD components must be designed and constructed to the satisfaction of the Council's Senior Civil Engineer and completed prior to the sealing of the Final Plan / issue of a Completion Certificate.
- 5. In association with a plumbing Application, Maintenance Schemes for WSUD and OSD elements must be submitted for approval, to the satisfaction of Council's Senior Civil Engineer, defining the maintenance method and frequency, cleanout procedures, descriptions and diagrams of how the installed systems operate and details of the life of assets and replacement requirements. The applicant must ensure ongoing compliance with the approved WSUD Maintenance Scheme for the defects' liability/maintenance period.

APPENDIX

C12.0 Flood-Prone Areas Hazard Code

| Standard | Acceptable Solution | Proposed | Complies? | | |
|---|---|---|---|--|--|
| C12.5 Use Standards | | | | | |
| C12.5.1 Uses within a flood-prone hazard area | A1 No Acceptable Solution. | NA | | | |
| C12.5.2 Critical use, hazardous use or vulnerable use | A1 No Acceptable Solution. | NA | | | |
| use of vullerable use | A2 No Acceptable Solution. | NA | | | |
| | A3 No Acceptable Solution. | NA | | | |
| | A4 No Acceptable Solution. | NA | | | |
| | C12.6 Development Standards | for Buildings and Works | | | |
| C12.6.1 Buildings and works within a flood-prone hazard area | A1 No Acceptable Solution. | Proposed works are within a flood- prone area. Performance criteria addressed by a Flood Hazard Report with comprehensive assessment and design of infrastructure to safely convey the runoff. | No Refer to Hydraulic referral for discussion on performance criteria | | |
| | C12.7 Development Standa | ards for Subdivision | | | |
| C12.7.1 Subdivision within a flood-prone hazard area | A1 Each lot, or a lot proposed in a plan of subdivision, within a flood-prone hazard area, must: (a) be able to contain a building area, vehicle access, and services, that are wholly located outside a flood-prone hazard area; (b) be for the creation of separate lots for existing buildings; | Acceptable solution met under A1 (a) and demonstrated in the concept engineering plans. | Yes | | |
| | existing buildings; (c) be required for public use by the Crown, a council or a State authority; or (d) be required for the provision of Utilities. | | | | |

DEVELOPMENT APPLICATIONS

WASTE MANAGEMENT REFERRAL

DA No:. PLN-24-129 **Date Referred:** 1/08/2024

Planner: Lyndal Byrne To Be Returned By: 08/08/2024

Waste Gaye Hunt Date Returned: 19/08/24

Management Rep:

Property File No: 5297675 Discretionary Permitted Discretionary

Details of Applicant's Name: PDA Surveyors Engineering and Planners

Application:

Business Contact Name: Jane Monks

Contact Email: jane.monks@pda.com.au

Address of 15 Karambi Street Chigwell

Development:

Proposal In Detail: Subdivision (61 Lots plus balance)

Comments:

Waste services to the proposed subdivision ay 15 Karambi St Chigwell would be Council's standard bin service collected fortnightly.

- Council's Standard Bin Service includes one (1) x 140L wheelie bin for Waste, one (1) x 240L wheelie bin for Recycling, and one (1) x 240L for FOGO wheelie bin to each of the lots, collected fortnightly.
- For new subdivisions the footpath must be designed and constructed to accommodate the placement of bins on both sides of the road. Footpath width to each lot to meet the minimum accessible footpath width (1.5 metre) and need to comply with Councils Footpath Policy.
- For new properties and subdivisions all new road construction must ensure that continuous forward movement for waste service vehicles is available.
- Road pavements in the proposed subdivision are to be designed and constructed to accommodate medium/heavy rigid service vehicles.
- Turning heads of cul-de-sacs shall be a minimum of 18 metre diameter inside the kerb to allow for the continuous forward movement of a medium/heavy rigid service

vehicles (tandem 22.5 Tone capacity) and include access for the lifting arm in an area

without any overhead obstructions. Hammer Head cul-de-sacs are not recommended

for turning of waste contractor service vehicles as continuous forward moment cannot

be achieved.

In an area with an overhead obstruction such as a tree canopy a minimum height of 5.0

metres needs to be allowed for contractor's collection vehicle including access to the

lifting arm.

Wheelie bins need to be placed at least 1 meter from light/power poles, bus stops,

trees.

Council's Waste Services Contractor service vehicles will not enter any properties to

collect and empty fortnightly servicing of wheelie bins. All bins are to be placed on the

kerbside for collection. Bins need to be positioned in a single line at the kerbside.

Evan Brown

Waste Services Coordinator

Document Set ID: 3517099