

DEVELOPMENT APPLICATION

APPLICATION NUMBER: PLN-25-247

PROPOSED DEVELOPMENT: New dwelling & demolition of existing

LOCATION: 33 Pitcairn Street Glenorchy

APPLICANT: SJM Property Developments

ADVERTISING START DATE: 21/10/2025

ADVERTISING EXPIRY DATE: 5/11/2025

Plans and documentation are available for inspection at Council's Offices, located at 374 Main Road, Glenorchy between 8.30 am and 5.00 pm, Monday to Friday (excluding public holidays) and the plans are available on Glenorchy City Council's website (www.gcc.tas.gov.au) until 5/11/2025.

During this time, any person may make representations relating to the applications by letter addressed to the Chief Executive Officer, Glenorchy City Council, PO Box 103, Glenorchy 7010 or by email to gccmail@gcc.tas.gov.au.

Representations must be received by no later than 11.59 pm on **5/11/2025**, or for postal and hand delivered representations, by 5.00 pm on **5/11/2025**.

11 - Public Documents\CAD Library\Civil\C000

| DRAWING INDEX | | | | | |
|--|------------------------------------|---|--|--|--|
| DRAWING No. REVISION DRAWING TITLE | | | | | |
| C000 | Α | TITLE PAGE | | | |
| C100 A DRIVEWAY NOTES AND LEGENDS | | | | | |
| C101 | Α | DRIVEWAY SETOUT PLAN | | | |
| C130 | Α | VEHICLE MOVEMENT DIAGRAM - B85 | | | |
| C135 | C135 A VEHICLE MOVEMENT PLAN - B85 | | | | |
| C255 | Α | CONSTRUCTION DETAILS - RESIDENTIAL DRIVEWAY | | | |

SJM PROPERTY DEVELOPMENTS PROPOSED DWELLING

33 PITCAIRN STREET, GLENORCHY 7010

GENERAL NOTES

- SURVEY DATA COMPLETED AND PROVIDED BY LEARY COX & CRIPPS LAND & ENGINEERING SURVEYORS, DATED 24/07/2025, REFERENCE No. 14534.
- 2. HORIZONTAL DATUM GDA2020, VERTICAL DATUM AHD83, CONTOUR INTERVALS AT 0.2m.
- 3. TITLE BOUNDARY AS PER SURVEYOR'S PLAN.
- 4. LOCATION OF EXISTING SERVICES AS PER SURVEY DATA, LIST DATA & BYDA DOCUMENTATION DATED 10/10/2025 UNLESS NOTED OTHERWISE.

| Α | FOR PLANNING APPROVAL | S.M. | M.H. | 13/10/2025 |
|-----|-----------------------|------|------|------------|
| REV | DESCRIPTION | BY | CHK | DATE |

SCIENCE IN DESIGN
121 Sandy Bay Road, Sandy Bay TAS 7005
Phone (03) 6240 9911 www.jsa.com.au

| M. HORSHAM CC5865 I | AS SHOWN | A3 | PR |
|--|------------------------------|----|----|
| CIVIL ENGINEER/DESIGNER S. MARTININGUI | HYDRAULIC ENGINEER R. HORNER | | |
| STATUS PLANNING | APPROVAL | | |

SJM PROPERTY DEVELOPMENTS
PROPOSED DWELLING
33 PITCAIRN STREET, GLENORCHY 7010

TITLE PAGE

DJECT NO COOO REV A


GLENORCHY CITY COUNCIL PLANNING SERVICES


APPLICATION No.: PLN-25-247


DATE RECEIVED: 14/10/2025

Document Set ID: 3546880


Version: 1, Version Date: 16/10/2025

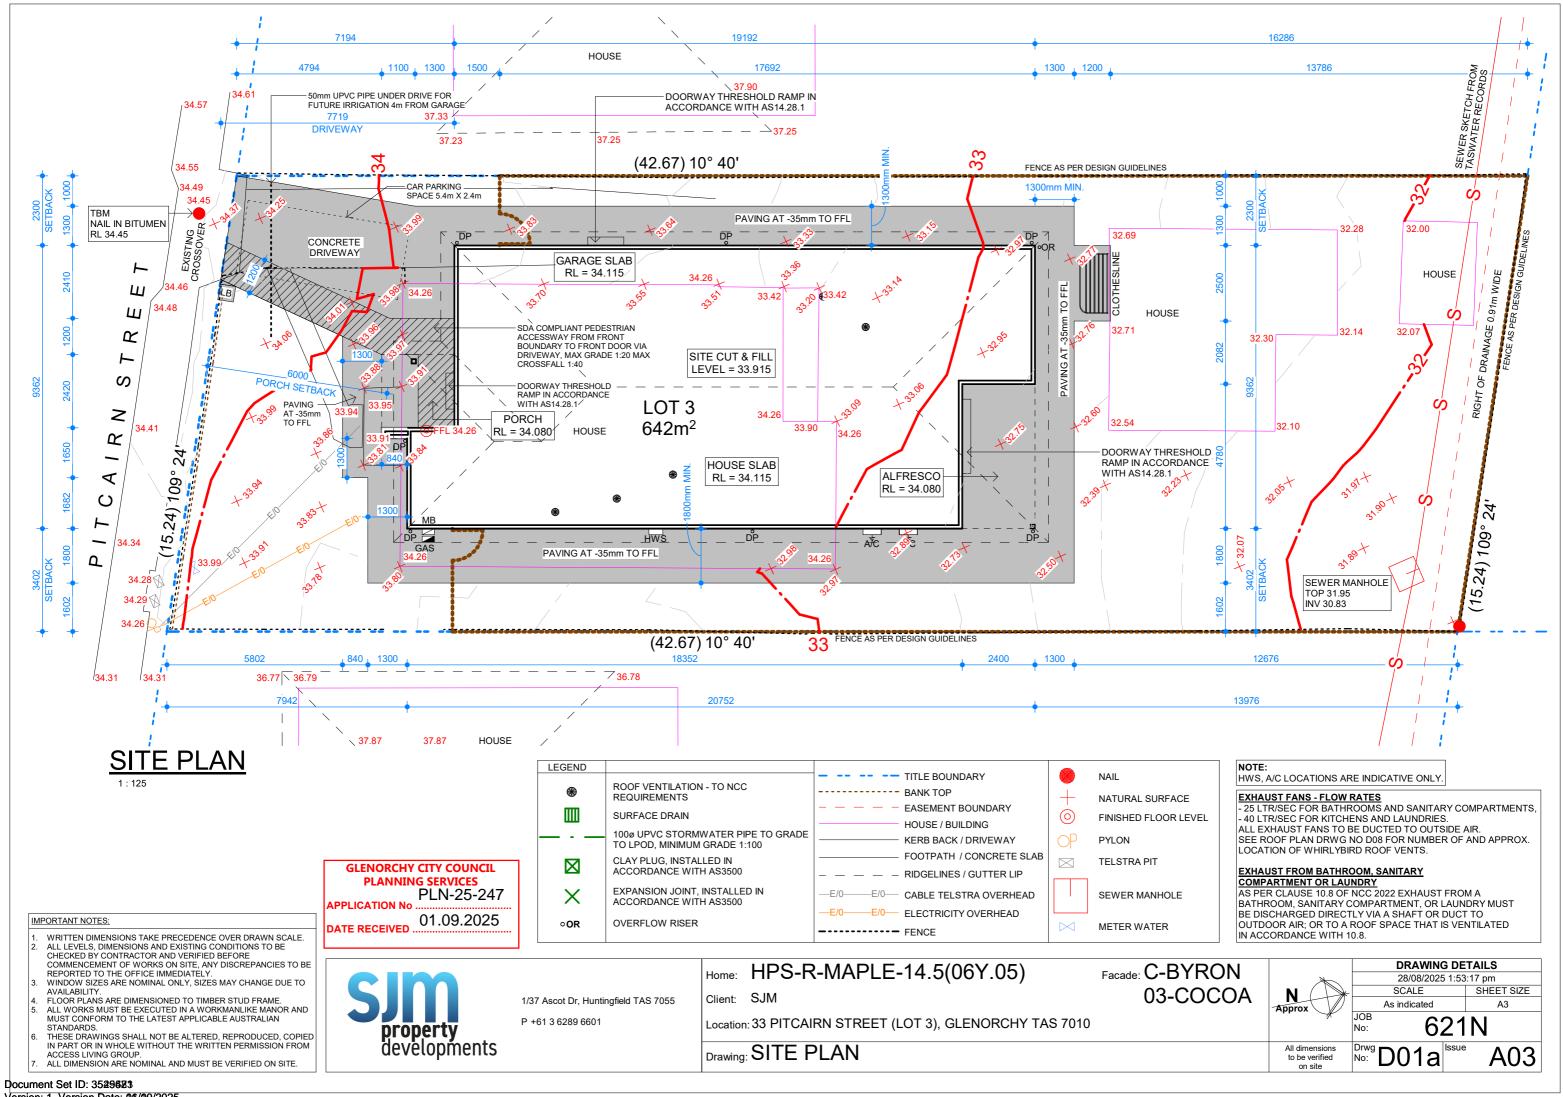

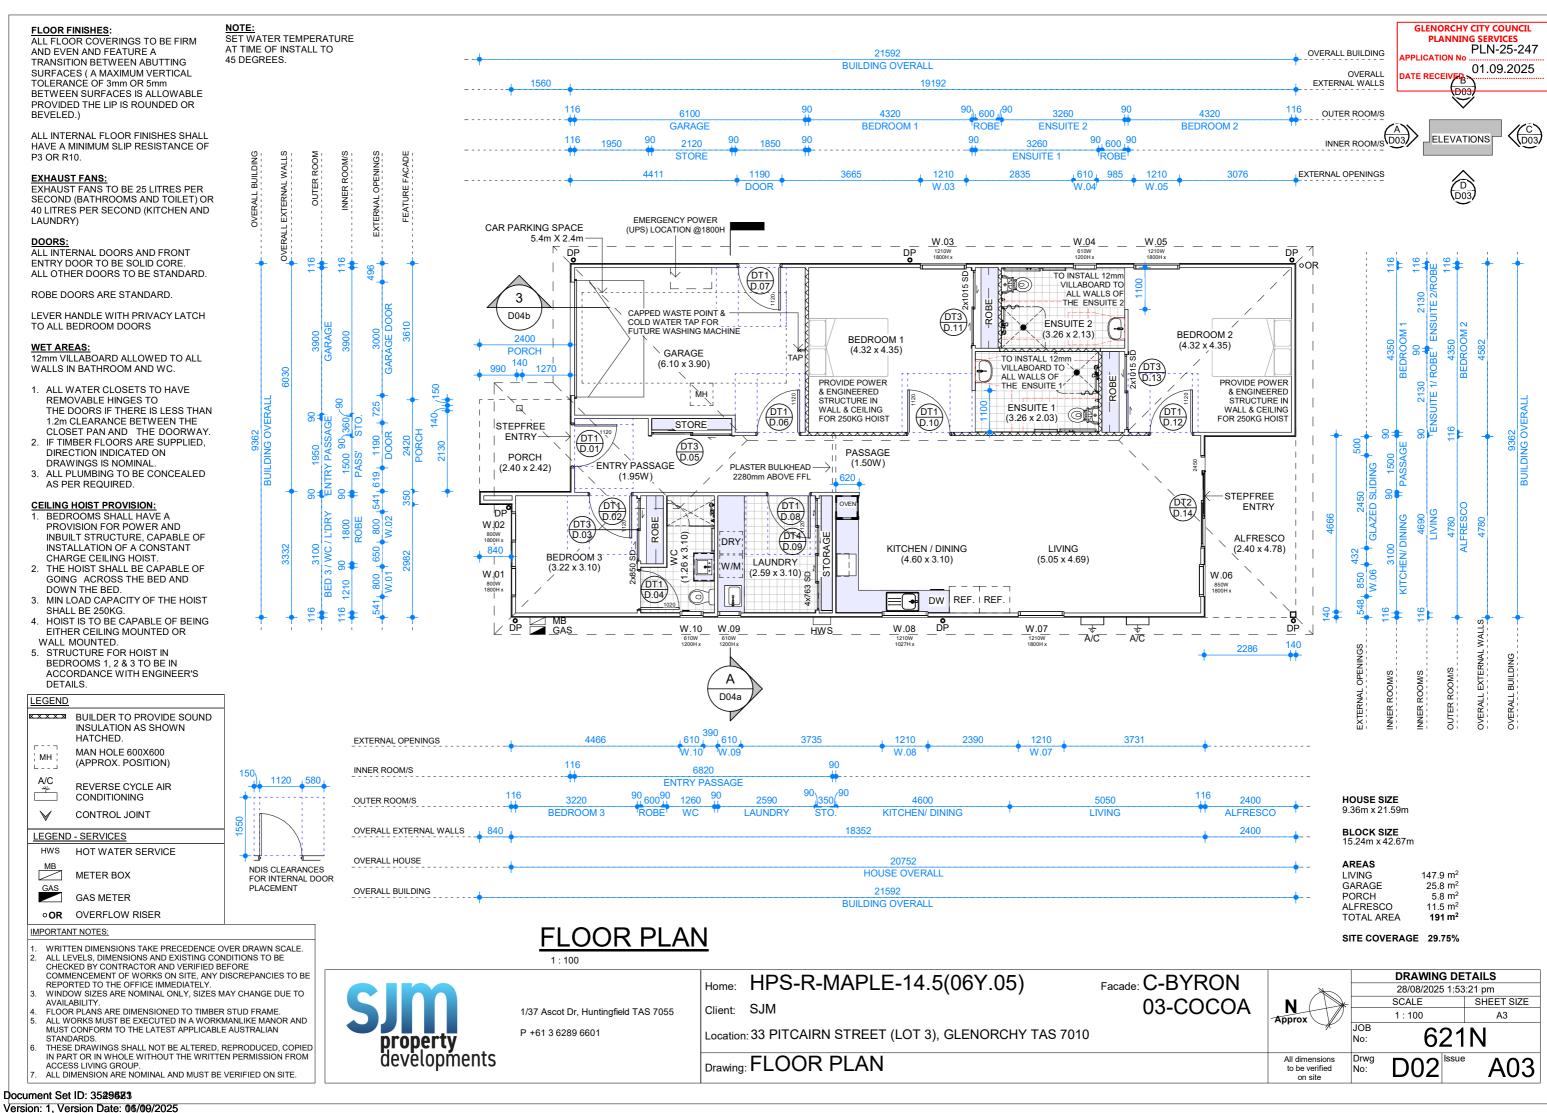

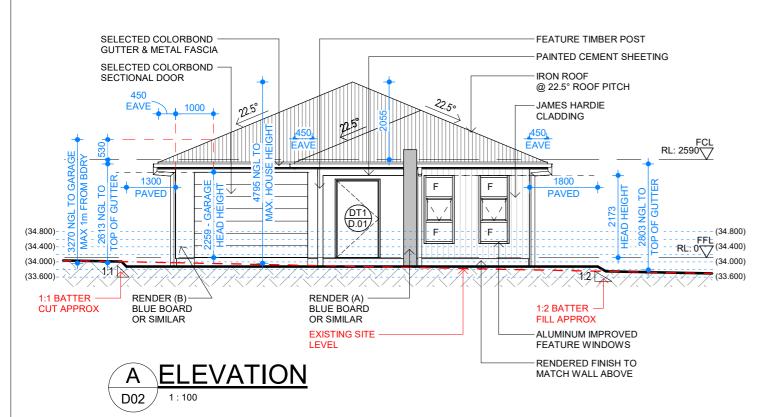

| GARAGE ROOF HEIGHT AT BOUNDARY | | |
|---|--------|----------------|
| CEILING TO ROOF AT BOUNDARY | 70 | mm |
| CEILING HEIGHT OF HOUSE | 2,590 | mm |
| GARAGE SETDOWN | 0 | mm |
| RL OF GARAGE SLAB | 34,115 | mm |
| HIGHEST NGL RL OF GARAGE AT BOUNDARY | 33,980 | mm |
| LOWEST NGL RL OF GARAGE AT BOUDNARY | 33,950 | mm |
| AVERAGE NGL RL OF GARAGE AT BOUNDARY | 33,965 | mm |
| AVERAGE GARAGE HEIGHT AT BOUNDARY FROM NGL | 2,810 | mm |
| MAXIMUM GARAGE HEIGHT AT BOUNDARY FROM NGL | 2,825 | mm |
| ROOF RISE OVER 1m= 370mm (22.5°) | 530 | mm |
| GARAGE HT 1m IN FROM BOUNDARY FROM NGL | 3,270 | mm |
| HOUSE MAX HEIGHT | | |
| CEILING LEVEL TO THE HIGHEST POINT | 2,055 | mm |
| MAX HEIGHT OF HOUSE FROM NGL | 4,795 | mm |
| PORCH MAX HEIGHT | | 3 |
| CEILING LEVEL TO THE HIGHEST POINT AT 6.0m SETBACK LINE | 264 | mm |
| NGL AT FORWARD MOST POINT (AT 6.0m SETBACK LINE) | 33,860 | mm |
| MAX HEIGHT OF PORCH FROM NGL | 3,109 | mm |
| LOT AREAS | | |
| TOTAL SITE AREA | 642.00 | m ² |
| PERMITTED BUILDING AREA | 385.20 | m ² |
| TOTAL BUILDING AREA | 191.00 | m ² |
| TOTAL NON-PERMEABLE AREA - DRIVEWAY AND CONCRETE PATHS | 126.8 | m ² |
| TOTAL PERMEABLE AREA | 324.2 | m ² |

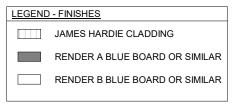

LEGEND - SERVICES HOT WATER SERVICE METER BOX **GAS METER**

NOTE: NATURAL GROUND LEVELS ARE SHOWN INDICATIVELY ONLY.

| AVERAGE GARAGE WALL HEIGHT | | | |
|-------------------------------|---------------------|--|--|
| WALL LENGTH: | 6.33m | | |
| WALL AREA: | 17.79m ² | | |
| AVERAGE WALL HEIGHT: | 2.81m | | |


GLENORCHY CITY COUNCIL PLANNING SERVICES PLN-25-247 01.09.2025

A3

A03

621N

All dimensions

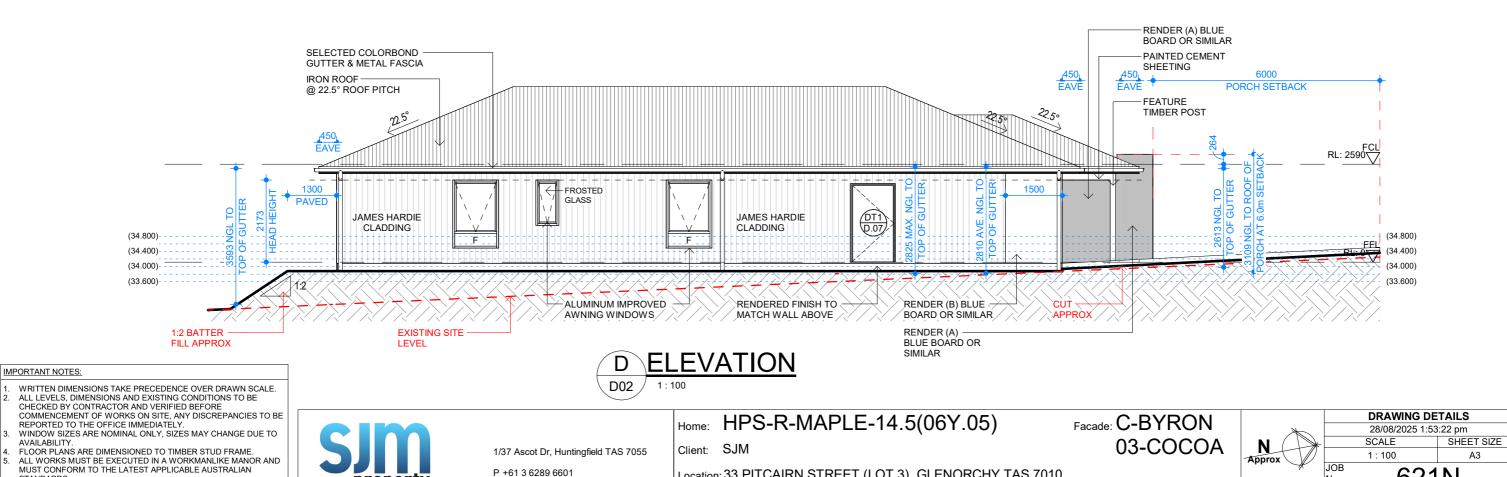

Location: 33 PITCAIRN STREET (LOT 3), GLENORCHY TAS 7010


Drawing: ELEVATIONS A & B

P +61 3 6289 6601

property developments

THESE DRAWINGS SHALL NOT BE ALTERED, REPRODUCED, COPIED IN PART OR IN WHOLE WITHOUT THE WRITTEN PERMISSION FROM ACCESS LIVING GROUP.

ALL DIMENSION ARE NOMINAL AND MUST BE VERIFIED ON SITE.

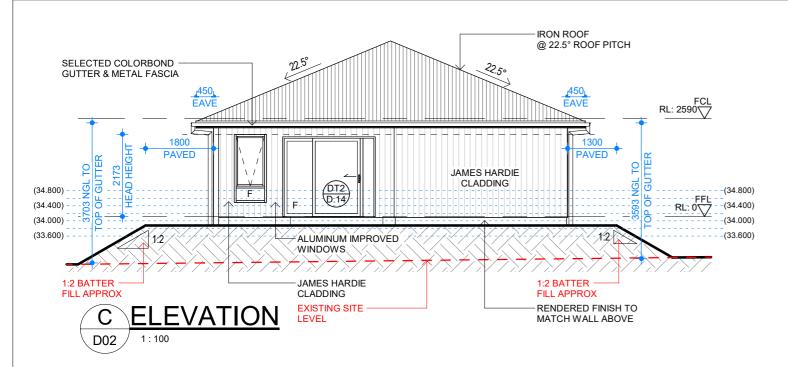

| OT 3 GARAGE & HOUSE HEIGHTS & AREAS | | |
|---|--------|----------------|
| GARAGE ROOF HEIGHT AT BOUNDARY | | |
| CEILING TO ROOF AT BOUNDARY | 70 | mm |
| CEILING HEIGHT OF HOUSE | 2,590 | mm |
| GARAGE SETDOWN | 0 | mm |
| RL OF GARAGE SLAB | 34,115 | mm |
| HIGHEST NGL RL OF GARAGE AT BOUNDARY | 33,980 | mm |
| LOWEST NGL RL OF GARAGE AT BOUDNARY | 33,950 | mm |
| AVERAGE NGL RL OF GARAGE AT BOUNDARY | 33,965 | mm |
| AVERAGE GARAGE HEIGHT AT BOUNDARY FROM NGL | 2,810 | mm |
| MAXIMUM GARAGE HEIGHT AT BOUNDARY FROM NGL | 2,825 | mm |
| ROOF RISE OVER 1m= 370mm (22.5°) | 530 | mm |
| GARAGE HT 1m IN FROM BOUNDARY FROM NGL | 3,270 | mm |
| HOUSE MAX HEIGHT | | - 1 |
| CEILING LEVEL TO THE HIGHEST POINT | 2,055 | mm |
| MAX HEIGHT OF HOUSE FROM NGL | 4,795 | mm |
| PORCH MAX HEIGHT | | 3 |
| CEILING LEVEL TO THE HIGHEST POINT AT 6.0m SETBACK LINE | 264 | mm |
| NGL AT FORWARD MOST POINT (AT 6.0m SETBACK LINE) | 33,860 | mm |
| MAX HEIGHT OF PORCH FROM NGL | 3,109 | mm |
| OT AREAS | | |
| TOTAL SITE AREA | 642.00 | m ² |
| PERMITTED BUILDING AREA | 385.20 | m ² |
| TOTAL BUILDING AREA | 191.00 | m ² |
| TOTAL NON-PERMEABLE AREA - DRIVEWAY AND CONCRETE PATHS | 126.8 | m ² |
| TOTAL PERMEABLE AREA | 324.2 | m ² |

| LEGEND |) - FINISHES |
|--------|--------------------------------|
| | JAMES HARDIE CLADDING |
| | RENDER A BLUE BOARD OR SIMILAR |
| | RENDER B BLUE BOARD OR SIMILAR |
| | |

LEGEND - SERVICES HOT WATER SERVICE METER BOX GAS GAS METER

NOTE: NATURAL GROUND LEVELS ARE SHOWN INDICATIVELY ONLY.

| AVERAGE GARAGE WALL HEIGHT | | | |
|----------------------------|---------------------|--|--|
| WALL LENGTH: | 6.33m | | |
| WALL AREA: | 17.79m ² | | |
| AVERAGE WALL HEIGHT: | 2.81m | | |

GLENORCHY CITY COUNCIL PLANNING SERVICES PLN-25-247 01.09.2025

28/08/2025 1:53:23 pm

621N


A03

1:100

03-COCOA

N

All dimensions

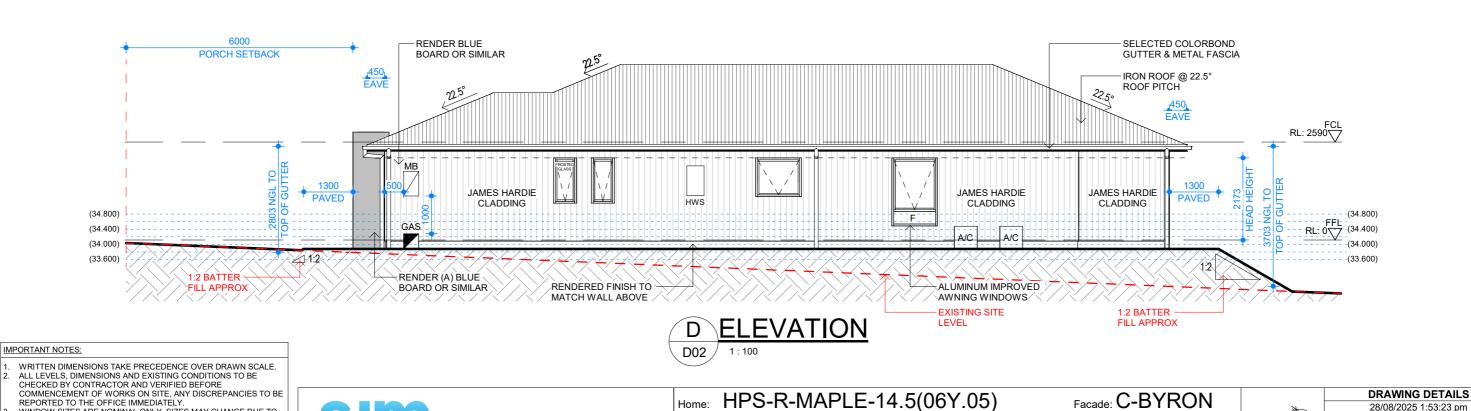

Client: SJM

Location: 33 PITCAIRN STREET (LOT 3), GLENORCHY TAS 7010

Drawing: ELEVATIONS C & D

1/37 Ascot Dr, Huntingfield TAS 7055

P +61 3 6289 6601

property developments

AVAILABILITY.

WINDOW SIZES ARE NOMINAL ONLY, SIZES MAY CHANGE DUE TO

AVAILABILITY.
FLOOR PLANS ARE DIMENSIONED TO TIMBER STUD FRAME.
ALL WORKS MUST BE EXECUTED IN A WORKMANLIKE MANOR AND
MUST CONFORM TO THE LATEST APPLICABLE AUSTRALIAN

STANDARDS.
THESE DRAWINGS SHALL NOT BE ALTERED, REPRODUCED, COPIED

IN PART OR IN WHOLE WITHOUT THE WRITTEN PERMISSION FROM ACCESS LIVING GROUP.


ALL DIMENSION ARE NOMINAL AND MUST BE VERIFIED ON SITE.

LEGEND ROOF VENTILATION - TO NCC

> **GLENORCHY CITY COUNCIL PLANNING SERVICES** PLN-25-247

01.09.2025

DATE RECEIVED

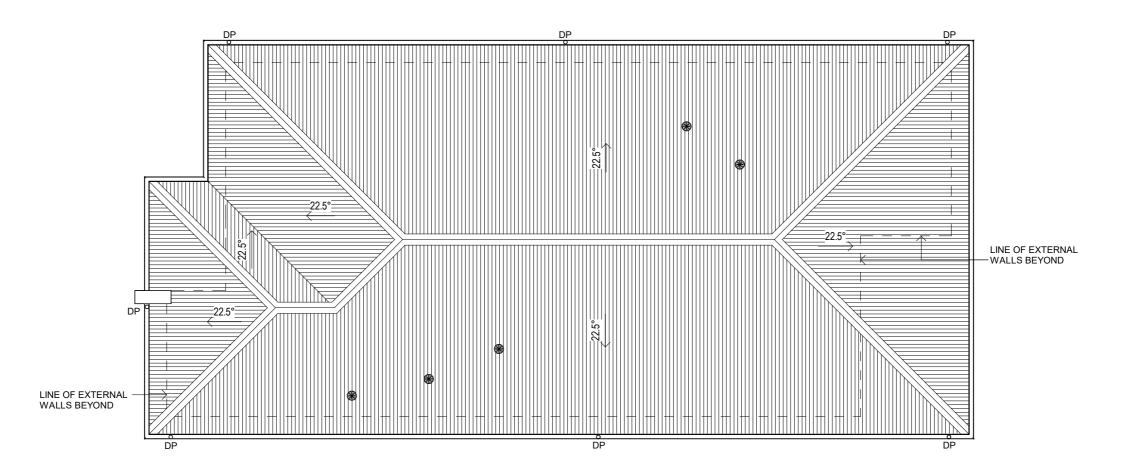

ROOF PLAN

IMPORTANT NOTES:

- WRITTEN DIMENSIONS TAKE PRECEDENCE OVER DRAWN SCALE.
 ALL LEVELS, DIMENSIONS AND EXISTING CONDITIONS TO BE
 CHECKED BY CONTRACTOR AND VERIFIED BEFORE
 COMMENCEMENT OF WORKS ON SITE, ANY DISCREPANCIES TO BE
 REPORTED TO THE OFFICE IMMEDIATELY.
 WINDOW SIZES ARE NOMINAL ONLY, SIZES MAY CHANGE DUE TO
 AVAILABILITY.

- AVAILABILITY.
 FLOOR PLANS ARE DIMENSIONED TO TIMBER STUD FRAME.
 ALL WORKS MUST BE EXECUTED IN A WORKMANLIKE MANOR AND
 MUST CONFORM TO THE LATEST APPLICABLE AUSTRALIAN
 STANDARDS.
 THESE DRAWINGS SHALL NOT BE ALTERED, REPRODUCED, COPIED
 IN PART OR IN WHOLE WITHOUT THE WRITTEN PERMISSION FROM
 ACCESS LIVING GROUP.
 ALL DIMENSION ARE NOMINAL AND MUST BE VERIFIED ON SITE.



1/37 Ascot Dr, Huntingfield TAS 7055

Location: 33 PITCAIRN STREET (LOT 3), GLENORCHY TAS 7010

HPS-R-MAPLE-14.5(06Y.05)


Facade: C-BYRON 03-COCOA

All dimensions to be verified

DRAWING DETAILS 28/08/2025 1:53:33 pm 1:100 621N

Drawing: ROOF PLAN

A03

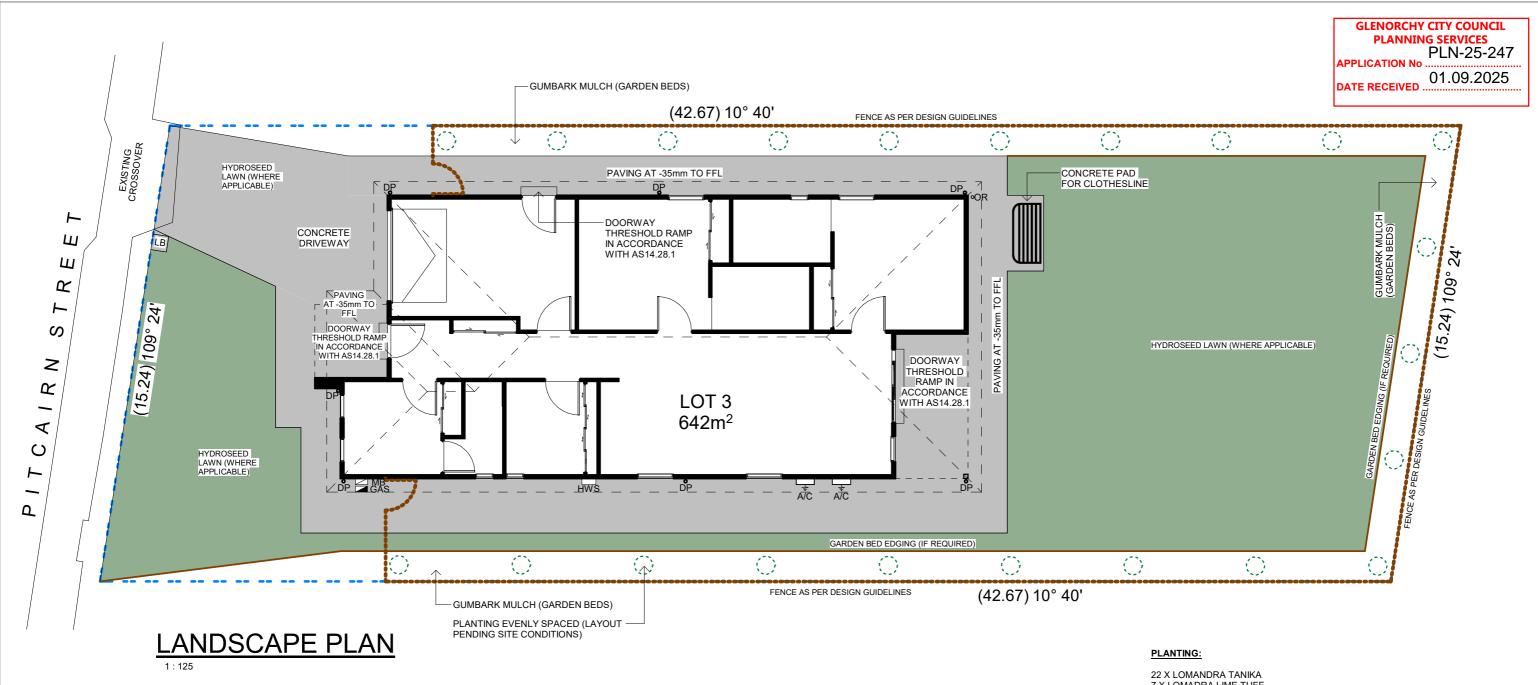

7 X LOMADRA LIME TUFF

1 X PITTOSPORUM SCREEN BETWEEN

<u>NOTE:</u> PLANTING TO BE SPACED EVENLY AROUND THE PROPERTY LANDSCAPING NOTES:

GRASSED AREAS TO BE HYDRO-SEEDED LAWN (LEVEL AREAS ONLY) GUM BARK MULCH TO BE PLACED IN THE FOLLOWING AREAS:

- SLOPED EMBANKMENTS

Facade: C-BYRON

03-COCOA

- TOP SIDE OF ANY WALLS OR LAWN EDGING WHERE MOWING IS IMPRACTICAL

TREATED PINE LAWN EDGING WHERE REQUIRED

NOTE: THIS DRAWING IS A PRELIMINARY INDICATION OF GENERAL LANDSCAPING LAYOUT. FINAL LAYOUT MAY CHANGE DUE TO SITE SPECIFIC LIMILATIONS.

IMPORTANT NOTES:

- WRITTEN DIMENSIONS TAKE PRECEDENCE OVER DRAWN SCALE. ALL LEVELS, DIMENSIONS AND EXISTING CONDITIONS TO BE CHECKED BY CONTRACTOR AND VERIFIED BEFORE COMMENCEMENT OF WORKS ON SITE, ANY DISCREPANCIES TO BE REPORTED TO THE OFFICE IMMEDIATELY.
- WINDOW SIZES ARE NOMINAL ONLY, SIZES MAY CHANGE DUE TO AVAILABILITY.
- AVAILABILITY.
 FLOOR PLANS ARE DIMENSIONED TO TIMBER STUD FRAME.
 ALL WORKS MUST BE EXECUTED IN A WORKMANLIKE MANOR AND
 MUST CONFORM TO THE LATEST APPLICABLE AUSTRALIAN
- THESE DRAWINGS SHALL NOT BE ALTERED, REPRODUCED, COPIED IN PART OR IN WHOLE WITHOUT THE WRITTEN PERMISSION FROM ACCESS LIVING GROUP.

 ALL DIMENSION ARE NOMINAL AND MUST BE VERIFIED ON SITE.



1/37 Ascot Dr, Huntingfield TAS 7055

P +61 3 6289 6601

HPS-R-MAPLE-14.5(06Y.05) Client: SJM


Location: 33 PITCAIRN STREET (LOT 3), GLENORCHY TAS 7010

Drawing: LANDSCAPE PLAN


DRAWING DETAILS 28/08/2025 1:53:38 pm SCALE N 1:125 621N All dimensions

SHEET SIZE

A03

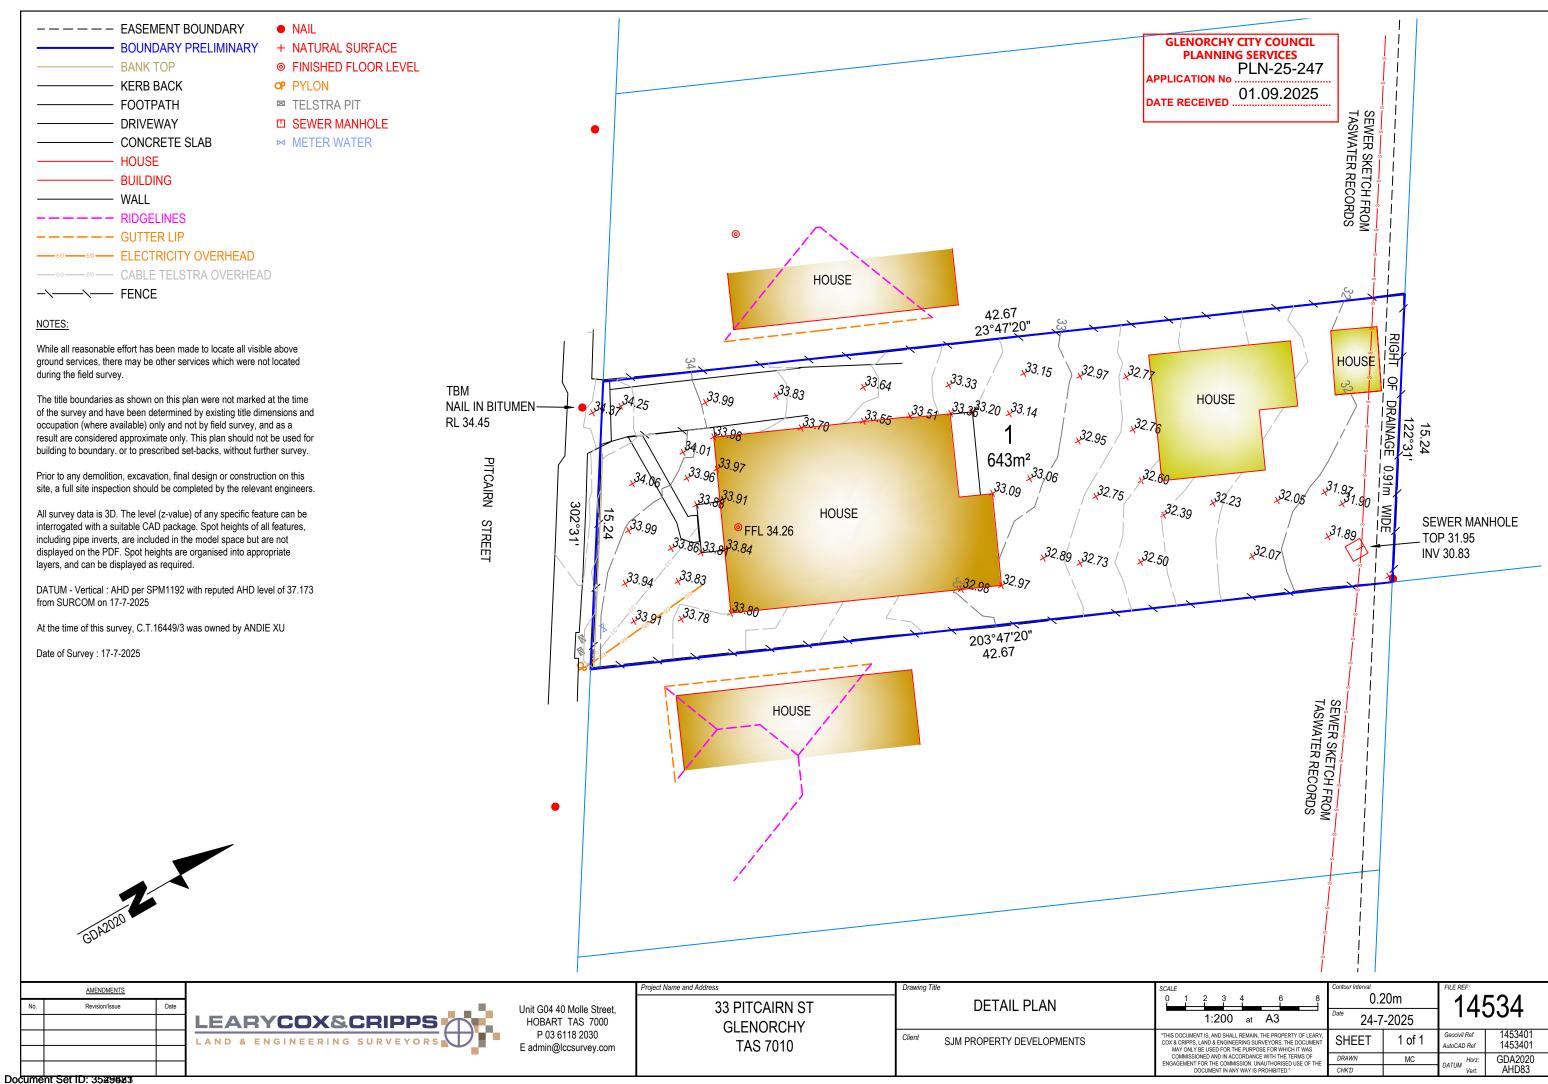

Version: 1, Version Date: 06/09/2025

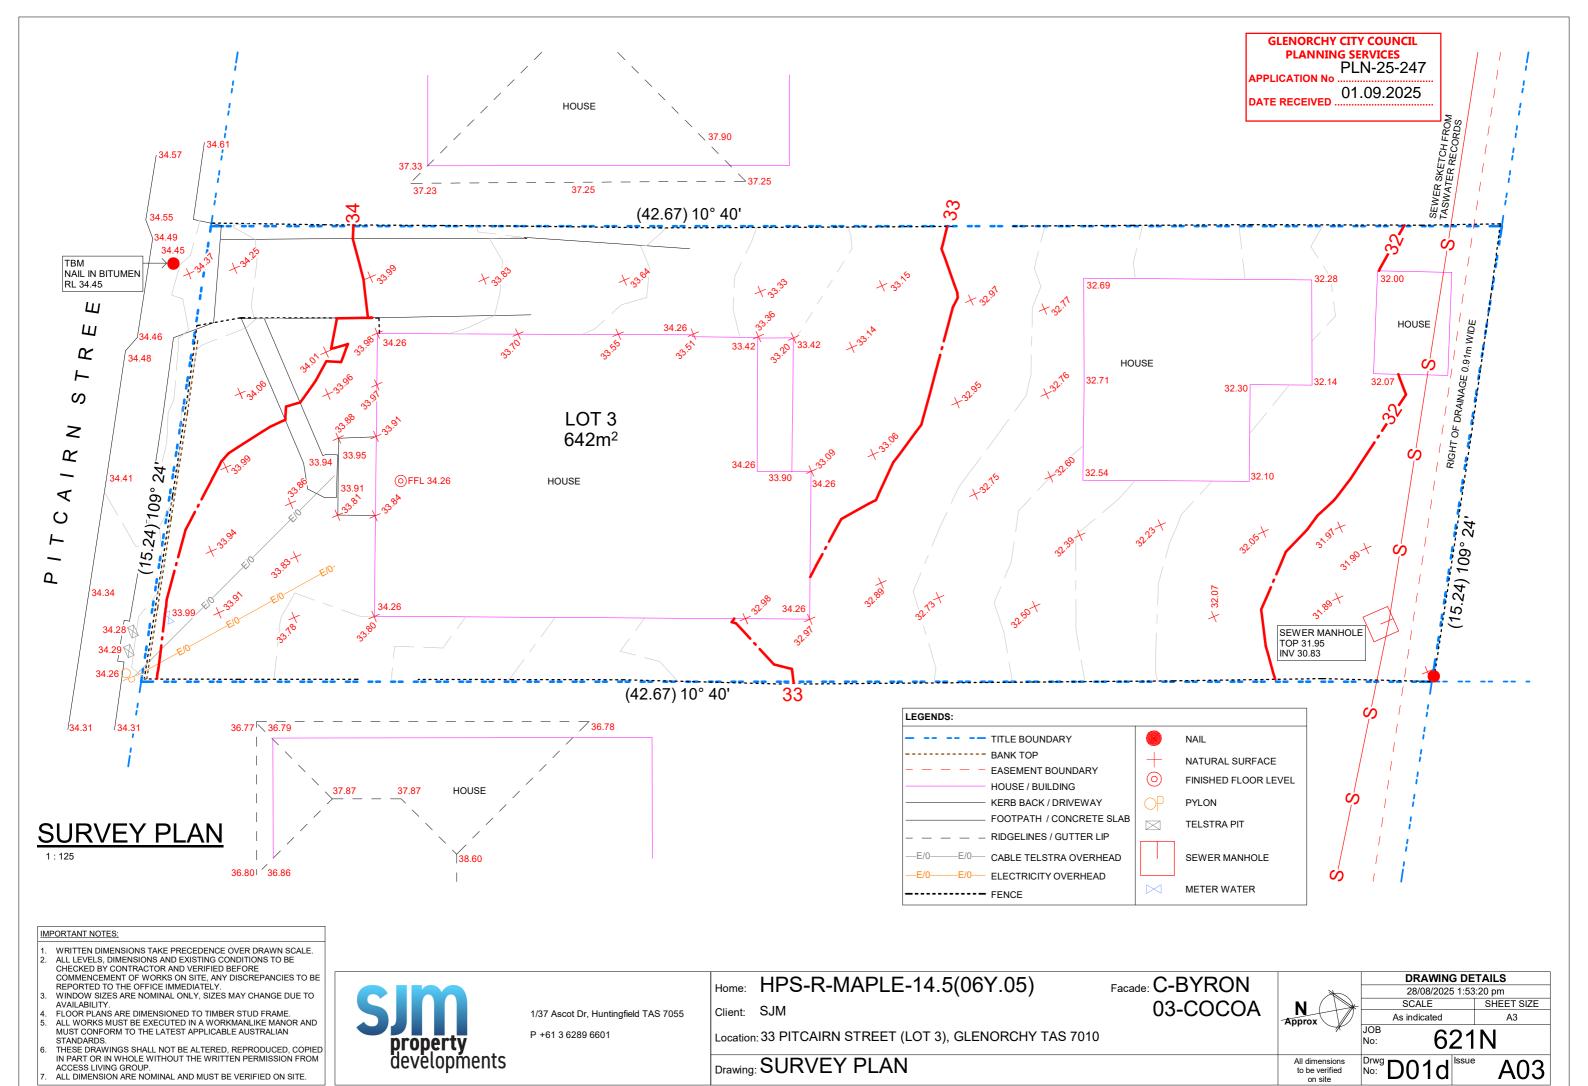

Document Set ID: 3529623

Version: 1, Version Date: 06/09/2025

NOTES: **GLENORCHY CITY COUNCIL** NOT FOR **PLANNING SERVICES** REFER TO C101 FOR DRIVEWAY NOTES AND LEGENDS. PROPOSED STORMWATER GRATED PIT AND GRATED CHANNEL ARE INDICATIVE ONLY. CONSTRUCTION APPLICATION No.: PLN-25-247 REFER TO ARCHITECTURAL DRAWINGS BY SJM FOR DRAINAGE DETAILS. **DATE RECEIVED:** 14/10/2025 CIVIL CONTRACTOR SHALL ENGAGE A LAND SURVEYOR TO SETOUT 35 PITCAIRN STREET EXISTING TASNETWORKS CONDUIT AND LIGHT VOLTAGE CABLE AS PER BYDA. DRIVEWAY LEVELS CT: 16449/2 **IMPORTANT** DRAWING MUST BE PRINTED & READ IN COLOUR 4.4% 4.4% P2 4.9% 4.4% 4.4% PITCAIRN STREET 2.4m P1 2.6% PROPOSED DWELLING FFL: 34.115 1.0m 32.6 33 PITCAIRN STREET 33.2 CT: 16449/3 31 PITCAIRN STREET CT: 16449/4 SCALE 1:100 AT A3 SHEET TRUE NORTH M. HORSHAM CC5865 I AS SHOWN Ã3 DRIVEWAY SETOUT PLAN SJM PROPERTY DEVELOPMENTS CIVIL ENGINEER/DESIGNER
S. MARTININGUI HYDRAULIC ENGINEER
R. HORNER PROPOSED DWELLING C101 33 PITCAIRN STREET, GLENORCHY 7010 25E82-13 Α 121 Sandy Bay Road, Sandy Bay TAS 7005 Phone (03) 6240 9911 www.jsa.com.au S.M. M.H. 13/10/2025 PLANNING APPROVAL Document Set ID: 3545880

Version: 1, Version Date: 16/10/2025

NOTES:

- PROPOSED CONTOURS AT 0.1m INTERVALS
- REFER TO C255 FOR TYPICAL DRIVEWAY CROSS SECTION.
- 3.0m MINIMUM DRIVEWAY WIDTH/DESIGN OF DOMESTIC DRIVEWAY AS PER AS/NZS 2890.1-2004 - SECTION 2.6
- P1 MIN. 3.0m WIDE. DOORWAY WIDTH TO SINGLE VEHICLE ENCLOSED GARAGE MIN. 3.0m AS PER AS/NZS 2890.1 CLAUSE 5.4.a.
- . P2 MIN 2.4x5.4m AS PER AS/NZS 2890.1 CLAUSE 2.4.1.

HATCH LEGEND



CONCRETE DRIVEWAY WITH PROPOSED CONTOURS SHOWN. 120 THICK, SL82 CENTRAL. REFER TO C255 FOR DETAILS.



EXISTING ROAD



EXISTING FOOTPATH

DRIVEWAY NOTES:

- EXCAVATED AND IMPORTED MATERIAL USED AS FILL IS TO BE APPROVED BY ENGINEER PRIOR TO INSTALLATION.
- FILL MATERIAL SHALL BE WELL GRADED AND FREE OF BOULDERS OR COBBLES EXCEEDING 150mm IN DIAMETER UNLESS APPROVED OTHERWISE.
- FILL REQUIRED TO SUPPORT DRIVEWAYS INCLUDING FILL IN EMBANKMENTS THAT SUPPORT DRIVEWAYS SHALL BE INSTALLED IN ACCORDANCE WITH THE FOLLOWING REQUIREMENTS:
- 3.1. TOP SOIL AND ORGANIC MATTER SHALL BE STRIPPED TO A MINIMUM OF 100mm.
- 3.2. THE SUB GRADE SHALL BE CHECKED FOR A MINIMUM BEARING CAPACITY OF 50 kPa.
- 3.3. FILL IN EMBANKMENTS SHALL BE KEYED 150mm INTO NATURAL GROUND. 3.4. THE FILL SHALL BE COMPACTED IN HORIZONTAL LAYERS OF NOT MORE THAN 150mm
- 3.5. EACH LAYER SHALL BE COMPACTED TO A MINIMUM DENSITY RATIO OF 95%, IT IS THE BUILDERS RESPONSIBILITY TO ENSURE THAT THIS IS ACHIEVED.
- 4. WHERE THE ABOVE REQUIREMENTS CANNOT BE ACHIEVED THE ENGINEER SHALL BE CONSULTED AND THE FORMATION SHALL BE PROOF ROLLED (UNDER SUPERVISION OF THE ENGINEER) TO DEMONSTRATE COMPACTION PRIOR TO THE PLACEMENT OF BASE OR SUB-BASE COURSES.
- 5. UNREINFORCED CONCRETE KERBS AND CHANNELS SHALL HAVE TROWELLED JOINTS AT NOT MORE THAN 3.0m CRS

CONTROLLED FILL:

CONTROLLED FILL SHALL BE LAID IN STRICT ACCORDANCE WITH AS2870 AND AS3798 REQUIREMENTS. THE FOLLOWING METHOD IS APPROVED:

- . FILL MATERIAL SHALL BE WELL GRADED FCR OR SITE ROCK REVIEWED DURING EXCAVATION.
- THE SUB GRADE SHALL BE CHECKED FOR BEARING CAPACITY WHICH IS A MINIMUM OF 50kPa FOR SLABS AND A MINIMUM OF 100kPa FOR FOOTINGS.
- 3. THE FILL SHALL BE COMPACTED IN HORIZONTAL LAYERS OF NOT MORE THAN 150mm.
- THE FILL SHALL BE COMPACTED TO A MINIMUM DENSITY RATIO OF 95% FOR RESIDENTIAL APPLICATIONS. IT IS THE BUILDERS
 RESPONSIBILITY TO ENSURE THAT THIS LEVEL OF COMPACTION IS ACHIEVED. IMPORTED MATERIAL, CONTRARY TO THE
 ABOVE SPECIFICATION, INTENDED FOR USE AS STRUCTURAL FILL SHALL BE APPROVED IN WRITING BY THE ENGINEER PRIOR
 TO LISE.

CONCRETE:

- CONCRETE SHALL BE NOT LESS THAN N25 GRADE, WITH 20mm NOMINAL MAXIMUM AGGREGATE SIZE, SLUMP SHALL BE SELECTED TO SUIT THE CONSTRUCTION CONDITIONS. UNLESS NOTED OTHERWISE THE MINIMUM APPROPRIATE SPECIFICATIONS FROM AS3600 AND AS2870 SHALL BE ADOPTED.
- 2. SAWN CONTROL JOINTS SHALL BE CONSTRUCTED AS SOON AS POSSIBLE WITHOUT RAVELING THE JOINT, GENERALLY THIS SHALL BE WITHIN 48 HOURS.
- 3. CONCRETE SHALL BE CURED FOR A MINIMUM OF 7 DAYS USING CURRENT BEST PRACTICE METHODS. SPRAY APPLIED CURING COMPOUNDS ARE GENERALLY NOT DEEMED SATISFACTORY AS SOLE CURING METHOD.
- 4. CONCRETE SHALL BE MECHANICALLY VIBRATED U.N.O.
- 5. ADDITIONAL WATER SHALL NOT BE ADDED TO THE CONCRETE ON SITE UNLESS SIGNED BY THE DRIVER AND APPROVED BY THE SUPPLIER.

GLENORCHY CITY COUNCIL PLANNING SERVICES

APPLICATION No. : PLN-25-247

DATE RECEIVED: 14/10/2025

A FOR PLANNING APPROVAL S.M. M.H. 13/10/2025

PEV DESCRIPTION PV CHK DATE

SCIENCE IN DESIGN 121 Sandy Bay Road, Sandy Bay TAS 700: Phone (03) 6240 9911 www.jsa.com.au

M. HORSHAM CC5865 I

CIVIL ENGINEER/DESIGNER
S. MARTININGUI

STATUS

PLANNING APPROVAL

SJM PROPERTY DEVELOPMENTS
PROPOSED DWELLING
33 PITCAIRN STREET, GLENORCHY 7010

A3

DRIVEWAY
NOTES AND LEGENDS

25E82-13 DWG NO C100 REV A

11 - Public Documents\CAD Library\Civil\C100

LINE LEGEND


300mm OFFSET FROM VEHICLE EXTENTS

B85 VEHICLES DIMENSION AS PER AS/NZS 2890.1:2004 - APPENDIX B - FIGURE B2

GLENORCHY CITY COUNCIL PLANNING SERVICES


APPLICATION No. : PLN-25-247

DATE RECEIVED: 14/10/2025

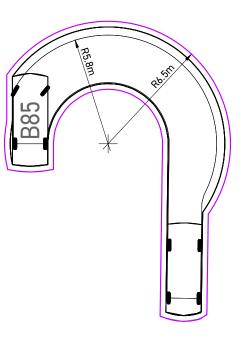

B85 VEHICLE MOVEMENT NOTES:

- MOVEMENT TEMPLATES DEMONSTRATE ABILITY
 OF VEHICLES TO ENTER INTERSECTION IN A
 FORWARDS DIRECTION AND LEAVE IN A
 FORWARDS DIRECTION.
- THE BASE DIMENSIONS OF THE CAR TEMPLATE
 REPRESENT THE B85 (85th PERCENTILE)
 VFHICI F
- THE SWEPT PATH OF THE VEHICLE REPRESENT THE OUTER EXTENTS OF THE VEHICLE BODY
- 4. THE PATHS WERE GENERATED WITH A TURNING SPEED OF 5km/hr FROM THE STREET.

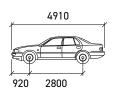

B85

mm

Width : 1870
Track : 1770
Lock to Lock Time : 4.0
Turning Radius : 5.8

| 1 | | | | | |
|---|---|-----------------------|------|------|------------|
| Г | | | | | |
| П | | | | | |
| П | | | | | |
| | | | | | |
| | | | | | |
| П | | | | | |
| Г | Α | FOR PLANNING APPROVAL | S.M. | M.H. | 13/10/2025 |
| Г | 7 | DESCRIPTION | DV | CIK | DATE |

SCIENCE IN DESIGN
121 Sandy Bay Road, Sandy Bay TAS 7005
Phone (03) 6240 9911 www.jsa.com.au

| STATUS PLANNING | APPROVAL | |
|--|------------------------------|----|
| CIVIL ENGINEER/DESIGNER S. MARTININGUI | HYDRAULIC ENGINEER R. HORNER | |
| M. HORSHAM CC5865 I | AS SHOWN | A3 |


SJM PROPERTY DEVELOPMENTS
PROPOSED DWELLING
33 PITCAIRN STREET, GLENORCHY 7010

| SCALE 1:200 AT A3 SHEET | | | | | | |
|-------------------------|------------------------------|--------|-----|-----|---|--|
| | VEHICLE MOVEMENT DIAGRAM B85 | | | | | |
| | PROJECT NO | DWG NO | | REV | | |
| 0 | 25E82-13 | C. | 130 | | A | |

DIMENSIONS TAKE PRECEDENCE. DO NOT SCALE.

Document Set ID: 3545880

Version: 1, Version Date: 16/10/2025

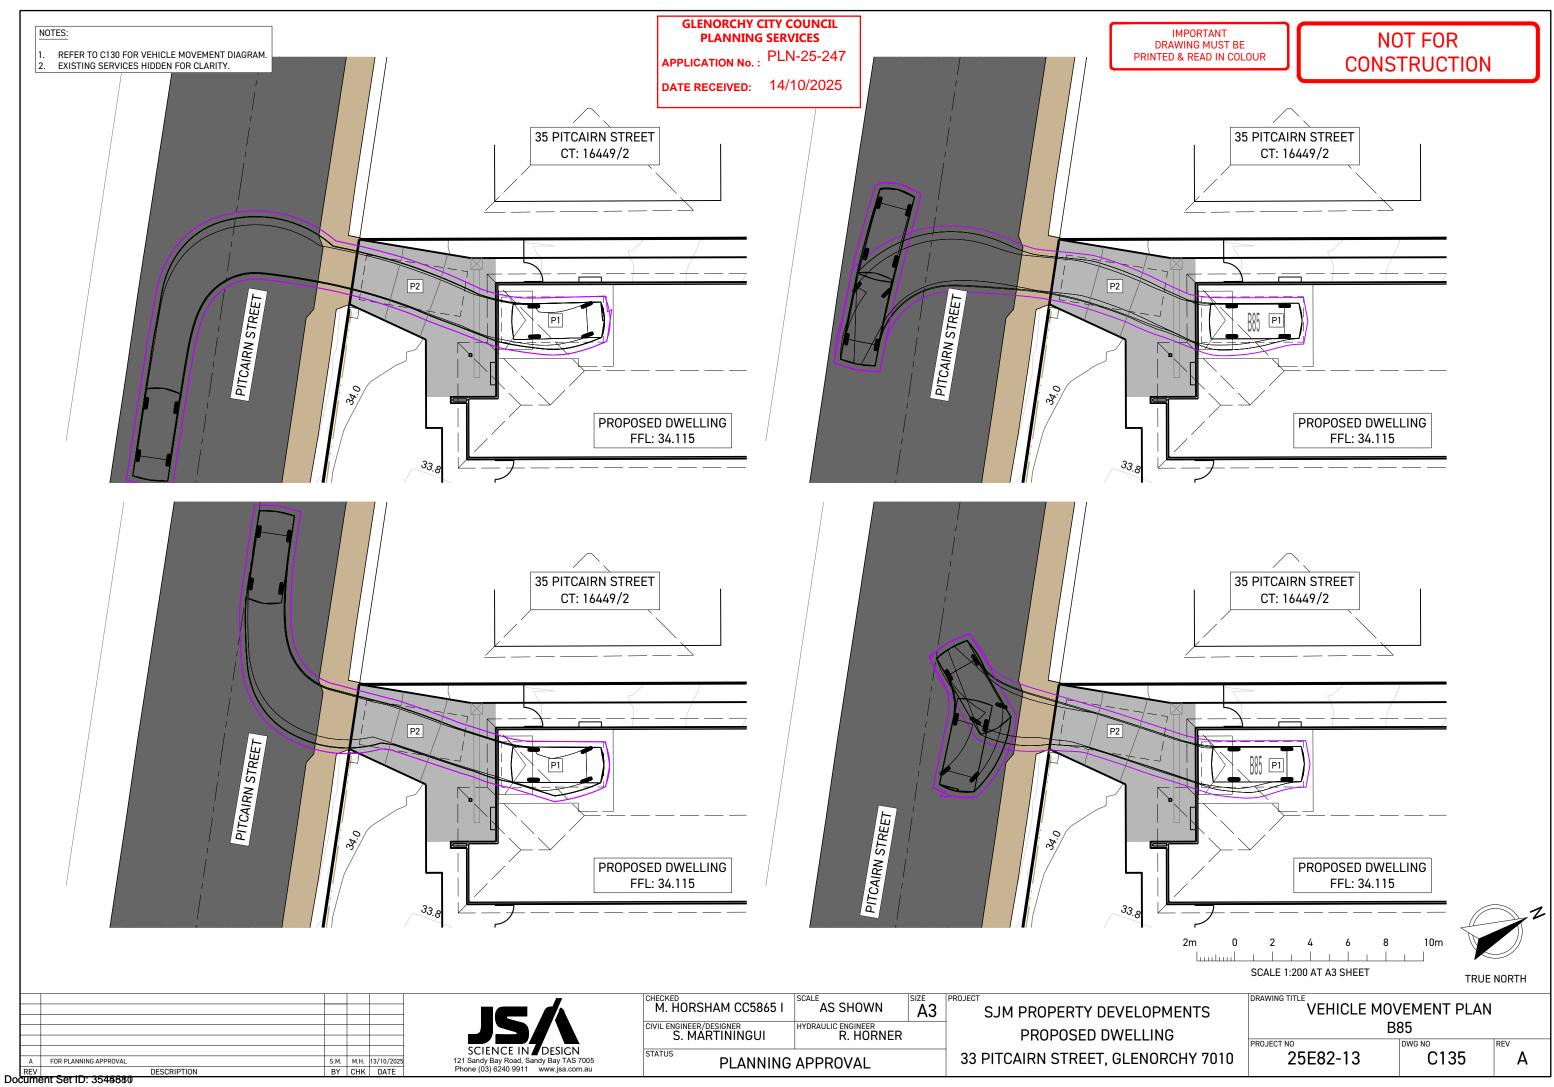

Version: 1, Version Date: 16/10/2025


GENERAL

- 1. IT IS THE RESPONSIBILITY OF THE CONTRACTOR TO CONTACT THE SERVICES AUTHORITY AND LOCATE EXISTING UNDER GROUND SERVICES PRIOR TO ANY EXCAVATION WORKS COMMENCING ON SITE.
- 2. AREAS DISTURBED BY EARTHWORKS ARE TO BE STRIPPED OF TOPSOIL TO A DEPTH OF 100mm (OR AS DIRECTED BY THE SUPERINTENDENT). TOPSOIL IS TO BE STOCKPILED ON SITE AND RE-SPREAD AFTER EARTHWORKS ARE COMPLETE.
- 3. A 100mm THICK LAYER OF SUB 2 40mm FCR MAY BE USED DURING CONSTRUCTION FOR TEMPORARY ACCESS. FOR WET GROUND WITH POOR DRAINAGE & BEARING CAPACITY, ADDITIONAL SUB GRADE REPLACEMENT USING 100mm SPALLS MAY BE REQUIRED. CONSULT ENGINEER.

DRIVEWAY NOTES:

- 4. EXCAVATED AND IMPORTED MATERIAL USED AS FILL IS TO BE APPROVED BY ENGINEER PRIOR TO INSTALLATION,
- 5. FILL MATERIAL SHALL BE WELL GRADED AND FREE OF BOULDERS OR COBBLES EXCEEDING 150MM IN DIAMETER UNLESS APPROVED OTHERWISE.
- 6. FILL REQUIRED TO SUPPORT DRIVEWAYS INCLUDING FILL IN EMBANKMENTS THAT SUPPORT DRIVEWAYS SHALL BE INSTALLED IN ACCORDANCE WITH THE FOLLOWING REQUIREMENTS:
- a.TOP SOIL AND ORGANIC MATTER SHALL BE STRIPPED TO A MINIMUM OF 100MM.
- b.THE SUB GRADE SHALL BE KEYED 150MM INTO NATURAL GROUND.
- c.THE FILL SHALL BE COMPACTED TO A MINIMUM DENSITY RATIO OF 95%, IT IS THE BUILDERS RESPONSIBILITY TO ENSURE THAT THIS IS ACHIEVED.
- 7. WHERE THE ABOVE REQUIREMENTS CANNOT BE ACHIEVED THE ENGINEER SHALL BE CONSULTED AND THE FORMATION SHALL BE PROOF ROLLED (UNDER SUPERVISION OF THE ENGINEER) TO DEMONSTRATE COMPACTION PRIOR TO THE PLACEMENT OF BASE OR SUB BASE COURSES.
- 8. UNREINFORCED CONCRETE KERBS AND CHANNELS SHALL HAVE TROWELED JOINT AT NOT MORE THAN 3.0M CENTRES.
- 9. FOR SPECIFICATIONS AND DETAILS NOT SHOWN WITH THIS DRAWING, THE BUILDER SHALL REFER TO AND COMPLY WITH CONSTRUCTION DETAIL PER AS3727.1 2016 PAVEMENTS PART 1: RESIDENTIAL.

| CONCRETE QUALITY | | | | | | | |
|---|-----|----|----|-----|----|--|--|
| ELEMENT SLUMP AGGREGATE (MAX. SIZE) CEMENT TYPE ADMIXTURE F'c (MPa) | | | | | | | |
| DRIVEWAY | 100 | 20 | SL | NIL | 25 | | |

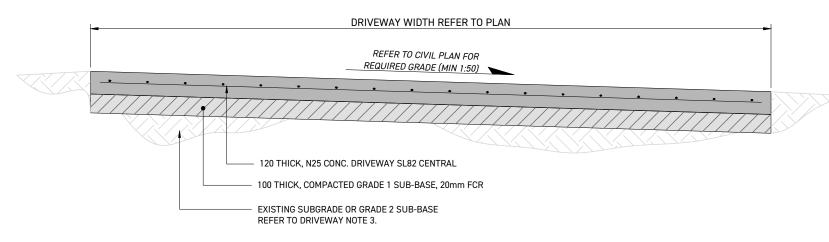

CONCRETE DRIVEWAY SECTION
SCALE: NTS

| Α | FOR PLANNING APPROVAL | S.M. | M.H. | 13/10/2025 |
|-----|-----------------------|------|------|------------|
| REV | DESCRIPTION | BY | СНК | DATE |

SCIENCE IN DESIGN
121 Sandy Bay Road, Sandy Bay TAS 7005
Phone (03) 6240 9911 www.jsa.com.au

CIVIL ENGINEER/DESIGNER
S. MARTININGUI

STATUS

CIVIL ENGINEER/DESIGNER
S. MARTININGUI

STATUS

PLANNING APPROVAL

SJM PROPERTY DEVELOPMENTS
PROPOSED DWELLING
33 PITCAIRN STREET, GLENORCHY 7010

CONSTRUCTION DETAILS
RESIDENTIAL DRIVEWAY

GLENORCHY CITY COUNCIL

PLANNING SERVICES
APPLICATION No.: PLN-25-247

DATE RECEIVED: 14/10/2025

25E82-13

C255

6233

BASIN (DN40) 100mm CHANNEL DRAIN WITH CLASS 'B' PLUMBING NOTES AND DRAINAGE NOTES: 4. PROVIDE PLASTEC DN100 SWIVEL EXPANSION JOINTS **DETAIL A: LAUNDRY STAND PIPE** DETAIL B: LAUNDRY STAND PIPE DN40 LAUNDRY STAND PIPE DN40 LAUNDRY STAND PIPE AT ALL DOWNPIPES AND SEWER CONNECTIONS TO TRAFFICABLE LID, 'ACO' K100 OR SIMILAR CLOTHES WASHING MACHINE (DN40) I. VENTING OF DRAINS TO COMPLY WITH MAIN LINES. LOCATE WITHIN 1m OF BUILDING LINE. HOSE FROM WASHING MACHINE HOSE FROM WASHING MACHINE AS/NZS 3500.2 3.9.2.1 CLAUSE. DOWNPIPE (DN90 SN2) DISH WASHING MACHINE 5. HERE PIPEWORK PENETRATES FOUNDATION OR SLAB . BACKFLOW PROTECTION VALVE IS EDGE PROVIDE 40mm LAGGING AROUND PIPEWORK. 450 x 450 x 600 DEEP PRECAST STORMWATER REQUIRED TO BE INSTALLED TO SHOWER HOSE ASSEMBLY WHERE SHOWER HOSE PIT WITH TRAFFICABLE CLASS 'B' LID, 'ACO' CLOTHES WASHING MACHINE 6. FOR CLASS 'H' AND 'E' SITES INSTALL PLASTEC DN100 TYPE 45 OR SIMILAR OVERFLOW RELIEF GULLY (DN100) + TAP OVER SWIVEL EXPANSION JOINTS AT ALL CHANGES OF CAN REACH THE TOILET BOWL. SWIVEL EXPANSION JOINT, REFER TO JSA 3. HOT WATER INSTALLATION SHALL DELIVER **DRAWING S750** HOT WATER TO ALL SANITARY FIXTURES USED FOR PERSONAL HYGIENE AT 50°C, '. FOR CLASS 'P' SITES INSTALL MIN 150mm OF COMPACTED FCR IN ALL TRENCHES BEFORE PLACING TUNDISH FOR A/C CONDENSATE (DN50) KITCHEN & LAUNDRY SHALL BE 60°C TO TROUGH (LAUNDRY) (DN40) UPSTREAM VENT (DN50) COMPLY WITH REQUIREMENTS OF AS3500 8. WHERE PIPEWORK PENETRATES SLAB VERTICALLY, WATER CLOSET PAN (DN100) 2021. (TEMPERING VALVES TO BE PROVIDE 10mm LAGGAING INSTALLED TO SUIT). SEWER DN100 uPVC SN6 (DWV) MIN 1:60 FALL STORMWATER DN100 uPVC SN6 (DWV) MIN 1:100 FALL DN40 TRAP DN40 TRAP DN40 VENT WASTE PIPE WASTE PIPE IO WITHIN 2.5m OF WHERE PIPE EXITS BUILDING ON DRAINS WHICH CONNECT LID 34.04 WITH AS/NZS 3500.2 4.7.1 (42.67) 10° 40' EXISTING CROSSOVER IL 32.25 GP X NGL 33.65 5.6% IL 32.95 NGL 32.65 DN40 LAUNDRY STAND PIPE WITH DN40 VENT, WIDE REFER TO DETAIL B Ш RIGHT OF DRAINAGE 0.91m W LOT 3 Ш 642m² (15.24) 109° 24' 2 .24) 109°; CONNECTION PER LISTMAP S CONNECT DISH WACHING SITE CONTRACTOR DURING CONNECT CLOTHES WASHING MACHINE PUMPED DISCHARGE TO ABOVE THE WATER SEAL PRELIMINARY SITE WORKS. INVERT ASSUMED 400mm DEEP. NGL 31.95 Z TO A TRAPPED WASTE PIPE OF THE KITCHEN SINK TRAP IN NGL 32.5 ACCORDANCE WITH AS/NZS (15. TROUGH, AS PER DETAIL A. IN 3500.2 13.25.2.1 IL 31.8 ACCORDANCE WITH AS/NZS OVERFLOW RELIEF 3500.2 13.25.1 GULLY (ORG) (150mm NGL 33.85 T BELOW LOWEST PLUMBING FIXTURE) \circ WITH TAP OVER. NGL 32.5 IL 31.9 NGL 32.3 Ω **EXISTING STORMWATER LOT** NGL 33.8 CONNECTION PER SITE SURVEY IO WITHIN 2 5m OF WHERE PLAN, LOCATION TO BI PIPE EXITS BUILDING ON DRAINS WHICH CONNECT CONFIRMED BY SITE NGL 32.5 NGL 33.5 IL 32.9 NGL 32.4 IL 32.0 PRELIMINARY SITE WORKS INVERT ASSUMED 400mm DEEP WITH AS/NZS 3500.2 4.7.1 PLUMBING PLAN (42.67) 10° 40' NGL 31.9 RMWATER LINES **GLENORCHY CITY COUNCIL** OINTS TO BE UNCOVERED ON SITE). **PLANNING SERVICES** SEWER MAINTENANCE HOLE APPLICATION No. : PLN-25-247 IL 30.83 **DATE RECEIVED:** 14/10/2025 IMPORTANT NOTES WRITTEN DIMENSIONS TAKE PRECEDENCE OVER DRAWN SCALE. ALL LEVELS, DIMENSIONS AND EXISTING CONDITIONS TO BE CHECKED BY CONTRACTOR AND VERIFIED BEFORE COMMENCEMENT OF WORKS ON SITE, ANY DISCREPANCIES TO BE DRAWING DETAILS HPS-R-MAPLE-14.5(06Y.05) Facade: C-BYRON REPORTED TO THE OFFICE IMMEDIATELY 28/08/2025 1:53:34 pm WINDOW SIZES ARE NOMINAL ONLY, SIZES MAY CHANGE DUE TO SCALE 03-COCOA AVAILABILITY. N AVAILABILITY. FLOOR PLANS ARE DIMENSIONED TO TIMBER STUD FRAME. ALL WORKS MUST BE EXECUTED IN A WORKMANLIKE MANOR AND Client: SJM 1/37 Ascot Dr, Huntingfield TAS 7055 As indicated A3 MUST CONFORM TO THE LATEST APPLICABLE AUSTRALIAN 621N P +61 3 6289 6601 Location: 33 PITCAIRN STREET (LOT 3), GLENORCHY TAS 7010 property developments THESE DRAWINGS SHALL NOT BE ALTERED, REPRODUCED, COPIED IN PART OR IN WHOLE WITHOUT THE WRITTEN PERMISSION FROM ACCESS LIVING GROUP. Drawing: PLUMBING PLAN All dimensions A03 ALL DIMENSION ARE NOMINAL AND MUST BE VERIFIED ON SITE