

DEVELOPMENT APPLICATION

APPLICATION NUMBER: PLN-25-295

PROPOSED DEVELOPMENT: Dwelling

LOCATION: 1 Anear Court Lutana

APPLICANT: Pinnacle Drafting & Design

ADVERTISING START DATE: 21/11/2025

ADVERTISING EXPIRY DATE: 5/12/2025

Plans and documentation are available for inspection at Council's Offices, located at 374 Main Road, Glenorchy between 8.30 am and 5.00 pm, Monday to Friday (excluding public holidays) and the plans are available on Glenorchy City Council's website (www.gcc.tas.gov.au) until 5/12/2025.

During this time, any person may make representations relating to the applications by letter addressed to the Chief Executive Officer, Glenorchy City Council, PO Box 103, Glenorchy 7010 or by email to gccmail@gcc.tas.gov.au.

Representations must be received by no later than 11.59 pm on **5/12/2025**, or for postal and hand delivered representations, by 5.00 pm on **5/12/2025**.

ABN 19 753 252 493

GLENORCHY CITY COUNCIL PLANNING SERVICES

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DATE RECEIVED: 11/11/2025

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Note: The images provided are artistic representations only and should not be used as references for final colours, finishes, or external/internal features.

1 Anear Court, Lutana - 7009

Owner(s) or Clients Building Classification

Designer

Total Floor Area (Combined)

Alpine Area

Other Hazards

(e.g., High wind, earthquake, flooding, landslip, dispersive soils, sand dunes, mine subsidence, landfill, snow & ice, or other relevant factors)

Homes Tasmania

1a

Jason Nickerson CC6073Y

155.65m²

Deck 3.30m²

N/A N/A Title Reference

Zoning General Residential

Land Size

Design Wind Speed

Soil Classification

Climate Zone

Corrosion Environment
Bushfire Attack Level (BAL)

Low

27872/8

509m²

TBA

TBA

Low

Changes Lis	t		
ID	Description of change	Date Changed	Designer

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ID	Sheet Name	Issue
A.01	Site Plan	DA - 01
A.02	Floor Plan	DA - 01
A.03	Elevations	DA - 01
A.04	Elevations	DA - 01
A.05	Roof Plan	DA - 01
A.06	Electrical Plan	DA - 01

Surface Water Drainage

Ground to fall away from building in all directions in compliance with AS2870 & N.C.C 2022 3.3.3.

Surface water must be diverted away from a Class 1 building as follows:

(a) Slab-on-ground - finished ground level adjacent to a building: the external finished surface surrounding the slab must be drained to move surface water away from the building and graded to give a slope of not less than (i)25mm over the first 1m from the building

(A)in low rainfall intensity areas for surfaces that are reasonably impermeable (such as concrete or claypaving); or

(B) for any reasonably impermeable surface that forms part of an access path or ramp provided for the purposes of Clauses 1.1 (2) or (4)(c) of the ABCB Standard for Livable Housing Design; or

(ii)50 mm over the first 1 m from the building in any other case.

(b)Slab-on-ground - finished slab heights: the height of the slab-on-ground above external finished surfaces mustbe not less than

(i) 100 mm above the finished ground level in low rainfall intensity areas or sandy, welldrained areas; or

(ii) 50 mm above impermeable (paved or concrete) areas that slope away from the building in accordance with(a); or (iii) 150 mm in any other case.

(c)The ground beneath suspended floors must be graded so that the area beneath the building is above the adjacent external finished ground level and surface water is prevented from ponding under the building.

Subsoil Drainage

is to comply with AS2870, AS3500 & N.C.C 2022 3 3 4

Where a subsoil drainage system is installed to divert subsurface water away from the area beneath a building, the subsoil drain must-

(a) be graded with a uniform fall of not less than 1:300: and

(b) discharge into an external silt pit or sump with.

(i) the level of discharge from the silt pit or sump into an impervious drainage line not less than 50 mm below the invert level of the inlet; and provision for cleaning and maintenance.

Note

All driveway pits and grate drains to be Class B.

Stormwater pits are indicative. Location may vary depending on site conditions.

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Survey Notes


This plan and associated digital model is prepared for Pinnacle Drafting from a combination of field survey and existing records for the purpose of designing new constructions on the land and should not be used for any other

The title boundaries as shown on this plan were not marked at the time of the survey and have been determined by plan dimensions only and not by field survey. No measurements or offsets are to be derived between the features on this plan and the boundary layer. The relationship between the features in this model and the boundary layers cannot be used for any set out purposes or to confirm the position of the title boundaries on site.

Due to the nature of the title boundary information, if any structures are designed on or near a boundary we would recommend a re-mark survey be completed and lodged with the Land Titles Office to support the boundary definition. Services shown have been located where visible by field survey.

Services denoted as being "Per BYDA only" are approximate and for illustrative purposes only. Prior to any demolition, excavation or construction on the site, the relevant authority should be contacted for possible location of further underground services and detailed locations of all services.

This note forms an integral part of the Plan/Data. Any reproduction of this plan/model without this note Attached will render the information shown invalid.

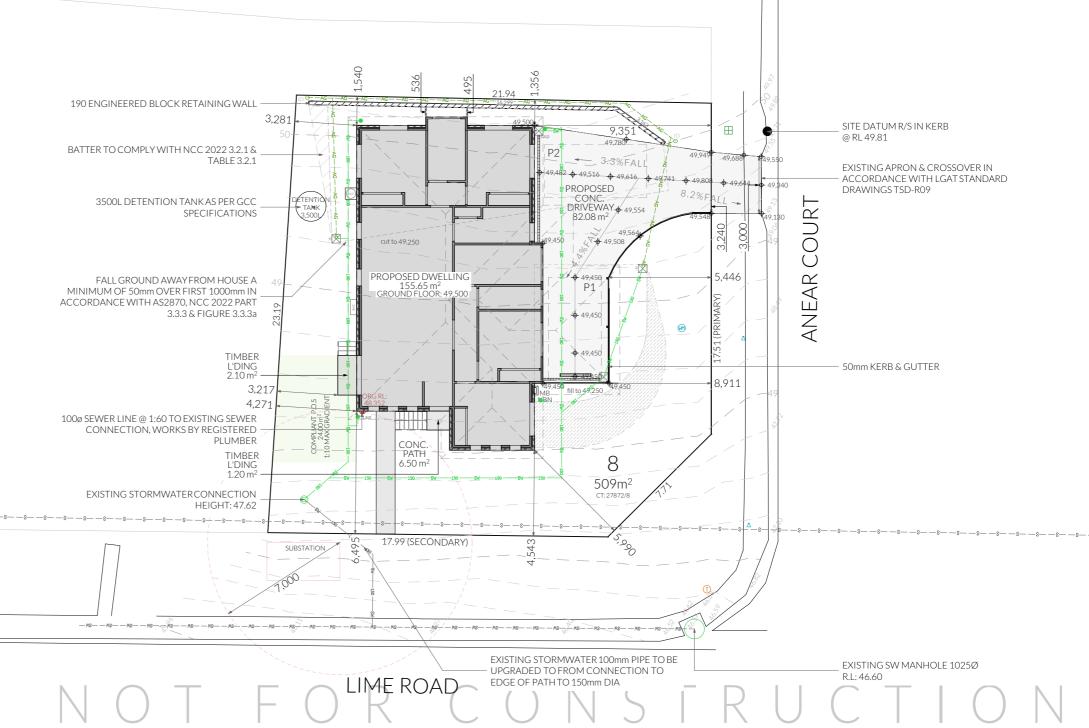

Site Areas

Site Area **Building Footprint** Total Site Coverage

 $509m^{2}$ 155.65m² 30.58%

> PINNACLE DRAFTING & DESIGN 7/3 Abernant Way, Cambridge 7170

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Site Plan

Revision:

Approved by:

DA - 01

Scale: 1:200 @ A3

Pg. No:

A.01

Proposal: Government Housing Tender

Client: Homes Tasmania Address: 1 Anear Court, Lutana - 7009 Date:

Engineer: TBA

Building Surveyor: TBA

Drawn by: CJ & JRM Job No: 039-2025







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Articulation Joint

Smoke Alarm

Construction of sanitary compartments 10.4.2 of NCC 2022

The door to a fully enclosed sanitary compartment must

- open outwards; or
- slide; or
- be readily removable from the outside of the

unless there is a clear space of at least 1.2 m, measured in accordance with Figure 10.4.2 of NCC $\,$ 2022 Vol II, between the closet pan within the sanitary compartment and the doorway.

Note: Safe Movement & Egress

Openable windows greater than 4m above the surface below are to be fitted with a device to limit opening or a suitable screen so a 125mm sphere cannot pass through. Except for Bedrooms, where the requirement is for heights above 2m. Refer to clauses 11.3.7 and 11.3.8 of NCC 2022 for further information on suitable protective devices.

Note: Paved Areas

All paths and patios to fall away from dwelling.

Note: Stair Construction

All stairs to be constructed in accordance with NCC Vol II 2022 Part 11.2.2:

Riser: Min 115mm - Max 190mm Going: Min 240mm - Max 355mm Slope (2R+G): Max 550 - Min 700

For stairways serving non-habitable room used infrequently, refer to table 11.2.2(b).

Landings to comply with Clause 11.2.5 and be a minimum of 750mm deep measured 500mm from the inside edge of the landing.

Slip resistance of treads, nosings and ramps to $% \left\{ 1,2,\ldots \right\}$ comply with Clause 11.2.4.

Heights of rooms & other spaces 10.3.1 of NCC 2022

Heights of rooms and other spaces must not be less

(a)in a habitable room excluding a kitchen - 2.4 m; and (b)in a kitchen - 2.1 m; and

(c)in a corridor, passageway or the like - 2.1 m; and (d)in a bathroom, shower room, laundry, sanitary $compartment, airlock, pantry, storeroom, garage, car parking area or the like - 2.1\ m; and \\ (e)in a room or space with a sloping ceiling or$

projections below the ceiling line within- See NCC directly for these items

(f)in a stairway, ramp, *landing*, or the like - 2.0 m measured vertically above the nosing line of stairway treads or the floor surface of a ramp, landing or the like.

If required onsite, the builder may work within the tolerances of the above as specified within the NCC 2022 Vol II. Builder to contact Pinnacle before undertaking works.


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Important Note

Design Policy guidelines & Livable Housing Design Guidelines for silver generally with Gold compliance to Bedrooms, Bathrooms and Laundry



Floor Areas

Floor Plan

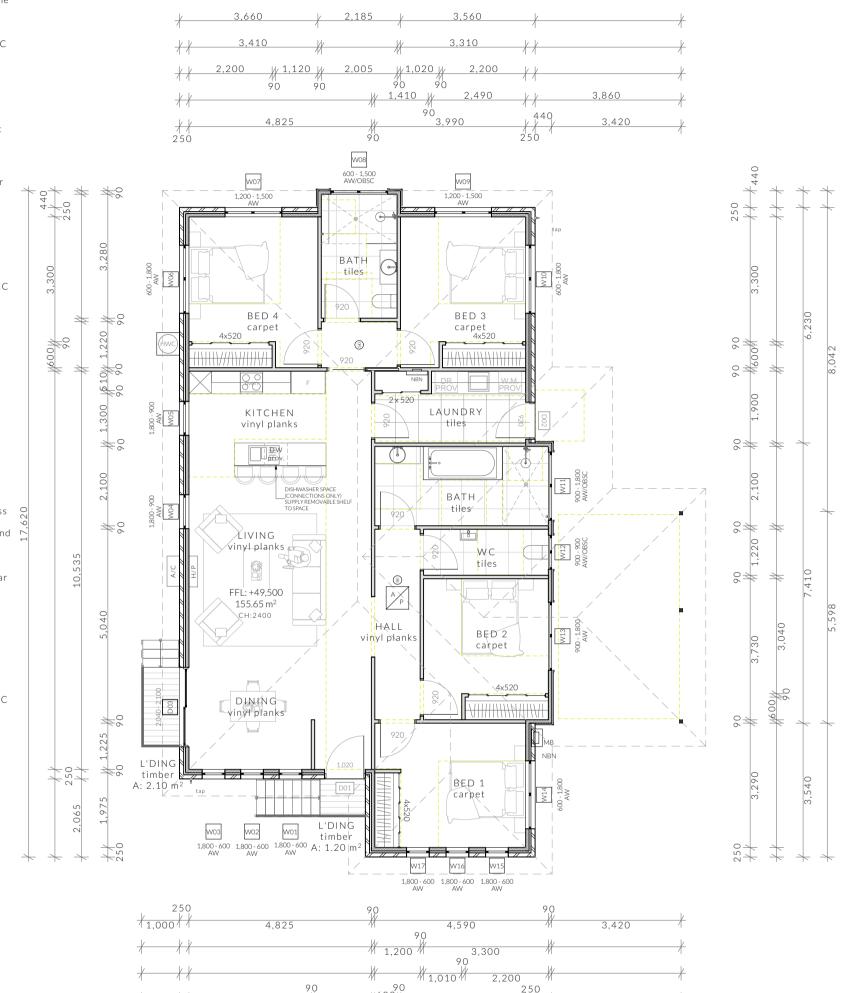Floor Area 155.65m² L'dings 3.30m²

10,845

3,300

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www.pinnacledrafting.com.au

Licence Number: CC6073 1:100 Pg. No:

A.02


Proposal: Government Housing Tender Client: Homes Tasmania Address: 1 Anear Court, Lutana - 7009

30/09/2025 Date: Drawn by: CJ & JRM Job No: 039-2025 Engineer: TBA Building Surveyor: TBA





DA-01 JN Approved by: Document Set ID: 3556947 Version: 2, Version Date: 18/11/2025

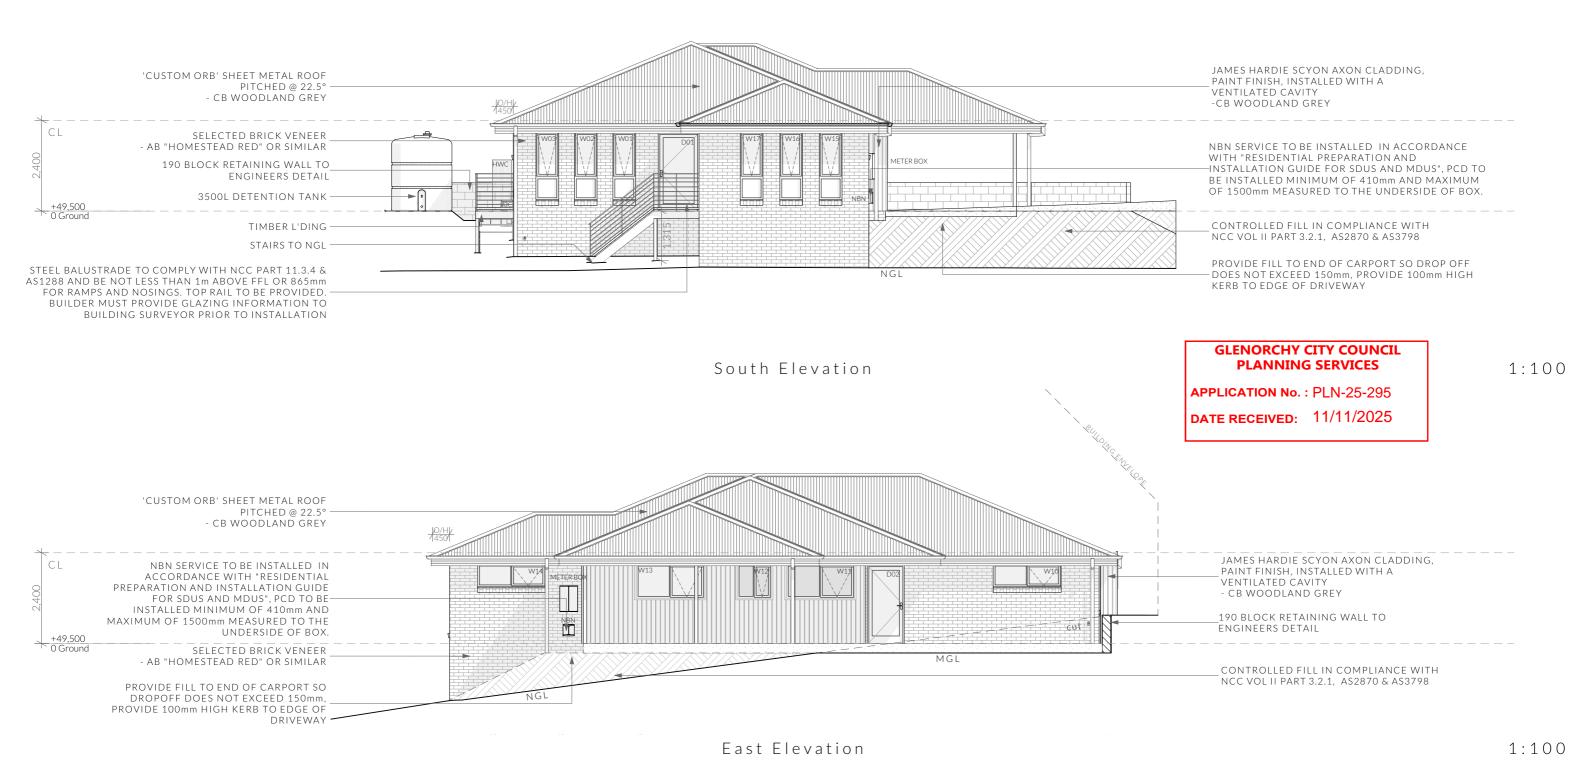

Clearances between cladding and ground shall comply with Clause 7.5.7 of the NCC 2022 and shall be a minimum clearance of:

100mm in low rainfall intensity areas or sandy, well-drained areas; or 50mm above impermeable areas that slope away from the building; or 150mm in any other case.

Wall cladding must extend a minimum of 50 mm below the bearer or lowest horizontal part of the suspended floor framing.

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U.N.O in builders specifications or located in saline environments or if using a glazed finish brick, brickwork is to be installed in stretcher bond pattern with raked joints.

Openable windows greater than 4m above ground level are to be fitted with a device to limit the opening or a suitable screen so a 125mm sphere cannot pass through, and withstand a force of 250N. Except for bedrooms, where the requirement is for heights above 2m.

All stairs to be constructed in accordance with NCC 2022 Vol II Part 11.2.2

Riser: Min 115mm - Max 190mm Going: Min 240mm - Max 355mm PINNACLE DRAFTING & DESIGN PINNACLE 03 6248 4218

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Elevations Revision:

Approved by:

DA - 01

Slope (2R+G): Max 550 - Min 700

Scale: Proposal: Government Housing Tender 1:100 @ A3 Client: Homes Tasmania Pg. No: Address: 1 Anear Court, Lutana - 7009 A.03

Date: Drawn by: CJ & JRM Job No: 039-2025 Engineer: TBA

Building Surveyor: TBA

commencing any orders, works or requesting producing snop drawings.

ANY AND ALL DISCREPANCIES DISCOVERED BY OUTSIDE PARTIES ARE TO

BROUGHT TO THE ATTENTION OF PINNACLE DRAFTING & DESIGN PTY LTI

AS SOON AS PRACTICABLE. This document must be printed in colour. Pinnacle



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North Elevation

1:100

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Elevations

Revision: DA - 01 Approved by:

Slope (2R+G): Max 550 - Min 700

Scale: 1:100 @ A3 Pg. No: A.04

Proposal: Government Housing Tender Client: Homes Tasmania Address: 1 Anear Court, Lutana - 7009 Drawn by: CJ & JRM Job No: 039-2025 Engineer: TBA

Building Surveyor: TBA



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Ventilation of roof spaces NCC 2022 Part 10.8.3

A roof must have a roof space that-

(a)is located-

(i)immediately above the primary insulation layer;

(ii)immediately above sarking with a vapour permeance of not less than 1.14 µg/N.s, which is immediately above the primary insulation layer;

(iii)immediately above ceiling insulation; and (b) has a height of not less than 20 mm; and (c)is either-

(i)ventilated to outdoor air through evenly distributed openings in accordance with Table

(ii)located immediately underneath the roof tiles of an unsarked tiled roof.

Stormwater Notes

All gutters, downpipes and rain heads to be designed and installed in compliance with AS3500.3 & NCC 2022 Volume II Part 7.4.

Roofing Cladding

Roof cladding, flashings, cappings, roof sheeting and fixings are to be installed in accordance with NCC 2022 Volume II Part 7.2 for sheet roofing and Part 7.3 for tiled and shingle roofing.

Eaves & Soffit Linings

To comply with NCC 2022 Vol II Part 7.5.5 and where provided, external fibre-cement sheets and linings used as eaves and soffit linings must-

(a)comply with AS/NZS 2908.2 or ISO 8336; and (b) be fixed in accordance with Table 7.5.5 and Figure 7.5.5 using-

(i) 2.8×30 mm fibre-cement nails; or (ii) No. 8 wafer head screws (for 4.5 mm and 6 mm sheets only); or

(iii) No. 8 self embedding head screws (for 6 mm

Refer to table 7.5.5 for trimmer and fastener spacings.




(1) Ventilation openings are specified as a minimum free open area per metre length of the longest horizontal dimension of the roof.

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(2) For the purposes of this Table, high level openings are openings provided at the ridge or not more than 900 mm below the ridge or highest point of the roof space, measured vertically.



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Roof Plan Revision:

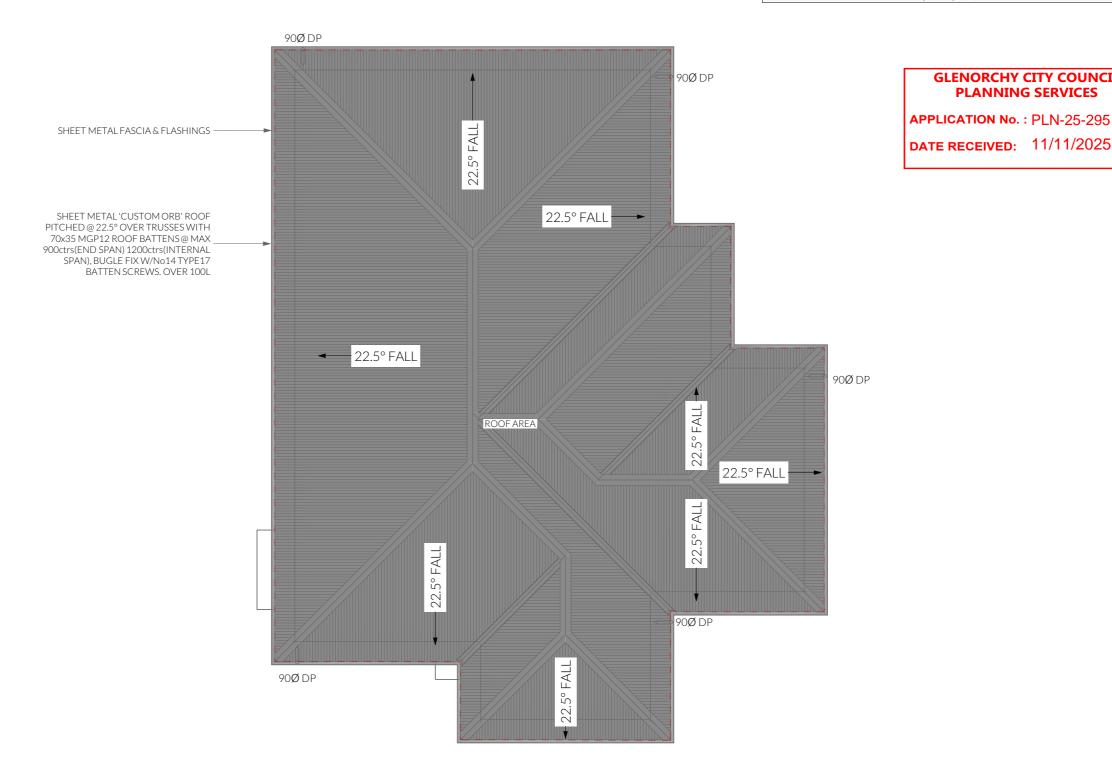Approved by:

DA - 01

JN

Scale: 1:100 @ A3 Pg. No: A.05

Proposal: Government Housing Tender Client: Homes Tasmania Address: 1 Anear Court, Lutana - 7009

Date: Drawn by: CJ & JRM Job No: 039-2025 Engineer: TBA

Building Surveyor: TBA



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