

#### **DEVELOPMENT APPLICATION**

**APPLICATION NUMBER:** PLN-25-027

**PROPOSED DEVELOPMENT:** Alterations and additions to public hall

(Community Meeting and Entertainment)

**LOCATION:** India House Community Centre 7 Lodge Street

Glenorchy

APPLICANT: Urban Space Designers


**ADVERTISING START DATE:** 07/11/2025


**ADVERTISING EXPIRY DATE:** 21/11/2025

Plans and documentation are available for inspection at Council's Offices, located at 374 Main Road, Glenorchy between 8.30 am and 5.00 pm, Monday to Friday (excluding public holidays) and the plans are available on Glenorchy City Council's website (<a href="www.gcc.tas.gov.au">www.gcc.tas.gov.au</a>) until 21/11/2025.

During this time, any person may make representations relating to the applications by letter addressed to the Chief Executive Officer, Glenorchy City Council, PO Box 103, Glenorchy 7010 or by email to <a href="mailto:gccmail@gcc.tas.gov.au">gccmail@gcc.tas.gov.au</a>.

Representations must be received by no later than 11.59 pm on **21/11/2025**, or for postal and hand delivered representations, by 5.00 pm on **21/11/2025**.

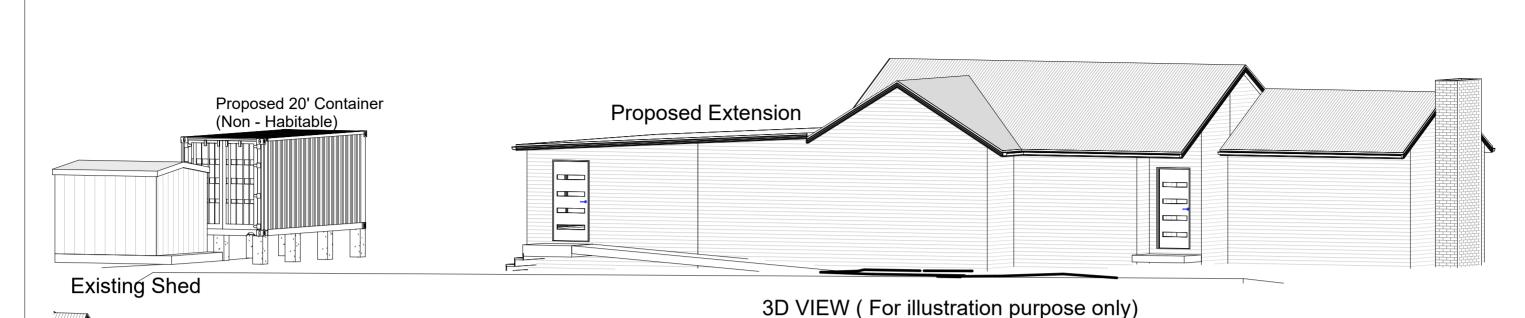

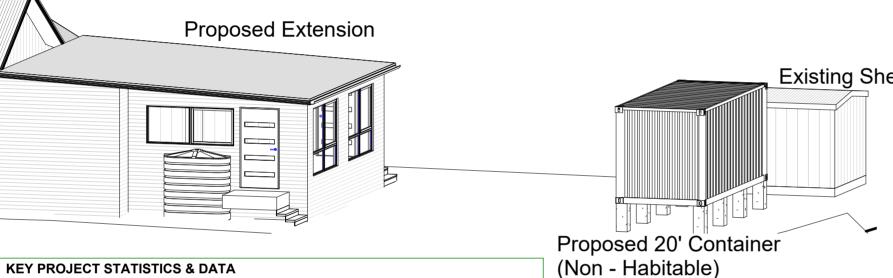

**KEY PROJECT STATISTICS & DATA** LOCATION: 7 LODGE STREET, GLENORCHY TAS - 7010

Property description:

Title Volume: 131102 Folio:

616.00Sqm Lot Area:

**AREAS** 

SITE AREA: 616.00 sqm **GREEN AREA:** 43.66% 269.00sqm **CONCRETE AREA:** 16.72% 103.00sqm **CAR PARKING:** 50.00sqm 08.12%

**EXISTING BUILDING + SHED:** 132.50sqm + 9.00sqm

PROPOSED BUILDING + CONTAINER: 37.50sqm + 15.00sqm TOTAL BUILDING FOOTPRINT: 194.00sqm

PLINTH LEVEL OF PROPOSED BUILDING: 14.60TO ENSURE THAT RISK FROM

RIVERINE FLOODING IS APPROPRIATELY MANAGED THE NEW STRUCTURE WILL **REQUIRE A FLOOR LEVEL AT MINIMUM AHD OF 14.60 METRES** 

	Existing Shed
0	
osed 20' Containe	er

FINISHES		
Exterior Walls	Weatherboard	
Windows	Aluminium Glazed - Shale Gree	
Gutter/ Fascia/ Fence	Colorbond Corrugated	
Roof	Colorbond Corrugated	
Design Components		
Proposed Single Storey Extension to Existing at the real		
Proposed 20' Container at the rear		
NOTES:		
All Bathrooms, Ensuite and Laundry windows are to be Obscure Glass.		
All internal doors are standard. The reflectivity index used in the External Facade of the Building not to exceed 20%.		
Eaves vents should be evenly spaced.		

Sheet List			
Sheet Number	Sheet Name	Current Revision	
A01	COVER SHEET	2	
A02	SITE PLAN	2	
A03	DIMENSION PLAN	2	
A04	ELEVATIONS	2	
A05	ELEVATIONS	2	
A06	ROOF PLAN	2	
A11	SERVICE PLAN	2	
A12	SHADOWS 21ST JUNE	2	
A13	SHADOWS 21ST JUNE	2	

THIS PLAN ACCEPTED BY: PLEASE NOTE; NO VARIATIONS WILL BE ACCEPTED ON THIS PLAN AFTER SIGNING SIGNATURE: DATE:



0402438170

info@urbanspacedesigners.com.

www.urbanspacedesigners.com.a

Accreditation: TAS - 381246362 VIC - DP-AD 72846

purpose. Verify all dimensions and levels on site and report any discrepancies tourban Space Designers for direction prior to the commencement of work. Drawings to be read in conjunction with all other contract documents. Use figured dimensions only. **Do not scale from drawings**.

31.50%

The completion of the issued details checked and authorized section below is confirmation of the status of the drawing The drawing shall not be used for the construction unless endorsed "for construction" and authorized for issue.

Read these drawings in conjunctions with drawings prepared by USD. Refer any discrepancies with the architect before

proceeding with any building works.

The drawing is prepared as built and strict instructions to builders to have a physical measurement before ref drawing and inform USD if there are any gaps in dimensions.

Indian Society of Tasmania Inc.


Extension to Existing Building & Addition of Caretaker's Room

7 Lodge Street, Glenorchy, TAS - 7010

Revisions	DRAWINGS	
Issue Name	Date	CHECK all dimensions and mea
aretaker room revised to ground floor		
aretaker room removed. 20'Storage	14/10/2025	prior to fabrication and or con
ontainer placed at the rear.		Dimensions are in millimeters
		and do not allow for interior li
		ALL work in Accordance with T


easurements on site nstruction. "frame to frame The Building Code Australia (BCA) as amended, relevant Australian Standards (AS) Codes and good building practice Drawings to be read in conjunction with specifications and schedules.

Sheet: **COVER SHEET** Drawn: GK Date: 29/10/2024 7-LS/Glenorchy/Arch/30032021

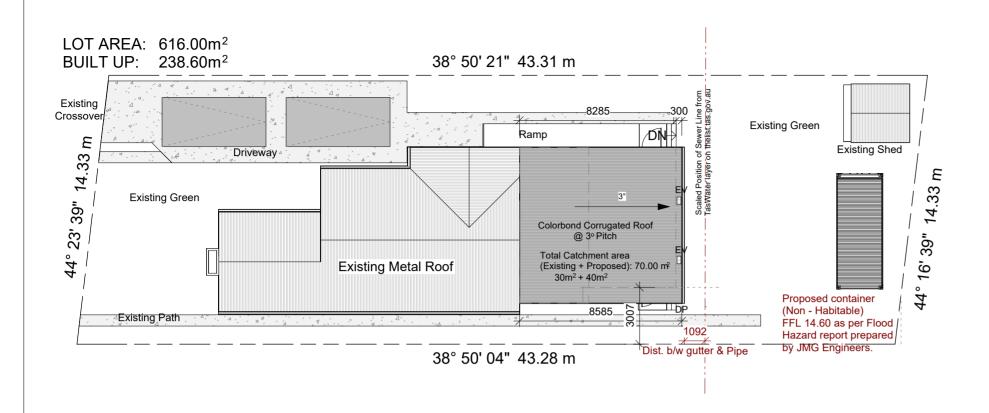

#### SITE PLAN

1:200

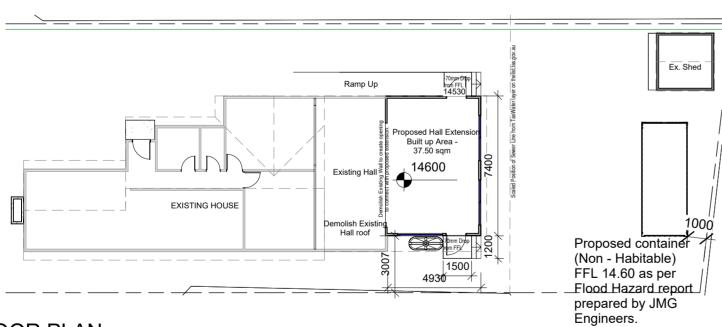

### FLOOR PLAN

1:200

# 0402438170

info@urbanspacedesigners.com

www.urbansp

**Accreditation** TAS - 381246362 VIC - DP-AD 72846 purpose. Verify all dimensions and levels on site and report any discrepancies to Urban Space Designers for direction prior to the commencement of work. Drawings to be read in conjunction with all othe figured dimensions only. **Do not scale from drawings.** 

USD cannot guarantee the accuracy of content and format for copies of drawings issued electron The completion of the issued details checked and authorized section below is confirmation of the status of the drawing The drawing shall not be used for the construction unless endorsed "for construction" and author Read these drawings in conjunctions with drawings prepared by USD. Refer any discrepancies with the architect before

proceeding with any building works.
The drawing is prepared as built and strict instructions to builders to have a physical drawing and inform USD if there are any gaps in dimensions

Indian Society of Tasmania Inc.

Extension to Existing Building & Addition of Caretaker's Room

7 Lodge Street, Glenorchy, TAS - 7010

#### **Surface Water Drainage**

Ground to fall away from building in all Directions in compliance with AS2870 & N.C.C 2022 3.3.3.


Surface water must be diverted away from a Class 1 building as follows: (a) Slab-on -ground - Finished ground level adjacent to a building: the external finished surface surrounding the slab must be drained to move surface water away from the building and graded to give a slope of not less than


- (i) 25 mm over the first 1m from the building
- (A) in low rainfall intensity areas for surfaces that are reasonably impermeable (such as concrete or clay paving); or
- (B) for any reasonably impermeable surface that forms part of an access path or ramp provided for the purposes of Clauses 1.1 (2) or (4)(c) of the ABCB Standard for Livable Housing Design; or
- (ii) 50 mm over the first 1m from the building in any other case.
- (b) Slab-o n -ground finished slab heights: the height of the slab-on ground above external finished surfaces must not be less than:
- (i) 100 mm above the finished ground level in low rainfall intensity areas or sandy, well drained areas; or
- (ii) 50 mm above impermeable (paved or concrete) areas that slope away from the building in accordance with(a); or
- (iii) 150 mm in any other case.
- (c) The ground beneath suspended floors must be graded so that the area beneath the building is above the adjacent external finished ground level and surface water is prevented from ponding under the building.

#### **Subsoil Drainage**

To comply with AS2870, AS3500 & N.C.C 2022 3.3.4. Where a subsoil drainage system is installed to divert subsurface water away from the area beneath a building, the subsoil drain must-

- (a) be graded with a uniform fall of not less than 1:300; and
- (b) discharge into an external silt pit or sump with-
- (i) the level of discharge from the silt pit or sump into an impervious drainage line not less than 50 mm below the invert level of the inlet; and provision for cleaning and maintenance.

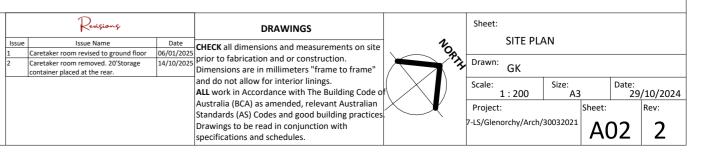

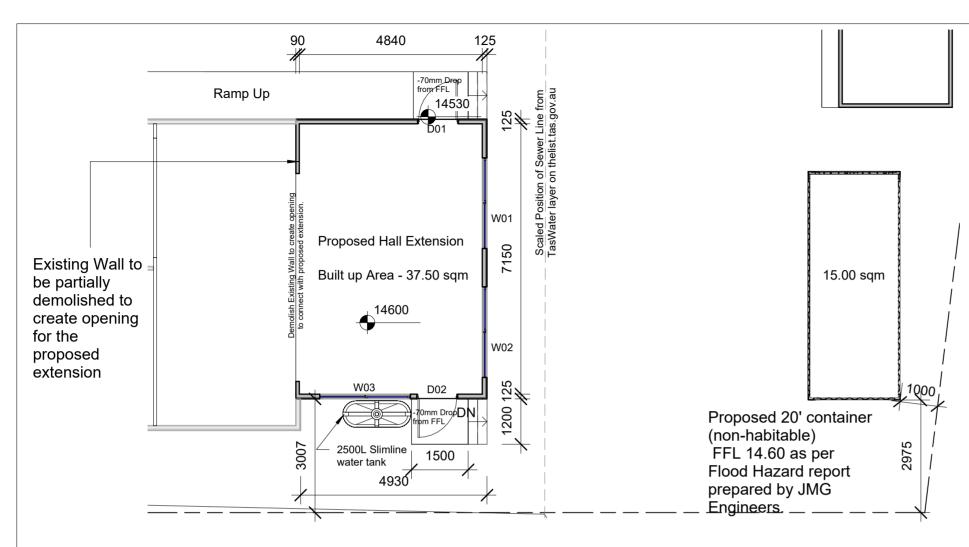

### **GROUND FLOOR PLAN**

1 · 100

Generally Demolition works must be carried out in Accordance with AS 2601 - 2001: Demolition of Structures & Regulations

29. 30 & 31 of the Building Regulations (TAS) 2016.

Buildings prior to 1990 MAY contain asbestos. Buildings prior to 1986 ARE LIKELY to contain Asbestos either in Cladding

material or in Fire retardant insulation material. The Builder should check & if necessary, take appropriate action before

demolishing, cutting, sanding, drilling or otherwise disturbing the existing structure.

Procedures and methods of Demolition must be adequate to prevent injury to persons & avoid damage to neighboring property.

Before removing existing wall shown to be demolished, Builder shall confirm on - site whether they are Load bearing or not. If

it is found to be Load - Bearing, a structural Engineer must be engaged to determine any beams required to support these loads.

All redundant stormwater, sewer and water connections associated with the demolition shall be cut & sealed to the satisfaction

of council's Senior Plumbing Inspector.

The removal of existing plumbing fixtures shall include all associated waste & vent pipes, Floor Drains,

pipework brackets, support etc. & seal off existing services, seal off & make good all floor, wall & roof penetrations

Generally, make good to existing floors, walls, & ceilings where all demolition work occurs to match existing as & where

required.

#### Heights of rooms & other spaces 10.3.1 of NCC 2022

Heights of rooms and other spaces must not be less than;

- in a habitable room excluding a kitchen 2.4 m; and
- (b) in a kitchen - 2.1 m; and
  - in a corridor, passageway or the like 2.1 m; and
- (d) in a bathroom, shower room, laundry, sanitary compartment, airlock, pantry, storeroom, garage, car parking area or the like - 2.1 m; and
- (e) in a room or space with a sloping ceiling or projections below the ceiling line within - See NCC directly for these items
- in a stairway, ramp, landing, or the like 2.0 m measured vertically above the nosing line of stairway treads or the floor surface of a ramp, landing or the like. If required onsite, the builder may work within the tolerances of the above as specified within the NCC 2022 Vol II. Builder to contact USD before undertaking works.

#### Construction of Sanitary Compartments 10.4.2 of NCC 2022 compartments 10.4.2 of NCC 2022

The door to a fully enclosed sanitary compartment must -

- open outwards; or
- slide: or

(c)

be readily removable from the outside of the compartment.

unless there is a clear space of at least 1.2 m, measured in accordance with Figure 1 0.4.2 of NCC 2022 Vol II, between the closet pan within the sanitary compartment and the doorway.

#### **Note: Safe Movement & Egress**

Openable windows greater than 4 m above the surface below are to be fitted with a device to limit opening or a suitable screen so a 125 mm sphere cannot pass through. Except for Bedrooms, where the requirement is for heights above 2m. Refer to clauses 11.3.7 and 11.3.8 of NCC 2022 for further information.

#### **Note: Paved Areas**

All paths and patios to fall away from the building.

#### **Note: Stair Construction**

All stairs to be constructed in accordance with NCC Vol II 2022 Part 11.2.2:

Riser: Min 115 mm - Max 190mm Going: Min 240 mm - Max 355m m Slope (2R + G ): Max 550 - Min 700

For stairways serving non-habitable room used infrequently, refer to table 1 1 .2 .2 (b). Landings to comply with Clause 1 1 .2 .5 and be a minimum of 750 mm deep measured

500 mm from the inside edge of the landing.

Slip resistance of treads, nosings and ramps to comply with Clause 11.2.4.

#### WINDOWS:

- Windows to be Aluminium framed Awning unless otherwise.
- All windows to be fabricated and installed in Accordance with AS1288 and AS2047 to be specific wind speed as per Engineer's report.
- Glazings and Frames to comply with AS2047 & AS1288
- OG Window Obscure Glass with a uniform transparency of 25%, in accordance with requirements of Interim Planning Scheme 2015.

NOTE: Contractor to confirm all Windows Dimensions on site and review with client before fabrication.



## 0402438170

info@urbanspacedesigners.com.

www.urbanspacedesigners.com.

Accreditation TAS - 381246362 VIC - DP-AD 72846 purpose. Verify all dimensions and levels on site and report any discrepancies to Urban Space Designers for direction prior to the commencement of work. Drawings to be read in conjunction with all other contract doc figured dimensions only. **Do not scale from drawings.** 

USD cannot guarantee the accuracy of content and format for copies of drawings issued electronically

The completion of the issued details checked and authorized section below is confirmation of the status of the drawing The drawing shall not be used for the construction unless endorsed "for construction" and authorized for issue.

Read these drawings in conjunctions with drawings prepared by USD. Refer any discrepancies with the architect before

proceeding with any building works.

The drawing is prepared as built and strict instructions to builders to have a physical measurement before refe drawing and inform USD if there are any gaps in dimensions

Indian Society of Tasmania Inc.


Extension to Existing Building & Addition of Caretaker's Room


Address 7 Lodge Street, Glenorchy, TAS - 7010


Revisions Issue Name Caretaker room revised to ground floor 06/01/202 container placed at the rear

DRAWINGS Date CHECK all dimensions and measurements on site 14/10/2025 prior to fabrication and or construction Dimensions are in millimeters "frame to frame and do not allow for interior linings ALL work in Accordance with The Building Code Australia (BCA) as amended, relevant Australian Standards (AS) Codes and good building practice Drawings to be read in conjunction with

specifications and schedules

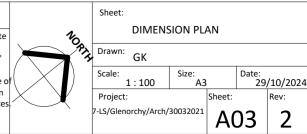

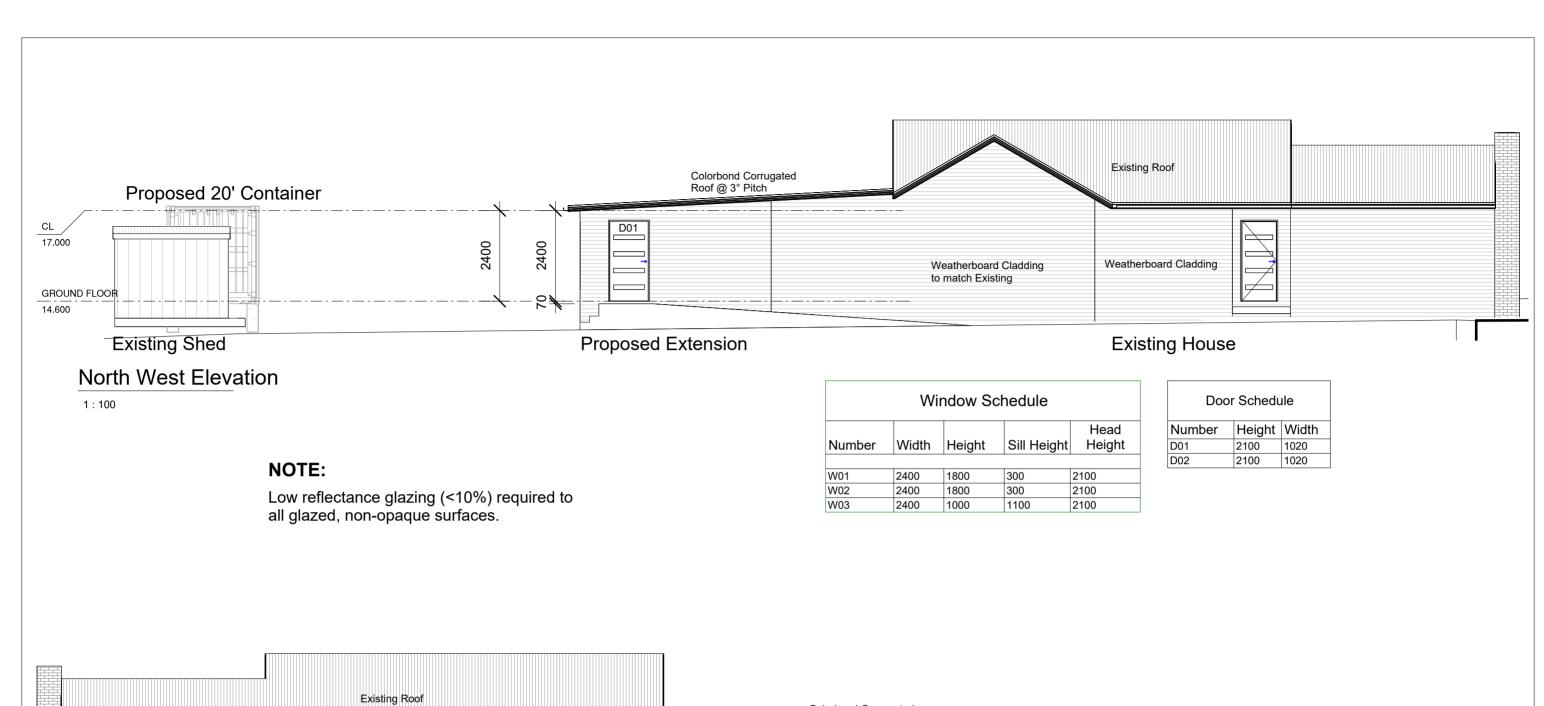

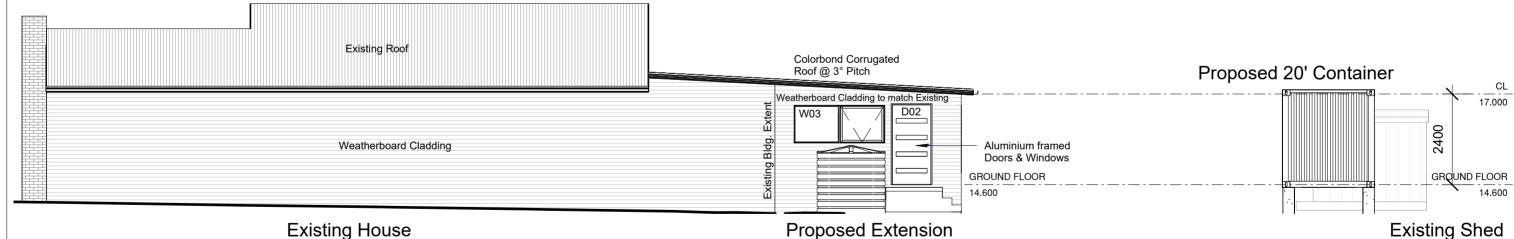

South East Elevation

**Proposed Extension** 

**Existing Shed** 

Fall Ground away from House a min. of 50mm over the first 1000mm in Accordance with AS2870, NCC 2022 Part 3.3.3 & Fig. 3.3.3a



1:100

0402438170

VIC - DP-AD 72846

info@urbanspacedesigners.com

www.urbanspacedesigners.com Accreditation: TAS - 381246362

purpose. Verify all dimensions and levels on site and report any discrepancies tourban Space Designers for direction prior to the commencement of work. Drawings to be read in conjunction with all other contract doci figured dimensions only. **Do not scale from drawings.** 

USD cannot guarantee the accuracy of content and format for copies of drawings issued electronically The completion of the issued details checked and authorized section below is confirmation of the status of the drawing The drawing shall not be used for the construction unless endorsed "for construction" and authorized for issue.

Read these drawings in conjunctions with drawings prepared by USD. Refer any discrepancies with the architect before

proceeding with any building works.

The drawing is prepared as built and strict instructions to builders to have a physical measurement before refe drawing and inform USD if there are any gaps in dimensions.


Indian Society of Tasmania Inc.

Extension to Existing Building & Addition of Caretaker's Room

7 Lodge Street, Glenorchy, TAS - 7010

Revisions **DRAWINGS** Issue Name CHECK all dimensions and measurements on site 14/10/2025 prior to fabrication and or construction. Caretaker room revised to ground floor 06/01/2025 Dimensions are in millimeters "frame to frame container placed at the rear. and do not allow for interior linings. ALL work in Accordance with The Building Code Australia (BCA) as amended, relevant Australian Standards (AS) Codes and good building practice Drawings to be read in conjunction with specifications and schedules.

Sheet: **ELEVATIONS** Drawn: GK Date: 29/10/2024 1:100 7-LS/Glenorchy/Arch/30032021

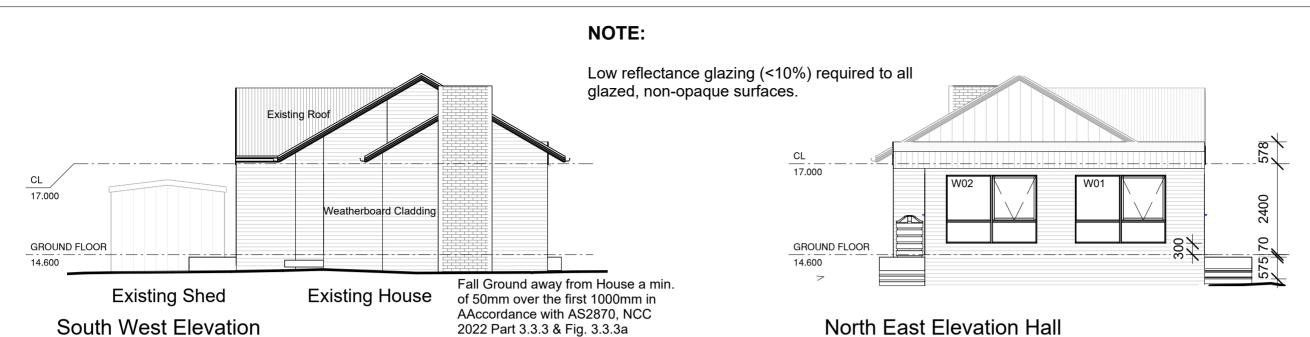


2022 Part 3.3.3 & Fig. 3.3.3a


## North East Elevation Hall

1:100

Door Schedule			
Number	Height	Width	
D01	2100	1020	
D02	2100	1020	

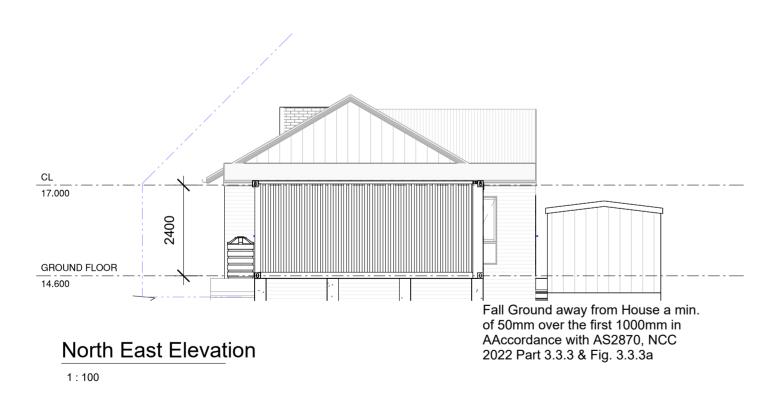

Window Schedule				
Number	Width	Height	Sill Height	Head Height
W01	2400	1800	300	2100
W02	2400	1800	300	2100
W03	2400	1000	1100	2100

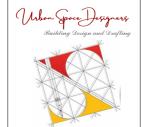

1:100

0402438170

TAS - 381246362

VIC - DP-AD 72846

info@urbanspacedesigners.com.

www.urbanspacedesigners.com.

Accreditation:

purpose. Verify all dimensions and levels on site and report any discrepancies tdurban Space Designers for direction prior to the commencement of work. Drawings to be read in conjunction with all other contract doci figured dimensions only. **Do not scale from drawings.** 

The completion of the issued details checked and authorized section below is confirmation of the status of the drawing The drawing shall not be used for the construction unless endorsed "for construction" and authorized for issue.

Read these drawings in conjunctions with drawings prepared by USD. Refer any discrepancies with the architect before

proceeding with any building works.

The drawing is prepared as built and strict instructions to builders to have a physical measurement before refe drawing and inform USD if there are any gaps in dimensions.


Indian Society of Tasmania Inc.

Extension to Existing Building & Addition of Caretaker's Room

7 Lodge Street, Glenorchy, TAS - 7010

Revisions			DRAWINGS
sue	Issue Name	Date	CHECK all dimensions and measurements on site
Car	retaker room revised to ground floor		
	retaker room removed. 20'Storage htainer placed at the rear.		prior to fabrication and or construction. Dimensions are in millimeters "frame to frame" and do not allow for interior linings. ALL work in Accordance with The Building Code Australia (BCA) as amended, relevant Australian Standards (AS) Codes and good building practice Drawings to be read in conjunction with specifications and schedules.

Sheet: **ELEVATIONS** Drawn: GK Date: 29/10/2024 7-LS/Glenorchy/Arch/30032021

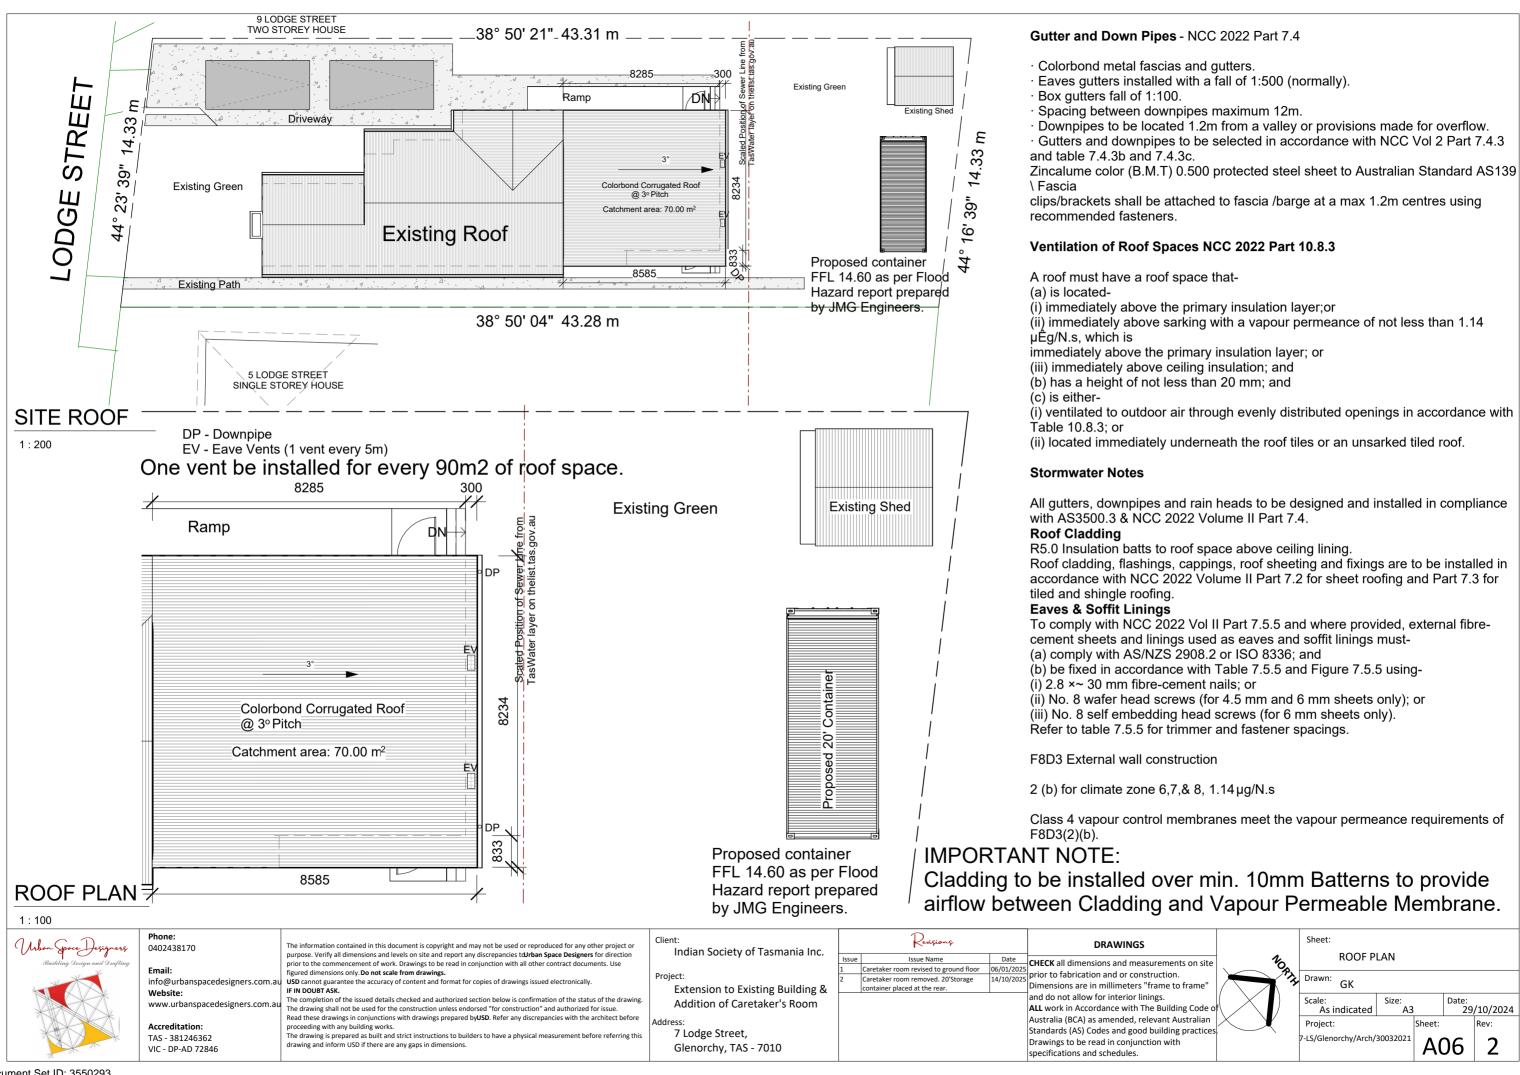

#### **Surface Water Drainage**

Ground to fall away from building in all Directions in compliance with AS2870 & N.C.C 2022 3.3.3

Surface water must be diverted away from a Class 1 building as follows:

- (a) Slab-on -ground Finished ground level adjacent to a building: the external finished surface surrounding the slab must be drained to move surface water away from the building and graded to give a slope of not less than
- (i) 25 mm over the first 1m from the building (A) in low rainfall intensity areas for surfaces that are reasonably impermeable (such as concrete or clay paving); or
- (B) for any reasonably impermeable surface that forms part of an access path or ramp provided for the purposes of Clauses 1.1 (2) or (4)(c) of the ABCB Standard for Livable Housing Design;
- (ii) 50 mm over the first 1m from the building in any other case.
- (b) Slab-o n -ground finished slab heights: the height of the slab-on -ground above external finished surfaces must not be less than: (i) 100 mm above the finished ground level in low rainfall intensity areas or sandy, well drained
- areas: or (ii) 50 mm above impermeable (paved or concrete) areas that slope away from the building in accordance with(a); or
- (iii) 150 mm in any other case.
- (c) The ground beneath suspended floors must be graded so that the area beneath the building is above the adjacent external finished ground level and surface water is prevented from ponding under the building.


#### **Subsoil Drainage**

To comply with AS2870, AS3500 & N.C.C 2022 3.3.4.

Where a subsoil drainage system is installed to divert subsurface water away from the area beneath a building, the subsoil drain must-

- (a) be graded with a uniform fall of not less than 1:300 ; and
- (b) discharge into an external silt pit or sump

(i) the level of discharge from the silt pit or sump into an impervious drainage line not less than 50 mm below the invert level of the inlet; and provision for cleaning and maintenance.

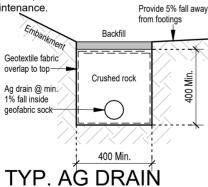

Wet areas shown hatched to comply with AS3740 & current N.C.C.


Sewer line 100Ø UPVC U.N.O. Stormwater line 100Ø UPVC U.N.O.

DRAINAGE LEGEND		
Abbreviation	Fixture	Min. Outlet Size (dia)
В	BASIN	40
втн	BATH 40	
SHR	SHOWER 40	
s	SINK 50	
TR	TROUGH 40	
wc	WATER 100 CLOSET PAN	
DP	DOWNPIPE 90	
TSB	TILED SPLASH BACK	
NOTES:		

WHERE DOWNPIPES ARE FURTHER THAN 1.2m AWAY FROM VALLEY REFER TO N.C.C. 7.3.5(2)

Waterproof Membrane not required below Pre - Formed Shower Bases, but still required at Penetrations (including floor waste)

Proposed DN100 uPVC SN8 stormwater per TSD-SW25-v3 with I.O. to surface. Works by Council approved contractor at developer's cost.

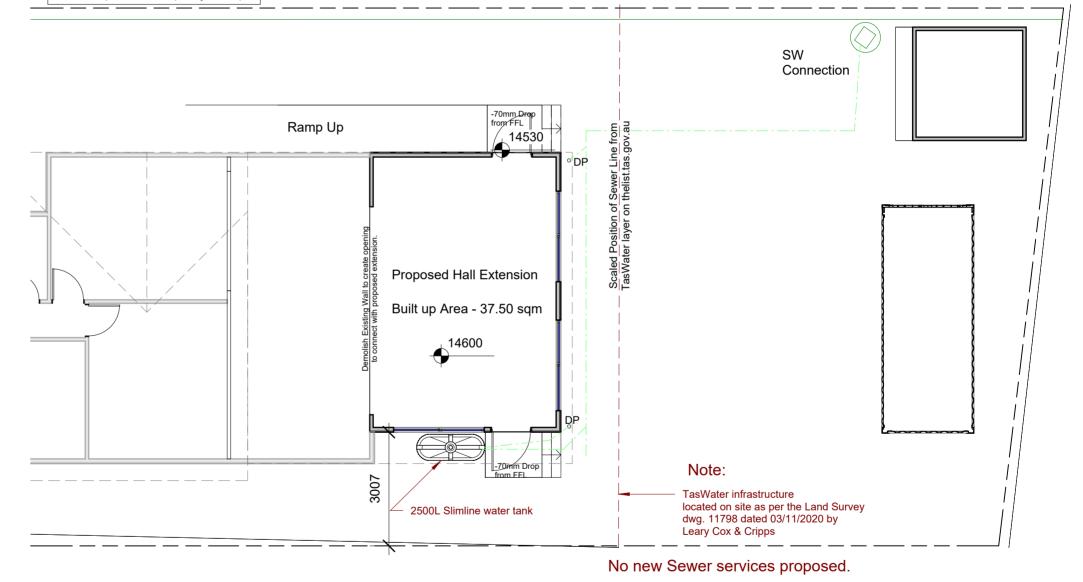

SERVICE PLAN

1:100

0402438170

info@urbanspacedesigners.com.

www.urbanspacedesigners.com.a

Accreditation: TAS - 381246362 VIC - DP-AD 72846

The information contained in this document is copyright and may not be used or reproduced for any other project of purpose. Verify all dimensions and levels on site and report any discrepancies tourban Space Designers for direction prior to the commencement of work. Drawings to be read in conjunction with all other contract doc figured dimensions only. **Do not scale from drawings.** 

USD cannot guarantee the accuracy of content and format for copies of drawings issued electronically

The completion of the issued details checked and authorized section below is confirmation of the status of the drawing The drawing shall not be used for the construction unless endorsed "for construction" and authorized for issue.

Read these drawings in conjunctions with drawings prepared by USD. Refer any discrepancies with the architect before proceeding with any building works.

The drawing is prepared as built and strict instructions to builders to have a physical measurement before referring this

drawing and inform USD if there are any gaps in dimensions

Indian Society of Tasmania Inc.


Extension to Existing Building & Addition of Caretaker's Room

Address: 7 Lodge Street, Glenorchy, TAS - 7010


Revisions Issue Name Caretaker room revised to ground floor 06/01/2025 container placed at the rear

DRAWINGS Date CHECK all dimensions and measurements on site

14/10/2025 prior to fabrication and or construction Dimensions are in millimeters "frame to frame and do not allow for interior linings. ALL work in Accordance with The Building Code Australia (BCA) as amended, relevant Australian Standards (AS) Codes and good building practice Drawings to be read in conjunction with specifications and schedules.

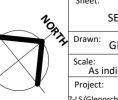


Sheet: Drawn: GK SERVICE PLAN Date: 29/10/2024 As indicated 7-LS/Glenorchy/Arch/30032021

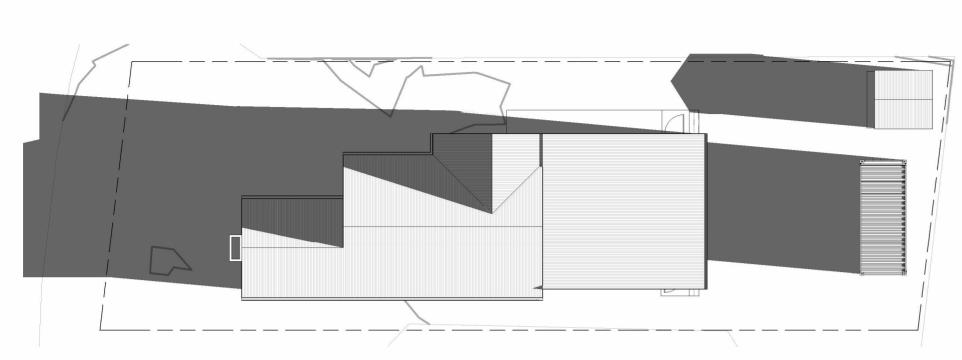

# **SHADOW 9AM**

1:200

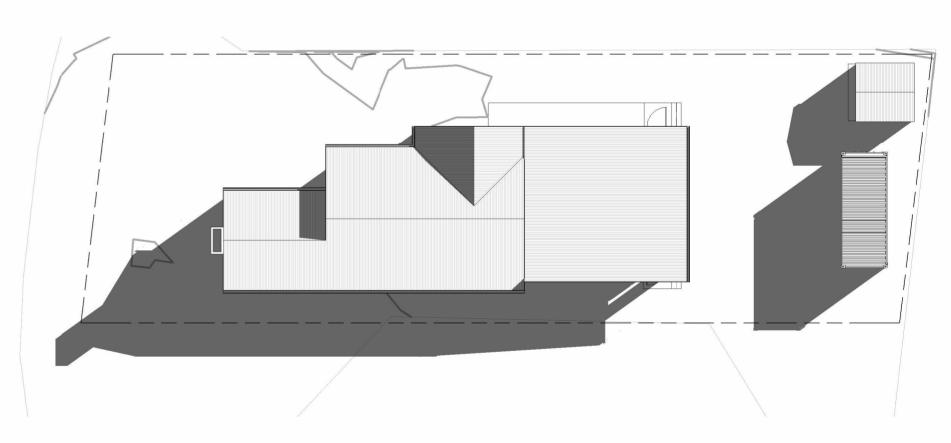

# SHADOW 12PM

1:200



Phone: 0402438170

info@urbanspacedesigners.com.a Website:

www.urbanspacedesigners.com.a

Accreditation: TAS - 381246362 VIC - DP-AD 72846

ne information contained in this doctiment is copyright and may not be used or reproduced for any other project or purpose. Verify all dimensions and levels on site and report any discrepancies turban Space Designers for direction prior to the commencement of work. Drawings to be read in conjunction with all other contract documents. Use figured dimensions only. Do not scale from drawings. USD cannot guarantee the accuracy of content and format for copies of drawings issued electronically. IF IN DOUBT ASK.

IF IN DOUBT ASK.

The completion of the issued details checked and authorized section below is confirmation of the status of the drawing. The drawing shall not be used for the construction unless endorsed "for construction" and authorized for issue. Read these drawings in conjunctions with drawings prepared by USD. Refer any discrepancies with the architect before proceeding with any building works.

The drawing is prepared as built and strict instructions to builders to have a physical measurement before referring this drawing and inform USD if there are any gaps in dimensions.

Indian Society of Tasmania Inc.

Extension to Existing Building & Addition of Caretaker's Room

Address: 7 Lodge Street, Glenorchy, TAS - 7010

Revisions		DRAWINGS
Issue Name	Date	CHECK all dimensions and measurements on site
etaker room revised to ground floor	06/01/2025	and the false is a second and the assurements on site
etaker room removed. 20'Storage	14/10/2025	prior to fabrication and or construction.
tainer placed at the rear.		Dimensions are in millimeters "frame to frame"
	and do not allow for interior linings.	
		ALL work in Accordance with The Building Code of

Australia (BCA) as amended, relevant Australian


Standards (AS) Codes and good building practices

Drawings to be read in conjunction with specifications and schedules.

Sheet: Drawn: GK SHADOWS 21ST JUNE

Scale:

Date: 29/10/2024 1:200 7-LS/Glenorchy/Arch/30032021

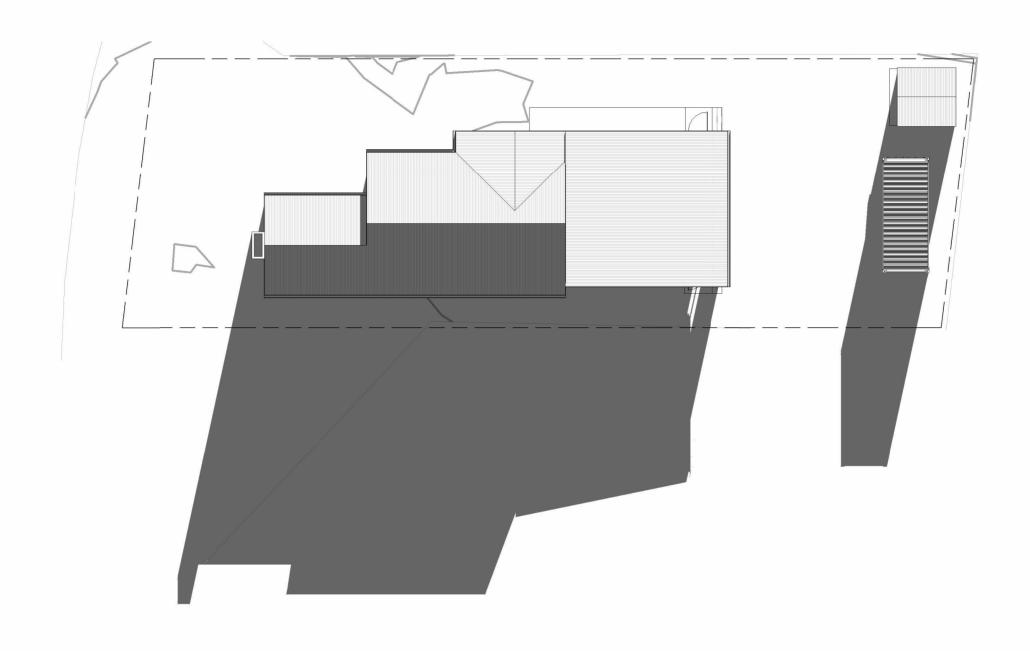

# SHADOW 3PM

1:200



0402438170

info@urbanspacedesigners.com.a Website:

www.urbanspacedesigners.com.a Accreditation: TAS - 381246362 VIC - DP-AD 72846

purpose. Verify all dimensions and levels on site and report any discrepancies **td/rban Space Designers** for direction prior to the commencement of work. Drawings to be read in conjunction with all other contract documents. Use figured dimensions only. **Do not scale from drawings.** 

USD cannot guarantee the accuracy of content and format for copies of drawings issued electronically.

IF IN DOUBT ASK.

The completion of the issued details checked and authorized section below is confirmation of the status of the drawing. The drawing shall not be used for the construction unless endorsed "for construction" and authorized for issue. Read these drawings in conjunctions with drawings prepared by USD. Refer any discrepancies with the architect before proceeding with any building works.

The drawing is prepared as built and strict instructions to builders to have a physical measurement before referring this drawing and inform USD if there are any gaps in dimensions.

Indian Society of Tasmania Inc.

Extension to Existing Building & Addition of Caretaker's Room

Glenorchy, TAS - 7010

Address: 7 Lodge Street,

Revisions Caretaker room revised to ground floor Caretaker room removed. 20'Storage container placed at the rear.

Caretaker room removed. 20'Storage container placed at the rear.

CHECK all dimensions and measurements on site prior to fabrication and or construction. Dimensions are in millimeters "frame to frame"

**DRAWINGS** 

Drawings to be read in conjunction with specifications and schedules.

and do not allow for interior linings. ALL work in Accordance with The Building Code of

Australia (BCA) as amended, relevant Australian Standards (AS) Codes and good building practices

Sheet: Drawn: GK SHADOWS 21ST JUNE

Date: 29/10/2024 Scale: 1:200 7-LS/Glenorchy/Arch/30032021

