

DEVELOPMENT APPLICATION

APPLICATION NUMBER: PLN-25-293

PROPOSED DEVELOPMENT: Dwelling

LOCATION: 116A Branscombe Road Claremont

APPLICANT: Wilson Homes Tasmania Pty Ltd

ADVERTISING START DATE: 05/12/2025

ADVERTISING EXPIRY DATE: 19/12/2025

Plans and documentation are available for inspection at Council's Offices, located at 374 Main Road, Glenorchy between 8.30 am and 5.00 pm, Monday to Friday (excluding public holidays) and the plans are available on Glenorchy City Council's website (www.gcc.tas.gov.au) until 19/12/2025.

During this time, any person may make representations relating to the applications by letter addressed to the Chief Executive Officer, Glenorchy City Council, PO Box 103, Glenorchy 7010 or by email to gccmail@gcc.tas.gov.au.

Representations must be received by no later than 11.59 pm on 19/12/2025, or for postal and hand delivered representations, by 5.00 pm on 19/12/2025.

ABN 19 753 252 493

SHEET INDEX

COVER SHEET SITE PLAN DRIVEWAY PLAN SOIL & WATER MANAGEMENT PLAN GROUND FLOOR PLAN ELEVATIONS / SECTION ELEVATIONS WINDOW & DOOR SCHEDULES CALCULATIONS **DETAILS - FACE BRICKWORK** ROOF DRAINAGE PLAN FLOOR COVERINGS KITCHEN DETAILS **BATHROOM DETAILS** WC DETAILS **ENSUITE DETAILS ENSUITE (IN BED 4) DETAILS** LAUNDRY DETAILS 3D VIEWS **GENERAL NOTES** WET AREA & ENERGY EFFICIENCY NOTES 21

BUILDING INFORMATION

GROUND FLOOR TOP OF WALL HEIGHT(S): 2595mm (CEILING HEIGHT 45mm LOWER THAN TOP OF WALL) ROOF PITCH (U.N.O.): ELECTRICITY SUPPLY: SINGLE PHASE GAS SUPPLY: NONE

ROOF MATERIAL SHEET METAL ROOF COLOUR: DARK

WALL MATERIAL: BRICK VENEER

INSULATION

INSULATION TO BE INSTALLED IN ACCORDANCE WITH N.C.C. AND RELEVANT AUSTRALIAN STANDARDS

SARKING UNDER ROOFING

CEILING: R4.1 BATTS (EXCL. GARAGE, ALFRESCO & PATIO)

EXTERIOR WALLS: R2.0 BATTS (EXCL. GARAGE) WALL WRAP TO ENTIRE HOUSE

INTERIOR WALLS: R2.0 BATTS WHERE SHOWN ON PLANS AND WHERE ADJACENT TO GARAGE / SUBFLOOR / ROOF SPACES / SKYLIGHTS

B&J WITH AIRCELL

FLOOR INSULATION: R2.0 BATTS TO FLOOR SPACES ABOVE PORCH /ALFRESCO / GARAGE AREAS, IF APPLICABLE

SITE & ENGINEERING INFORMATION

DESIGN WIND CLASSIFICATION:

CLIMATE ZONE: **ZONE 7 - COOL TEMPERATE**

WIND REGION: TERRAIN CATEGORY: TC2.5

SHIELDING FACTOR: PS - PARTIAL SHIELDING

TOPOGRAPHIC CLASSIFICATION: T2 **DESIGN WIND SPEED:** 50 m/sec

SITE CLASSIFICATION: SLAB CLASSIFICATION: TBC

SLAB TO BE IN ACCORDANCE WITH AS 2870. REFER TO ENGINEER'S DRAWINGS FOR ALL SLAB DETAILS.

PROVIDE BRICK CONTROL JOINTS IN ACCORDANCE WITH N.C.C.

ALL TIMBER FRAMING TO BE DESIGNED TO AS1684-2010


PROVIDE ALUMINIUM DOOR JAMBS TO ALL EXTERNAL TIMBER DOORS

NCC 2022 LIVABLE HOUSING COMPLIANCE


ACCESSIBLE SANITARY COMPARTMENT: WC ACCESSIBLE SHOWER LOCATION: BATH

GENERAL NOTES:

- THRESHOLD OF ACCESSIBLE SHOWER ENTRY TO BE MAX.5MM
- 1 EXTERIOR DOOR NOMINATED AS 870 OR GREATER TO ACHIEVE MIN 820MM CLEAR OPENING
- REFER TO APPLICABLE WET AREA PLANS AND INTERIOR **ELEVATIONS OR LOCATIONS OF REQUIRED WALL** REINFORCEMENT FOR FUTURE GRAB RAIL INSTALLATION.

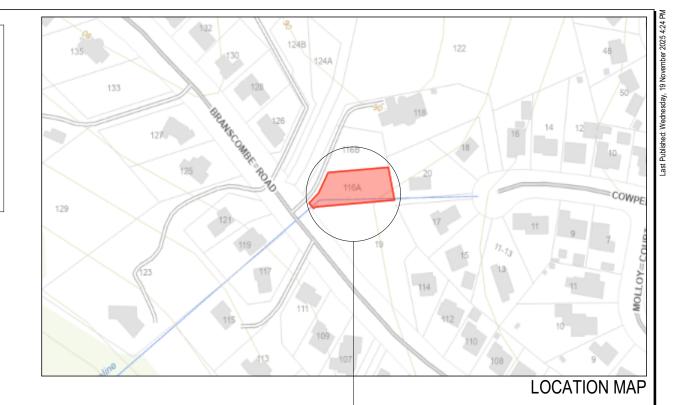

SITE LOCATION-

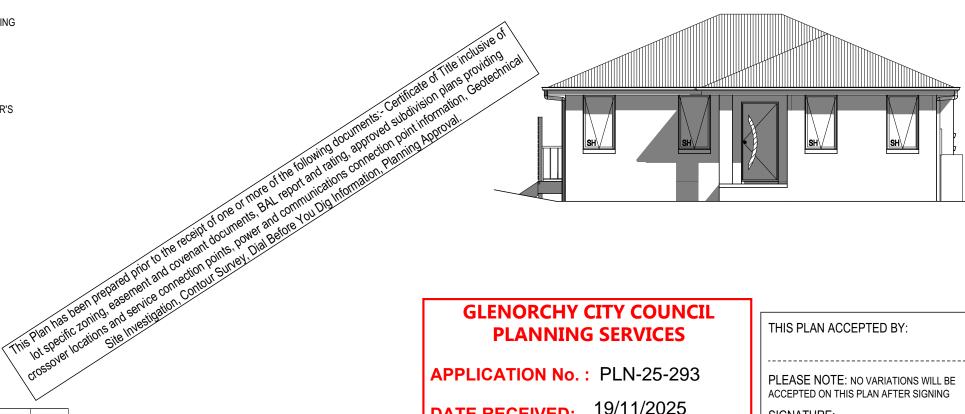

GLENORCHY CITY COUNCIL PLANNING SERVICES

APPLICATION No.: PLN-25-293

DATE RECEIVED: 19/11/2025

THIS PLAN ACCEPTED BY:

PLEASE NOTE: NO VARIATIONS WILL BE ACCEPTED ON THIS PLAN AFTER SIGNING

SIGNATURE:

DATE:

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PRELIMINARY PLAN SET

PRELIMINARY PLAN SET - PLANNING RFI UPDATE

PRELIMINARY PLAN SET - COLOUR UPDATE

PRELIMINARY PLAN SET - INITIAL ISSUE

AMENDMENT

DESIGNER

DRAWN REVISION HMI 2025.08.14 4 DRAFT SALE PLAN - CT2 HMI 2025.09.03 5 DRAFT SALE PLAN - CT3 6 PRELIM PLAN - INITIAL ISSUE NVO 2025.09.30 7 PRELIM PLANS - COLOUR UPDATE TNG 2025.10.28 8 PRELIM PLANS - PLANNING RFI UPDATE RT2 2025.11.18

ALL

ALL

ALL

SHEET

2025.11.19

2025.10.28

2025.09.30

DATE

RT2

TNG

NVO

DRAWN CHECK

PRATIK DHIRAJBHAI & KAJALBEY PRATIK DARJI ADDRESS 116A BRANSCOMBE ROAD, CLAREMONT TAS 7011 LOT / SECTION / CT: 1 / - / 183217 GLENORCHY COUNCIL

HOUSE DESIGN HOUSE CODE AMALFI ONE H-WDNAMF10SA FACADE DESIGN FACADE CODE: CLASSIC F-WDNAMF10CLASA SHEET TITLE SHEET No.: SCALES: **COVER SHEET** 1 / 21

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714360

ZONE: 8.0 GENERAL RESIDENTIAL .584km DISTANCE FROM BREAKING SURF (BEEDHAMS BAY

REFER TO SHEET 1 (COVER SHEET) FOR ALL BUILDING INFORMATION REGARDING: SUSTAINABILITY REQUIREMENTS


SITE CLASSIFICATION GENERAL BUILDING INFORMATION WIND CLASSIFICATION

WITHIN 1 KM. OF NO BREAKING SALT WATER WITHIN 100 M. OF SALT NO MINIMUM AHD FLOOR NO LEVEL APPLICABLE SURVEY AREA NEW LATITUDE 0° 00' 00" S LONGITUDE 0° 00' 00" E

APPROX. IMPORT/EXPORT FILL CUT VOLUME 17.13m 0.00m³ FILL VOLUME DIFFERENCE 17.13m

TONNAGE: 17.13m³ x 2.25 = 38.54t 39 TONNES OF EXPORT FILL

LOT SIZE: 761m² HOUSE (COVERED AREA) 172.92m² SITE COVERAGE: 22.72%

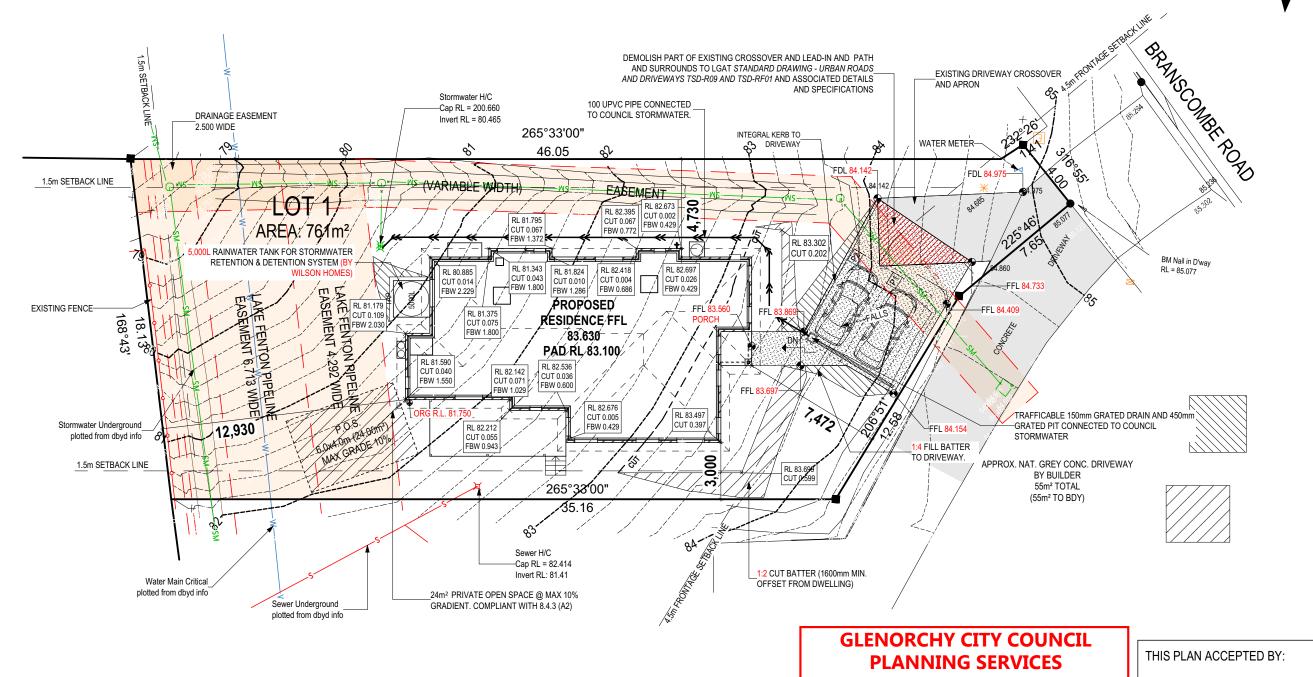

DESIGNER

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DRAWN 4 DRAFT SALE PLAN - CT2 HMI 2025.08.14 5 DRAFT SALE PLAN - CT3 HMI 2025.09.03 6 PRELIM PLAN - INITIAL ISSUE NVO 2025.09.30 7 PRELIM PLANS - COLOUR UPDATE TNG 2025.10.28 8 PRELIM PLANS - PLANNING RFI UPDATE RT2 2025.11.18

PRATIK DHIRAJBHAI & KAJALBEY PRATIK DARJI 116A BRANSCOMBE ROAD, CLAREMONT TAS 7011 LOT / SECTION / CT: 1 / - / 183217 GLENORCHY COUNCIL

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APPLICATION No.: PLN-25-293

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SIGNATURE:

DATE:

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116A BRANSCOMBE ROAD, CLAREMONT TAS 7011

GLENORCHY COUNCIL

NVO 2025.09.30

TNG 2025.10.28

RT2 2025.11.18

LOT / SECTION / CT:

1 / - / 183217

6 PRELIM PLAN - INITIAL ISSUE

7 PRELIM PLANS - COLOUR UPDATE

8 PRELIM PLANS - PLANNING RFI UPDATE

CLASSIC

SHEET TITLE:

DRIVEWAY PLAN

AND VERIFY DIMENSIONS AND LEVELS PRIOR TO THE COMMENCEMENT OF ANY WORK. AL DISCREPANCIES TO BE REPORTED TO THE DRAFTING OFFICE. 714360

F-WDNAMF10CLASA

SHEET No.: SCALES:

1:100

3 / 21

ALL VEGETATION OUTSIDE THE BUILDING ZONE WILL BE MAINTAINED.

OWNER TO STABILISE THE SITE ON COMPLETION OF THE BUILD WITH TURF LAWNS, GRASS SEEDS, NATIVE GROUND COVERS AND/ OR MULCH SPREAD TO A DEPTH OF 75-100mm

THE FOLLOWING IS A STANDARD
APPROACH. SEDIMENT AND EROSION
CONTROL MEASURES WILL BE REVIEWED
PRIOR TO COMMENCING WORK AND
INSTALLED BASED ON THE OUTCOME OF
THAT REVIEW.


NOTES

1. ALL EROSION AND SEDIMENT CONTROL STRUCTURES TO BE INSPECTED EACH WORKING DAY AND MAINTAINED IN GOOD WORKING ORDER.

- 2. ALL GROUND COVER VEGETATION
 OUTSIDE THE IMMEDIATE BUILDING AREA
 TO BE PRESERVED DURING THE BUILDING
 PHASE
- 3. ALL EROSION AND SEDIMENT CONROL MEASURES TO BE INSTALLED PRIOR TO COMMENCEMENT OF MAJOR EARTHWORKS.
- 4. STOCKPILES OF CLAYEY MATERIAL TO BE COVERED WITH AN IMPERVIOUS SHEET. 5. ROOF WATER DOWNPIPES TO BE CONNECTED TO THE PERMAMENT UNDERGROUND STORMWATER DRAINAGE SYSTEM AS SOON AS PRACTICAL AFTER


THE ROOF IS LAID.


6. DIVERSION DRAINS ARE TO BE CONNECTED TO A LEAGAL DISCHARGE POINT (COUNCIL STORMWATER SYSTEM, WATERCOURSE OR ROAD DRAIN).
7. SEDIMENT RETENTION TRAPS INSTALLED AROUND THE INLETS TO THE STORMWATER SYSTEM TO PREVENT SEDIMENT & OTHER DEBRIS BLOCKING THE DRAINS.

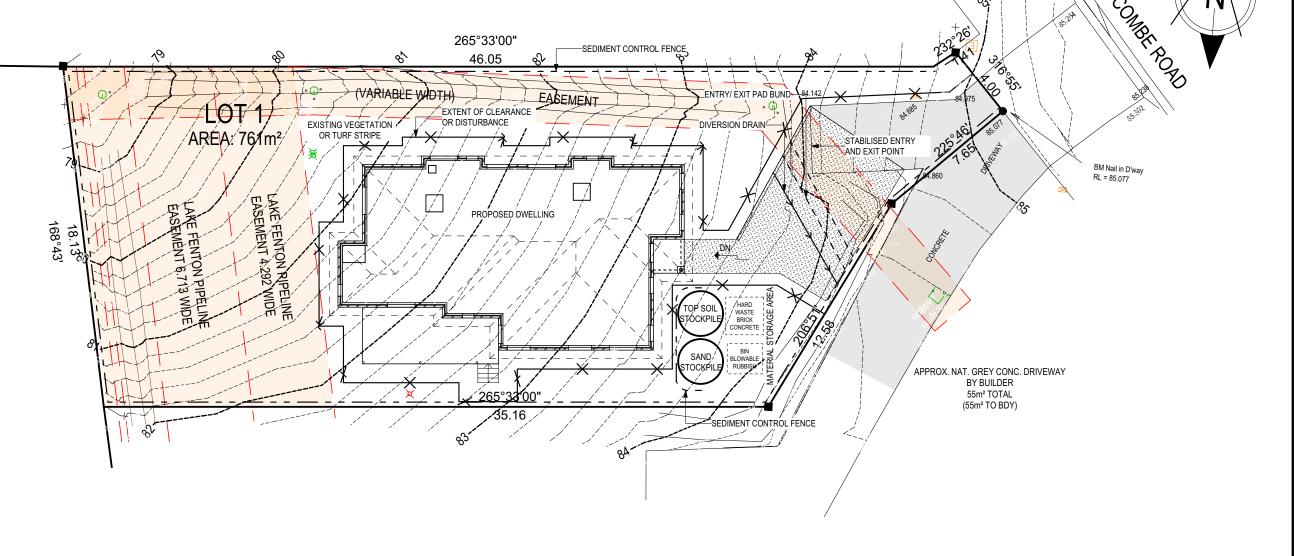


ALL RUNOFF AND SEDIMENT
CONTROL STRUCTURES WILL BE
INSPECTED EACH WORKING DAY
AND MAINTAINED IN A FUNCTIONAL
CONDITION.

ALL VEGETATION OUTSIDE THE BUILDING ZONE WILL BE MAINTAINED.

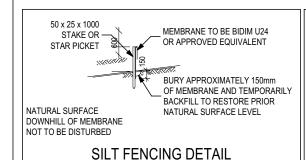

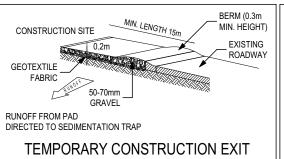

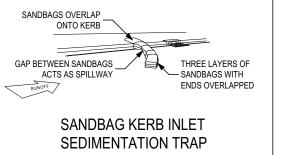

GLENORCHY CITY COUNCIL PLANNING SERVICES

APPLICATION No.: PLN-25-293

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	REVISION		RAWN
4	DRAFT SALE PLAN - CT2	НМІ	2025.08.14
5	DRAFT SALE PLAN - CT3	НМІ	2025.09.03
6	PRELIM PLAN - INITIAL ISSUE	NVO	2025.09.30
7	PRELIM PLANS - COLOUR UPDATE	TNG	2025.10.28
8	PRELIM PLANS - PLANNING RFI UPDATE	RT2	2025.11.18

	CLIENT:									
.14	PRATIK DHIRAJBHAI & KAJALBEY PRATIK DARJI									
.03	ADDRESS:									
.30	116A BRANSCOMBE RO	AD, CLAREMONT TAS 7011								
.28	LOT / SECTION / CT: COUNCIL:									
.18	1 / - / 183217 GLENORCHY COUNCIL									

WITER CONCERT OF WILCOTTHOMECT IT ETD.			
HOUSE DESIGN: AMALFI ONE		HOUSE CODE: H-WDNAMF10SA	
FACADE DESIGN:		FACADE CODE:	1
CLASSIC		F-WDNAMF10CLASA	
SHEET TITLE:	SHEET No.:	SCALES:	
SOIL & WATER MANAGEMENT PLAN	4 / 21	1:200	

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REFER TO SHEET 1 (COVER SHEET) FOR ALL BUILDING INFORMATION REGARDING: SUSTAINABILITY REQUIREMENTS SITE CLASSIFICATION
GENERAL BUILDING INFORMATION

CHARGED DOWNPIPE DIRECTED TO TANK STANDARD DOWNPIPE DIRECTED

TO STORMWATER DISCHARGE

FLASHING DETAIL' AND W-BRIC-001 FOR **BRICK COURSING & WINDOW FLASHING**

ALL GROUND FLOOR BULKHEAD AND SQUARE SET OPENING FRAMES TO BE 2155 ABOVE FFL UNLESS NOTED OTHERWISE

REFER TO WINDOW & DOOR SCHEDULES FOR FULL DETAILS OF ALL WINDOWS AND

FINAL WINDOW AND EXTERIOR DOOR LOCATIONS MAY BE ADJUSTED ON SITE TO SUIT BRICKWORK GAUGE

ALL STAIR TREADS TO PROVIDE A MINIMUM SLIP RESISTANCE TO MEET NCC REQUIREMENTS

UNLESS NOTED OTHERWISE ALL ROOMS ARE REFERENCED AS FOLLOWS:





FLOOR PLAN LEGEND

HS / WS HOB SPOUT / WALL SPOUT FACE BRICK / COMMON BRICK

SOUND INSULATION

BRICK ARTICULATION JOINT

DENOTES DRAWER SIDE

MECHANICAL VENTILATION LOAD BEARING WALL

PLASTERBOARD

THIS DOOR OPENS FIRST

SMOKE ALARM LIFT OFF HINGE

WATER POINT

XFW FLOOR WASTE

GAS BAYONET

TOTAL FLOOR AREAS

LIVING 150.13 2.93 PORCH 172.92 m²

18,320 1,290 3,120 3,350 4.450 2,390 3.720 3,630 MASTER SUITE 3.030 BED 3 1,860 BATH 90,, 920 WC ,,90 1,700 LDRY ,,90 2,960 BED 2 1,910 ENS 90,

ACCESS PANEL LOCATION TO BE CONFIRMED ON SITE

90, 1,170 90, 1,700 ROBE 90, 1,210 WIR , 90 240_{+ +} 1,700 ROBE 90₊₊ 1,240 90₊₊ 1,020 90 70 90 1.300 90 REF +90 PANTRY ** 90, 1,910 LINEN 90, 2,000 ENTRY 240, ,

2,500

W05 MAINS WATER* 800 1,800 YARD TAP A857x610 A857x610 AF1200x1450 AC PAD AF1200x1210 CDP A.I AF1457x1450 THRESHOLD OF ACCESSIBLE SUBJECT TO FINA (W06) HOWER ENTRY TO BE MAX. 5MM WC TRUSS LAYOUT **ENS** 2,710 BATH REFER TO BATHROOM DETAILS LDRY ##8 MAN HOLE **BATH** BED 2 MASTER BED 3 820 WIR SUITE 90₄₄ 1,600 HALL 90₄ 3,470 N <u>S</u>, 2 x 720 HALL WATER POINT TO 용 ROBE FH 🔓 4D-M REF. SPACE 2 x 720 P<u>ANTRY</u>¥ ROBE ∯ LINEN 820 620 35mm WALL PROFILE TO CSM ADJECENT TO ROBE SHELVIN ``X PORCH **DINING** FRIDGE SPACE **ENTRY** 3,510 8 1,700 ROBE 90_k FRAMED BULKHEAD TO KITCHEN ,450 KITCHEN CUPBOARDS 2287 OFF FFL AND 630 FROM WALL 190 FAMILY / ENTRY DWŚ BED 4 (W12) **FAMILY** STUDY AF1457x1450 MAINS WATER AJ A<u>1</u>45<u>7</u>x6<u>1</u>0 YARD TAP (W13) x920 **DECK** 2097 TIMBER DECK WITH NATURAL TREATED PINE STEPS 240 AF/F1812 AF1457x1450 MIN. 1m HIGH SELECTED NCC COMPLIANT HANDRAIL (W14) (W15) 2R+G = 582 (OK) 90 x 90mm GAL SHS POST-RISERS = 5 @ 166mi FIXED TIMBER PRIVACY SCREEN MIN. 1700mm ABOVE FFL WITH UNIFORM TRANSPARENCY OF NO MORE THAN 25% **GLENORCHY CITY COUNCIL**

> 10,690 KITCHEN / DINING / ENTRY ²⁴⁰→PLANNING SERVICES 240, 1,200 ENS , 90 APPLICATION No.: PLN-25-293 5,520 2,970 8,200 **DATE RECEIVED:** 19/11/2025

> > ALL DIMENSIONS ARE FRAME DIMENSIONS

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4.140 BED 4

PRATIK DHIRAJBHAI & KAJALBEY PRATIK DARJI ADDRESS 116A BRANSCOMBE ROAD, CLAREMONT TAS 7011 LOT / SECTION / CT: 1 / - / 183217 GLENORCHY COUNCIL

HOUSE DESIGN HOUSE CODE AMALFI ONE H-WDNAMF10SA FACADE DESIGN FACADE CODE: CLASSIC F-WDNAMF10CLASA SHEET TITLE SHEET No.: SCALES: GROUND FLOOR PLAN 5 / 21 1:100

PROVIDE AND INSTALL SINGLE PHASE REVERSE CYCLE AIR CONDITIONING SYSTEM. NUMBER AND POSITIONING OF OUTLETS AND THE FINAL LOCATION OF THE RETURN AIR GRILLE WILL BE DETERMINED ON SITE BY THE AIR CONDITIONING CONTRACTOR AND IS SUBJECT TO TRUSS LAYOUT AND ANY OTHER CONSTRUCTION CONSTRAINTS.

FRAME MANUFACTURER TO PROVIDE CLEARANCE FOR PASSAGE OF FAN COIL UNIT FROM RETURN AIR OPENING TO FINAL FAN COIL LOCATION.

SHAMPOO RECESS SIZE | STRUCTURAL DIMENSIONS 470 x 380mm "MEDIUM" 800 x 380mm 878mm 446mm 1500 x 380mm 1578mm

REFER WILSON HOMES' DETAIL G-WETA-TILE01 FOR FURTHER DETAIL PRIOR TO INSTALLATION.

THIS PLAN ACCEPTED BY:


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1 / - / 183217

RT2 2025.11.18

8 PRELIM PLANS - PLANNING RFI UPDATE


Version: 1, Version Date: 02/12/2025

714360

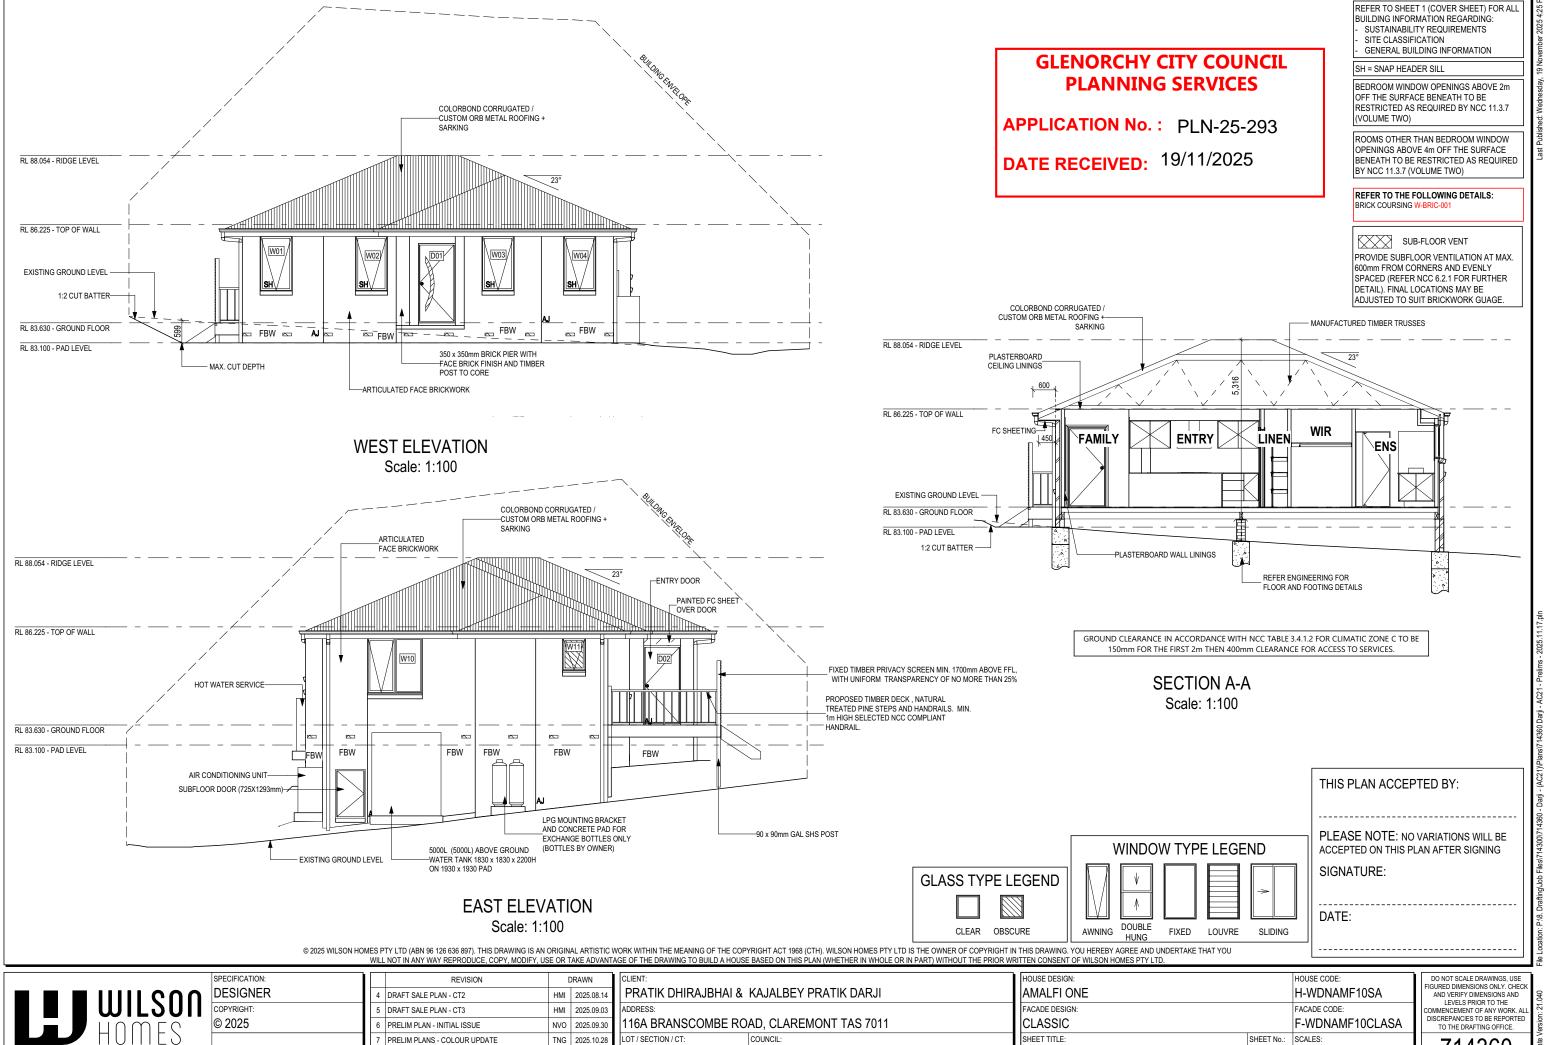ELEVATIONS / SECTION

6 / 21

1:100

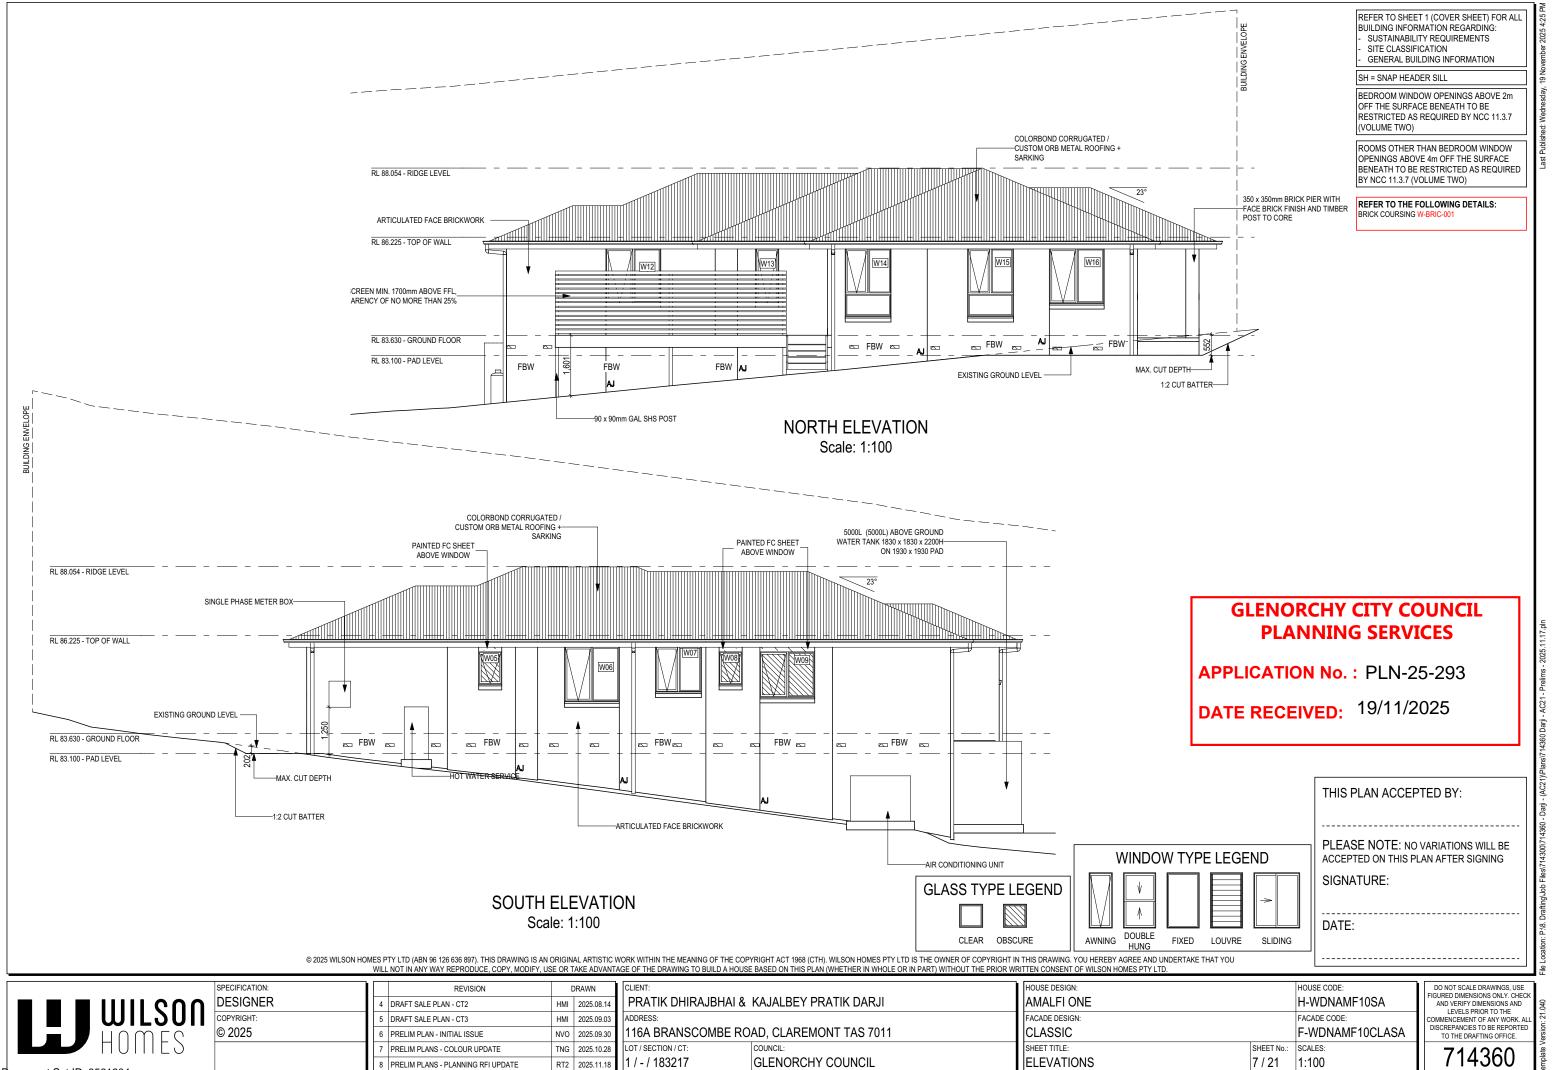

Version: 1, Version Date: 02/12/2025

0,3 ASSUME LOOKING FROM OUTSIDE	1, 2 ASSUME LOOKI	ING FROM INSIDE								
ID CODE°	ROOM	HEIGHT	WIDTH I	PERIMETER	AREA FRAME (m²) TYPE	BAL RATIN	G SILL TYPE	ORIENT.	GLAZING AREA (m²)	ADDITIONAL INFORMATION ¹
W01 A1457x850	STUDY	1,457	850	4,614	1.24 ALUMINIUM	N/A	SNAP HEADER	W	0.96 CLEAR, DOUBLE GLAZED	
W02 A1457x850	STUDY	1,457	7 850	4,614	1.24 ALUMINIUM	N/A	SNAP HEADER	W	0.96 CLEAR, DOUBLE GLAZED	
W03 A1457x850	MASTER SUITE	1,457	7 850	4,614	1.24 ALUMINIUM	N/A	SNAP HEADER	W	0.96 CLEAR, DOUBLE GLAZED	
W04 A1457x850	MASTER SUITE	1,457	7 850	4,614	1.24 ALUMINIUM	N/A	SNAP HEADER	W	0.96 CLEAR, DOUBLE GLAZED	
W05 A857x610	ENS	857	610	2,934	0.52 ALUMINIUM	N/A	ANGLED	S	0.35 OBSCURE, DOUBLE GLAZED, TOUGHENED	PAINTED FC SHEET OVER
W06 AF1457x1450	BED 2	1,457	1,450	5,814	2.11 ALUMINIUM	N/A	ANGLED	S	1.70 CLEAR, DOUBLE GLAZED	MP 725
W07 AF1200x1210	LDRY	1,200	1,210	4,820	1.45 ALUMINIUM	N/A	ANGLED	S	1.11 CLEAR, DOUBLE GLAZED	MP 605
W08 A857x610	WC	857	610	2,934	0.52 ALUMINIUM	N/A	ANGLED	S	0.35 OBSCURE, DOUBLE GLAZED, TOUGHENED	PAINTED FC SHEET OVER
W09 AF1200x1450	BATH	1,200	1,450	5,300	1.74 ALUMINIUM	N/A	ANGLED	S	1.38 OBSCURE, DOUBLE GLAZED, TOUGHENED	MP 725, PAINTED FC SHEET OVER
W10 AF1457x1450	BED 3	1,457	1,450	5,814	2.11 ALUMINIUM	N/A	ANGLED	E	1.70 CLEAR, DOUBLE GLAZED	MP 725
W11 A857x610	ENS	857	610	2,934	0.52 ALUMINIUM	N/A	ANGLED	E	0.35 OBSCURE, DOUBLE GLAZED, TOUGHENED	
W12 AF1457x1450	BED 4	1,457	1,450	5,814	2.11 ALUMINIUM	N/A	ANGLED	N	1.70 CLEAR, DOUBLE GLAZED	MP 725
W13 A1457x610	KITCHEN	1,457	610	4,134	0.89 ALUMINIUM	N/A	ANGLED	N	0.64 CLEAR, DOUBLE GLAZED	
W14 AF/F1812	FAMILY	1,800	1,210	6,020	2.18 ALUMINIUM	N/A	ANGLED	N	1.72 CLEAR, DOUBLE GLAZED	BP 600, MP 0/605
W15 AF/F1812	FAMILY	1,800	1,210	6,020	2.18 ALUMINIUM	N/A	ANGLED	N	1.72 CLEAR, DOUBLE GLAZED	BP 600, MP 0/605
W16 AF1457x1450	STUDY	1,457	1,450	5,814	2.11 ALUMINIUM	N/A	ANGLED	N	1.70 CLEAR, DOUBLE GLAZED	MP 725
					23.40				18.26	

EXTERIOR DOOR SCHEDULE

ASSUME LOOKING FROM OUTSIDE

ID	CODE°	ROOM	HEIGHT	WIDTH	AREA FRAME (m²) TYPE	BAL Rating	SILL TYPE	ORIENT.	GLAZING TYPE	DOOR TYPE	ADDITIONAL INFORMATION ¹
D01	2097x920	ENTRY	2,097	976	2.05 ALUMINIUM	N/A	SNAP HEADER	W	OBSCURE	SWINGING	
D02	2097x920	FAMILY	2.097	976	2.05 ALUMINIUM	N/A	SNAP HEADER	E	CLEAR, DOUBLE GLAZED	SWINGING	

4.10 m²

INTERIOR DOOR SCHEDULE

NOTE: INTERNAL DOORS TO WET AREAS WITH MECHANICAL VENTILATION TO BE UNDERCUT 20mm

CODE	TYPE	HEIGHT	WIDTH	GLAZING	ADDITIONAL INFORMATION
2 x 720	SWINGING	2,040	1,440	N/A	
2 x 770	SMARTROBE SLIDING	2,040	1,560	N/A	
2 x 770	SWINGING	2,040	1,540	N/A	
620	SWINGING	2,040	620	N/A	
720	SWINGING	2,040	720	N/A	LIFT-OFF HINGES
770	SWINGING	2,040	770	N/A	LIFT-OFF HINGES
770	SWINGING	2,040	770	N/A	
770 CSD	CAVITY SLIDING	2,040	770	N/A	
820	SWINGING	2,040	820	N/A	
950 SS	SQUARE SET OPENING	2,155	950	N/A	
	2 x 720 2 x 770 2 x 770 620 720 770 770 770 CSD	2 x 720 SWINGING 2 x 770 SMARTROBE SLIDING 2 x 770 SWINGING 620 SWINGING 720 SWINGING 770 SWINGING 770 SWINGING 770 CSD CAVITY SLIDING 820 SWINGING	2 x 720 SWINGING 2,040 2 x 770 SMARTROBE SLIDING 2,040 2 x 770 SWINGING 2,040 620 SWINGING 2,040 720 SWINGING 2,040 770 SWINGING 2,040 770 SWINGING 2,040 770 CSD CAVITY SLIDING 2,040 820 SWINGING 2,040	2 x 720 SWINGING 2,040 1,440 2 x 770 SMARTROBE SLIDING 2,040 1,560 2 x 770 SWINGING 2,040 1,540 620 SWINGING 2,040 620 720 SWINGING 2,040 720 770 SWINGING 2,040 770 770 SWINGING 2,040 770 770 CSD CAVITY SLIDING 2,040 770 820 SWINGING 2,040 820	2 x 720 SWINGING 2,040 1,440 N/A 2 x 770 SMARTROBE SLIDING 2,040 1,560 N/A 2 x 770 SWINGING 2,040 1,540 N/A 620 SWINGING 2,040 620 N/A 720 SWINGING 2,040 720 N/A 770 SWINGING 2,040 770 N/A 770 SWINGING 2,040 770 N/A 770 CSD CAVITY SLIDING 2,040 770 N/A 820 SWINGING 2,040 820 N/A

PICTURE / TV RECESS & SQUARE SET WINDOW SCHEDULE

QTY TYPE HEIGHT WIDTH AREA (m²)

GLENORCHY CITY COUNCIL

APPLICATION No.: PLN-25-293

DATE RECEIVED: 19/11/2025

PLANNING SERVICES

Windows supplied MUST HAVE Uw better and or equal to stated figures and SHGC within +/- 5% of stated figures. Restricted windows to have their openability restricted as per N.C.C 11.3.6.

Window Manufacturer: Dowell Windows

WERS Code

DOW-022-003

DOW-005-001

DOW-038-001

DAR-034-001

DAR-034-001

DOW-017-001

DOW-020-001

WERS Code

TND-034-001

STG-001-066

DOW-038-005

AUW-009-009

AUW-009-009

GRN-009-001

DOW-020-001

WERS Code

TND-034-001

STG-001-066

DOW-038-005

AMJ-007-005

AMJ-007-005

GRN-009-001

U Value SHGC

0.64

0.58

0.71

0.63

0.63

0.55

0.54

SHGC

0.61

0.54

0.66

0.58

0.58

0.53

0.54

SHGC

0.61

0.54

0.66

0.59

0.59

0.53

2.9

3.9

3.03

3.97

3.97

4.1

4.1

3.1

3.91

3.02

4.03

4.03

4.25

U Value

4.1

3.1

3.91

3.02

4.03

4.03

4.29

U Value

No BAL / BAL 12.5

Fixed External Window

Window Type

Sliding Window

Awning Window

Sliding Door

Stacking Door Hinged Door

Bi-Fold Door

Sliding Window

Awning Window

Sliding Door

Stacking Door

Hinged Door

Bi-Fold Door

Window Type

Sliding Window

Awning Window

Sliding Door

Stacking Door

Hinged Door

Fixed External Window

BAL 29

Fixed External Window

BAL 19 Window Type

> SINGLE GLAZING U.N.O. REFER TO GENERAL NOTES FOR FURTHER DETAIL AND REQUIREMENTS.

REFER TO SHEET 1 (COVER SHEET) FOR ALL BUILDING INFORMATION REGARDING: SUSTAINABILITY REQUIREMENTS

SITE CLASSIFICATION GENERAL BUILDING INFORMATION

THIS PLAN ACCEPTED BY:

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SIGNATURE:

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PRATIK DHIRAJBHAI & KAJALBEY PRATIK DARJI ADDRESS: 116A BRANSCOMBE ROAD, CLAREMONT TAS 7011 LOT / SECTION / CT: GLENORCHY COUNCIL 1 / - / 183217

HOUSE DESIGN HOUSE CODE AMALFI ONE H-WDNAMF10SA FACADE DESIGN: FACADE CODE: F-WDNAMF10CLASA CLASSIC SHEET TITLE: SHEET No.: SCALES: WINDOW & DOOR SCHEDULES 8 / 21

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714360

	INTOINE LIGHT AND VENTILATION								
ROOM	AREA (m2)	WINDOW ID	LIGHT REQUIRED (m2)	LIGHT ACHIEVED (m2)	VENTILATION REQ`D (m2)	VENTILATION ACH'D (m2)			
OPEN KITCHEN/ LIVING/ DINING/ FAMILY	37.92 m²	D02, W13, W14, W15	3.79 m²	4.08 m²	1.90 m²	3.98 m²			
MASTER SUITE	12.60 m²	W03, W04	1.26 m²	1.92 m²	0.63 m²	2.30 m²			
BED 2	9.71 m²	W06	0.97 m²	1.70 m²	0.49 m²	0.97 m²			
BED 3	11.76 m²	W10	1.18 m²	1.70 m²	0.59 m²	0.97 m²			
BED 4	12.34 m²	W12	1.23 m²	1.70 m²	0.62 m²	0.97 m²			
STUDY	10.53 m²	W01, W02, W16	1.05 m²	3.62 m²	0.53 m²	3.27 m²			

PART 10.5.1 LIGHT: Minimum 10% of the floor area of a habitable room required (natural light)

PART 10.6 VENTILATION: Minimum 5% of the floor area of a habitable room required. (An exhaust fan may be used for sanitary compartment, laundry or bathroom provided contaminated air discharges directly to the outside of the building by way of ducts).

GLENORCHY CITY COUNCIL PLANNING SERVICES

APPLICATION No.: PLN-25-293

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 2025.09.30

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 TNG
 2025.10.28

 8 PRELIM PLANS - PLANNING RFI UPDATE
 RT2
 2025.11.18

CLIENT:
PRATIK DHIRAJBHAI & KAJALBEY PRATIK DARJI

ADDRESS:
116A BRANSCOMBE ROAD, CLAREMONT TAS 7011

LOT/SECTION/CT: COUNCIL:
1 / - / 183217 GLENORCHY COUNCIL

HOUSE DESIGN:
AMALFI ONE
FACADE DESIGN:
CLASSIC
SHEET TITLE:
CALCULATIONS
HOUSE CODE:
H-WDNAMF10SA
FACADE CODE:
F-WDNAMF10CLASA
SCALES:
9 / 21


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714360

Version: 1, Version Date: 02/12/2025

Location: P.18. Drattinglubb Files/714300/714360 - Darji - (AC21)/Plans/714360 Darji - AC21 - Prelims -

		STA	NDARI	D BRICK	<					STA	NDARI	D BRICK	<			
RICKWORK	DIMENSION	IS Bricks p	er m ² in wa	II = 48.5 appr	OX.	all dimer	sions in mm	BRICKWORK	DIMENSION	IS Bricks p	er m ² in wa	II = 48.5 appı	OX.	all dimer	nsions in mn	
ORMAT SIZ 40x120x86r			NUFACTURIN <110x76mm	NG SIZE:		L GAUGE: es to 600mm		FORMAT SIZ 240x120x86r			MANUFACTURING SIZE: 230x110x76mm			VERTICAL GAUGE: 7 Courses to 600mm		
NO. OF BRICKS	LENGTH	OPENING	HEIGHT	NO. OF BRICKS	LENGTH	OPENING		NO. OF BRICKS	LENGTH	OPENING		NO. OF BRICKS	LENGTH	OPENING	HEIGHT	
1	230	250	86	26	6230	6250	2229	11	2630	2650	943	36 ¹ 2	8630		3086	
1 ¹ 2	350	370		26 ¹ 2	6350	6370		11 ¹ 2	2750	2770		36 ¹ 2	8750			
2	470	490	172	27	6470	6490	2314	12	2870	2890	1029	37	8870		3172	
21 2	590	610		271 2	6590	6610		12 ¹ 2	2990	3010		37 ¹ 2	8990			
3	710	730	257	28	6710	6730	2400	13	3110	3130	1114	38	9110		3257	
31 2	830	850		28 ¹ 2	6830	6850		13 ¹ 2	3230	3250		38 ¹ 2	9230	Ī		
4	950	970	343	29	6950	6970	2486	14	3350	3370	1200	39	9350	LENGTH.	3343	
41 2	1070	1090		29 ¹ ₂	7070	7090		14 ¹ ₂	3470	3490		39 ¹ ₂	9470			
5	1190	1210	429	30	7190	7210	2572	15	3590	3610	1286	40	9590		3429	
5 ¹ ₂	1310	1330		30 ¹ 2	7310	7330		15 ¹ 2	3710	3730		40 ¹ 2	9710	20 TO		
6	1430	1450	514	31	7430	7450	2657	16	3830	3850	1372	41	9830	. 20	3514	
6 ¹ 2	1550	1570		31 ¹ 2	7550	7570		16 ¹ 2	3950	3970		41 ¹ 2	9950	ADD		
7	1670	1690	600	32	7670	7690	2743	17	4070	4090	1457	42	10070	∀	3600	
7 ¹ ₂	1790	1810		32 ¹ 2	7790	7810		17 ¹ 2	4190	4210		42 ¹ 2	10190	NEEDED		
8	1910	1930	686	33	7910	7930	2829	18	4310	4330	1543	43	10310		3686	
81 2	2030	2050		33 ¹ 2	8030	8050		18 ¹ 2	4430	4450		43 ¹ 2	10430			
9	2150	2170	772	34	8150	8170	2914	19	4550	4570	1629	44	10550	<u></u>	3772	
9 ¹ ₂	2270	2290		34 ¹ ₂	8270	8290		19 ¹ ₂	4670	4690		44 ¹ 2	10670	OFTEN REQUIRED.		
10	2390	2410	857	35	8390	8400	3000	20	4790	4810	1714	45	10790		3857	
								20 ¹ 2	4910	4930		45 ¹ 2	10910	В		
								21	5030	5050	1800	46	11030		3943	
								21 ¹ 2	5150	5170		46 ¹ 2	11150			
								22	5270	5290	1886	47	11270		4029	
								22 ¹ 2	5390	5410		47 ¹ 2	11390			
								23	5510	5530	1972	48	11510	NOT	4114	
								23 ¹ 2	5630	5650		48 ¹ 2	11630			
								24	5750	5770	2057	49	11750		4200	
								24 ¹ ₂	5870	5890		49 ¹ ₂	11870			
								25	5990	6010	2143	50	11990		4286	
								25 ¹ 2	6110	6130		100	23990		8572	

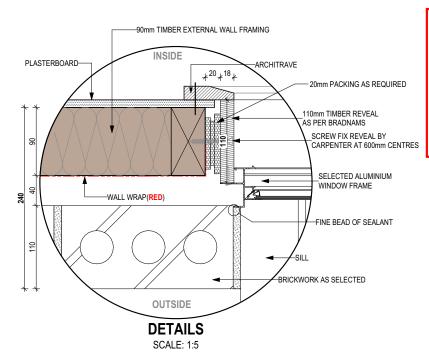

GLENORCHY CITY COUNCIL PLANNING SERVICES

APPLICATION No.: PLN-25-293

DATE RECEIVED: 19/11/2025

PLEASE NOTE: NO VARIATIONS WILL BE ACCEPTED ON THIS PLAN AFTER SIGNING SIGNATURE: DATE:

THIS PLAN ACCEPTED BY:

THIS DWELLING IS BEING CONSTRUCTED IN A [Unused] AREA

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5	DRAFT SALE PLAN - CT3	НМІ	2025.09.03		
6	PRELIM PLAN - INITIAL ISSUE	NVO	2025.09.30		
7	PRELIM PLANS - COLOUR UPDATE	TNG	2025.10.28		
8	PRELIM PLANS - PLANNING RFI UPDATE	RT2	2025.11.18		

1	CLIENT:								
1	PRATIK DHIRAJBHAI & KAJALBEY PRATIK DARJI								
	ADDRESS:								
	116A BRANSCOMBE ROAD, CLAREMONT TAS 7011								
1	LOT / SECTION / CT: COUNCIL:								
	1 / - / 183217								

HOUSE DESIGN:		HOUSE CODE:
AMALFI ONE		H-WDNAMF10SA
FACADE DESIGN:		FACADE CODE:
CLASSIC		F-WDNAMF10CLASA
SHEET TITLE:	SHEET No.:	SCALES:
DETAILS - FACE BRICKWORK	10 / 21	

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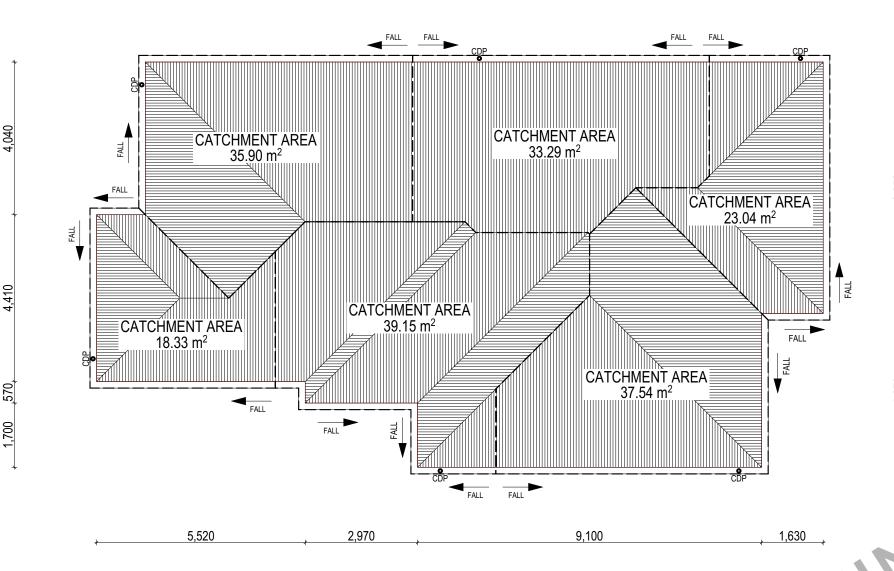
 SOS WEST SOS EASY

WHERE DOWNPIPES ARE FURTHER THAN 1.2m AWAY FROM VALLEY REFER TO N.C.C. 7.3.5(2)

POSITION AND QUALITY OF DOWNPIPES ARE NOT TO BE ALTERED WITHOUT CONSULTATION WITH DESIGNER.

AREA'S SHOWN ARE SURFACE AREAS/ CATCHMENT AREAS, NOT PLAN AREAS

Roofi	ng Data	
	176.61	Flat Roof Area (excluding gutter and slope factor) (m²)
	191.86	Roof Surface Area (includes slope factor, excludes gutter) (m²)
Down	pipe roof	calculations (as per AS/NZA3500.3:2021)
Ah	187.25	Area of roof catchment (including 115mm Slotted Quad Gutter) (m²)
Ac	226.57	Ah x Catchment Area Multiplier for slope (Table 3.4.3.2 from AS/NZS 3500.3:2021)(1.21 for 23° pitch) (m²)
Ae	6300	Cross sectional area of 57 x 115 Slotted Quad Gutter (mm²)
DRI	86	Design Rainfall Intensity (determined from Table E1 from AS/NZS 3500.3:2021)
Acdp	64	Catchment area per Downpipe (determined from Figure 3.5(A) from AS/NZS 3500.3:2021) (m²)
Required Downpipes	3.54	Ac / Acdp
Downpipes Provided	6	



SOFFIT EAVE VENT PROPOSED LOCATION TO BE MIN. 1M FROM CORNER JOINT

GLENORCHY CITY COUNCIL PLANNING SERVICES

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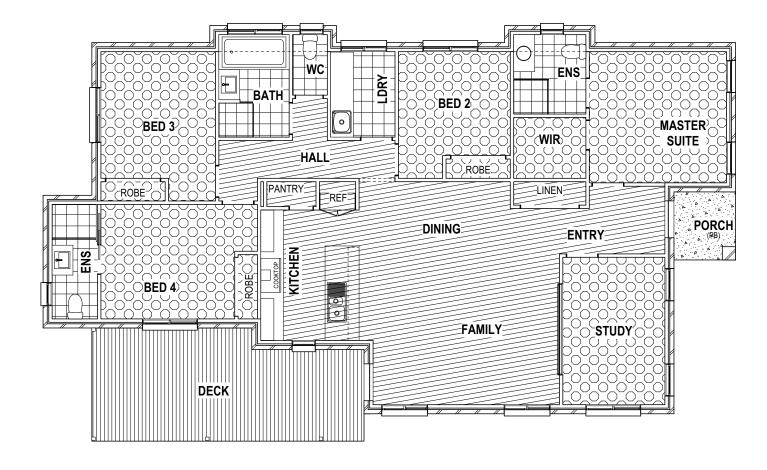
714360

REFER TO SHEET 1 (COVER SHEET) FOR ALL BUILDING INFORMATION REGARDING:
- SUSTAINABILITY REQUIREMENTS
- SITE CLASSIFICATION
- GENERAL BUILDING INFORMATION

FLOOR TILES SHOWN ON PLAN DO NOT INDICATE THE SIZE OR JOINT LOCATIONS OF THE ACTUAL FLOOR TILES.
TIMBER FLOORING SHOWN ON PLAN DOES NOT INDICATE THE BOARD SIZE OR DIRECTION OF THE ACTUAL FLOORING.

COVERINGS LEGEND

NO COVERING
COVER GRADE CONCRETE
CARPET
LAMINATE
TILE (STANDARD WET AREAS)
TILE (UPGRADED AREAS)
DECKING



GLENORCHY CITY COUNCIL PLANNING SERVICES

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ADDRESS:
116A BRANSCOMBE ROAD, CLAREMONT TAS 7011
LOT/SECTION/CT: COUNCIL:
1 / - / 183217 GLENORCHY COUNCIL

HOUSE DESIGN:

AMALFI ONE

FACADE DESIGN:

CLASSIC

SHEET TITLE:

FLOOR COVERINGS

HOUSE CODE:

H-WDNAMF10SA

FACADE CODE:

F-WDNAMF10CLASA

SHEET No.:


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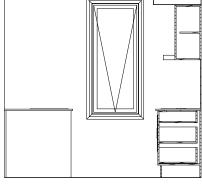
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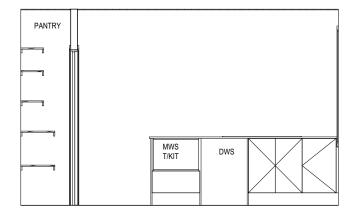
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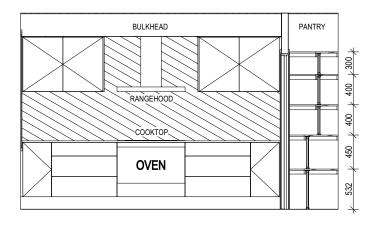




ELEVATION C Scale: 1:50



ELEVATION B Scale: 1:50

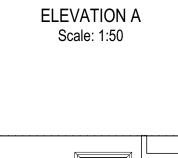


ELEVATION D Scale: 1:50


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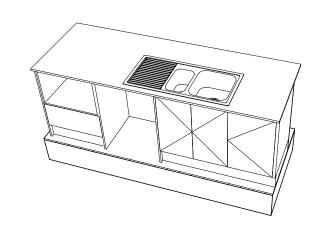
DETAILS DEPICTED ON THIS SHEET ARE A REPRESENTATION ONLY. JOINER MAY ADJUST CABINETRY AS REQUIRED.

GAS CONNECTION FOR COOKTOP TO BE LOCATED 700mm TO RIGHT HAND SIDE OF CENTRE OF COOKTOP

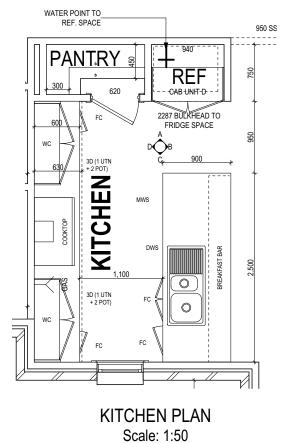

FRAMED BULKHEAD TO KITCHEN CUPBOARDS 2287 OFF FFL AND 630 FROM WALL



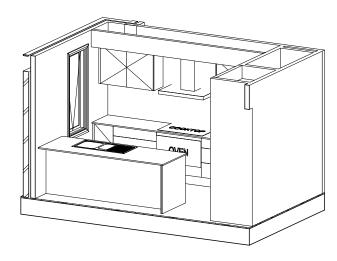

GLENORCHY CITY COUNCIL PLANNING SERVICES

APPLICATION No.: PLN-25-293

DATE RECEIVED: 19/11/2025

- 1			1
١		THIS PLAN ACCEPTED BY:	
ı			:
ı			9
		PLEASE NOTE: NO VARIATIONS WILL BE ACCEPTED ON THIS PLAN AFTER SIGNING	
١		SIGNATURE:	i
		DATE:	9
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ALL DIMENSIONS ARE FRAME DIMENSIONS

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	REVISION		DRAWN
4	DRAFT SALE PLAN - CT2	НМІ	2025.08.14
5	DRAFT SALE PLAN - CT3	НМІ	2025.09.03
6	PRELIM PLAN - INITIAL ISSUE	NVO	2025.09.30
7	PRELIM PLANS - COLOUR UPDATE	TNG	2025.10.28
8	PRELIM PLANS - PLANNING RFI UPDATE	RT2	2025.11.18
	6	4 DRAFT SALE PLAN - CT2 5 DRAFT SALE PLAN - CT3 6 PRELIM PLAN - INITIAL ISSUE 7 PRELIM PLANS - COLOUR UPDATE	4 DRAFT SALE PLAN - CT2 HMI 5 DRAFT SALE PLAN - CT3 HMI 6 PRELIM PLAN - INITIAL ISSUE NVO 7 PRELIM PLANS - COLOUR UPDATE TNG

ī	CLIENT:		
4	PRATIK DHIRAJBHAI & KAJALBEY PRATIK DARJI		
3	ADDRESS:		
0	116A BRANSCOMBE ROAD, CLAREMONT TAS 7011		
8	LOT / SECTION / CT:	COUNCIL:	
8	1 / - / 183217	GLENORCHY COUNCIL	

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HOUSE DESIGN:	HOUSE CODE:	T.	
AMALFI ONE	H-WDNAMF10SA		
ACADE DESIGN:	FACADE CODE:	1	
CLASSIC	F-WDNAMF10CLASA		
SHEET TITLE:	SHEET No.:	SCALES:	
KITCHEN DETAILS	13 / 21	1:50	

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LEGEND

CONNECTION

MIXER TAP


HT HOT TAP

RSHR RAIL SHOWER


ROSE SHOWER ROSE SHOWER ELBOW

ELBW


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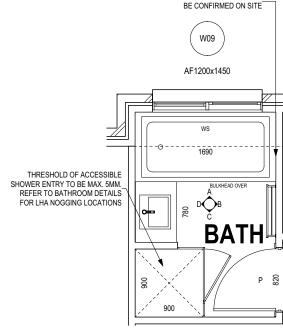
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Scale: 1:50

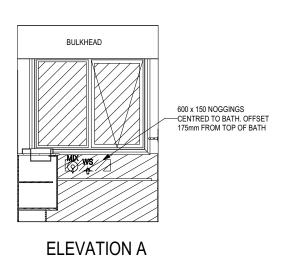

BATHROOM PLAN Scale: 1:50

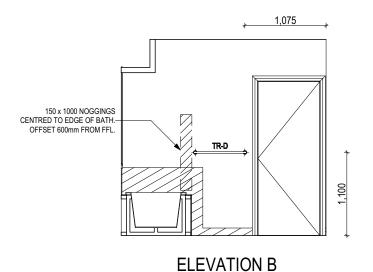


ACCESS PANEL LOCATION TO

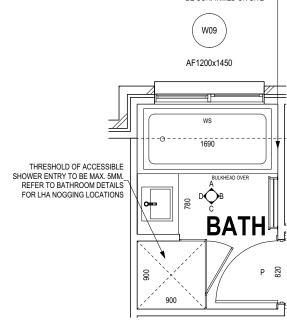GLENORCHY CITY COUNCIL PLANNING SERVICES


APPLICATION No.: PLN-25-293


DATE RECEIVED: 19/11/2025

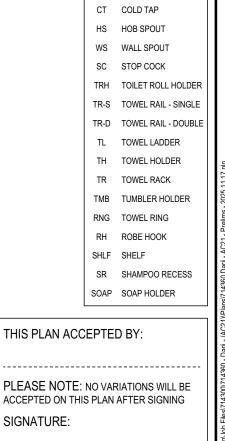

SIGNATURE:

DATE:

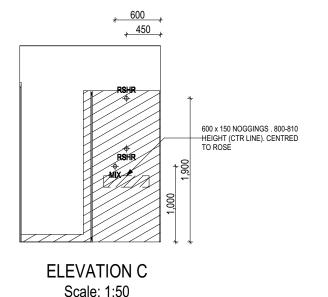

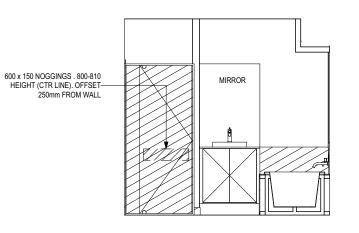

ELEVATION D Scale: 1:50

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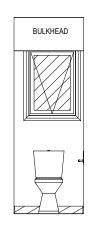
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SIGNER	4	DRAFT SALE PLAN - CT2	НМІ	2025.08.
YRIGHT:	5	DRAFT SALE PLAN - CT3	НМІ	2025.09.
2025	6	PRELIM PLAN - INITIAL ISSUE	NVO	2025.09.
	7	PRELIM PLANS - COLOUR UPDATE	TNG	2025.10.
	8	PRELIM PLANS - PLANNING RFI UPDATE	RT2	2025.11.

	CLIENT:		
3.14	PRATIK DHIRAJBHAI & KAJALBEY PRATIK DARJI		
9.03	ADDRESS:		
9.30	116A BRANSCOMBE ROAD, CLAREMONT TAS 7011		
0.28	LOT / SECTION / CT:	COUNCIL:	
1.18	1 / - / 183217	GLENORCHY COUNCIL	


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111111111111111111111111111111111111111		H-WDNAMF10SA
FACADE DESIGN:		FACADE CODE:
CLASSIC		F-WDNAMF10CLASA
SHEET TITLE:	SHEET No.:	SCALES:
BATHROOM DETAILS	14 / 21	1:50

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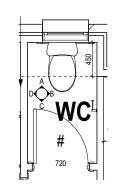
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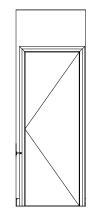





ELEVATION B Scale: 1:50

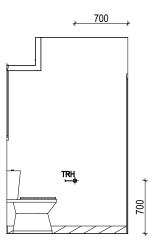

WC PLAN Scale: 1:50



ELEVATION C Scale: 1:50

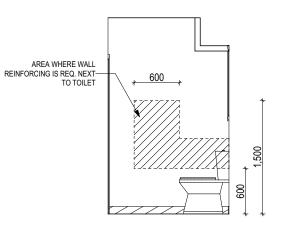

ELEVATION D Scale: 1:50

GLENORCHY CITY COUNCIL PLANNING SERVICES

APPLICATION No.: PLN-25-293

DATE RECEIVED: 19/11/2025

RSHR	RAIL SHOWER
ROSE	SHOWER ROSE
ELBW	SHOWER ELBOW CONNECTION
MIX	MIXER TAP
НТ	HOT TAP
СТ	COLD TAP
HS	HOB SPOUT
WS	WALL SPOUT
SC	STOP COCK
TRH	TOILET ROLL HOLDER
TR-S	TOWEL RAIL - SINGLE
TR-D	TOWEL RAIL - DOUBLE
TL	TOWEL LADDER
TH	TOWEL HOLDER
TR	TOWEL RACK
TMB	TUMBLER HOLDER
RNG	TOWEL RING
RH	ROBE HOOK
SHLF	SHELF
SR	SHAMPOO RECESS
SOAP	SOAP HOLDER

THIS PLAN ACCEPTED BY:

SIGNATURE:

DATE:

PLEASE NOTE: NO VARIATIONS WILL BE

ACCEPTED ON THIS PLAN AFTER SIGNING

LEGEND

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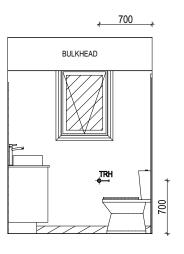


ECIFICATION:		REVISION)F
ESIGNER	4	DRAFT SALE PLAN - CT2	НМІ	
PYRIGHT:	5	DRAFT SALE PLAN - CT3	НМІ	
2025	6	PRELIM PLAN - INITIAL ISSUE	NVO	Ī
	7	PRELIM PLANS - COLOUR UPDATE	TNG	
	8	PRELIM PLANS - PLANNING RFI UPDATE	RT2	


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	НМІ	2025.08.14	PRATIK DHIRAJBHAI &	KAJALBEY PRATIK DARJI	
	НМІ	2025.09.03	ADDRESS:		
	NVO	2025.09.30	116A BRANSCOMBE ROAD, CLAREMONT TAS 7011		
	TNG	2025.10.28		COUNCIL:	
	RT2	2025.11.18	1 / - / 183217	GLENORCHY COUNCIL	

THEN CONSENT OF WILSON HOMES FIT LTD.			
HOUSE DESIGN:		HOUSE CODE:	ì
AMALFI ONE		H-WDNAMF10SA	FIG
FACADE DESIGN:		FACADE CODE:	cc
CLASSIC		F-WDNAMF10CLASA	D
SHEET TITLE:	SHEET No.:	SCALES:	
WC DETAILS	15 / 21	1:50	


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ELEVATION A Scale: 1:50





ELEVATION B Scale: 1:50

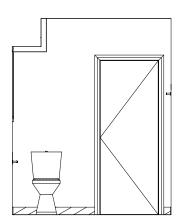

Scale: 1:50

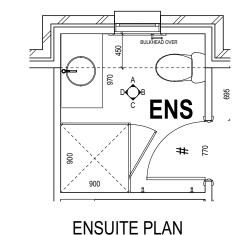LEGEND RSHR RAIL SHOWER ROSE SHOWER ROSE SHOWER ELBOW ELBW CONNECTION MIX MIXER TAP HT HOT TAP CT COLD TAP HOB SPOUT WS WALL SPOUT STOP COCK TRH TOILET ROLL HOLDER TR-S TOWEL RAIL - SINGLE TR-D TOWEL RAIL - DOUBLE TL TOWEL LADDER TH TOWEL HOLDER TR TOWEL RACK TMB TUMBLER HOLDER RNG TOWEL RING ROBE HOOK SHLF SHELF SHAMPOO RECESS

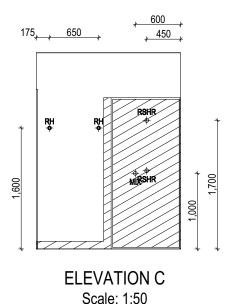

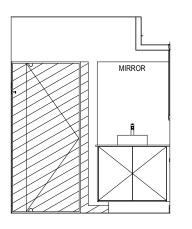

ELEVATION D Scale: 1:50

GLENORCHY CITY COUNCIL PLANNING SERVICES

APPLICATION No.: PLN-25-293

DATE RECEIVED: 19/11/2025

		SOAP SOAP HOLDER
	THIS PLAN ACC	EPTED BY:
		NO VARIATIONS WILL BE S PLAN AFTER SIGNING
	SIGNATURE:	
	DATE:	
	D/ (I E.	

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PECIFICATION: DESIGNER		REVISION		RAWN
		DRAFT SALE PLAN - CT2	НМІ	2025.08.14
COPYRIGHT: 2025		DRAFT SALE PLAN - CT3	НМІ	2025.09.03
		PRELIM PLAN - INITIAL ISSUE	NVO	2025.09.30
	7	PRELIM PLANS - COLOUR UPDATE	TNG	2025.10.28
		PRELIM PLANS - PLANNING RFI UPDATE	RT2	2025.11.18

	RAWN	CLIENT:		
НМІ	2025.08.14	PRATIK DHIRAJBHAI & KAJALBEY PRATIK DARJI		
НМІ	2025.09.03	ADDRESS:		
NVO	2025.09.30	116A BRANSCOMBE ROAD, CLAREMONT TAS 7011		
TNG	2025.10.28	LOT / SECTION / CT:	COUNCIL:	
RT2	2025.11.18	1 / - / 183217	GLENORCHY COUNCIL	

HOUSE DESIGN:		HOUSE CODE:	╽┃
AMALFI ONE		H-WDNAMF10SA	FI
FACADE DESIGN:		FACADE CODE:	co
CLASSIC		F-WDNAMF10CLASA	
SHEET TITLE:	SHEET No.:	SCALES:	
ENSUITE DETAILS	16 / 21	1:50	

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LEGEND

RSHR RAIL SHOWER


ROSE SHOWER ROSE ELBW SHOWER ELBOW CONNECTION MIX MIXER TAP HT HOT TAP

CT COLD TAP HS HOB SPOUT WS WALL SPOUT SC STOP COCK TRH TOILET ROLL HOLDER TR-S TOWEL RAIL - SINGLE


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TR TOWEL RACK TMB TUMBLER HOLDER


RNG TOWEL RING ROBE HOOK

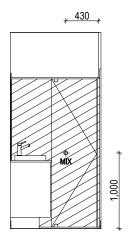


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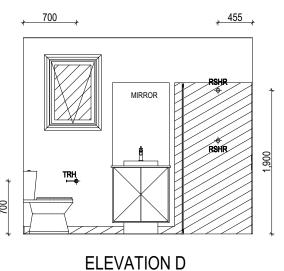


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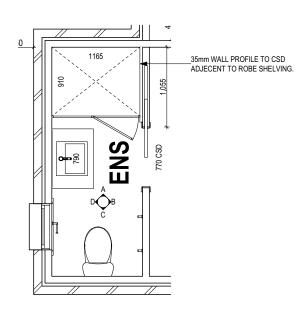


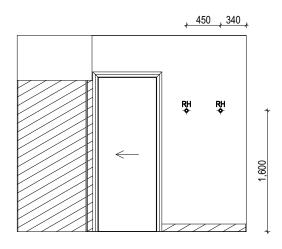ELEVATION C Scale: 1:50

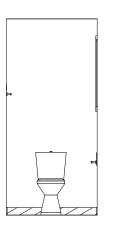

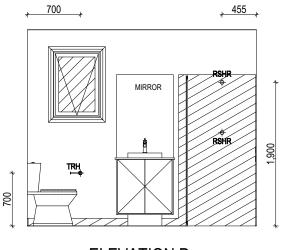

Scale: 1:50



ENSUITE (IN BED 4) PLAN Scale: 1:50

GLENORCHY CITY COUNCIL PLANNING SERVICES

APPLICATION No.: PLN-25-293

DATE RECEIVED: 19/11/2025

	SHLF	SHELF	1		
	SR	SHAMPOO RECESS			
	SOAP	SOAP HOLDER	!		
THIS PLAN ACC	EPTE	D BY:			
PLEASE NOTE: NO VARIATIONS WILL BE ACCEPTED ON THIS PLAN AFTER SIGNING					
SIGNATURE:			i		
DATE:			9		
	PLEASE NOTE: ACCEPTED ON THI SIGNATURE:	THIS PLAN ACCEPTED PLEASE NOTE: NO VAR ACCEPTED ON THIS PLAN SIGNATURE:	ACCEPTED ON THIS PLAN AFTER SIGNING SIGNATURE:		

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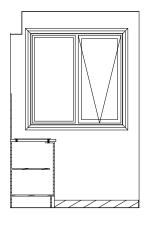


CIFICATION:		REVISION		RAWN
SIGNER	4	DRAFT SALE PLAN - CT2	НМІ	2025.08.
PYRIGHT:		DRAFT SALE PLAN - CT3	НМІ	2025.09.
2025	6	PRELIM PLAN - INITIAL ISSUE	NVO	2025.09.
	7	PRELIM PLANS - COLOUR UPDATE	TNG	2025.10.
	8	PRELIM PLANS - PLANNING RFI UPDATE	RT2	2025.11.

٦	CLIENT:					
4	PRATIK DHIRAJBHAI & KAJALBEY PRATIK DARJI					
3	ADDRESS:					
0	116A BRANSCOMBE ROAD, CLAREMONT TAS 7011					
8	LOT / SECTION / CT:	COUNCIL:				
8	1 / - / 183217	GLENORCHY COUNCIL				

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HOUSE DESIGN:		HOUSE CODE:	1
AMALFI ONE		H-WDNAMF10SA	
FACADE DESIGN:		FACADE CODE:	c
CLASSIC		F-WDNAMF10CLASA	
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ENSUITE (IN BED 4) DETAILS	17 / 21	1:50	


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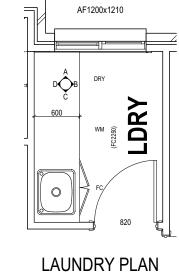
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ELEVATION C


Scale: 1:50



ELEVATION B Scale: 1:50

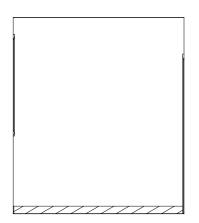

Scale: 1:50

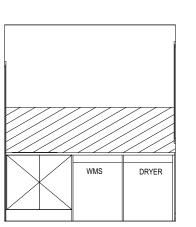

ELEVATION D Scale: 1:50

GLENORCHY CITY COUNCIL PLANNING SERVICES

APPLICATION No.: PLN-25-293

DATE RECEIVED: 19/11/2025

Ι.		9
	THIS PLAN ACCEPTED BY:	Darii - (AC21)
	PLEASE NOTE: NO VARIATIONS WILL BE ACCEPTED ON THIS PLAN AFTER SIGNING SIGNATURE:	
	DATE:	Polytop: D48 Draffing

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IFICATION:		REVISION		RAWN
SIGNER	4	DRAFT SALE PLAN - CT2	НМІ	2025.08.1
RIGHT:	5	DRAFT SALE PLAN - CT3	НМІ	2025.09.0
025	6	PRELIM PLAN - INITIAL ISSUE	NVO	2025.09.3
	7	PRELIM PLANS - COLOUR UPDATE	TNG	2025.10.2
	8	PRELIM PLANS - PLANNING RFI UPDATE	RT2	2025.11.1

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l	CLIENT:		ŀ
.14	PRATIK DHIRAJBHAI &	KAJALBEY PRATIK DARJI	1
.03	ADDRESS:		Ī
.30	116A BRANSCOMBE RO	AD, CLAREMONT TAS 7011	ľ
.28	LOT / SECTION / CT:	COUNCIL:	[
.18	1 / - / 183217	GLENORCHY COUNCIL	

HOUSE DESIGN:		HOUSE CODE:
AMALFI ONE		H-WDNAMF10SA
FACADE DESIGN:		FACADE CODE:
CLASSIC		F-WDNAMF10CLASA
SHEET TITLE:	SHEET No.:	SCALES:
LAUNDRY DETAILS	18 / 21	1:50

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FRONT LEFT 3D FRONT RIGHT 3D



REAR LEFT 3D



REAR RIGHT 3D

PLEASE NOTE: NO VARIATIONS WILL BE ACCEPTED ON THIS PLAN AFTER SIGNING

THIS PLAN ACCEPTED BY:

SIGNATURE:

DATE:

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	5
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HOMES	(
ПОПІЕЭ	

SPECIFICATION: DRAWN REVISION DESIGNER HMI 2025.08.14 4 DRAFT SALE PLAN - CT2 COPYRIGHT: 5 DRAFT SALE PLAN - CT3 HMI 2025.09.03 © 2025 6 PRELIM PLAN - INITIAL ISSUE NVO 2025.09.30 7 PRELIM PLANS - COLOUR UPDATE TNG 2025.10.28 8 PRELIM PLANS - PLANNING RFI UPDATE RT2 2025.11.18

ı	CLIENT:		
1	PRATIK DHIRAJBHAI & KAJALBEY PRATIK DARJI		
1	ADDRESS:		
1	116A BRANSCOMBE ROAD, CLAREMONT TAS 7011		
1	LOT / SECTION / CT:	COUNCIL:	
1	1 / - / 183217	GLENORCHY COUNCIL	

HOUSE DESIGN:	HOUSE CODE:	
AMALFI ONE	H-WDNAMF10SA	
FACADE DESIGN:	FACADE CODE:	
CLASSIC	F-WDNAMF10CLAS	3A
SHEET TITLE:	SHEET No.: SCALES:	
3D VIEWS	19 / 21	

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GENERAL

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- ALL WORK TO BE CARRIED OUT IN ACCORDANCE WITH THE NATIONAL CONSTRUCTION CODE (N.C.C.)
- INTERNAL DIMENSIONS ARE TO WALL FRAMING ONLY AND DO NOT INCLUDE WALL LININGS

SITE WORKS

- CUT AND FILL BATTERS ARE INDICATIVE ONLY. BATTER TO COMPLY WITH THE N.C.C. TABLE 3.2.1
- ALL CUTS AND FFL'S SHOWN (DA DRAWINGS) ARE SUBJECT TO ENGINEERING ADVICE ONCE À SATISFACTORY SOIL TEST HAS BEEN RECEIVED AND REVIEWED
- ALL EMBANKMENTS THAT ARE LEFT EXPOSED MUST BE STABILISED WITH VEGETATION OR SIMILAR TO PREVENT
- EMBANKMENTS CANNOT EXCEED 2.0m IN HEIGHT WITHOUT THE AID OF RETAINING WALLS OR OTHER APPROVED TYPES OF SOIL RETAINING METHODS
- ALL UNPROTECTED EMBANKMENTS MUST COMPLY WITH THE SLOPE RATIOS FOR SOIL TYPE IN TABLE 3.2.1 OF THE N.C.C.

SOIL TYPE /	EMBANKMENT OF SLOPE	
CLASSIFICATION	COMPACTED FILL	CUT
STABLE ROCK (A)	3:3	8:1
SAND (A)	1:2	1:2
SILT (P)	1:4	1:4
FIRM CLAY	1:2	1:1
SOFT CLAY	NOT SUITABLE	2:3
SOFT SOILS (P)	NOT SUITABLE	NOT SUITABLE

MASONRY

- ALL MASONRY TO BE CONSTRUCTED IN ACCORDANCE WITH
- EXTERNAL WALLS TO BE 110mm BRICKWORK UNLESS NOTED OTHERWISE
- MORTAR MIXED @ 1:1:6 CEMENT:LIME:SAND UNLESS STATED OTHERWISE BY ENGINEER
- DAMP-PROOF COURSE IN ALL PERIMETER WALLS CUT INTO EXTERNAL WALLS BELOW FLOOR LEVEL WITH WEEP HOLES @ 1200 CTRS IN ACCORDANCE WITH AS2904
- VERTICAL ARTICULATION JOINTS TO BE PROVIDED @ 6m MAX. CTRS FOR UNREINFORCED MASONRY WALLS EXCEPT WHERE BUILT ON CLASS A OR S SOIL AND SPACED AS PER AS3700 SECTION 12.6.4. WILSON HOMES REQUEST THAT @ 5M CTRS
- WHERE NECESSARY, STEEL LINTELS ARE TO BE PROVIDED IN ACCORDANCE WITH AS4100 AND AS3700a

TIMBER FRAMING

- ALL WORK TO BE CARRIED OUT IN ACCORDANCE WITH THE CURRENT N.C.C.
- ALL TIMBER FRAMING TO BE CARRIED OUT IN ACCORDANCE **WITH AS1684**
- MGP10 PINE FRAMING OR F17 SOLID AND FINGER JOINED FRAMING TO ALL STRUCTURAL COMPONENTS. 90 x 35mm FRAMING TO INTERNAL AND EXTERNAL WALLS. TIMBER COMPOSITE ENGINEERED ROOF TRUSSES WITH HARDWOOD AND MGP COMPONENTS
- GALVANISED WALL TIES TO MASONRY @ 450 CTRS HORIZONTALLY AND 600 CTRS VERTICALLY, WITH SPACING REDUCED BY 50% AROUND OPENINGS

BRACING / LINTELS

- WALL BRACING AS PER AS1684-2 2021 AND AS1170 WIND
- WALL BRACING AS SHOWN ON PLAN IS A MINIMUM ONLY. BUILDER TO PROVIDE ADDITIONAL BRACING TO SUIT THE CONSTRUCTION OF WALL FRAMES IN ACCORDANCE WITH GOOD BUILDING PRACTICE.
- PLYWOOD BRACING IN ACCORDANCE WITH AS1684
- 65 x 19mm HW DIAGONAL TIMBER BRACING CHECKED INTO STUDS AND FIXED IN ACCORDANCE WITH AS1684

TIMBER LINTELS FOR SINGLE (OR UPPER STORY) TO BE F17 HARDWOOD AS FOLLOWS:

1500 - 2400 140 x 35 2400 - 2700 190 x 35

TIEDOWN AND FIXING CONNECTIONS TO COMPLY WITH AS1684

STEEL LINTELS FOR SINGLE (OR UPPER STOREY) TO BE AS FOLLOWS:

0 - 2700 90 x 90 x 6 EA 2700 - 3200 100 x 100 x 8 EA 150 x 90 x 8 EA 3200 - 4000

*LINTELS REQUIRE 150mm BEARING EITHER SIDE OF OPENING

ALL LINTEL SIZES SHOWN ARE SUBJECT TO ENGINEERS DETAILS

CONCRETE

- CONCRETE FOOTING AND SLABS TO BE IN ACCORDANCE WITH AS2870
- CONCRETE TO BE MANUFACTURED TO COMPLY WITH AS3600 AND:
- HAVE A STRENGTH @ 28 DAYS OF NOT LESS THAN 25MpA (N25 GRADE)
- HAVE A 20mm NOMINAL AGGREGATE SIZE
- HAVE A NOMINAL 80mm SLUMP
- CONCRETE SLAB TO BE LAID OVER 0.2mm POLYTHENE MEMBRANE, 50mm WELL BEDDED SAND AND MINIMUM COMPACTED FCR (20mm)
- SLAB THICKNESS AND REINFORCEMENT TO BE AS PER ENGINEERS DESIGN

DRAINAGE / WATER

- DRAINAGE TO BE DESIGNED AND CONSTRUCTED IN ACCORDANCE WITH AS3500 AND LOCAL AUTHORITY
- STORMWATER PIPES TO BE UPVC CLASS HD
- SEWER PIPES TO BE UPVC CLASS SH
- PROVIDE Ø20mm K2 POLYETHYLENE WATER RETICULATION
- TYPE B STOP VALVE TO BE LOCATED ADJACENT TO ENTRY
- BACKFILL ALL TRENCHES BENEATH VEHICLE PAVEMENT AND SLABS ON GRADE TO FULL DEPTH WITH 20 FCR
- PROVIDE OVERFLOW RELIEF GULLY WITH TAP OVER. INVERT LEVEL TO BE 150 MIN. BELOW LOWEST SANITARY DRAINAGE
- CUT AND BATTER ARE INDICATIVE. BATTER TO COMPLY WITH CURRENT N.C.C. TABLE 3.2.1
- AG DRAIN REQUIRED AROUND PERIMETER OF DWELLING FOR ALL CLASS M, H, E SITES. LOCATE AG DRAIN NOT CLOSER THAN 1.5m FROM FOOTINGS IN ACCORDANCE WITH AS2870 SECTION 5.6
- PROVIDE SURFACE DRAINAGE IN ACCORDANCE WITH AS2870 SECTION 5.6.3
- PROVIDE FLEXIBLE JOINTS IN ALL DRAINAGE EMERGING FROM UNDERNEATH OR ATTACHED TO BUILDING IN ACCORDANCE WITH AS2870 SECTION 5.6.4 FOR ALL CLASS H AND E SITES. REFER TO GEOTECH FOR FURTHER INFORMATION
- DOWNPIPES AND GUTTERS DESIGNED IN ACCORDANCE WITH AS/NZS 3500.3

Plumbing to AS3500 ITEM PIPE SIZE ORG DN100- TAP OVER KITCHEN SINK DN50 LAUNDRY TROUGH DN50 SHOWER **DN50** BASIN DN40 BATH DN40 WC DN100 **VENT PIPE DN50**

ORG TO BE 150mm LOWER THAN LOWEST FIXTURE AND 75mm ABOVE FGL

Minimum grades of discharge pipes

Size of graded section	Minimum Grade %
of pipe DN	
40	2.50
50	2.50
65	2.50
80	1.65
100	1.65
125	1.25
150	1.00

WINDOWS

- WINDOWS TO BE ALUMINIUM FRAMED SLIDING UNLESS NOTED OTHERWISE
- ALL WINDOWS TO BE FABRICATED AND INSTALLED IN ACCORDANCE WITH AS1288 AND AS2047 TO SPECIFIC WIND SPEED AS PER ENGINEERS REPORT
- ALL OPENING WINDOWS TO COMPLY WITH N.C.C. 8 REQUIREMENTS
- AS PER N.C.C. 11.3.6 ALL BEDROOM WINDOWS WHERE THE LOWEST OPENABLE PORTION OF THE WINDOW IS WITHIN 1.7m OF FFL AND THE FFL IS 2m OR MORE ABOVE NGL, REQUIRE A PERMANENTLY FIXED DEVICE RESTRICTING ANY OPENINGS OF THE WINDOW OR SCREEN SO THAT A 125mm SPHERE CANNOT PASS THROUGH: AND RESISTING OUTWARDS HORIZONTAL ACTION OF 250N AGAINST THE WINDOW. WHERE THE DEVICE OR SCREEN CAN BE REMOVED, UNLOCKED OR OVER-RIDDEN, THE DEVICE OR SCREEN MUST HAVE A CHILD RESISTANT RELEASE MECHANISM INSTALLED AND BARRIER BELOW THE WINDOW THAT IS 865mm HIGH ABOVE FFL AND RESTRICTS ANY OPENING WITHIN THE BARRIER SO THAT A 125mm SPHERE CANNOT PASS THROUGH, AND HAS NO HORIZONTAL OR NEAR HORIZONTAL ELEMENTS BETWEEN 150mm AND 760mm FROM FFL.
- GLAZING INSTALLED IN AREAS WITH HIGH POTENTIAL FOR HUMAN IMPACT TO COMPLY WITH N.C.C. PART 8.4

WET AREAS

- WALLS TO WET AREAS TO BE FINISHED WITH WET AREA **PLASTERBOARD**
- COMPLIANCE WITH N.C.C. PART 10.2 AND AS3740
- ALL UNENCLOSED SHOWERS ABOVE BATHS TO HAVE MINIMUM 900mm SHOWER SCREEN OR FLOORWASTE WITHIN 1500mm OF SHOWER CONNECTION AS PER AS3740

CONDENSATION

- WHERE RAKED CEILINGS EXIST, IT IS HIGHLY RECCOMENDED THAT SUITABLE SPACING BETWEEN SARKING AND BULK INSULATION EXISTS. (NO CONTACT BETWEEN PRODUCTS) THE BUILDER IS TO ENSURE ADEQUATE SIZED TIMBER IS USED TO ENSURE THIS SEPARATION IS PROVIDED
- IN STANDARD ROOF SPACES. IT IS HIGHLY RECOMMENDED TO PROVIDE SEPARATION BETWEEN SARKING AND CEILING INSULATION AROUND THE BUILDING PERIMETER, TO ENSURE AIRFLOW FROM EAVE VENTS IS MAINTAINED
- IT IS HIGHLY RECOMMENDED THAT ALL LIGHTWEIGHT CLADDING IS BATTENED OUT FROM STUDS (METAL / FC SHEET / TIMBER)

STAIRCASES / BALUSTRADES / HANDRAILS

INSTALLED TO MANUFACTURERS SPECIFICATIONS. TRUSS

ROOF TO BE COLORBOND 'CUSTOM ORB' METALDECK UNLESS

NOTED OTHERWISE. PROVIDED AND INSTALLED IN ACCORDANCE WITH AS1562.1 (IF TILED REFER TO AS2050)

- PREFABRICATED ROOF TRUSSES TO BE SUPPLIED AND

MANUFACTURER TO CONFIRM LINTEL SIZES.

STAIR TREADS STAIR RISERS

ROOFING

240mm MIN. - 355mm MAX. 115mm MIN. - 190mm MAX.

- HANDRAIL REQUIRED WHERE CHANGE OF LEVEL BETWEEN FLOOR / LANDINGS > 1m AS PER CURRENT N.C.C. 11.3.5
- NO GAPS IN STAIRCASES OR BALUSTRADE TO BE GREATER
- BALUSTRADE REQUIRED WHERE LEVEL OF LANDING OR DECK IS GREATER THAN 1000mm ABOVE ADJACENT GROUND LEVEL
- BALUSTRADE TO BE MINIMUM 1000mm ABOVE FFL (INCLUDING ANY FLOOR COVERINGS)
- DOORS OPENING OUTWARDS EXTERNALLY MUST OPEN TO A LANDING (MIN. 750mm WIDE) WHERE THE DIFFERENCE IN LEVELS IS GREATER THAN 570mm
- NON-SLIP TREADS TO ALL TREADS AND TO COMPLY WITH N.C.C. 11.2.4
- WHERE LANDINGS ARE NOT NOMINATED TO EXTERNAL DOORS, OPERATING DOOR LEAFS ARE TO BE SCREWED FIXED SHUT, OR PROVIDED WITH A FORMED FCR LANDING NOMINALLY 180mm BELOW FLOOR LEVEL.

WOOD HEATERS

- ALL WOOD HEATERS ARE TO COMPLY WITH MANUFACTURERS SPECIFICATION AND N.C.C. PART 12.4

FIRE SAFETY

- SMOKE ALARMS TO BE MAINS POWERED AND INSTALLED AS PER AS3786. LOCATIONS AS PER N.C.C. 9.5
- SMOKE ALARMS TO BE INTERCONNECTED WHERE THERE IS MORE THAN ONE ALARM
- INSTALLATION OF WOOD HEATERS TO COMPLY WITH AS2918. PROVIDE LOCAL AUTHORITIES WITH INSULATION AND COMPLIANCE CERTIFICATES

ELECTRICAL

EXHAUST FAN TO COMPLE NITORRELLY.C. C. PARY 10 6: OUNCIL SECTION C PLANNING SERVICES

EXHAUST FANS TO BE SEALED AND DUCTED TO OUTSIDE OF DWELLING IN ACCORDANCE WITH NCC VOL 2, PART 10.8.2 AND APPLICATION No.: PLN-25-293

- IF VENTING OCCURS DIRECTLY THROUGH WALLS/ROOF ADJACENT TO FANT THE NUMBER SOURCES SELF CLOSAGE 1/2025
BAFFLES OBE CLASSIFIED AS A SEALED UNIT

MEET ALL STANDARD AND CODE REQUIREMENTS - ALL GPO'S TO BE 300mm FROM FEL UNI ESS NOTED OTHERWISE

THIS PLAN ACCEPTED BY: PLEASE NOTE: NO VARIATIONS WILL BE ACCEPTED ON THIS PLAN AFTER SIGNING SIGNATURE: DATE:

THIS DWELLING IS BEING CONSTRUCTED IN A [Unused] AREA

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ADDRESS LOT / SECTION / CT: 1 / - / 183217

PRATIK DHIRAJBHAI & KAJALBEY PRATIK DARJI 116A BRANSCOMBE ROAD, CLAREMONT TAS 7011 COUNCIL . GLENORCHY COUNCIL

HOUSE DESIGN H-WDNAMF10SA AMALFI ONE FACADE CODE: FACADE DESIGN CLASSIC F-WDNAMF10CLASA SHEET TITLE SHEET No.: SCALES: **GENERAL NOTES** 20 / 21

DO NOT SCALE DRAWINGS, USE IGURED DIMENSIONS ONLY, CHEC AND VERIFY DIMENSIONS AND I EVELS PRIOR TO THE TO THE DRAFTING OFFICE.

WET AREA NOTES

WETAKLANOTEO	I	T	I	I
VESSELS OR AREA WHERE THE FIXTURE IS INSTALLED	FLOORS AND HORIZONTAL SURFACES	WALLS	WALL JUNCTIONS AND JOINTS	PENETRATIONS
ENCLOSED SHOWER WITH HOB	WATERPROOF ENTIRE ENCLOSED SHOWER AREA INCLUDING HOB.	WATERPROOF TO NOT LESS THAN 150mm ABOVE THE SHOWER FLOOR SUBSTRATE OR NOT LESS THAN 25mm ABOVE THE MAXIMUM RETAINED WATER LEVEL WHICH EVER IS THE GREATER WITH THE REMAINDER BEING WATERPROOF TO A HEIGHT OF NOT LESS THAN 1800mm ABOVE THE FINISHED FLOOR LEVEL.	WATERPROOF INTERNAL AND EXTERNAL CORNERS AND HORIZONTAL JOINTS WITHIN A HEIGHT OF 1800mm ABOVE THE FLOOR LEVEL WITH NOT LESS THAN 40mm WIDTH EITHER SIDE OF THE JUNCTION.	WATERPROOF ALL PENETRATIONS.
ENCLOSED SHOWER WITHOUT HOB	WATERPROOF ENTIRE ENCLOSED SHOWER AREA, INCLUDING WATERSTOP.	WATERPROOF TO NOT LESS THAN 150mm ABOVE THE SHOWER FLOOR SUBSTRATE WITH THE REMAINDER BEING WATERPROOF TO A HEIGHT OF NOT LESS THAN 1800mm ABOVE THE FINISHED FLOOR LEVEL.	WATERPROOF INTERNAL AND EXTERNAL CORNERS AND HORIZONTAL JOINTS WITHIN A HEIGHT OF 1800mm ABOVE THE FLOOR LEVEL WITH NOT LESS THAN 40mm WIDTH EITHER SIDE OF THE JUNCTION.	WATERPROOF ALL PENETRATIONS.
ENCLOSED SHOWER WITH STEPDOWN	WATERPROOF ENTIRE ENCLOSED SHOWER AREA INCLUDING THE STEPDOWN.	WATERPROOF TO NOT LESS THAN 150mm ABOVE THE SHOWER FLOOR SUBSTRATE OR NOT LESS THAN 25mm ABOVE THE MAXIMUM RETAINED WATER LEVEL WHICHEVER IS THE GREATER WITH THE REMAINDER BEING WATERPROOF TO A HEIGHT OF NOT LESS THAN 1800mm ABOVE THE FINISHED FLOOR LEVEL.	WATERPROOF INTERNAL AND EXTERNAL CORNERS AND HORIZONTAL JOINTS WITHIN A HEIGHT OF 1800mm ABOVE THE FLOOR LEVEL WITH NOT LESS THAN 40mm WIDTH EITHER SIDE OF THE JUNCTION.	WATERPROOF ALL PENETRATIONS.
ENCLOSED SHOWER WITH PRE-FORMED SHOWER BASE	N/A	WATERPROOF TO A HEIGHT OF NOT LESS THAN 1800mm ABOVE FINISHED FLOOR LEVEL.	WATERPROOF INTERNAL AND EXTERNAL CORNERS AND HORIZONTAL JOINTS WITHIN A HEIGHT OF 1800mm ABOVE THE FLOOR LEVEL WITH NOT LESS THAN 40mm WIDTH EITHER SIDE OF THE JUNCTION.	WATERPROOF ALL PENETRATIONS.
UNENCLOSED SHOWERS	WATERPROOF ENTIRE UNCLOSED SHOWER AREA.	WATERPROOF TO NOT LESS THAN 150mm ABOVE THE SHOWER FLOOR SUBSTRATE OR NOT LESS THAN 25mm ABOVE THE MAXIMUM RETAINED WATER LEVEL WHICH EVER IS THE GREATER WITH THE REMAINDER BEING WATERPROOF TO A HEIGHT OF NOT LESS THAN 1800mm ABOVE THE FINISHED FLOOR LEVEL.	WATERPROOF INTERNAL AND EXTERNAL CORNERS AND HORIZONTAL JOINTS WITHIN A HEIGHT OF 1800mm ABOVE THE FLOOR LEVEL WITH NOT LESS THAN 40mm WIDTH EITHER SIDE OF THE JUNCTION.	WATERPROOF ALL PENETRATIONS.
AREAS OUTSIDE THE SHOWER AREA FOR CONCRETE AND COMPRESSED FIBRE CEMENT SHEET FLOORING	WATER RESISTANT TO ENTIRE FLOOR.	N/A	WATERPROOF ALL WALL/FLOOR JUNCTIONS. WHERE A FLASHING IS USED THE HORIZONTAL LEG MUST BE NOT LESS THAN 40mm.	N/A
AREAS OUTSIDE THE SHOWER AREA FOR TIMBER FLOORS INCLUDING PARTICLEBOARD, PLYWOOD AND OTHER TIMBER BASED FLOORING MATERIALS	WATERPROOF ENTIRE FLOOR.	N/A	WATERPROOF ALL WALL/FLOOR JUNCTIONS. WHERE A FLASHING IS USED THE HORIZONTAL LEG MUST BE NOT LESS THAN 40mm.	N/A
AREAS ADJACENT TO BATHS AND SPAS FOR CONCRETE AND COMPRESSED FIBRE CEMENT SHEET FLOORING.	WATER RESISTANT TO ENTIRE FLOOR.	WATERPROOF TO A HEIGHT OF NOT LESS THAN 150mm ABOVE THE VESSEL AND EXPOSED SURFACES BELOW THE VESSEL LIP TO FLOOR LEVEL.	WATERPROOF EDGES OF THE VESSEL AND JUNCTION OF BATH ENCLOSURE WITH FLOOR. WHERE THE LIP OF THE BATH IS SUPPORTED BY A HORIZONTAL SURFACE, THIS MUST BE WATERPROOF FOR SHOWERS OVER BATH AND WATER RESISTANT FOR ALL OTHER CASES.	WATERPROOF ALL TAP AND SPOUT PENETRATIONS WHERE THEY OCCUR IN A HORIZONTAL SURFACE.
AREAS ADJACENT TO BATHS AND SPAS (SEE NOTE 1) FOR TIMBER FLOORS INCLUDING PARTICLEBOARD, PLYWOOD AND OTHER TIMBER BASED FLOORING MATERIALS.	WATERPROOF ENTIRE FLOOR.	WATERPROOF TO A HEIGHT OF NOT LESS THAN 150mm ABOVE THE VESSEL AND EXPOSED SURFACES BELOW THE VESSEL LIP TO FLOOR LEVEL.	WATERPROOF EDGES OF THE VESSEL AND JUNCTION OF BATH ENCLOSURE WITH FLOOR. WHERE THE LIP OF THE BATH IS SUPPORTED BY A HORIZONTAL SURFACE, THIS MUST BE WATERPROOF FOR SHOWERS OVER BATH AND WATER RESISTANT FOR ALL OTHER CASES.	WATERPROOF ALL TAP AND SPOUT PENETRATIONS WHERE THEY OCCUR IN A HORIZONTAL SURFACE.
INSERTED BATHS	N/A FOR FLOOR UNDER BATH. ANY SHELF AREA ADJOINING THE BATH OR SPA MUST BE WATERPROOF AND INCLUDE A WATERSTOP UNDER THE VESSEL LIP.	N/A FOR WALL UNDER BATH. WATERPROOF TO NOT LESS THAN 150mm ABOVE THE LIP OF THE BATH.	N/A FOR WALL UNDER BATH. WATERPROOF TO NOT LESS THAN 150mm ABOVE THE LIP OF BATH OR SPA.	WATERPROOF ALL TAP AND SPOUT PENETRATIONS WHERE THEY OCCUR IN A HORIZONTAL SURFACE.
WALLS ADJOINING OTHER VESSELS (EG. SINKS, LAUNDRY TUBS AND BASINS)	N/A	WATERPROOF TO A HEIGHT OF NOT LESS THAN 150mm ABOVE THE VESSEL IF THE VESSEL IS WITHIN 75mm OF THE WALL.	WHERE THE VESSEL IS FIXED TO A WALL, WATERPROOF EDGES FOR EXTENT OF VESSEL.	WATERPROOF ALL TAP AND SPOUT PENETRATIONS WHERE THEY OCCUR IN A HORIZONTAL SURFACE.

THE ABOVE INFORMATION IS FOR GENERAL GUIDANCE AND IS INDICATIVE ONLY. WATERPROOFING INSTALLERS TO COMPLY WITH ALL CURRENT CODES OF LEGISLATION WHICH TAKE PRECEDENCE OVER THIS SPECIFICATION

WATERPROOF ALL WALL/FLOOR JUNCTIONS TO NOT

LESS THAN 25mm ABOVE THE FINISHED FLOOR LEVEL,

WET AREA WAERPROOFING BY LICENSED AND ACCREDITED INSTALLER. CERTIFICATION TO BE PROVIDED TO BUILDING SURVEYOR. CONTRACTOR OR BUILDER TO DETERMINE THE APPROPRIATE WATERPROOFING IN ACCORDANCE WITH AS3740 PART 10.2 OF N.C.C. AND TO NOTIFY THE BUILDING SURVEYOR FOR INSPECTION ARRANGEMENTS DURING INSTALL ATION.

SEALED TO FLOOR.

WATER RESISTANT TO ENTIRE FLOOR.

ENERGY EFFICIENCY - GENERAL

STATED R VALUES ARE FOR ADDITIONAL INSULATION REQUIRED AND ARE NOT RT VALUES (TOTAL SYSTEM VALUE)

INSULATION TO BE INSTALLED TO MANUFACTURERS SPECIFICATIONS AND ANY RELEVANT STANDARDS

BULK INSULATION IS NOT TO BE COMPRESSED AS THIS REDUCES THE EFFECTIVE R RATING

WAFFLE POD ALLOWANCES:

- REFER TO ENERGY CERTIFICATION

X-POD ALLOWANCE

3.12.3.4 - EXHAUST FANS

(a) A CONDITIONED SPACE; OR

(i) A CONDITIONED SPACE: OR

OR THE LIKE WHEN SERVING: (a) A HEATED SPACE; OR

3.12.5.5 - ARTIFICIAL LIGHTING

EXCEED THE ALLOWANCE OF

(i) 5W/m2 IN A CLASS 1 BUILDING

(b) CONSTRUCTION REQUIRED BY (a) MUST BE:

AN EXHAUST FAN MUST BE FITTED WITH A SEALING DEVICE SUCH AS A SELF

(a) ROOFS, EXTERNAL WALLS, EXTERNAL FLOORS AND AN OPENING SUCH

WITH (b) WHEN FORMING PART OF THE EXTERNAL FABRIC OF:

(i) ENCLOSED BY AN INTERNAL LINING SYSTEM THAT ARE CLOSE

(ii) SEALED BY CAULKING, SKIRTING, ARCHITRAVES, CORNICES OR THE

3.12.3.6 - EVAPORATIVE COOLERS
AN EVAPORATIVE COOLER MUST BE FITTED WITH A SELF CLOSING DAMPER

FITTING AT CEILING, WALL AND FLOOR JUNCTIONS; OR

(a) LAMP POWER DENSITY OR ILLUMINATION POWER DENSITY OF AN

(b) THE ILLUMINATION POWER DENSITY ALLOWANCE IN (a) MAY BE

ARTIFICIAL LIGHT, EXCLUDING HEATING THAT EMITS LIGHT, MUST NOT

(ii) 4W/m² ON A VERANDAH, BALCONY OR THE LIKE ATTACHED TO A CLASS 1 BUILDING (NOT EXCLUDING EAVE PERIMETER LIGHTS);
(iii) 3W/m² IN A CLASS 10A BUILDING ASSOCIATED WITH A CLASS 1

INCREASED BY DIVIDING IT BY THE ILLUMINATION POWER DENSITY

ADJUSTMENT FACTOR FOR A CONTROL DEVICE AS PER N.C.C TABLE

(ii) A HABITABLE ROOM IN CLIMATE ZONE 4, 5, 6, 7 OR 8.

(b) A HABITABLE ROOM IN CLIMATE ZONES 4, 5, 6, 7 OR 8.

AS A WINDOW FRAME, DOOR FRAME, ROOF LIGHT FRAME OR THE LIKE

MUST BE CONSTRUCTED TO MINIMISE AIR LEAKAGE IN ACCORDANCE

CLOSE DAMPER, FILTER OR THE LIKE WHEN SERVING:

(b) A HABITABLE ROOM IN THE CLIMATE ZONES 4, 5, 6, 7 OR 8. 3.12.3.5 - CONSTRUCTION OF ROOF, WALLS AND FLOORS

- REFER TO ENERGY CERTIFICATION

CLEARANCE IS REQUIRED FOR UNCOMPRESSED INSTALLATION OF BULK INSULATION &

TIMBERS SHOULD BE SIZED ACCORDINGLY 210mm FOR R4 1 BULK INSULATION

210mm FOR R5.0 BULK INSULATION

260mm FOR R6.0 BULK INSULATION

THESE DIMENSIONS ARE NOMINAL AND MAY VARY DEPENDING ON THE TYPE OF INSULATION TO BE INSTALLED

N.C.C 2022 TAS PART H6

IN TASMANIA, FOR NCC PART H6 REFER TO NCC 2019 AMENDMENT 1 PART 2.6; FOR NCC PART 13.1 REFER TO NCC 2019 PART 3.12.

N.C.C 2019 3.12.0 (A)

PERFORMANCE REQUIREMENT P2.6.1 FOR THE THERMAL PERFORMANCE OF THE BUILDING IS SATISFIED BY COMPLYING WITH:

3.12.0.1 - FOR REDUCING THE HEATING AND COOLING LOADS TO REDUCE HEATING AND COOLING LOADS MUST ACHIEVE AN ENERGY RATING USING HOUSING ENERGY RATING SOFTWARE OF NOT LESS THAN 6

BUILDER TO ENSURE THAT ALL INSULATION COMPLIES WITH AS/NZS 4859.1

3.12.1.1 - FOR BUILDING FABRIC THERMAL INSULATION

AND BE INSTALLED TO N.C.C 3.12.1.1.

3.12.1.2(e) - FOR COMPENSATING FOR A LOSS OF CEILING INSULATION REFER TO ATTACHED THERMAL PERFORMANCE CERTIFICATE

- (i) IF ALLOWANCE HAS BEEN MADE FOR CEILING PENERATIONS IN NATHERS (FIRST RATE 5) CERTIFICATION PROCESS THEN NO FURTHER ACTION REQUIRED
- (ii) IF NO ALLOWANCE HAS BEEN MADE FOR CEILING PENETRATIONS IN NATHERS (FIRST RATE 5) CERTIFICATION PROCESS THEN CEILING PENETRATION AREA MUST BE CALCULATED AND THE NECESSARY ADJUSTMENT MADE TO THE SPECIFIED INSULATION AS PER TABLE

3.12.1.5(c) AND 3.12.1.5(d) - FOR FLOOR EDGE INSULATION FOR CONCRETE SLAB ON GROUNG WITH IN SLAB HEATING OR COOLING.

3.12.3 - FOR BUILDING SEALING

3.12.3.1 - CHIMNEYS AND FLUES

THE CHIMNEY OR FLUE OF AN OPEN SOLID FUEL BURNING APPLIANCE MUST BE PROVIDED WITH A DAMPER OR FLAP THAT CAN BE CLOSED TO SEAL THE CHIMNEY OR FLUE.

3.12.3.2 - ROOF LIGHTS

- (a) A ROOF LIGHT MUST BE SEALED, OR CAPABLE OF BEING SEALED WHEN
 - (i) A CONDITIONED SPACE; OR
- (ii) A HABITABLE ROOM IN CLIMATE ZONES 4, 5, 6, 7 OR 8
- (b) $\stackrel{\checkmark}{\text{A}}$ ROOF LIGHT REQUIRED BY (a) TO BE SEALED, OR CAPABLE OF BEING SEALED MUST BE CONSTRUCTED WITH:
- (i) AN IMPERFORATE CEILING DIFFUSER OR THE LIKE INSTALLED AT A CEILING OR INTERNAL LINING LEVEL; OR
- (ii) A WATERPROOF SEAL; OR
- (iii) A SHUTTER SYSTEM READILY OPERATED MANUALLY

MECHANIC LLLY OR ELECTRONICAL X BY THE OCCUPANTITY COUNCIL

3.12.0.1 - EXTERNAL WINDOWS AND DOORS (a) A SEAL TO RESTRIC AIR INFILTRATION AND INTENGACE REVICES

- EXTERNAL DOOR, OPENABLE WINDOW AND OTHER SUCH OPENING:
- (I) WHEN SER /ING A CONDITIONED SPACE; OR
- (II) IN CLIMATE ZAND PLOTOR WHEN NO. HABITAPELN-25-293
- (b) A WINDOW COINPLYING WITH THE MAXIMUM AIR INFILTRATION RATES SPECIFIED IN A \$2047 NEED NOT COMPLY WITH (a).
- 19/11/2025 (c) A SEAL REQUIFE TY AT E RECEIVED: 19/1
 (i) FOR THE BOTTOM EDGE OF AN INTERNAL SWING DOOR, MUST BE A
- DRAFT PROTECTION DEVICE; AND
- (ii) FOR THE OTHER EDGES OF AN EXTERNAL SWING DOOR OR THE EDGES OF AN OPENABLE WINDOW OR OTHER SUCH OPENING, MAY BE A FOAM OR RUBBER COMPRESSIBLE STRIP, FIBROUS SEAL OR

PLEASE NOTE: NO VARIATIONS WILL BE ACCEPTED ON THIS PLAN AFTER SIGNING
SIGNATURE:
DATE:

THIS PLAN ACCEPTED BY:

THIS DWELLING IS BEING CONSTRUCTED IN A [Unused] AREA

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WATERPROOF ALL WALL/FLOOR JUNCTIONS.

LEG MUST BE NOT LESS THAN 40mm.

WHERE A FLASHING IS USED THE HORIZONTAL



REVISION DRAWN 4 DRAFT SALE PLAN - CT2 HMI 2025.08.14 5 DRAFT SALE PLAN - CT3 HMI 2025.09.03 6 PRELIM PLAN - INITIAL ISSUE NVO 2025.09.30 7 PRELIM PLANS - COLOUR UPDATE TNG 2025.10.28 8 PRELIM PLANS - PLANNING RFI UPDATE RT2 2025.11.18

PRATIK DHIRAJBHAI & KAJALBEY PRATIK DARJI ADDRESS: 116A BRANSCOMBE ROAD, CLAREMONT TAS 7011 LOT / SECTION / CT: COUNCIL . 1 / - / 183217 GLENORCHY COUNCIL

HOUSE DESIGN HOUSE CODE AMALFI ONE H-WDNAMF10SA FACADE DESIGN FACADE CODE CLASSIC F-WDNAMF10CLASA SHEET TITLE: SHEET No.: SCALES: WET AREA & ENERGY EFFICIENCY NOTES 21 / 21

DO NOT SCALE DRAWINGS, USE FIGURED DIMENSIONS ONLY, CHEC AND VERIFY DIMENSIONS AND I EVELS PRIOR TO THE TO THE DRAFTING OFFICE.

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LAUNDRIES AND WCS